### MEMO

### **Disclaimer for Review of Plans**

The San Francisco Planning Code requires that the plans of certain proposed projects be provided to members of the public prior to the City's approval action on the project. Accordingly, any images of plans featured on this website are provided for the primary purpose of facilitating public input prior to the City's action. The City and County of San Francisco does not own the copyright to these images. Please be aware that the unauthorized reproduction, distribution, or alteration of these images may result in a violation of Federal Copyright Law (17 U.S.C.A. Sections 101 et seq.) and that any party who seeks to reproduce or alter these images does so at his or her own risk.

Additionally, plans provided on this website are limited to site plans, elevations and/or section details (floor plans and structural details may not be included). These are DRAFT PLANS being provided for public review PRIOR to the City's approval action on the project. Final plans may differ from those that are currently available for review.

1650 Mission St. Suite 400 San Francisco, CA 94103-2479

Reception: 415.558.6378

Fax: 415.558.6409

Planning Information: 415.558.6377 NOTICE OF PUBLIC HEARING

Hearing Date: Wednesday, December 03, 2014

Time: **9:30 AM** 

Location: City Hall, 1 Dr. Carlton B. Goodlett Place, Room 408

Case Type: Variance(Permitted Obstruction)

Hearing Body: Zoning Administrator

| PORPERTY INFORMATION |                   | APPLICATION INFORMATION |                           |
|----------------------|-------------------|-------------------------|---------------------------|
| Project Address:     | 1 Franklin St     | Case No.:               | 2014.1423V                |
| Cross Street(s):     | Page Street       | Building Permit:        | 200912032516              |
| Block / Lot No.:     | 0837/003          | Applicant/Agent:        | Charles Shin              |
| Zoning District(s):  | NCT-3 / 50-X/85-X | Telephone:              | 415-501-0931              |
| Area Plan:           | Market Octavia    | E-Mail:                 | n.cranmer@js-sullivan.com |

### PROJECT DESCRIPTION

The proposal is to construct an 8-story mixed-use structure with ground-floor commercial space and 35 residential units on an existing surface parking lot. The project was previously granted a variance from the permitted obstruction requirement on April 6, 2010 (Case No. 2010.0102V); however, the project was not built and the variance subsequently expired.

**SECTION 136 OF THE PLANNING CODE** states that permitted obstructions (bay windows) over the public right-of-way are limited to extend over the property line 2-feet where the sidewalk is 9-feet or less and 3-feet where the sidewalk is over 9-feet in width. The maximum width allowed for a bay window is 15-feet, narrowed at a 45-degree angle to a maximum width of 9-feet as it extends over the property line. The minimum horizontal separation between bay windows is 2-feet at the property line, widened at a 135-degree angle to a minimum width of 8-feet as it extends over the property line. The proposed bay windows do not meet the projection, width, or separation requirements; therefore, the project seeks a variance from the requirements of Section 136.

### ADDITIONAL INFORMATION

FOR MORE INFORMATION, PLEASE CONTACT PLANNING DEPARTMENT STAFF:

Planner: Gonzalo Mosquera Telephone: 415-575-9165 Mail: Gonzalo.Mosquera@sfgov.org

**ARCHITECTURAL PLANS:** The site plan and elevations of the proposed project are available on the Planning Department's website at: <a href="http://sf-planning.org/ftp/files/notice/2014.1423V.pdf">http://sf-planning.org/ftp/files/notice/2014.1423V.pdf</a>

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Para información en Español llamar al: 558.6378

### GENERAL INFORMATION ABOUT PROCEDURES

#### VARIANCE HEARING INFORMATION

Under Planning Code Section 306.3, you, as a property owner or resident within 300 feet of this proposed project or interested party on record with the Planning Department, are being notified of this Variance Hearing. You are not obligated to take any action. For more information regarding the proposed work, or to express concerns about the project, please contact the Applicant/Agent or Planner listed on this notice as soon as possible. Additionally, you may wish to discuss the project with your neighbors and neighborhood association or improvement club, as they may already be aware of the project.

Persons who are unable to attend the public hearing may submit written comments regarding this application to the Zoning Administrator, Planning Department, 1650 Mission Street, Suite 400, San Francisco, CA 94103, by 5:00pm the day prior to the hearing. These comments will be made a part of the official public record, and will be brought to the attention of the person or persons conducting the public meeting or hearing

### **BUILDING PERMIT APPLICATION INFORMATION**

Under Planning Code Section 311/312, the Building Permit Application for this proposal is also subject to a 30-day notification to occupants and owners within 150-feet of the subject property. On November 10, 2014, the Department issued the required Section 312 notification for this project (expires December 10, 2014).

#### **BOARD OF APPEALS**

An appeal of the approval (or denial) of a **variance application** by the Zoning Administrator may be made to the **Board of Appeals within 10 days** after the **Variance Decision Letter** is issued by the Zoning Administrator.

An appeal of the approval (or denial) of a **building permit application** by the Planning Department may be made to the **Board of Appeals within 15 days** after the **building permit** is issued (or denied) by the Director of the Department of Building Inspection.

Appeals must be submitted in person at the **Board's office at 1650 Mission Street, 3rd Floor, Room 304**. For further information about appeals to the Board of Appeals, including current fees, **contact the Board of Appeals** at **(415) 575-6880**.

#### **ABOUT THIS NOTICE**

The Planning Department is currently reviewing its processes and procedures for public notification as part of the Universal Planning Notification (UPN) Project. The format of this Public Hearing notice was developed through the UPN Project and is currently being utilized in a limited trial-run for notification of Variance Hearings.

If you have any comments or questions related to the UPN Project or the format of this notice, please visit our website at <a href="http://upn.sfplanning.org">http://upn.sfplanning.org</a> for more information.

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Para información en Español llamar al: 558.6378


# 1 FRANKLIN

| ABBREVIATIONS  | SYMBOLS  | GENERAL NOTES  | BUILDING DATA  | PLANNING DATA   | DRAWING INDEX   | SAN FRANCISCO, CA 94102   |
|--|--|--|--|---|---|---|
| R. PROPERTY LINE L.P. LOW PARTITION L.P. LOW PARTIT | NORTH ARROW  COLUMN LINE / GRID LINE  MATCH LINE  WORK POINT CONTROL POINT OR DATUM POINT  CENTER LINE (DIMENSION LINE)  PROPERTY LINE  A3.6  ELEVATION ELEVATION NUMBER SHEET NUMBER  SECTION NUMBER SHEET NUMBER  14  DETAIL DET | 1. GENERAL CONTRACTOR AND HIS SUBCONTRACTORS SHALL FAMILIARIZE THEMSELVES WITH SITE CONDITIONS, WITH THE CONTRACT DOCUMENTS, MATTERS AND CONDITIONS WHICH MAY AFFECT THE OPERATION AND COMPLETION OF THE PROJECT.  2. CONTRACTOR SHALL FURNISH ALL LABOR, MATERIAL, EQUIPMENT AND SERVICES REQUIRED FOR OR REASONABLY INCIDENTAL TO THE COMPLETION OF THE WORK.  3. CONTRACTOR SHALL BE RESPONSIBLE FOR PROVIDING ALL WORK AND MATERIALS IN ACCORDANCE WITH ALL LOCAL REGULATORY AGENCIES, APPLICABLE BUILDING CODES AND REQUIREMENTS.  4. THE GENERAL CONTRACTOR IS RESPONSIBLE FOR CHECKING CONTRACT DOCUMENTS, INCLUDING CONDITIONS OF APPROVAL BY THE CITY OF SAN FRANCISCO AND FIELD CONDITIONS AND DIMENSIONS FOR ACCURACY AND CONFIRMING THAT WORK IS BUILDABLE AS SHOWN BEFORE PROCEEDING WITH CONSTRUCTION. IF THERE ARE ANY QUESTIONS REGARDING THESE OR OTHER COORDINATION ISSUES, THE CONTRACTOR IS RESPONSIBLE FOR OBTAINING A CLARIFICATION FROM THE ARCHITECT BEFORE PROCEEDING WITH WORK IN QUESTION.  5. GENERAL CONTRACTOR SHALL VERIFY THAT NO CONFLICTS EXIST IN LOCATIONS OF ANY AND ALL MECHANICAL, TELEPHONE, ELECTRICAL, LIGHTING, PLUMBING AND SPRINKLER EQUIPMENT (TO INCLUDE ALL PIPING, DUCTWORK AND CONDUIT) AND THAT ALL REQUIRED CLEARANCES FOR INSTALLATION AND MAINTENANCE OF FUTURE EQUIPMENT ARE PROVIDED.  6. THE GENERAL CONTRACTOR SHALL COORDINATE THE LAYOUT AND EXACL LOCATION OF ALL PARTITIONING, DOORS, ELECTRICAL, TELEPHONE OUTLETS AND LIGHT SWITCHES WITH THE OWNER'S REPRESENTATIVE AND ARCHITECT IN THE FIELD BEFORE PROCEEDING WITH CONSTRUCTION.  7. DO NOT SCALE DRAWINGS. DIMENSIONS GOVERN. VERIFY DIMENSIONS WITH THELD CONDITIONS. IF DISCREPANCIES ARE DISCOVERED BETWEEN FIELD CONDITION AND DRAWINGS OR BETWEEN DRAWINGS, CONTACT ARCHITECT FOR RESOLUTION BEFORE PROCEEDING.  8. "TYPICAL" MEANS IDENTICAL FOR ALL SIMILAR CONDITIONS UNLESS OTHERWISE NOTED.  9. "SIMILAR" MEANS COMPARABLE CHARACTERISTICS FOR THE ELEVATION NOTED. VERIFY DIMENSIONS AND OBJENTATION ON PLAN.  10. ALL WORK SHALL BE SCHEDULED AND PERFORMED SO AS NOT TO DISTURB OR CAUSE DA  | SPRINKLER PROTECTION:  SPRINKLER PROTECTION:  SPRINKLER PROTECTION:  YES  FULLY AUTOMATIC SPRINKLER  SYSTEM  GROSS BUILDING AREA SUMMARY  FLOOR  GROSS AREA  (S.F.)  1 2,692 TYPE I-B MERCANTILE M 3,121 TYPE I-B RESIDENTIAL R-2, S-2  2 4,762 TYPE I-B RESIDENTIAL R-2, S-2  3 4,805 TYPE I-B RESIDENTIAL R-2  3 4,805 TYPE I-B RESIDENTIAL R-2  4 4,805 TYPE I-B RESIDENTIAL R-2  5 4,784 TYPE I-B RESIDENTIAL R-2  6 3,739 TYPE I-B RESIDENTIAL R-2  7 3,850 TYPE I-B RESIDENTIAL R-2  8 3,850 TYPE I-B RESIDENTIAL R-2  7 3,850 TYPE I-B RESIDENTIAL R-2  8 3,850 TYPE I-B RESIDENTIAL R-2  8 3,850 TYPE I-B RESIDENTIAL R-2  8 3,850 TYPE I-B RESIDENTIAL R-2  CONSTRUCTION  S-2 79,000  M UNLIMITED  ALLOWABLE AREA PER FLOOR PER CBC TABLE 503 FOR TYPE I-B  CONSTRUCTION  S-2 79,000  M UNLIMITED  ALLOWABLE AREA PER FLOOR WITH INCREASES PER CBC SECTION 506.1  S-2 255,170  M UNLIMITED  R-2 UNLIMITED  TOTAL ALLOWABLE BUILDING AREA TYPE I-B CONSTRUCTION, S-2 OCCUPANCY  PER CBC SECTION 506.4 FOR 510,340  MOST RESTRICTIVE USE  TOTAL PROPOSED BUILDING AREA 36,408 G.S.F. ABOVE GRADE STORIES  | PROJECT ADDRESS:  1 FRANKLIN STREET SAN FRANCISCO, CA 94102  PROJECT DESCRIPTION:  NEW PRIVATELY FUNDED MIXED USE RESIDENTIAL BUILDING ON EXISTING OPEN PARKING LOT; 7 STORIES OF RESIDENTIAL UNITS OVER 1 STORY OF COMMERCIAL / RETAIL & PARKING; NO BASEMENT   ZONING: NEIGHBORHOOD PLAN  BLOCK & LOT NO.:  BLOCK 0837, LOT 3  HEIGHT LIMIT: SPLIT - 85' / 55'  LOT AREA: 6,600 S.F.  RESIDENTIAL DENSITY: NO LIMIT  F.A.R.: N/A  NUMBER OF UNITS PROPOSED: 35 DWELLING UNITS 1 BEDROOM UNITS 1 BEDROOM UNITS 1 BEDROOM UNITS 1 BEDROOM UNITS 1 STUDIO UNITS 1 BEDROOM UNITS 1 STUDIO UNITS 1 STUDIO UNITS 1 BEDROOM UNITS 1 UNITS 1 STUDIO UNITS 1 UNITS 1 STUDIO UNITS 1 UNITS 2 BEDROOM UNITS 1 UNITS 1 UNITS 1 UNITS 1 UNITS 2 BEDROOM UNITS 1 UNITS 1 UNITS 1 UNITS 2 BEDROOM UNITS 1 UNITS 1 UNITS 1 UNITS 2 UNIT TOTAL B.M.R. UNITS PROPOSED 4 UNITS COMMERCIAL (2,692 GSF TOTAL): 3 SPACES ON | A0.0 COVER SHEET / BUILDING DATA  A0.1 PLANNING DEPT. CERTIFICATE OF DETERMINATION A0.2 PLANNING DEPT. CERTIFICATE OF DETERMINATION A0.3 ACCESSIBILITY STANDARDS & DIAGRAMS A0.4 ACCESSIBILITY STANDARDS & DIAGRAMS A0.5 ACCESSIBILITY STANDARDS & DIAGRAMS A0.5 ACCESSIBILITY STANDARDS & DIAGRAMS A0.7 EXITING / ACCESSIBIL PATH OF TRAVEL PLANS A0.8 GREENPOINT CHECKLIST A0.9 GREENPOINT CHECKLIST A0.10 GREENPOINT CHECKLIST A0.11 SITE PHOTOGRAPHS A0.12 SITE PHOTOGRAPHS A0.13 SITE PHOTOGRAPHS A0.13 SITE PHOTOGRAPHS A1.1 FIRST FLOOR PLAN A1.1 FIRST FLOOR PLAN A1.2 SECOND & THIRD FLOOR PLANS A1.3 FOURTH & FIFTH FLOOR PLANS A1.4 SIXTH & SEVENTH FLOOR PLANS A1.5 EIGHTH & ROOF FLOOR PLANS A1.5 EIGHTH & ROOF FLOOR PLANS A2.0 EAST & SOUTH EXTERIOR ELEVATIONS A2.1 WEST & NORTH EXTERIOR ELEVATIONS A2.1 WEST & NORTH EXTERIOR ELEVATIONS A3.1 BUILDING SECTION SUPPLEMENTAL EXHIBITS (11"X 17" FORMAT) EXHIBIT A REAR YARD REQUIREMENT (PLANN. CODE SEC. 134) EXHIBIT B.1 OPEN SPACE CALCULATION (PLANN. CODE SEC. 135) EXHIBIT D BAY WINDOW CALCULATION (PLANN. CODE SEC. 135)   | The architecture office of Warner Schmal  1014 Howard Street San Francisco, CA 9410 F 415 . 252.9020 T 415 . 252.706  Copyright © 2010 FORUM DESIGN LTD. This drawing and written material constitute the original work of this Architect and may not be used uplicated or disclosed without the Architect's written consent. |
| CLRM CLASSROOM PRCST PRE-CAST CMU CONCRETE MASONRY UNIT P.T. PRESSURE TREATED P.T.D., PAPER TOWEL DISPENSER COL COLUMN P.T.D., P.T.D., PAPER TOWEL DISPENSER COMBINATION PAPER TOWEL DISPENSER RECEPTAGE PIN PARTITION PAPER TOWEL PAPER TOWEL DISPENSER RECEPTAGE PIN PARTITION PAPER TOWEL DISPENSER RECEPTAGE PIN PARTITION PAPER TOWEL PAPER RECONSTRUCTION PAPER RECONSTRUCTION PARTITION PAPER RECONSTRUCTION PAPER RECONSTRUCTION PAPER RECONSTRUCTION PAPER RECONSTRUCTION PAPER PA | SHEET NUMBER  ENLARGED DETAIL DETAIL NUMBER SHEET NUMBER  B  A9.1  A9.1  INTERIOR ELEVATION ELEVATION GROUP NO. SHEET NUMBER ELEV. DESIGNATION  OFFICE  ROOM NAME ROOM NUMBER  36  SHEET NOTES  3 APPLIANCE REF. NO.  102  CEILING HEIGHT REFLECTED CEILING PLAN  REVISION  DOOR SYMBOL SEE DOOR SCHEDULE SHEET  (N) DOOR & DOOR FRAME   | EMANATE FROM CONSTRUCTION AREAS. CONSTRUCTION DEBRIS SHALL BE 60% RECYCLED - CONFIRM W/ THE CITY OF SAN FRANCISCO RECYCLING SPECIALIST.  12. ALL FRAMING AND FURRED WORK SHALL BE PROPERLY LAID OUT, ACCURATELY PLUMBED, LEVELED, ALIGNED AND RIGIDLY SECURED IN PLACE.  13. CONTRACTOR TO PROVIDE AND INSTALL FIRE EXTINGUISHERS WHERE DESIGNATED ON PLAN OR REQUIRED BY CODES. SUBMIT LOCATIONS FOR ARCHITECT'S APPROVAL.  14. GENERAL CONTRACTOR AND SUBCONTRACTORS TO COORDINATE INSTALLATION OF N.I.C. ITEMS WITH OTHER TRADES.  15. HVAC, PLUMBING, FIRE PROTECTION & SECURITY SYSTEMS TO BE DESIGN-BUILD BY GC. LAYOUTS SHOWN ON THESE DWGS ARE FOR DESIGN INTENT ONLY.  16. ALL ACCESSIBLE FEATURES SHALL MEET ACCESSIBILITY REQUIREMENTS PER DETAILS AND NOTES ON SHEETS OF HANDICAP ACCESSIBILITY STANDARDS & DIAGRAMS.  17. NO WORK DEFECTIVE IN CONSTRUCTION QUALITY OR DEFICIENT IN ANY REQUIREMENT OF THE DRAWINGS OR NOTES, WILL BE ACCEPTABLE IN CONSEQUENCE OF THE OWNERS OR ARCHITECT'S FAILURE TO DISCOVER OR POINT OUT DEFECTS AND DEFICIENCIES DURING CONSTRUCTION. DEFECTIVE WORK REVEALED WITHIN THE TIME REQUIRED BY GUARANTEES SHALL BE REPLACED BY WORK CONFORMING WITH THE INTENT OF THE CONTRACT. NO PAYMENT, EITHER PARTIAL OR FINAL SHALL BE CONSTRUED AS AN ACCEPTANCE OF DEFECTIVE WORK OR IMPROPER MATERIALS.  18. THE GENERAL CONTRACTOR SHALL PREPARE AND SUBMIT BEFORE STARTING THE WORK A SCHEDULE INDICATING REQUIRED CONSTRUCTION TIME FOR EACH CONTRACTOR & SUBCONTRACTOR'S WORK.  19. CONFIRM APPROXIMATE ON-SITE DELIVERY DATES FOR ALL CONSTRUCTION MATERIALS REQUIRED BY THE CONSTRUCTION DOCUMENTS. NOTIFY ARCHITECT IN WRITING OF ANY POSSIBLE CONSTRUCTION DELAYS AFFECTING OCCUPANCY THAT MAY ARISE DUE TO THE AVAILABILITY OF SPECIFIED PRODUCTS. REQUEST FOR SUBSTITUTIONS WILL NOT BE ACCEPTED AFTER CONSTRUCTION STARTS.  20. GENERAL CONTRACTOR TO SUBMIT REQUIRED SAMPLES, SHOP DRAWINGS AND PRODUCT DATA TO ARCHITECT FOR REVIEW PRIOR TO FABRICATION. ALLOW ARCHITECT SUFFICIENT TIME TO REVIEW AND COMMENT. ARCHITECT'S REVIEW WILL BE FOR CONFORMANCE WITH DESIGN CO | TOTAL ALLOWABLE BUILDING AREA IS GREATER THAN THE PROPOSED BUILDING AREA ON THE MOST RESTRICTIVE REQUIREMENTS (S-2 OCCUPANCY), ALLOWING THE APPLICATION OF THE NON-SEPARATED USE PROVISIONS DESCRIBED IN CBC SECTION 508.3.2  ALLOWABLE BUILDING HEIGHT TOTAL HEIGHT PERMITTED: 160 FEET  ACTUAL BUILDING HEIGHT FROM GRADE PLANE: 84.24 TO TOP OF ROOF TOTAL # OF STORIES PERMITTED: 11  ACTUAL # OF STORIES PROPOSED: 8  TOTAL HEIGHT AND NUMBER OF STORIES PERMITTED IS GREATER THAN PROPOSED HEIGHT AND NUMBER OF STORIES.  FIRE-RESISTANCE RATING REQUIREMENTS FOR BUILDING ELEMENTS FOR TYPE I-B CONSTRUCTION PER TABLE 601:  STRUCTURAL FRAME 2-HR REDUCE TO 1-HR FOR ROOF SUPPORT ONLY EXTERIOR BEARING WALLS 2-HR INTERIOR BEARING WALLS 2-HR REDUCE TO 1-HR FOR ROOF SUPPORT ONLY INT. NONBEARING WALLS 0-HR ROOF CONSTRUCTION 1-HR EXT. NONBEARING WALLS SEE BELOW  FIRE-RESISTANCE RATING REQUIREMENTS FOR EXTERIOR WALLS BASED ON FIRE SEPARATION DISTANCE FOR TYPE I-B CONSTRUCTION PER TABLE 602:  X < 5 2-HR FOR GROUP M OCCUP.; 1-HR FOR GROUPS R & S-2 OCCUPS.  5 < X < 10 1-HR FOR GROUP M OCCUP.; 1-HR FOR GROUPS R & S-2 OCCUPS.  10 < X < 30 1-HR FOR GROUP M OCCUP.; 1-HR FOR GROUPS R & S-2 OCCUPS.  X > 30 0-HR FOR GROUP M OCCUP.; 0-HR FOR GROUPS R & S-2 OCCUPS. | 1ST FLOOR   | PROJECT TEAM  OWNER  JS SULLIVAN DEVELOPMENT 1699 VALENCIA ST. SAN FRANCISCO, CA 95110 CONTACT:  FORUM DESIGN LTD. 1014 HOWARD STREET SAN FRANCISCO, CA 94103 CONTACT:  FORUM DESIGN LTD. 1014 HOWARD STREET SAN FRANCISCO, CA 94103 CONTACT:  WARNER SCHMALZ, AIA w.schmolz@forumdesign.com  STRUCTURAL ENGINEER NISHKIAN MENNINGER 600 HARRISON ST., SUITE 110 CONTACT:  SURVEYOR  FREDERICK T. SEHER & ASSOCIATES 841 LOMBARD ST. SAN FRANCISCO, CA 94133 CONTACT:  SURVEYOR  FREDERICK T. SEHER & ASSOCIATES 841 LOMBARD ST. SAN FRANCISCO, CA 94133 CONTACT:  MECHANICAL / ELECTRICAL / PLUMBING / T-24 ENERGY COMPILANCE  | ☐ 6-16-10 DBI PLAN CHECK COMMENTS  2 9-17-14 REVISION   |
| F.D. FLOOR DRAIN FON FOUNDATION F.E. FIRE EXTINGUISHER F.E. FIRE EXTINGUISHER CAB. F.H.C. FIRE HOSE CABINET FIN. FINISH FLASHING FLUOR FLUORESCENT F.O.C. FACE OF CONCRETE F.O.F. FACE OF STUD F.O.S. FACE OF STUD FRACE | (N) DOOR & DOOR FRAME  WINDOW MARK SEE WINDOW SCHEDULE SHEET  PARTITION TYPE SEE PARTITION SHEET A600 ALIGNMENT SYMBOL  NEW SPOT ELEVATION  (E)+150.00' EXISTING SPOT ELEVATION  | <ol> <li>SUBMIT THREE SAMPLES OR THREE COPIES OF SCHEDULES AND PRODUCT DATA FOR EACH ITEM.</li> <li>THE ARCHITECT WILL PREPARE A PRE-FINAL PUNCH LIST OF ITEMS FOR THE GENERAL CONTRACTOR TO COMPLETE. THE GENERAL CONTRACTOR SHALL NOTIFY ARCHITECT IN WRITING TO REQUEST A FINAL OBSERVATION AFTER ALL THE ITEMS ON THE PRE-FINAL PUNCH LIST HAVE BEEN CORRECTED.</li> <li>ALL GWB PARTITIONS SHALL BE TAPED &amp; SANDED SMOOTH W/ NO VISIBLE JOINTS. ALL SURFACES SHALL BE ALIGNED &amp; SANDED SMOOTH.</li> <li>ALL DIMS. ARE F.O.S. TO F.O.S., U.N.O. DIMS. NOTED "CLEAR" OR "CLR" ARE MIN. REQUIRED DIMS. CLEARANCES MUST BE ACCURATELY MAINTAINED, &amp; SHALL NOT VARY MORE THAN 1/8" W/O WRITTEN INSTRUCTION FROM THE ARCH'T. ALL DIMS. MARKED "CLEAR" SHALL BE MAINTAINED &amp; SHALL ALLOW FOR THICKNESSES OF ALL FINISHES INCL. CARPET (&amp; CUSHION), CERAMIC TILE, ETC.</li> <li>DIMS MARKED + MEAN A TOLERANCE NOT GREATER NOR SMALLER THAN 2" FROM INDICATED DIM., U.N.O.</li> <li>ALL EXPOSED GWB EDGES TO HAVE APPROPRIATE METAL EDGE TRIM.</li> </ol>   |  | PREVIOUS PLAN'G DEPT. APPROVALS  CERTIFICATE OF DETERMINATION EXEMPTION FROM ENVIRONMENTAL REVIEW CASE NO. 2008.1328E  AGREEMENT TO IMPLEMENT MITIGATION MEASURE(S) CASE NO. 2008.1328E  ORIGINAL SITE PERMIT APPLICATION WAS SUBMITTED & REVIEWED IN 2010. VARIANCE FOR BAY WINDOWS IS NOW RESUBMITTED TO MEET CURRENT PLANNING CODE REGULATIONS.  PERMITS TO BE ISSUED SEPARATELY   | <b>-</b>  | VARIANCE APPLICATION/ SITE PERMIT  JOB NUMBER: DRAWN BY   |
| G.B. GRAB BAR T.R. TRASH RECPTACLE GC GENERAL CONTRACTOR T'S TREADS GL GLASS T.V. TELEVISION GND GROUND T.W.C. TACKABLE WALL COVERING GR GRADE UTPP. TYPICAL UNF UNFINISHED US.O. UNLESS NOTED OTHERWISE HC HANDICAP ACCESSIBLE V.S.O. UNLESS SHOWN OTHERWISE HD HEADER VERT VERTICAL OR VERTICALLY HDWD HARDWOOD VEST VESTIBULE HDWE HARDWARE HT HEIGHT W.S.C. TACKABLE WALL COVERING T.V. TELEVISION UNFINISHED U.N.O. UNLESS NOTED OTHERWISE U.S.O. UNLESS SHOWN OTHERWISE VERT VERTICAL OR VERTICALLY VESTIBULE V.C.T. VINYL COMPOSITION TILE HT HEIGHT W.S.F. VERIFY IN FIELD WASHER HORIZ  | NOTE:<br>SOME OF THE ABOVE SYMBOLS MAY<br>NOT HAVE BEEN USED FOR THIS<br>PROJECT.  | <ul> <li>27. ALL WORK SHALL BE ERECTED &amp; INSTALLED PLUMB, LEVEL, SQUARE &amp; TRUE, &amp; IN PROPER ALIGNMENT.</li> <li>28. VERIFY FIELD CONDITIONS &amp; FINISHES BEFORE ORDERING DOORS - BOTTOM OF DOORS TO CLEAR THE TOP OF FINISHED FLOOR, INCL., BUT NOT LIMITED TO CARPET, TILE &amp; THE LIKE, AS APPLICABLE, BY 1/4" MAXIMUM, UNLESS OTHERWISE NOTED. VERIFY ALL SLAB CONDITIONS &amp; CODE &amp; INSTALLATION REQ'TS FOR FIRE-RATED DOORS.</li> <li>29. DIMENSIONS LOCATING DOORS BY EDGE ARE TO THE INSIDE EDGE OF JAMB, U.N.O.</li> <li>30. "ALIGN" MEANS TO ACCURATELY LOCATE FINISHED FACES IN THE SAME PLANE.</li> </ul>   |  | ADDENDUM PROCESS SHORING & UNDERPINNING FIRE SPRINKLER SYSTEM/STANDPIPE FIRE ALARM SYSTEM  APPLICABLE CONSTRUCTION CODES  | Hayes St  Linden St  Linden St  Rell St  Address  Address  Csaa  Building  Fell St  Fell St  Formula  San Francisco   | DATE: CHECKED BY 09-15-2009  SCALE:  SHEET TITLE:   |
| HORIZ HORIZONTAL WB WET BAR HR HOUR WC WATER CLOSET H.S. HANGER STRIP W/C WINE COOLER H.W.D. HOT WATER DISPENSER WH WATER HEATER I.D. INSIDE DIAMETER (DIM.) WD WOOD IDENT IDENTICAL W/D WASHER & DRYER STACKED INSUL INSULATION W.I. WROUGHT IRON INT INTERIOR WIN WINDOW  JAN JANITOR WK WORK  K KITCHEN W/O WITHOUT K.S. KNEE SPACE WP WATERPROOF LAB LABORATORY W.PT WORKING POINT LAM LAMINATE W.R. WATER RESISTANT LAV LAVATORY WSCT WAINSCOT LKR LOCKER WT. WEIGHT NOTE: SOME OF THE ABOVE ABBREVIATIONS MAY NOT HAVE BEEN USED FOR THIS PROJECT.   |  | <ol> <li>PENETRATIONS OF FIRE-RESISTIVE WALLS, FLOOR-CEILINGS, &amp; ROOF-CEILINGS SHALL BE PROTECTED AS REQUIRED BY CODE.</li> <li>ALL STRUCTURAL (AMONG OTHER) DWGS SHALL BE THOROUGHLY CROSSREFERENCED AGAINST ARCHITECTURAL DWGS PRIOR TO WORK DONE - ANY CONFLICTS SHALL BE BROUGHT TO ARCHITECT'S ATTENTION IMMEDIATELY.</li> <li>BACKING PLATES IN PARTITIONS SHALL BE PROVIDED IN ALL AREAS WHERE REQUIRED, WHICH WILL INCLUDE BUT IS NOT LIMITED TO, OPENED &amp; CLOSED SHELVING, COAT POLES &amp; SHELVES, CABINETRY, COUNTERS, AND SUPPORT OF TRIM.</li> <li>INSTALL ALL SIGNAGE AS REQUIRED BY CODE.</li> </ol>   |  | 2007 CALIFORNIA BLUILDING CODE & SAN FRANCISCO AMENDMENTS 2007 CALIFORNIA MECHANICAL CODE & SAN FRANCISCO AMENDMENTS 2007 CALIFORNIA PLUMBING CODE & SAN FRANCISCO AMENDMENTS 2007 CALIFORNIA ELECTRICAL CODE & SAN FRANCISCO AMENDMENTS 2007 CALIFORNIA ENERGY CODE 2007 CALIFORNIA FIRE CODE & S.F. AMENDMENTS 2007 SAN FRANCISCO HOUSING CODE 2006 NFPA 72 (FIRE ALARMS) 2006 NFPA 13/13R (SPRINKLERS)   | PROJECT SITE ROSE ST. THE PAGE | SHEET NUMBER:  AO.0   |

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| 2 | 9-17-14   | REVISION |
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1 | SITE PLAN | 1/8" = 1'-0"

# 1 FRANKLIN

SAN FRANCISCO, CA 94102

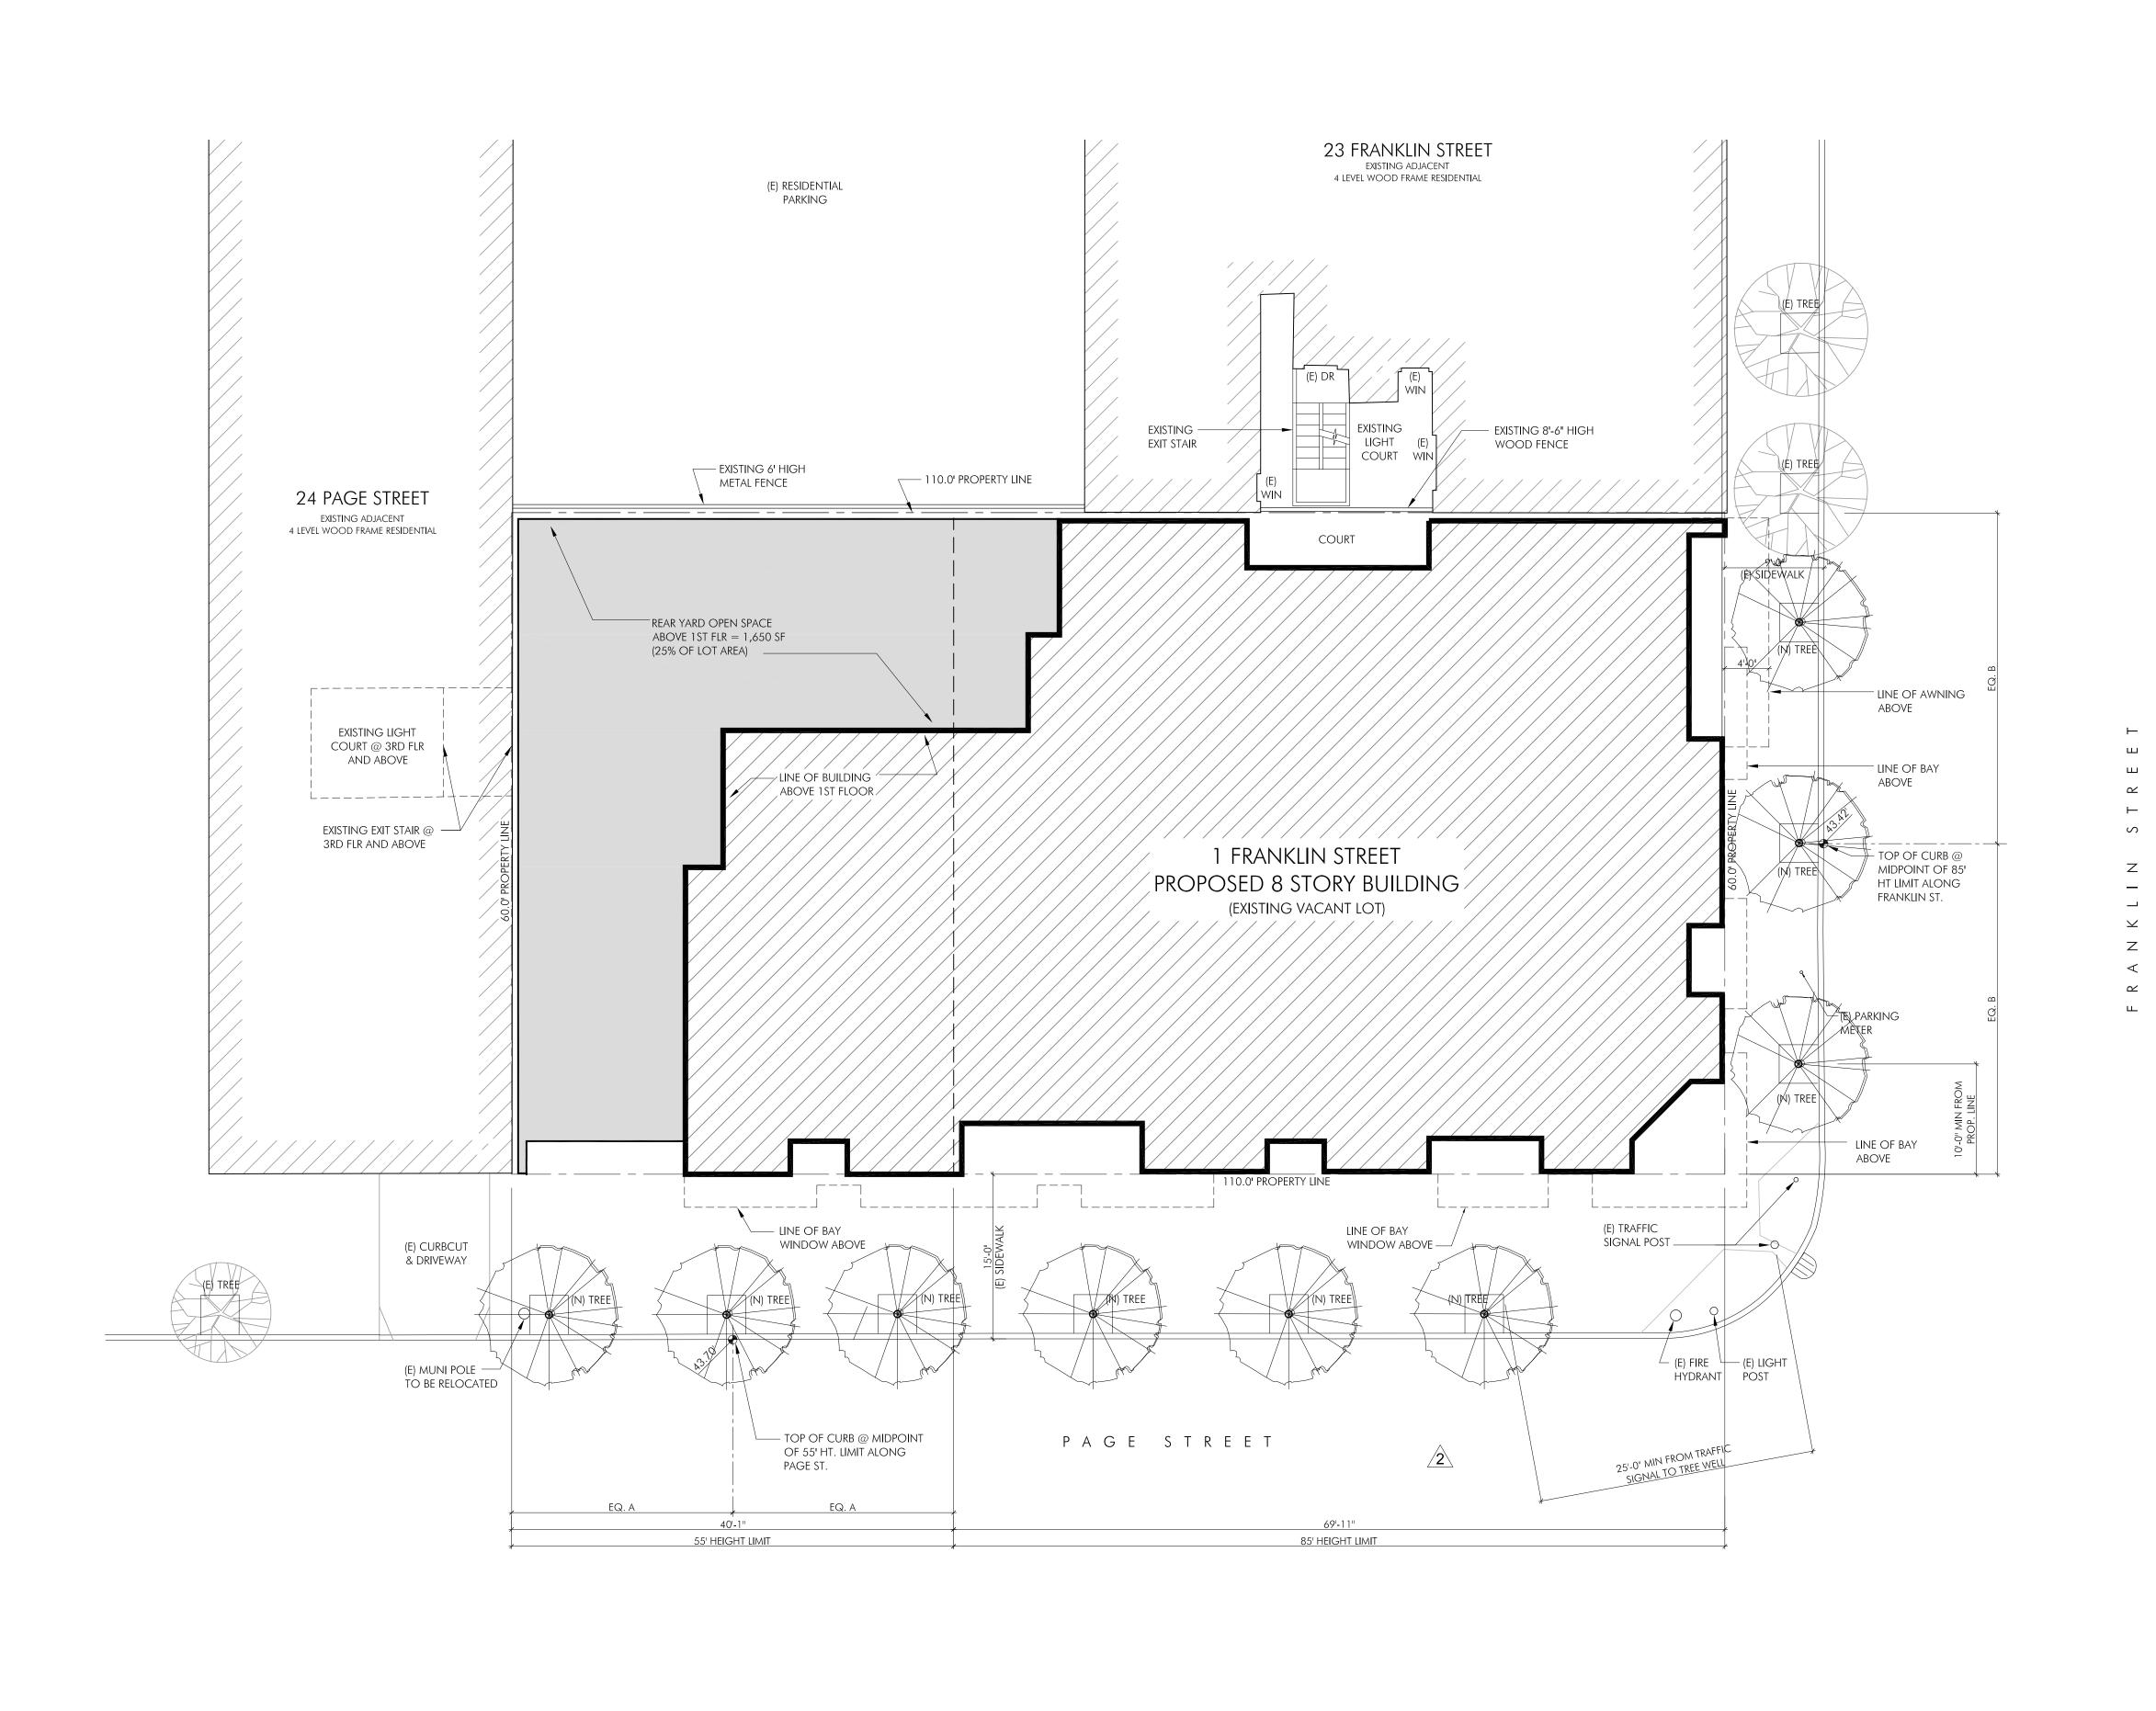


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20 FRANKLIN EXISTING RESIDENTIAL



| $\overline{\Lambda}$ | 6-16-10 | DBI PLAN CHECK COMMENTS |
|----------------------|---------|-------------------------|
|                      | 9-17-14 |                         |
| /2\                  | 9-17-14 | REVISION                |
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| JOB NUMBER:            | DRAWN BY:   |
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| 07007                  |             |
| DATE:                  | CHECKED BY: |
| 09-15-2009             |             |
| SCALE:<br>1/8" = 1'-0" |             |

SHEET TITLE:

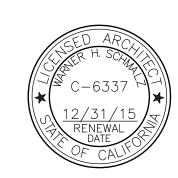SITE PLAN

SHEET NUMBER:

A1.0

### 55' HEIGHT LIMIT 85' HEIGHT LIMIT — STAIR & ELEVATOR PENTHOUSE BEYOND COMPOSITE EXTERIOR —— WALL PANELS, TYP — METAL CORNICE FACTORY FINISHED -METAL TOP RAIL @ DECKS @ TOP OF BAYS ALUMINUM METAL CORNICE @ TOP OF BAYS METAL TOPRAIL WINDOW, TYP. @ DECKS EXTERIOR METAL OR STAIR AND ELEVATOR COMPOSITE PANELS @ BAYS, TYP. PENTHOUSE BEYOND FACTORY FINISHED — T.O. FLAT ALUMINUM WINDOW, TYP 8TH FL FF 8TH FL FF 118.36' -118.36COMPOSITE EXTERIOR -WALL PANELS, TYP EXTERIOR METAL OR COMPOSITE PANELS @ BAYS, TYP. — ACCENT METAL AND TILE INSERTS, TYP. OPEN TO \_ BEYOND \_ 2ND FL FF 2ND FL FF 59.55' METAL AWNING W/ GLASS INSERTS @ COMM'L SPACE A 1ST FL FF COMMER'L ENTRANCE A 43.23 COMMER'L ENTRANCE A RESIDENTIAL GAS METER TRASH ROOM GRILLE CARRY-OUT FIRE EXIT ±44.20' LOWEST FIRE ACCESS POINT COMMERCIAL ENTRANCE C COMMERCIAL COMMERCIAL LOBBY ENTRANCE ±43.70' COMMERCIAL ENTRANCE A TOP OF CURB @ MIDPOINT OF ENTRANCE B entrance a TOP OF CURB @ MIDPOINT OF 85' ACCENT TILE METAL PLANTER HT LIMIT ALONG FRANKLIN ST. METAL AWNING W/ GLASS INSERTS @ RESID. ENTRY CERAMIC — TILE RESID. ENTRY METAL CANOPY W/ GLASS — enclosure TOP OF CURB @ INSERTS @ COMM'L SPACE A PAINTED METAL VENT — 55' HT. LIMIT GRILLE, TYP. ALONG PAGE: METAL SIGN @ COMM'L ENTRY ACCENT TILE INSERTS, TYP. MIDPOINT OF 85' HT LIMIT ALONG CERAMIC TILE — PAINTED METAL DOOR, TYP. METAL — metal sign —— @ Comm'l entry PLANTER ALONG PAGE ST. franklin st. (E) ADJACENT BUILDING (23 FRANKLIN STREET) (E) ADJACENT BUILDING (24 PAGE STREET) (E) SIDEWALK FRANKLIN STREET PAGE STREET (E) SIDEWALK 1 Franklin Street - Project Site 1 Franklin Street - Project Site EAST EXTERIOR ELEVATION - FRANKLIN ST. 2 | SOUTH EXTERIOR ELEVATION - PAGE ST.

# 1 FRANKLIN

SAN FRANCISCO, CA 94102



1014 Howard Street San Francisco, CA 94103 F 415 . 252.9020 T 415 . 252.7063

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| 1 | 6-16-10 | DBI PLAN CHECK COMMENTS |
|---|---------|-------------------------|
| 2 | 9-17-14 | revision                |
|   |         |                         |
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| JOB NUMBER:  | DRAWN BY:   |
|--------------|-------------|
| 07007        |             |
| DATE:        | CHECKED BY: |
| 09-15-2009   |             |
| SCALE:       |             |
| 1/8" = 1'-0" |             |
| SHEET TITLE: |             |

EAST & SOUTH EXTERIOR ELEVATIONS

SHEET NUMBER:

A2 (

## 85' HEIGHT LIMIT 55' HEIGHT LIMIT STAIR AND ELEVATOR —— PENTHOUSE BEYOND — SMOOTH FINISH CEMENT PLASTER COMPOSITE EXTER. SMOOTH FINISH CEMENT PLASTER WALL PANELS, TYP — FACTORY FINISHED \_\_\_\_ COMPOSITE EXTERIOR WALL PANELS, TYP ALUMINUM OR COMPOSITE PANELS @ BAYS, – STAIR AND ELEVATOR PENTHOUSE BEYOND WINDOWS, TYP. ROOF 128.42' T.O. FLAT ROOF - SMOOTH FINISH CEMENT PLASTER 8TH FL FF 118.36' 8TH FL FF 118.36 — EXTERIOR METAL OR COMPOSITE PANELS @ BAYS, TYP. FACTORY FINISHED ALUMINUM WINDOW,TYP - METAL TOP RAIL @ DECKS - (E) ADJACENT (E) ADJACENT BUILDING BEYOND (23 FRANKLIN STREET) (23 FRANKLIN STREET) 2ND FL FF - - <u>59.55'</u> 59.55 OUTLINE OF LIGHTCOURT OF EXISTING ADJACENT BUILDING EXTERIOR METAL OR COMPOSITE PANELS - SMOOTH FINISH — CEMENT PLASTER smooth finish $^{igtherapprox}$ CEMENT PLASTER @ DECKS FF @ RES. ——— STORAGE BEYOND COMMERCIAL C ENTRY 44.20' 44.28' 1ST FL FF COMMER'L ENTRANCE A 43.23' (E) ADJACENT BUILDING (24 PAGE STREET) FRANKLIN STREET (E) SIDEWALK 1 FRANKLIN STREET - PROJECT SITE (E) RESID PARKING (E) SIDEWALK 1 FRANKLIN STREET - PROJECT SITE

1 WEST EXTERIOR ELEVATION

2 | NORTH EXTERIOR ELEVATION | 1/8" = 1'-0"

# 1 FRANKLIN

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| 1 | 6-16-10 | DBI PLAN CHECK COMMENTS |
|---|---------|-------------------------|
| 2 | 9-17-14 | revision                |
|   |         |                         |
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JOB NUMBER: DRAWN BY: 07007

DATE: CHECKED BY: 09-15-2009


SCALE: 1/8" = 1'-0"

SHEET TITLE:

WEST & NORTH EXTERIOR ELEVATIONS

SHEET NUMBER:

A2.1

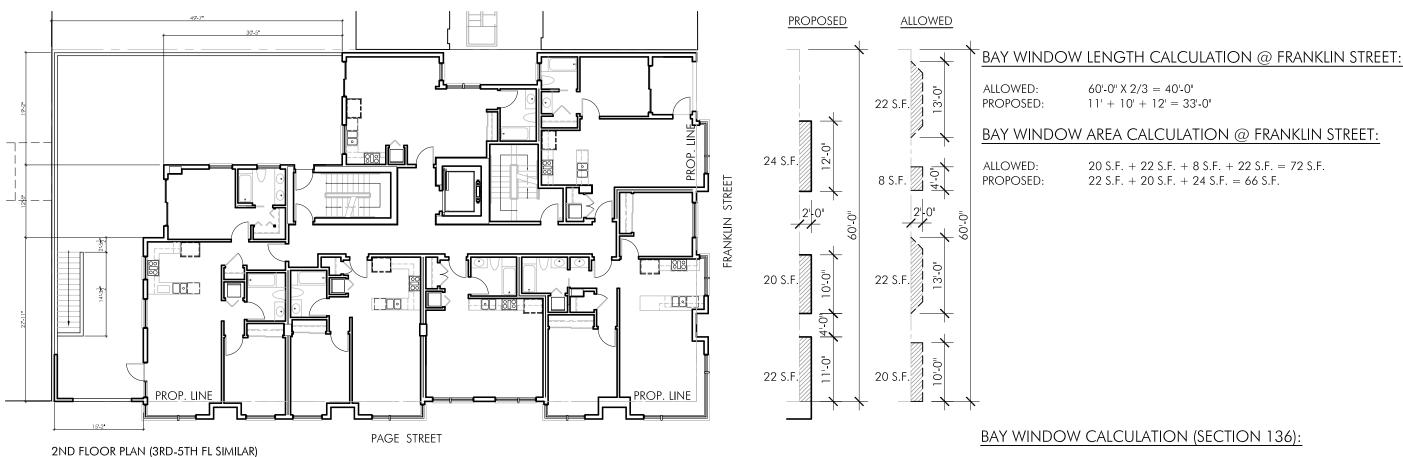

12'-0"

30/S,F/

10'-0"

10'-0"

V/34/5/5<u>/</u>5

| BUILDABLE LOT WIDTH @ PAGE STREET                           | 94'-4"       |
|---|--------------|
| BUILDABLE LOT WIDTH @ FRANKLIN STREET                       | 60'-0''      |
| TOTAL BUILDABLE LOT WIDTH                                   | 154'-4"      |
|   |              |
| ALLOWABLE BUILDABLE LOT WIDTH @ PAGE ST. (94'-4" X 2/3)     | 62'-1 5/8"   |
| ALLOWABLE BUILDABLE LOT WIDTH @ FRANKLIN ST. (60'-0" X 2/3) | 40'-0"       |
| TOTAL ALLOWABLE BUILDABLE LOT WIDTH                         | 102'-10 5/8" |
|   |              |
| PROPOSED BAY WINDOW LENGTH @ PAGE STREET                    | 74'-0"       |
| PROPOSED BAY WINDOW LENGTH @ FRANKLIN STREET                | 33'-0"       |
| TOTAL PROPOSED BAY WINDOW LENGTH                            | 107'-0" *    |

### \* PROPOSED BAY WINDOW DESIGN IS 4.0 % OVER ALLOWABLE LENGTH ADMINISTRATIVE APPROVAL REQUESTED

| ALLOWABLE BAY WINDOW AREA @ PAGE STREET     | 184.5 S.F.    |
|---|---------------|
| ALLOWABLE BAY WINDOW AREA @ FRANKLIN STREET | 72.0 S.F.     |
| TOTAL ALLOWABLE BAY WINDOW AREA             | 256.5 S.F.    |
|   |               |
| PROPOSED BAY WINDOW AREA @ PAGE STREET      | 182.5 S.F.    |
| PROPOSED BAY WINDOW AREA @ FRANKLIN STREET  | 66.0 S.F.     |
| TOTAL PROPOSED BAY WINDOW AREA              | 248.5 S.F. ** |

<sup>\*\*</sup> PROPOSED BAY WINDOW DESIGN IS 8.0 S.F. LESS THAN PRESCRIBED ALLOWABLE AREA ADMINISTRATIVE APPROVAL REQUESTED

### BAY WINDOW LENGTH CALCULATION @ PAGE STREET:

ALLOWED:  $94'-4" \times 2/3 = 62'-10 5/8"$ 

12'-0"

**PROPOSED** 

**ALLOWED** 

PROPOSED: 12' + 4' + 16' + 4' + 12' + 10' + 4' + 12'' = 74'-0''

### BAY WINDOW AREA CALCULATION @ PAGE ST.:

ALLOWED: 30 S.F. + 30 S.F. + 30 S.F. + 30 S.F. + 34.5 S.F. + 30 S.F. = 184.5 S.F.

118 S.F 16'-0"

12'-0"

94'-4"

10'-0"

PROPOSED: 118 S.F. + 64.5 S.F. = 182.5 S.F.

0 4' 8' 16' 32' SCALE: 1/16" = 1'-0"

FRANKLIN STREET





A-8

T F R A N K L I N
S A N F R A N C I S C O , C A L I F O R N I A 9 4 1 0 2

