

SAN FRANCISCO PLANNING DEPARTMENT

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Disclaimer for Review of Plans

The San Francisco Planning Code requires that the plans of certain proposed projects be provided to members of the public prior to the City's approval action on the project. Accordingly, any images of plans featured on this website are provided for the primary purpose of facilitating public input prior to the City's action. The City and County of San Francisco does not own the copyright to these images. Please be aware that the unauthorized reproduction, distribution, or alteration of these images may result in a violation of Federal Copyright Law (17 U.S.C.A. Sections 101 et seq.) and that any party who seeks to reproduce or alter these images does so at his or her own risk.

Additionally, plans provided on this website are limited to site plans, elevations and/or section details (floor plans and structural details may not be included). These are DRAFT PLANS being provided for public review PRIOR to the City's approval action on the project. Final plans may differ from those that are currently available for review.

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SAN FRANCISCO PLANNING DEPARTMENT

1650 Mission Street, Suite 400 • San Francisco, CA 94103 • Fax (415) 558-6409

NOTICE OF PUBLIC HEARING

Hearir	ng Date:	Wednesday, S	September 24,	, 2014	
Time:		9:30 AM			
Location:		City Hall, 1 Dr. Carlton B. Goodlett Place, Room 408			
Case Type: Variance (Rear Yard, Open Space, Exposure and Unit		xposure and Unit Mix)			
Hearing Body: Zoning Administrator					
PORPERTY INFORMATION APPLICATION INFORMATION					
Project Address:	530-548 B	rannan St	Case No.:	2014.1021V	
Cross Street(s):	4th and 5t	h Streets	Building Permit:	n/a	
Block / Lot No.:	3777/073-	174	Applicant/Agent:	Justin Chu, Essex Portfolio, LP	
Zoning District(s):	RED / 40-2	X	Telephone:	(650) 463-6377	
Area Plan:	Western S	SoMa Area Plan	E-Mail:	jchu@essex.com	
PROJECT DESCRIPTION					

The project includes establishment of 27 dwelling units. The project would result in: 32 live/work units and 10 dwelling units at 530 Brannan Street; 36 live/work units and 9 dwelling units at 542 Brannan Street; and, 34 live/work units and 8 dwelling units at 548 Brannan Street.

PER SECTION 134 OF THE PLANNING CODE, the subject property is required to maintain a rear yard of 25-feet. The existing building occupies the majority of the subject lot and encroaches into the required rear yard. Legalization of the dwelling units in the building requires a rear yard variance.

PER SECTION 135 OF THE PLANNING CODE, the subject property is required to provide at least 80 square feet of useable open space per dwelling unit. Currently, the project does not provide adequate useable open space for the dwelling units; therefore, a useable open space variance is required.

PER SECTION 140 OF THE PLANNING CODE, all dwelling units must directly face an open area, public street or public alley at least 25-feet wide. The proposal would legalize up to twenty dwelling units which do not meet the exposure requirements; therefore, an exposure variance is required.

PER SECTION 207.6 OF THE PLANNING CODE, the proposal must provide a dwelling unit mix of 40% 2 bedrooms or 30% 3 bedrooms. The proposed unit mix does not comply with this requirement; therefore, a variance is required.

ADDITIONAL INFORMATION

FOR MORE INFORMATION, PLEASE CONTACT PLANNING DEPARTMENT STAFF:Planner: Richard SucreTelephone: 415-575-9108Mail: Richard.Sucre@sfgov.org

ARCHITECTURAL PLANS: The site plan and elevations of the proposed project are available on the Planning Department's website at: http://sf-planning.org/ftp/files/notice/2014.1021V.pdf

GENERAL INFORMATION ABOUT PROCEDURES

VARIANCE HEARING INFORMATION

Under Planning Code Section 306.3, you, as a property owner or resident within 300 feet of this proposed project or interested party on record with the Planning Department, are being notified of this Variance Hearing. You are not obligated to take any action. For more information regarding the proposed work, or to express concerns about the project, please contact the Applicant/Agent or Planner listed on this notice as soon as possible. Additionally, you may wish to discuss the project with your neighbors and neighborhood association or improvement club, as they may already be aware of the project.

Persons who are unable to attend the public hearing may submit written comments regarding this application to the Zoning Administrator, Planning Department, 1650 Mission Street, Suite 400, San Francisco, CA 94103, by 5:00pm the day prior to the hearing. These comments will be made a part of the official public record, and will be brought to the attention of the person or persons conducting the public meeting or hearing

BUILDING PERMIT APPLICATION INFORMATION

Under Planning Code Section 311/312, the Building Permit Application for this proposal is also subject to a 30-day notification to occupants and owners within 150-feet of the subject property. **The mailing of such notification will be perfromed separately.**

BOARD OF APPEALS

An appeal of the approval (or denial) of a **variance application** by the Zoning Administrator may be made to the **Board of Appeals within 10 days** after the **Variance Decision Letter** is issued by the Zoning Administrator.

An appeal of the approval (or denial) of a **building permit application** by the Planning Department may be made to the **Board of Appeals within 15 days** after the **building permit** is issued (or denied) by the Director of the Department of Building Inspection.

Appeals must be submitted in person at the **Board's office at 1650 Mission Street**, **3rd Floor**, **Room 304**. For further information about appeals to the Board of Appeals, including current fees, **contact the Board of Appeals** at **(415) 575-6880**.

ABOUT THIS NOTICE

The Planning Department is currently reviewing its processes and procedures for public notification as part of the Universal Planning Notification (UPN) Project. The format of this Public Hearing notice was developed through the UPN Project and is currently being utilized in a limited trial-run for notification of Variance Hearings.

If you have any comments or questions related to the UPN Project or the format of this notice, please visit our website at <u>http://upn.sfplanning.org</u> for more information.

INTERIOR MODIFICATIONS TO LIVE/WORK LOFTS: 530 BRANNAN STREET, SAN FRANCISCO, CA 94107

PROJECT INFO GENERAL SCOPE OF WORK PROJECT DATA SUMMARY LEGALIZE OCCUPANCY CLASSIFICATION OF 7 EXISTING LIVE/WORK UNITS FOR RESIDENTIAL USE. **PROPERTY MANAGEMENT: ARCHITECT: CIVIL ENGINEER:** 530 BRANNAN: RSS ARCHITECTURE, INC. ESSEX PROPERTY TRUST, INC. UNDERWOOD & ROSENBLUM, INC. OCCUPANCY: ANDREW RAYMUNDO, ARCHITECT 925 E. MEADOW DRIVE 1630 OAKLAND ROAD, SUITE A114 TYPE OF CONSTRUCTION: PALO ALTO, CA 94303 SAN JOSE, CA 95131 APN: CONTACT: JIMMY CHANG CONTACT: JUSTIN CHU CONTACT: DAVE VOORHIES, P.E. ZONING: 915 TERMINAL WAY, SUITE C SPRINKLERS: SAN CARLOS, CA 94070 TEL: 650.494.3700 TEL: 408.453.1222 STORIES: TEL: 650.802.6865 EXISTING LOT AREA: EXISTING BLDG : TOTAL NO. OF EXISTING UNITS **ELECTRICAL ENGINEER:** NO. OF NEW UNITS NUTEK ENGINEERS TOTAL NO. OF NEW UNITS 600 MAGDALENA AVE LOS ALTOS, CA 94024 TOTAL NO. OF EXISTING PARKING STALLS 38 (UNCHANGED CONTACT: PERRY SAEEDNIA TEL: 650.796.7553 **GENERAL NOTES** SYMBOLS **APPLICABLE CODES** CONTRACTOR SHALL NOTIFY ARCHITECT IF THERE ARE ANY DISCREPANCIES BETWEEN THE REFERENCE DRAWINGS AND ACTUAL BUILT CONDITION, EXTERIOR ELEVATIONS 2013 CALIFORNIA BUILDING CODE PRIOR TO CONSTRUCTION TO RESOLVE. - ELEVATION NUMBER - SHEET NUMBER 2013 CALIFORNIA FIRE CODE 2. IT IS THE INTENT OF THESE DOCUMENTS TO MAINTAIN THE EXISTING RATED WALL ASSEMBLIES. 2013 CALIFORNIA ELECTRICAL CODE ARCHITECTURAL DETAILS 2013 CALIFORNIA PLUMBING CODE DETAIL NUMBER - SHEET NUMBER 2013 CALIFORNIA MECHANICAL CODE LEGEND NOTES 2013 ENERGY CODE COMPLIANCE - NOTE NUMBER ALL LOCAL CODES & ORDINANCES BY THE CITY OF SAN FRANCISCO

BENNETT LOFTS

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42

3777-107-138

12,000 SQ.FT.

11,156 SQ.FT.

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	The Hotel Utah Saloon The Hotel Utah Saloon	JOB: 1303 NORTH:	
	PROJECT SITE		

PERMIT SET 08/21/14

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915 TERMINAL WA

C-32316

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GENERAL

NO GUARANTEE FOR QUALITY OF CONSTRUCTION IS IMPLIED OR INTENDED BY THESE ARCHITECTURAL DOCUMENTS. THE GENERAL CONTRACTOR SHALL ASSUME FULL RESPONSIBILITY FOR ANY AND ALL CONSTRUCTION DEFICIENCIES.

CONSTRUCTION IS ALWAYS LESS THAN PERFECT SINCE BUILDINGS REQUIRE THE COORDINATION AND INSTALLATION OF MANY INDIVIDUAL PARTS BY THE VARIOUS CONSTRUCTION INDUSTRY TRADES. THESE DOCUMENTS CANNOT PORTRAY ALL COMPONENTS OR ASSEMBLIES EXACTLY. IT IS THE INTENT OF THESE ARCHITECTURAL DOCUMENTS THAT THEY REPRESENT A REASONABLE STANDARD OF CARE IN THEIR CONTENT. IT SHALL BE THE CONTRACTOR'S RESPONSIBILITY TO FULLY RECOGNIZE AND PROVIDE THAT STANDARD OF CARE.

THE CONSTRUCTION ASSEMBLIES DEPICTED IN THESE DOCUMENTS MAY PROVIDE FOR THE CONTACT OF DISSIMILAR MATERIALS WHICH, WHEN FINISH COATED OR SUBJECTED TO MOIST WEATHER CONDITIONS, MAY RESULT IN DISCOLORATION OF SOME OF THE MATERIAL SURFACES. THESE CONDITIONS MAY REQUIRE PERIODIC INSPECTION, MAINTENANCE AND/OR RE-COATING AT CLOSER INTERVALS THAN OTHER NON-AFFECTED SURFACES.

THESE ARCHITECTURAL CONSTRUCTION DRAWINGS DESCRIBE THE REQUIREMENTS OF THE PROJECT FOR A BUILDING PERMIT AND TO PREPARE ESTIMATES OF QUANTITY AND COSTS OF MATERIALS REQUIRED TO CONSTRUCT THE PROJECT. THESE DRAWINGS PROVIDE FOR ONLY SCHEMATIC PLUMBING/MECHANICAL EQUIPMENT LAYOUT AND SCHEMATIC ELECTRICAL POWER AND LIGHTING LAYOUT AS PREPARED BY THE ARCHITECT WITHOUT ENGINEERING DESIGNS, DETAILS, CALCULATIONS OR SPECIFICATIONS.

BY USE OF THESE DOCUMENTS, THE CONTRACTOR ACKNOWLEDGES THAT RSS ARCHITECTURE, AS THE ARCHITECT, IS THE AUTHOR OF, AND THEREFORE RESPONSIBLE FOR THE INTERPRETATION OF THESE DESIGN DOCUMENTS AND THAT THE CONTENT, CONCEPTS OR BASIC DESIGN DEMONSTRATED BY THE DOCUMENTS SHALL NOT BE FURTHER DEVELOPED, INTERPRETED, CLARIFIED OR TRANSFERRED WITHOUT WRITTEN CONSENT FROM THE ARCHITECT.

CHANGES TO THE PLANS AND SPECIFICATIONS BY MEANS OF SHOP DRAWINGS BECOME THE RESPONSIBILITY OF THE PERSON INITIATING SUCH CHANGES.

ALL GENERAL NOTES, SHEET NOTES AND LEGEND NOTES FOUND IN THESE DOCUMENTS SHALL APPLY, TYPICALLY, THROUGHOUT. IF INCONSISTENCIES ARE FOUND IN THE VARIOUS NOTATIONS, NOTIFY THE ARCHITECT IMMEDIATELY IN WRITING REQUESTING CLARIFICATION. IT IS THE EXPRESS INTENT OF THE PARTIES HERETO THAT THE ARCHITECT IS EXCULPATED FROM ANY LIABILITY WHATSOEVER, OCCASIONED BY THE CONTRACTOR'S FAILURE TO CARRY OUT THE WORK IN ACCORDANCE WITH THE CONTRACT DOCUMENTS.

INSOFAR AS THERE ARE MANY VARIABLES INVOLVED IN THE EXECUTION OF THE WORK DESCRIBED IN THESE DOCUMENTS, THE ARCHITECT DOES NOT CARRY ANY WARRANTY EXPRESSED OR IMPLIED FOR THE WORK OF THE TRADES.

THESE DOCUMENTS ARE COMPLETE AS PREPARED BY THE ARCHITECT. ADDITIONAL DOCUMENTS, INCLUDING WRITTEN SPECIFICATIONS, MAY BE PREPARED BY OTHERS AND USED TO SUPPLEMENT THE WORK OF THE CONTRACTOR. THE CONTRACTOR SHALL BE RESPONSIBLE FOR COORDINATING ALL SUPPLEMENTAL WORK IN CONFORMANCE WITH THESE DOCUMENTS.

THE CONTRACTOR SHALL, BY THE USE OF THESE DOCUMENTS, BE REQUIRED TO PROVIDE UNDERSTANDABLE AND THOROUGH INSTRUCTIONS TO THE OWNER ABOUT HIS/HER RESPONSIBILITIES FOR ON-GOING MAINTENANCE. THESE INSTRUCTIONS SHALL DESCRIBE PERIODIC INSPECTIONS AND PROCEDURES FOR MAINTENANCE OF BUILDING SYSTEMS AND MATERIALS, INCLUDING BUT NOT LIMITED TO: DRAINAGE, EROSION CONTROL, PLUMBING, MECHANICAL, PAVING, WATERPROOFING, DECKING, ROOFING, GLAZING, PAINTING, SEALANTS, ETC. THE CONTRACTOR SHALL OBTAIN INFORMATION AND INSTRUCTIONS FROM THE VARIOUS SUBCONTRACTORS, INSTALLERS AND MANUFACTURERS REGARDING MAINTENANCE OF THEIR SPECIFIC PORTIONS OF WORK AND MATERIALS. ALL WARRANTIES AND/OR GUARANTEES SHALL BE IDENTIFIED. THESE INSTRUCTIONS SHALL BE WRITTEN SO AS TO HAVE THE HOMEOWNER PROMPTLY ALERT THE CONTRACTOR AS TO ANY UNUSUAL WEARING OF MATERIALS OR MALFUNCTION OF COMPONENTS AND/OR ASSEMBLIES OF THE CONSTRUCTION. THE INSTRUCTIONS SHALL IDENTIFY THE EXPECTED USUAL WEARING. MOVEMENTS OR DEFORMATION OF MATERIALS AND THEIR PROJECTED LIFE.

ALL WORK SHALL COMPLY WITH APPLICABLE CODES AND TRADE STANDARDS WHICH GOVERN EACH PHASE OF THE WORK; INCLUDING, BUT NOT LIMITED TO: 2013 CALIFORNIA BUILDING CODE (CBC); CALIFORNIA MECHANICAL CODE (CMC); CALIFORNIA ELECTRICAL CODE (CEC); UNIFORM FIRE CODE (UFC); AMERICAN CONCRETE INSTITUTE (ACI); CALIFORNIA PLUMBING CODE (CPC), AND ALL APPLICABLE STATE AND/OR LOCAL CODES AND/OR LEGISLATION.

SITE EXAMINATION

THE CONTRACTOR AND ALL SUBCONTRACTORS SHALL THOROUGHLY EXAMINE THE SITE AND FAMILIARIZE THEMSELVES WITH THE CONDITIONS UNDER WHICH THE WORK IS TO BE PERFORMED. THE CONTRACTOR SHALL VERIFY, AT THE SITE, ALL MEASUREMENTS AFFECTING HIS WORK AND SHALL BE RESPONSIBLE FOR THE CORRECTIONS OF SAME. NO EXTRA COMPENSATION WILL BE ALLOWED TO THE CONTRACTOR FOR EXPENSES DUE TO HIS NEGLECT TO EXAMINE OR FAILURE TO DISCOVER CONDITIONS WHICH AFFECT HIS WORK.

DIMENSION CONTROL

IT IS THE RESPONSIBILITY OF THE CONTRACTOR AND ALL SUBCONTRACTORS TO CHECK AND VERIFY ALL CONDITIONS, DIMENSIONS, LINES AND LEVELS INDICATED. PROPER FIT AND ATTACHMENT OF ALL PARTS IS REQUIRED. SHOULD THERE BE ANY DISCREPANCIES, THE CONTRACTOR AND ALL SUBCONTRACTORS SHALL IMMEDIATELY NOTIFY THE ARCHITECT FOR CORRECTION OR ADJUSTMENT. IN THE EVENT OF FAILURE TO DO SO, THE CONTRACTOR SHALL BE RESPONSIBLE FOR CORRECTION OF ANY ERROR.

ALL DIMENSIONS AND CONDITIONS SHALL BE CHECKED AND VERIFIED ON THE JOB BY EACH SUBCONTRACTOR BEFORE HE BEGINS HIS WORK. ANY ERRORS, OMISSIONS OR DISCREPANCIES SHALL BE BROUGHT TO THE ATTENTION OF THE OWNER OR CONTRACTOR BEFORE CONSTRUCTION BEGINS. COMMENCEMENT OF WORK BY THE CONTRACTOR AND/OR ANY SUBCONTRACTOR SHALL INDICATE A KNOWLEDGE AND ACCEPTANCE OF ALL CONDITIONS DESCRIBED IN THESE CONSTRUCTION DOCUMENTS, OR EXISTING ON SITE, WHICH COULD AFFECT THEIR WORK.

DIMENSION CONTROL HAS BEEN TAKEN FROM READILY OBSERVABLE EXISTING CONDITIONS AND FIELD MEASUREMENTS. ADJUSTMENTS MAY HAVE TO BE EMPLOYED SHOULD AS-BUILT CONDITIONS VARY FROM ORIGINAL DOCUMENTS.

CONTROL OF APPROVAL

CONTRACTOR SHALL INCLUDE AND IMPLEMENT IN THE WORK ALL PERTINENT REQUIREMENTS FOR THIS PROJECT AS SET FORTH IN THE CONDITIONS OF APPROVAL BY THE CITY AGENCIES. A COPY OF THESE CONDITIONS IS AVAILABLE FROM THE OWNER AND ARCHITECT.

CONTINUING OPERATIONS

WHEN IT IS NECESSARY THAT THE OWNER CONTINUE PRESENT OCCUPANCY DURING THE RENOVATION WORK, THE CONTRACTOR SHALL, AFTER CONSULTING WITH THE OWNER, SCHEDULE THE WORK SO AS NOT TO INTERFERE WITH NORMAL HOUSEHOLD OPERATIONS.

WORK SEQUENCE

IN THE EVENT THAT SPECIAL SEQUENCING OF THE WORK IS REQUIRED BY THE OWNER, THE CONTRACTOR SHALL ARRANGE A CONFERENCE BEFORE ANY SUCH WORK IS BEGUN

MOISTURE PROTECTION

IT IS THE INTENT OF THESE DOCUMENTS TO PROVIDE DETAILS FOR CONSTRUCTION WHICH WILL TO THE BEST OF THE ARCHITECT'S KNOWLEDGE, THE CONSTRUCTION ASSEMBLIES RESULT IN A MOISTURE RESISTANT BUILDING ENVELOPE. IT IS THE RESPONSIBILITY OF THE REPRESENTED AND DETAILED IN THESE DOCUMENTS CONFORM TO THE STATE OF CALIFORNIA CONTRACTOR TO NOTIFY THE ARCHITECT OF ANY EXCEPTION HE MAY TAKE TO ANY OF THE ENERGY CONSERVATION REGULATIONS AS MANDATED IN THE TITLE 24 ENERGY COMPLIANCE DETAILS OR METHODS DESCRIBED HEREIN. IF THE CONTRACTOR IS AWARE OF ALTERNATE STANDARDS. WHILE THESE REGULATIONS RESULT IN A VERY TIGHT AIR AND MOISTURE MATERIALS OR METHODS THAT WILL BETTER SATISFY THIS INTENT, HE SHALL SO NOTIFY THE EXTERIOR ENVELOPE, THE SELECTION OF SPECIFIC VAPOUR RETARDERS AND AIR BARRIERS, ARCHITECT, IN WRITING, ALLOWING THE ARCHITECT TO MODIFY HIS DOCUMENTS ACCORDINGLY. AND PREVAILING CLIMATIC CONDITIONS MAY AFFECT OR IMPACT OTHER MEMBERS WITHIN THE FLOOR, WALL, CEILING AND ROOF ASSEMBLIES. THE CONTRACTOR, SUBCONTRACTOR AND SHOULD ANY SPECIAL SITUATION OCCUR DURING CONSTRUCTION, INCLUDING VARIOUS MATERIAL SUPPLIERS SHALL HAVE FULL RESPONSIBILITY IN SELECTION OF THESE MATERIALS CLIMATIC CONDITIONS, WHICH NECESSITATE APPLICATIONS OR METHODS TO INSURE THE AND SHALL EACH MAKE KNOWN TO ALL OTHERS ANY AND ALL EFFECTS OR IMPACTS THAT PROTECTION OF MATERIALS AND ASSEMBLIES, THE CONTRACTOR OR SUBCONTRACTOR (S) MAY OCCUR AND AFFECT THE SELECTION OF OTHER ASSEMBLY MATERIALS OR PROCEDURES SHALL SO NOTICE AND IMPLEMENT ANY OR ALL PROTECTIVE MEASURES. NECESSARY FOR PROPER CONSTRUCTION. THE CONTRACTOR SHALL FURTHER BE RESPONSIBLE FOR TESTING OF THESE ASSEMBLIES SHOULD IT BE REQUIRED OR DETERMINED ALL DOWNSPOUTS, SCUPPERS AND LEADERHEADS SHALL BE SIZED TO ACCOMMODATE TO STUDY THE PERFORMANCE OF THESE ASSEMBLIES AGAINST MOISTURE INFILTRATION, TRIBUTARY ROOF AREAS SERVED. IT SHALL BE THE RESPONSIBILITY OF THE INSTALLER TO MOISTURE ENTRAPMENT AND/OR ADVERSE AFFECTS ON THE DURABILITY, AESTHETICS, PROVIDE ANY AND ALL DESIGN, CALCULATIONS AND DATA THAT MAY BE REQUIRED IN ENERGY USE EFFICIENCY AND REASONABLE COMFORT WITHIN THE BUILDING(S) AS MAY BE

SUPPORT OF THIS SYSTEM. ALL RESPONSIBILITY FOR THE SYSTEM AND ITS FUNCTION SHALL CAUSED BY MOISTURE INFILTRATION AND ENTRAPMENT. BE BORNE BY THE SYSTEM DESIGNER AND/OR INSTALLER.

DEMOLITION NOTES

THESE ARCHITECTURAL DRAWINGS SHALL BE USED TO DETERMINE THE LIMITS OF NEW CONSTRUCTION AND EXISTING CONSTRUCTION TO REMAIN. THESE DRAWINGS ARE NOT INTENDED TO SHOW ALL EXISTING CONSTRUCTION. THE GENERAL CONTRACTOR SHALL BE RESPONSIBLE FOR DETERMINING THE EXTENT AND SCOPE OF EXISTING CONSTRUCTION TO BE REMOVED.

THE GENERAL CONTRACTOR SHALL PERFORM WORK IN OR ON THE EXISTING BUILDING. THIS CONSISTS PRINCIPALLY OF, BUT NOT NECESSARILY LIMITED TO, THE CUTTING AND REPAIR OR REPLACEMENT OF PORTIONS OF THE EXISTING BUILDING AS SHOWN, OR AS NECESSARY FOR INSTALLATION OR ERECTION OF NEW WORK, OR REMODELLING CALLED FOR ON DRAWINGS OR IN SPECIFICATIONS.

THE GENERAL CONTRACTOR SHALL MAKE ALL NECESSARY ARRANGEMENTS WITH OWNER FOR ENTRY AND EXECUTION OF WORK IN OR ON THE EXISTING BUILDING.

THE GENERAL CONTRACTOR SHALL ACCEPT THE SITE AS THEY FIND IT AND BE FAMILIAR WITH ITS CHARACTER AND THE TYPE OF WORK TO BE REMOVED. HE SHALL ENTIRELY DEMOLISH ON THE SITE ANY STRUCTURE OR PORTION THEREOF INDICATED TO BE REMOVED, AND SHALL NOT REMOVE ANY STRUCTURE FROM THE SITE, EITHER AS A WHOLE OR SUBSTANTIALLY AS A WHOLE WHERE NOT INDICATED. THE OWNER ASSUMES NO RESPONSIBILITY FOR THE CONDITION OF THE PORTIONS OF BUILDING TO BE REMOVED AND/OR DEMOLISHED.

THE GENERAL CONTRACTOR SHALL SEE THAT ALL SERVICES, TO THE AREAS TO BE DEMOLISHED, SUCH AS WATER, GAS, STEAM, ELECTRICITY AND TELEPHONE LINES, ARE DISCONNECTED AT THE ENTRIES AS APPLICABLE, ALL IN ACCORDANCE WITH THE RESTRICTIVE RULES AND REGULATIONS GOVERNING THE UTILITIES INVOLVED.

THE CONTRACTOR SHALL BE RESPONSIBLE FOR THE LOCATION OF ALL EXISTING UTILITIES AND COORDINATE THEIR REMOVAL TO AVOID ANY INTERRUPTION OF SERVICE TO ADJACENT PROPERTIES.

THE GENERAL CONTRACTOR SHALL PROVIDE AND INSTALL SHORING REQUIRED IN CONNECTION WITH THE DEMOLITION OPERATIONS, AND THE SUPPORTS SHALL HOLD THE EXISTING WORK THAT IS TO REMAIN IN PROPER POSITION UNTIL NEW SUPPORTING MEMBERS. AND INJURIES TO THE PUBLIC.

AFTER WORK HAS BEEN STARTED, IT SHALL BE CARRIED OUT TO COMPLETION, PROMPTLY, EXPEDITIOUSLY, AND IN AN ORDERLY MANNER, USING METHODS COMMONLY EMPLOYED, AND AS PROVIDED UNDER THE CITY OR COUNTY CODE FOR DEMOLITION WORK AS APPLICABLE.


GENERALLY, THE GENERAL CONTRACTOR SHALL DO ANY CUTTING AND REMOVE ANY OR ALL ITEMS, WHETHER SPECIFICALLY MENTIONED OR INDICATED, WHICH OBVIOUSLY WILL INTERFERE WITH OR BECOME INCONGRUOUS TO PROPOSED CONSTRUCTION FINISHES. WHEN ITEM(S) IS/ARE QUESTIONABLE, HE SHALL NOTIFY THE ARCHITECT. THE GENERAL CONTRACTOR SHALL EXERCISE UTMOST CARE TO SEE THAT MINIMUM CUTTING IS DONE.

SALVAGE

ALL ITEMS DEEMED SALVAGEABLE BY THE OWNER WILL EITHER BE INDICATED ON THE DRAWINGS, AND SHALL BE REMOVED PRIOR TO THE START OF DEMOLITION, OR WILL BE DIRECTED BY THE OWNER TO BE STORED BY THE CONTRACTOR AND SHALL REMAIN THE PROPERTY OF THE OWNER. ITEMS TO BE RELOCATED WILL BE INDICATED ON THE DRAWINGS. WITH THE EXCEPTION OF ANY SALVAGEABLE ITEMS, AS DIRECTED BY THE OWNER TO BE RETAINED, ALL REMOVED STRUCTURES AND MATERIALS SHALL BECOME THE PROPERTY OF THE CONTRACTOR. NO DEBRIS OR CONTRACTOR SALVAGEABLE ITEMS SHALL BE STORED OR ACCUMULATED ON THE PREMISES.

SITE PROTECTION

THE GENERAL CONTRACTOR SHALL PROTECT ALL INTERIOR AND EXTERIOR EXISTING CONSTRUCTION THAT IS TO REMAIN, INCLUDING LANDSCAPING ALONG THE PROPERTY LINES, AS WELL AS ON ADJACENT LOTS. ANY DAMAGE OR LOSS RESULTING FROM NEW CONSTRUCTION WORK SHALL BE CORRECTED OR REPLACED BY THE CONTRACTOR AT NO ADDITIONAL COST TO THE OWNER.

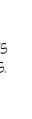

THE GENERAL CONTRACTOR SHALL BE FAMILIAR WITH MUNICIPAL REGULATIONS AND CARRY OUT THE WORK IN COMPLIANCE WITH ALL FEDERAL AND STATE REQUIREMENTS TO REDUCE FIRE HAZARDS AND INJURIES TO THE PUBLIC.

THE GENERAL CONTRACTOR SHALL PROVIDE AND INSTALL A TEMPORARY CONSTRUCTION FENCE, MEETING CITY STANDARDS, DURING CONSTRUCTION AND TAKE ALL MEASURES TO PROTECT THE PUBLIC FROM INJURY CAUSED ON SITE.

GLAZING REQUIREMENTS

ALL WINDOWS AND DOORS MUST MEET THE AIR AND INFILTRATION STANDARDS OF THE CURRENT ANSI AND SHALL BE CERTIFIED AND LABELLED.

HEATING DESIGN TEMPERATURE

MINIMUM INSIDE WINTER DESIGN TEMPERATURE IS 70 DEGREES

VAPOUR RETARDER AND AIR BARRIER

HAZARDOUS MATERIALS

THE ARCHITECT AND THE ARCHITECT'S CONSULTANTS ARE NOT "OWNER OR OPERATOR" AS DEFINED UNDER NESHAP, SECTION 112 OF THE CLEAN AIR ACT AND THEREFORE SHALL HAVE NO RESPONSIBILITY FOR THE DISCOVERY, PRESENCE, HANDLING, REMOVAL TRANSPORTATION, STORAGE OR DISPOSAL OF OR EXPOSURE OF PERSONS TO HAZARDOUS MATERIAL IN ANY FORM AT THE PROJECT PREMISES, INCLUDING BUT NOT LIMITED TO ASBESTOS, ASBESTOS PRODUCTS, POLYCHLORINATED BIPHENYL (PCB) OR OTHER TOXIC SUBSTANCES.

FLASHING CONDITIONS

FLASHING CONDITIONS SHOWN IN THESE PLANS WILL REQUIRE REMOVAL OF (E) SIDING ON ADJACENT SURFACES. CONTRACTOR TO COORDINATE W/ ARCHITECT FOR FLASHING INSTALLATION FOR AREAS WHERE SIDING IS NOT SCHEDULED FOR REPLACEMENT.

SYMBOLS

or NO. ABBREVIATIONS A.B. ABV A.C. PAVING A/C A.D. ADH. ADJ. AFF. ALT. ALUM. ANG. BA. BD. BDRM. BLDG. BLKG. BM. BOT. CAB. CEM. CLG. CLO. CLR. COL. CONC. CONST. CONT. CTR. DBL. D.F. DIA. DIAG. DIM. DIN. RM. DN. D.S. DTL. DWG. (E) or EXIST EIFS ELEC. EQ. EQPT. E.W. EXT. F.A.U. F.A.R. F.D. FDN. F.E.C. FIN. FLASH'G. FLR. F.O.C. F.O.M. F.O.S. FRM. FT. FTG. GA. GAR. G.D. G.F.I. G.I. GLULAM. GYP. BD. H.B. H.C. HDWD. HORIZ. HR. ΗT HVAC I.I.C. IN. INCL. INSUL. INT. JAN. KIT. LAM. LAUND. LAV. LB. or # LIN. LIV. RM.

REVIATION LIST

ANGLE AND CENTER LINE DIAMETER OR ROUND PFNNY NUMBER SQUARE FOOT ANCHOR BOLT ABOVE ASPHALT CONCRETE PAVING AIR CONDITIONING AREA DRAIN ADHESIVE ADJACENT ABOVE FINISH FLOOR ALTERNATE ALUMINUM ANGLE BATHROOM BOARD BEDROOM BUILDING BLOCKING BEAM BOTTOM CABINET CEMENT CEILING CLOSET CLEAR COLUMN CONCRETE CONSTRUCTION CONTINUOUS CENTER DRYER DOUBLE DOUGLAS FIR OR DRINKING FOUNTAIN DIAMETER DIAGONAL DIMENSION DINING ROOM DOWN DOWNSPOUT DETAIL DRAWING EXISTING EACH EXTERIOR INSULATION FINISH SYSTEM T.O. ELECTRICAL EQUAL EQUIPMENT EACH WAY EXTERIOR FORCED AIR UNIT FLOOR AREA RATIO FLOOR DRAIN FOUNDATION FIRE EXTINGUISHER CABINET FINISH FLASHING FLOOR FACE OF CONCRETE FACE OF MASONRY FACE OF STUD FRAME FEET FOOTING GUAGE GARAGE GARBAGE DISPOSAL GROUND FAULT INTERRUPTER GALVANIZED IRON GLULAM BEAM GYPSUM BOARD HOSE BIB HOLLOW CORE HARDWOOD HORIZONTAL HOUR

HEIGHT HEATING VENTILATION & AIR CONDITIONING IMPACT INSULATION CLASS INCH INCLUDE

CSI

ICBO

NFPA

NRCA

UBC

UFC

WIC

ADA

ADAAG

SMACNA

INSULATION INTERIOR JANITOR

KITCHEN

LAMINATE LAUNDRY LAVATORY POUND LINEN LIVING ROOM LIGHTWEIGHT

LT. WT.

MAT. MAX. MECH. MEMB. MFR. MIN. MSTR. BDRM. MTL. N.I.C. N.T.S. 0.C. 0.Н. OPNG. OPP PAN. PDR. PL. P. LAM. PLAST. PLYWD. PREFAB. P.T. P.T.D.F. P.T. SLAB RAG RFG. REG. REQ'D. RM. RDWD. REF. S.C. SCH. S.G.D. SHT. SIM. SPEC. S.T.C. STL. STOR. STRUCT. SUBFLR. SQ. SQ. FT. TOIL. T.P.H. TYP. U.O.N. VERT. V.G.D.F. W/ W WD. WIN. W.P. W.R. GYP. BD. WT. W.W.F. YD. AGENCIES ACI. AIA AISC AITG ANSI ASTM CAC CBC CEC CMC CPC


MECHANICAL MEMBRANE MANUFACTURER MINIMUM MASTER BEDROOM METAL NEW NOT IN CONTRACT NOT TO SCALE OVER ON CENTER (S) OPPOSITE HAND OPENING OPPOSITE PANTRY POWDER ROOM PLATE PLASTIC LAMINATE PLASTER PLYWOOD PREFABRICATED PRESSURE-TREATED PRESSURE TREATED DOUGLAS FIR POST TENSION SLAB RETURN AIR GRILLE REFRIGERATOR REGISTER REQUIRED ROOM REDWOOD REFER SOLID CORE SCHEDULE SLIDING GLASS DOOR SHEET SIMILAR SPECIFICATION SOUND TRANSMISSION CLASS STEEL STORAGE STRUCTURE OR STRUCTURAL SUB-FLOOR SQUARE SQUARE FOOT TELEPHONE TOP OF TOILET TOILET PAPER HOLDER TYPICAL UNLESS OTHERWISE NOTED VERTICAL VERTICAL GRAIN DOUGLAS FIR WITH WASHER WOOD WINDOW WATERPROOFING W.R. GYPSUM BOARD WELDED WIRE FABRIC YARD AMERICAN CONCRETE INSTITUTE

MATERIAL

MAXIMUM

THE AMERICAN INSTITUTE OF ARCHITECTS AMERICAN INSTITUTE OF STEEL CONSTRUCTION AMERICAN INSTITUTE OF TIMBER CONSTRUCTION AMERICAN NATIONAL STANDARDS INSTITUTE AMERICAN SOCIETY FOR TESTING & MATERIALS CALIFORNIA ADMINISTRATIVE CODE CALIFORNIA BUILDING CODE CALIFORNIA ELECTRICAL CODE CALIFORNIA MECHANICAL CODE CALIFORNIA PLUMBING CODE CONSTRUCTION SPECIFICATION INSTITUTE INTERNATIONAL CONFERENCE OF BUILDING OFFICIALS NATIONAL FIRE PROTECTION ASSOCIATION NATIONAL ROOFING CONTRACTORS ASSOCIATION SHEET METAL & AIR CONDITIONING CONTRACTORS NATIONAL ASSOCIATION UNIFORM BUILDING CODE UNIFORM FIRE CODE UNDERWRITERS LABORATORIES, INC. WOODWORK INSTITUTE OF CALIFORNIA **ABBREVIATED CODES & STANDARDS**

> AMERICANS WITH DISABILITIES ACT AMERICANS WITH DISABILITIES ACT ACCESSIBILITY GUIDELINES

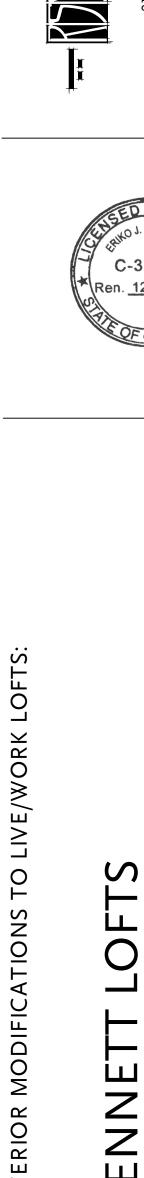

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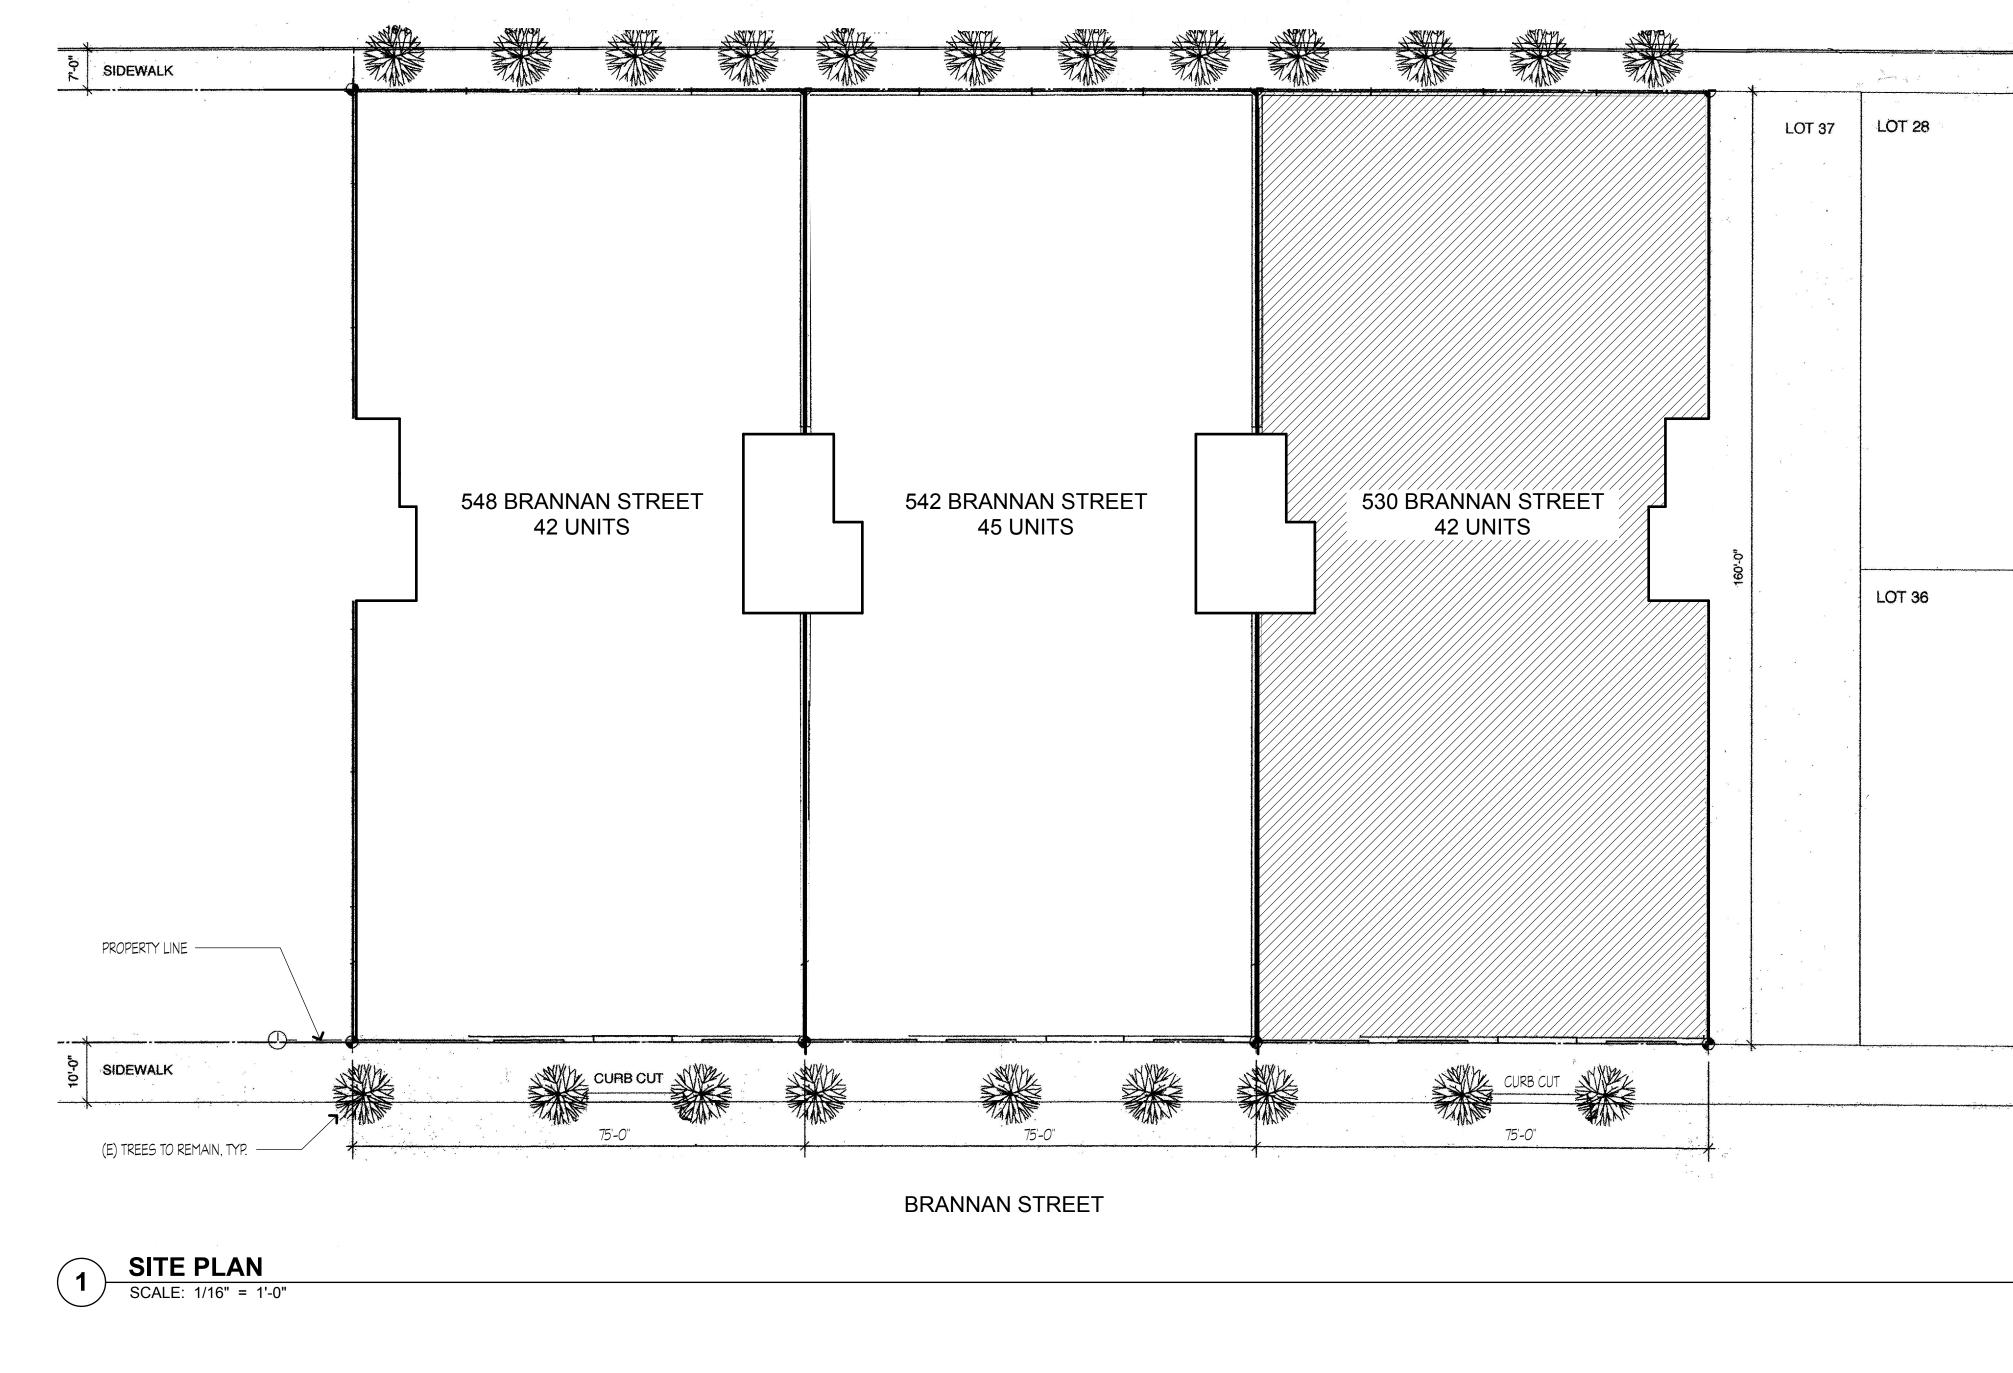
GENERAL NOTES

JOB: 1303


DRAWN ΡI

SHEET NO.

PERMIT SET 08/21/14



FREELON STREET

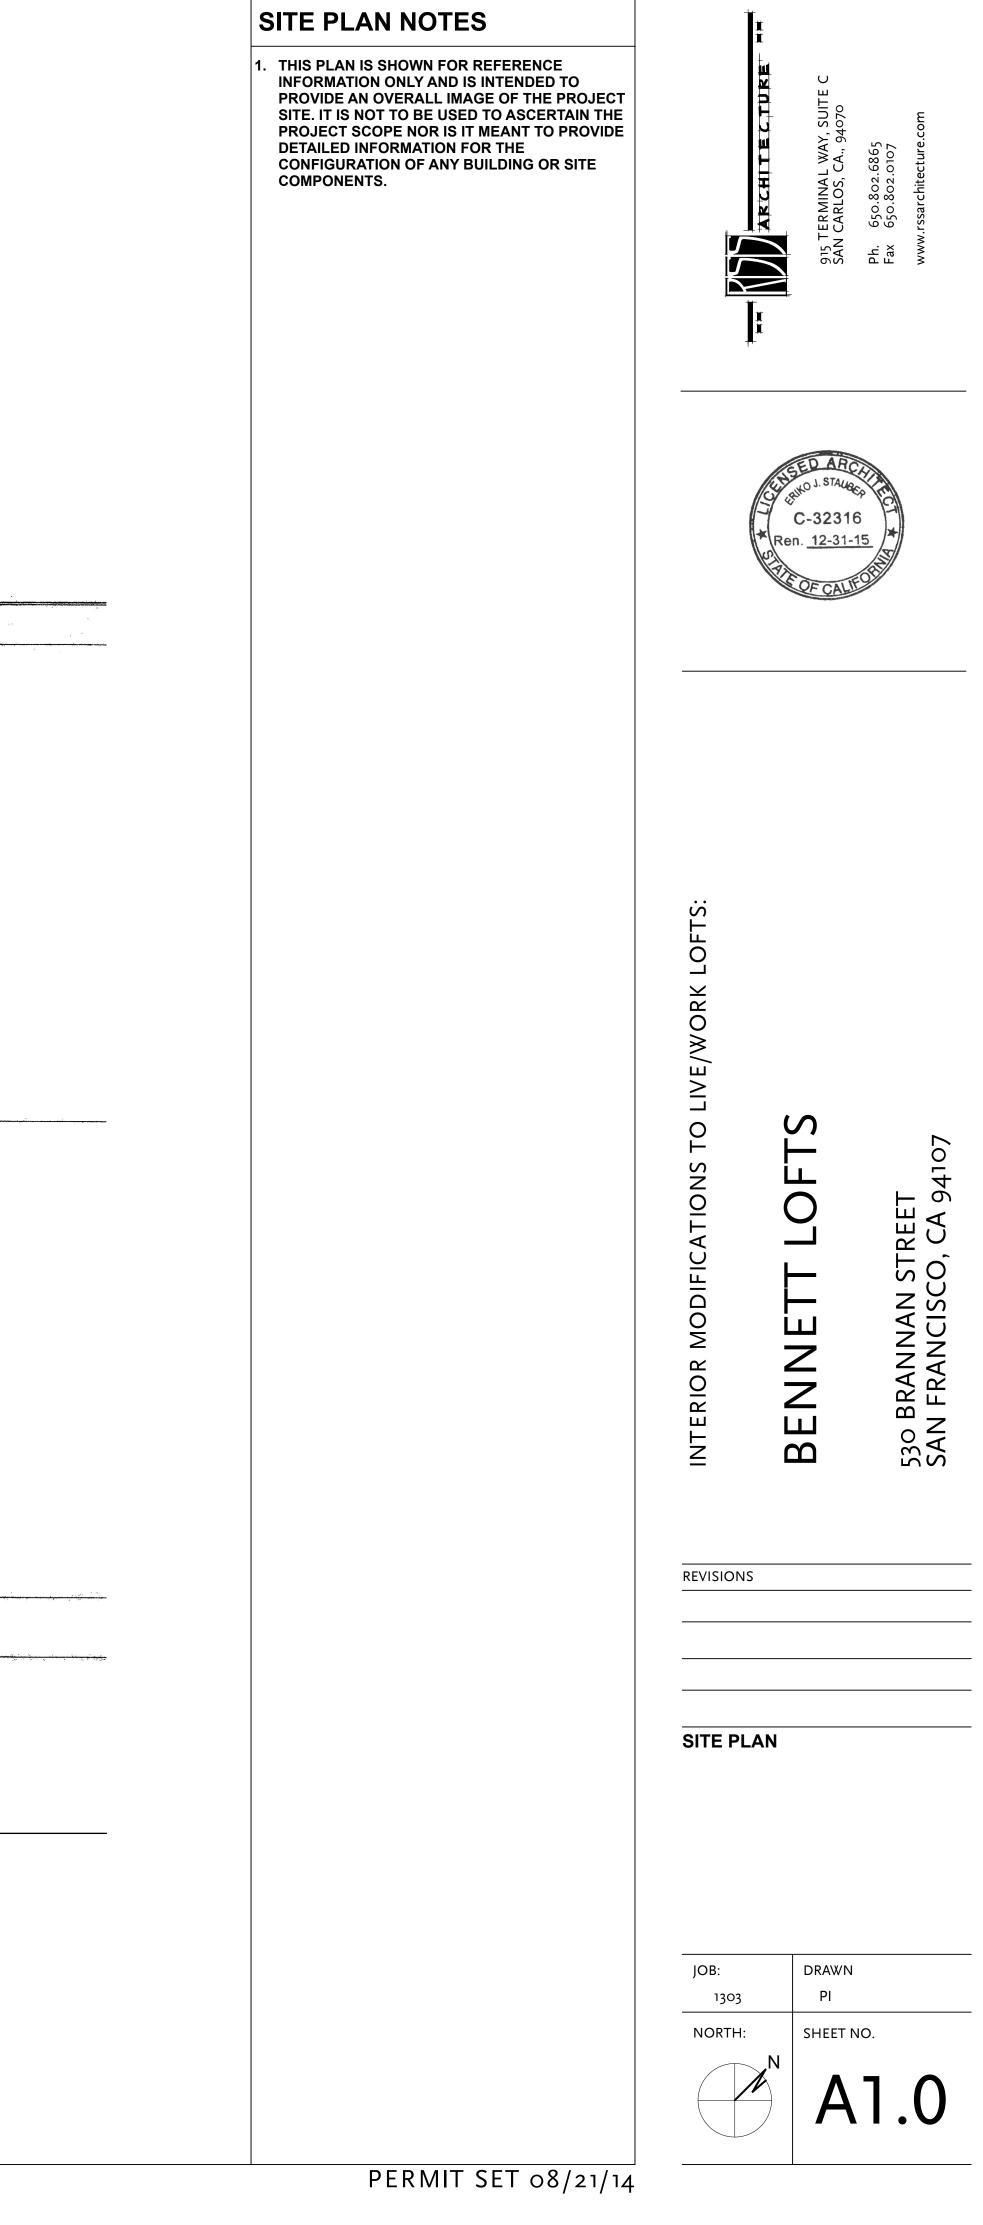



1



EXISTING SECOND FLOOR BUILDING PLAN SCALE: 1/8" = 1'-0"

(2)

PERMIT SET 08/21/14

ING PLAN NOTES EXISTING UNITS TO BE RENOVATED EXISTING WALL TO REMAIN EXISTING WALL TO BE REMOVED NEW WALL TO MATCH EXISTING (NON-LOAD BEARING WALL, TYP.) NEW PARTITION WALL TYP.		915 TERMINAL WAY, SUITE C SAN CARLOS, CA., 94070	Ph. 650.802.6865 Fax 650.802.0107 www.rssarchitecture.com
		C-3231 Ren. 12-31-	15
	INTERIOR MODIFICATIONS TO LIVE/WORK LOFTS:	NG BUILDING	530 BRANNAN STREET SAN FRANCISCO, CA 94107


JOB: 1303 DRAWN

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SHEET NO.




EXISTING THIRD FLOOR BUILDING PLAN SCALE: 1/8" = 1'-0"



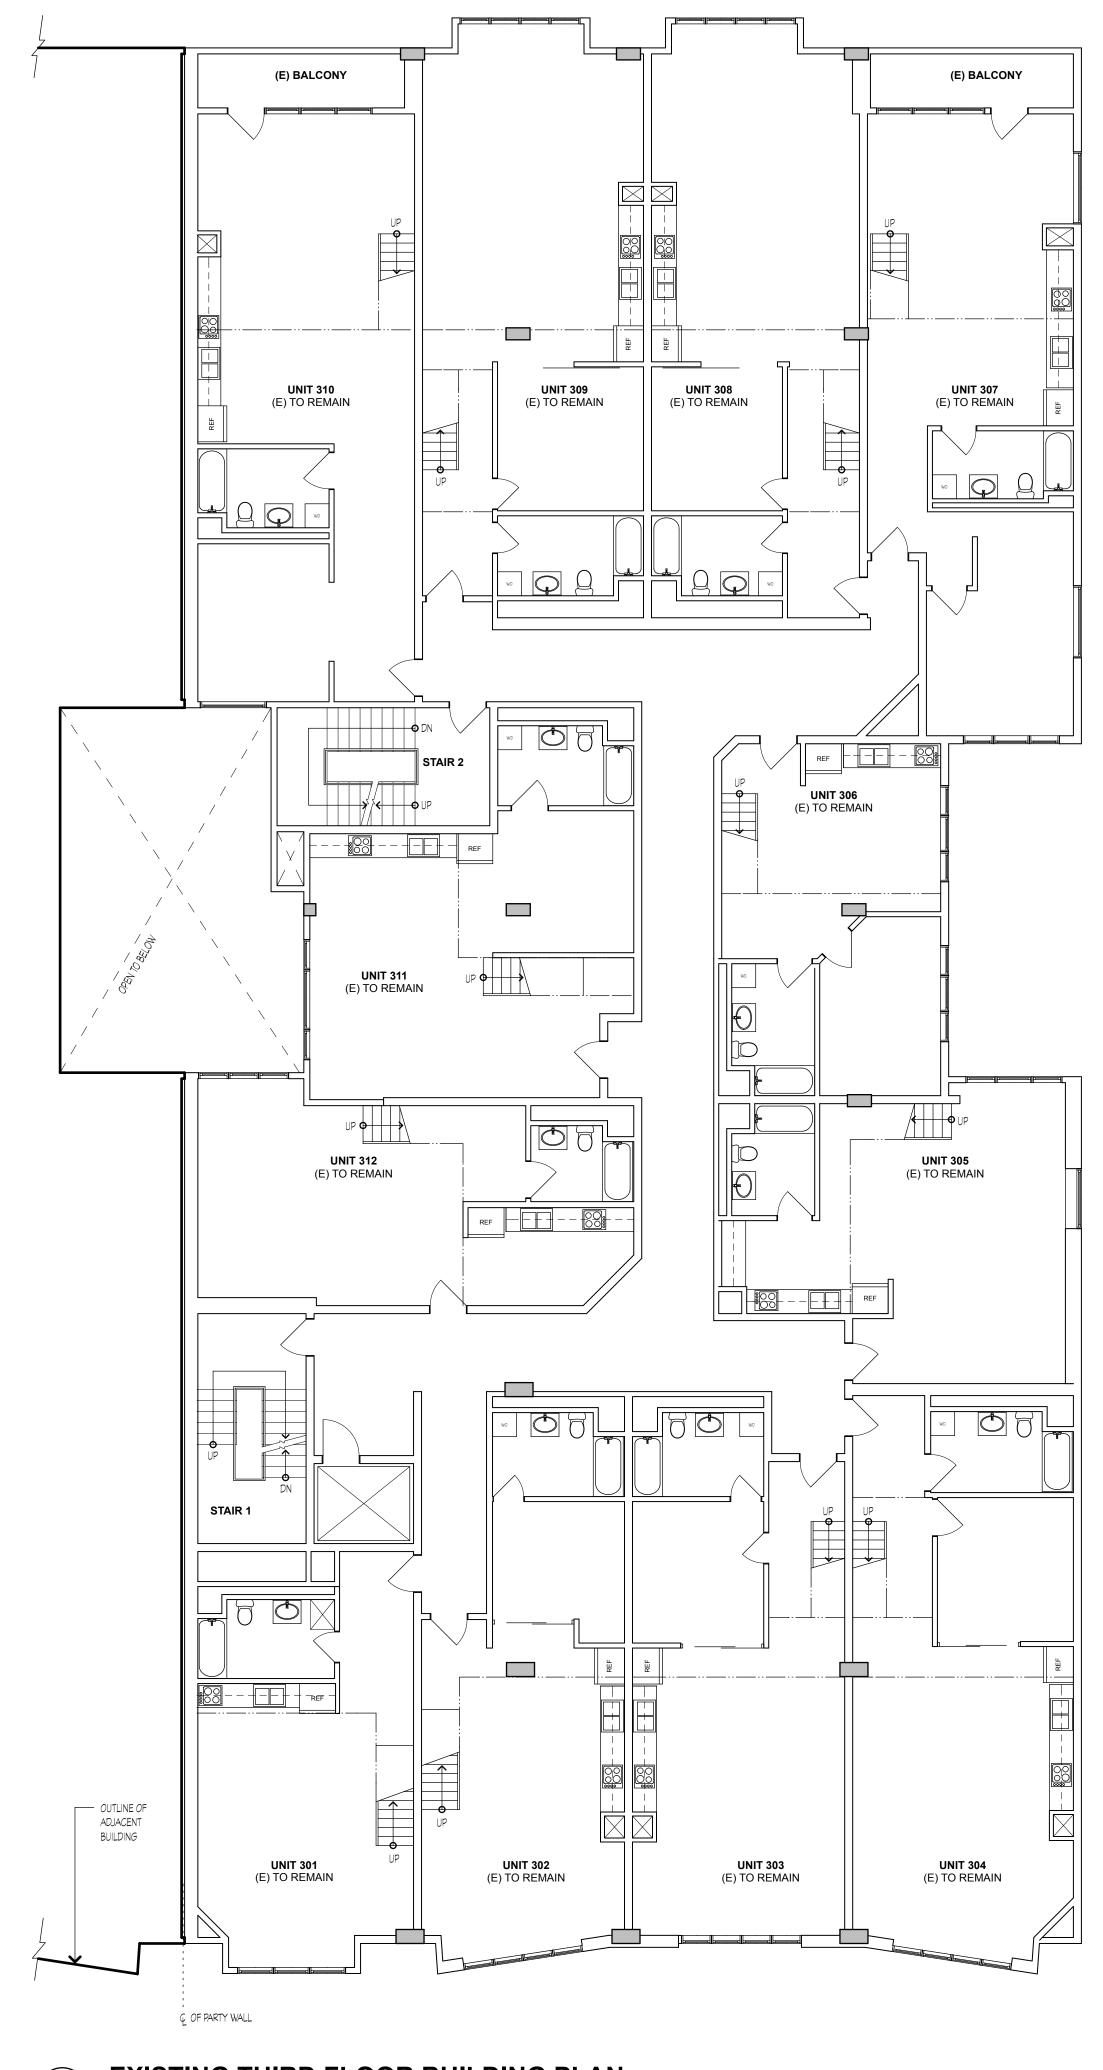



EXISTING THIRD FLOOR MEZZANINE BUILDING PLAN SCALE: 1/8" = 1'-0"

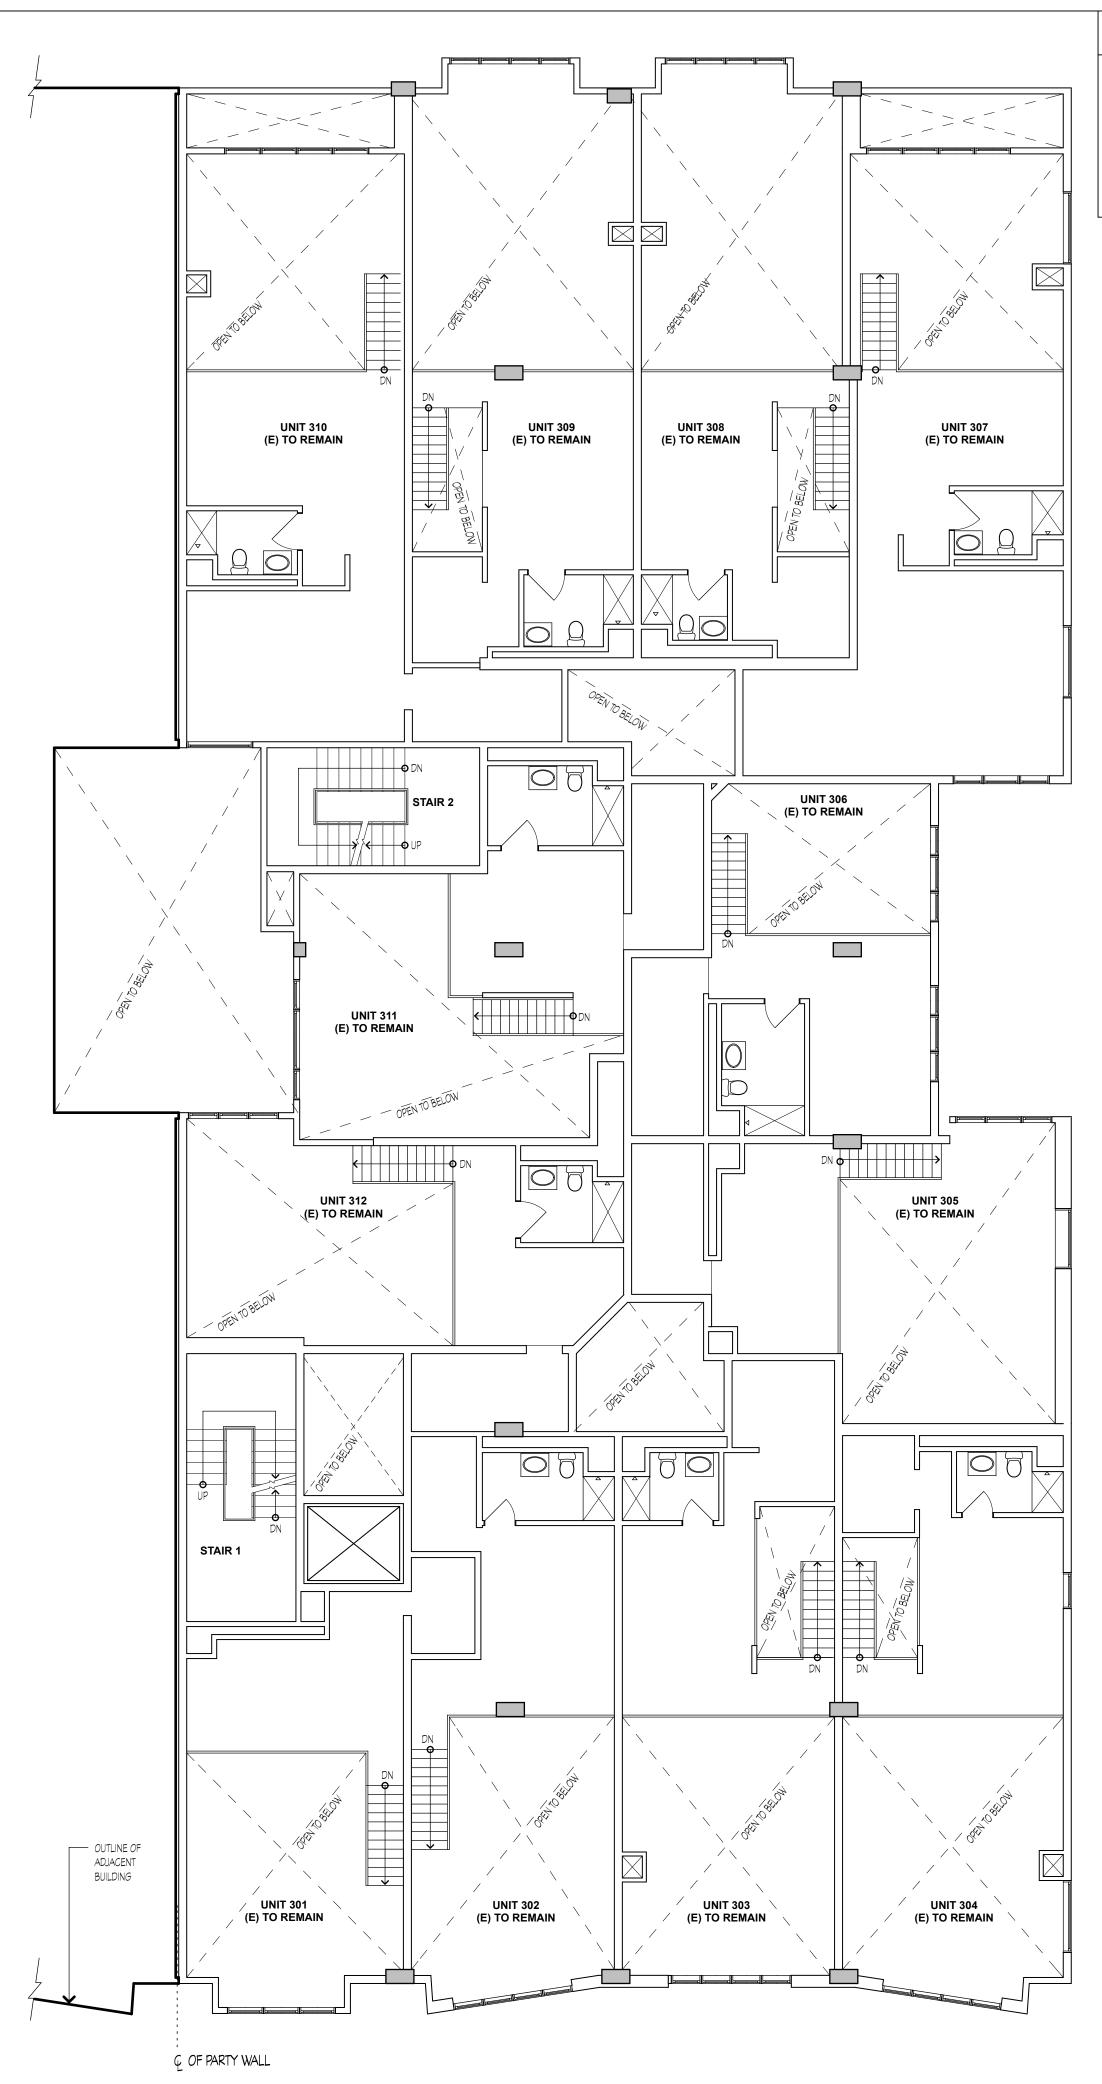


NOTES

SEE SHEET A2.0 FOR BUILDING PLAN LEGEND AND NOTES NOT SHOWN.

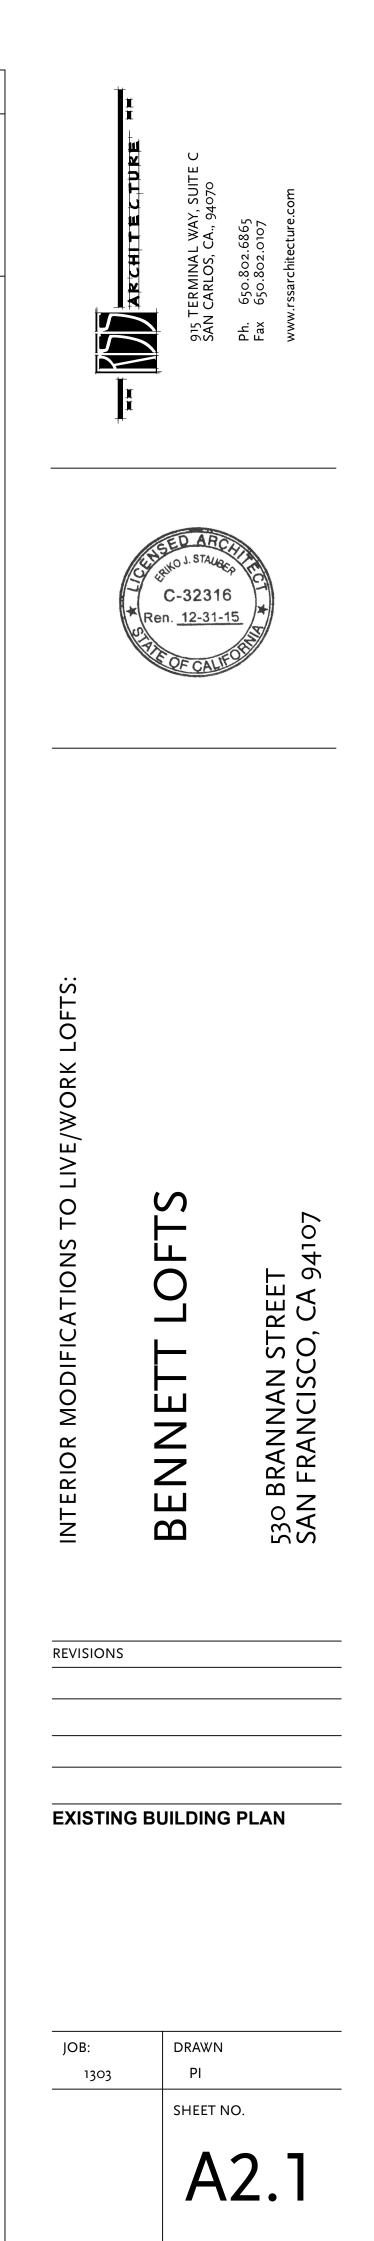


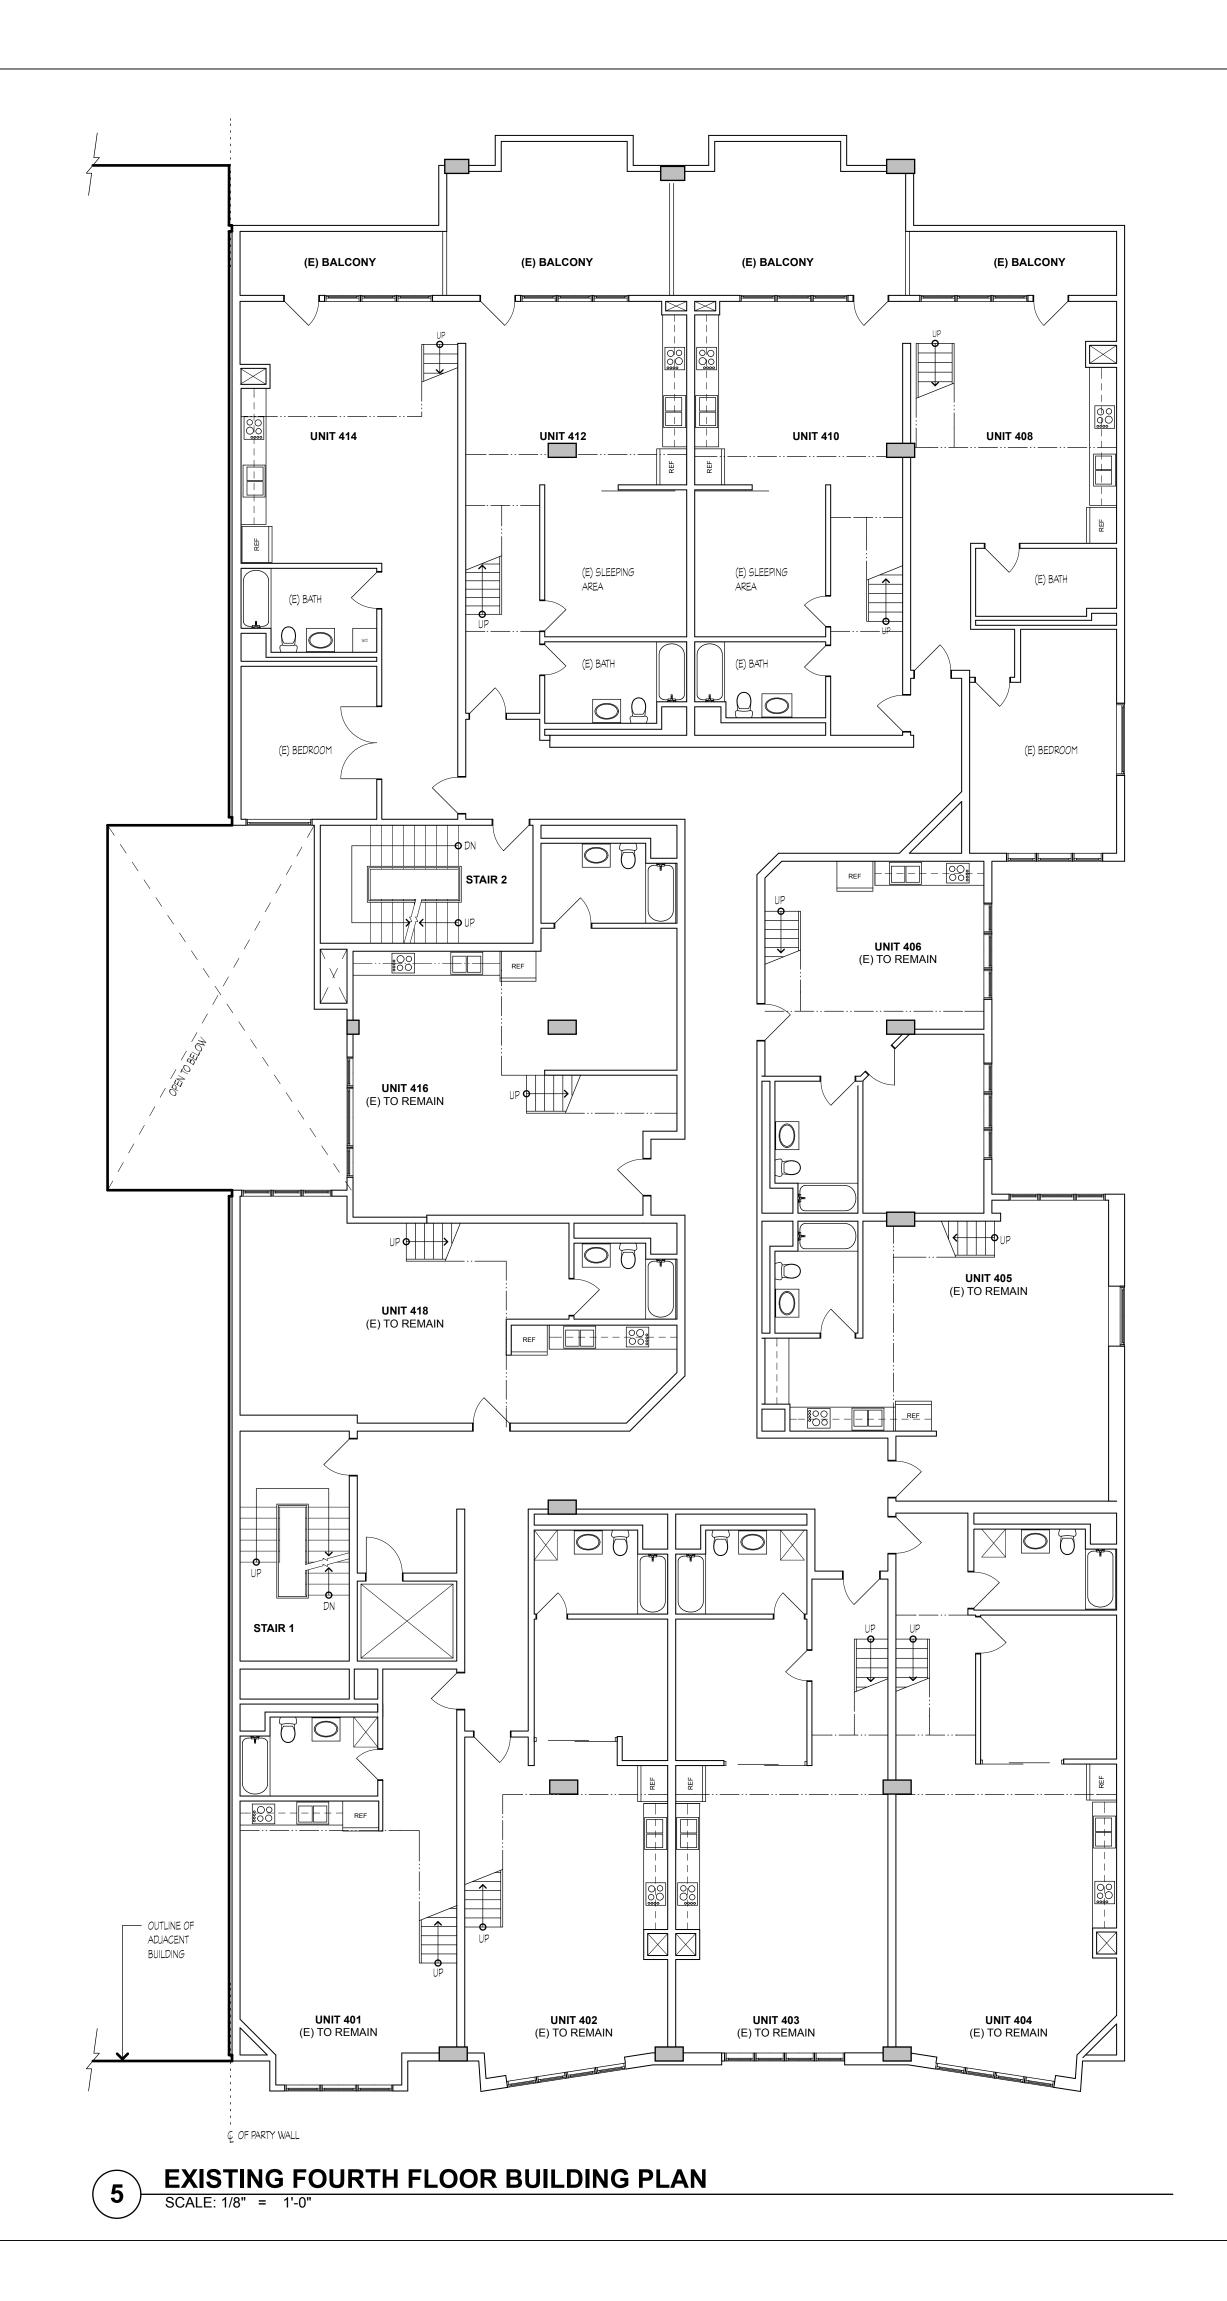


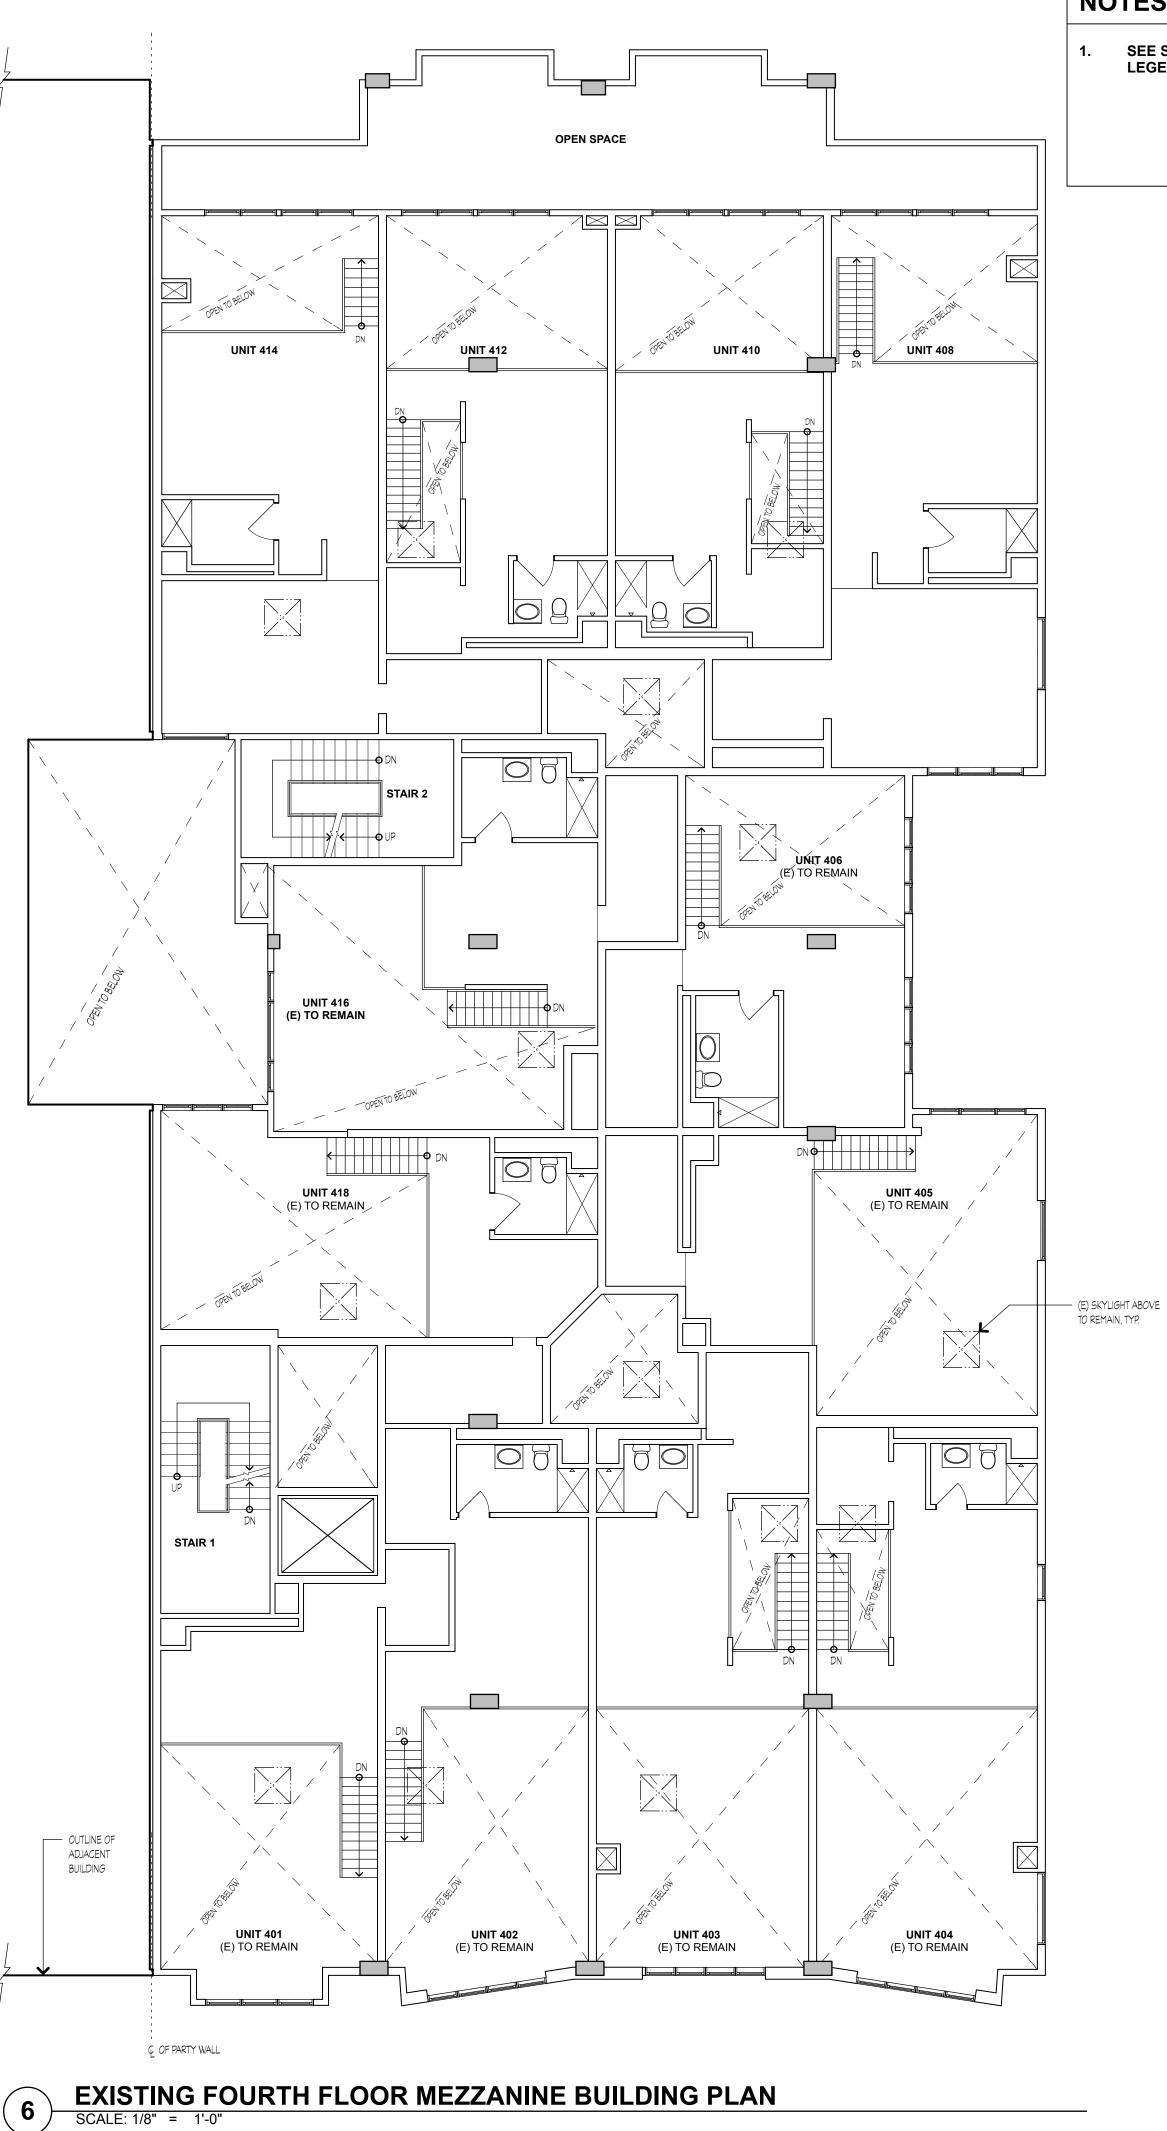

SEE SHEET A2.0 FOR BUILDING PLAN LEGEND AND NOTES NOT SHOWN.



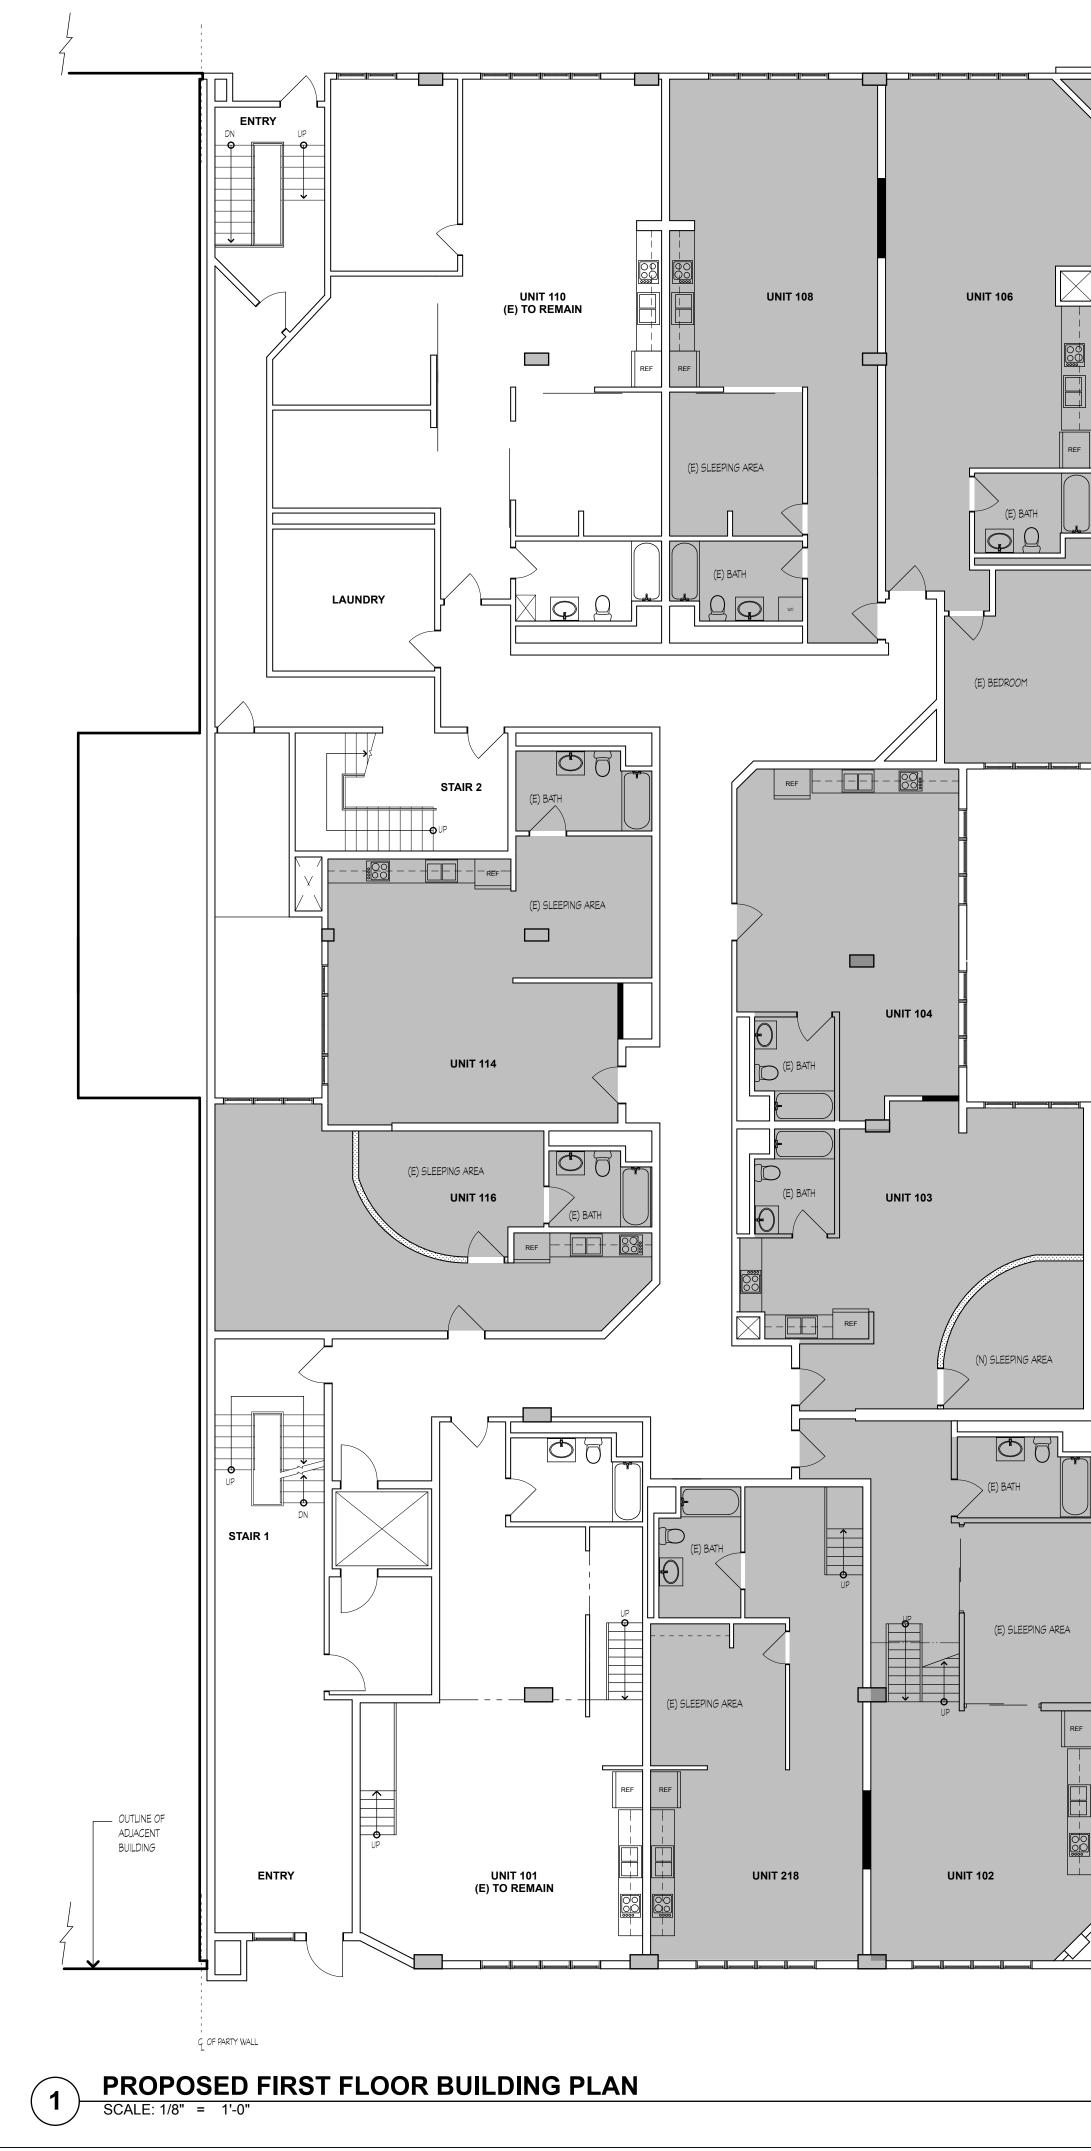

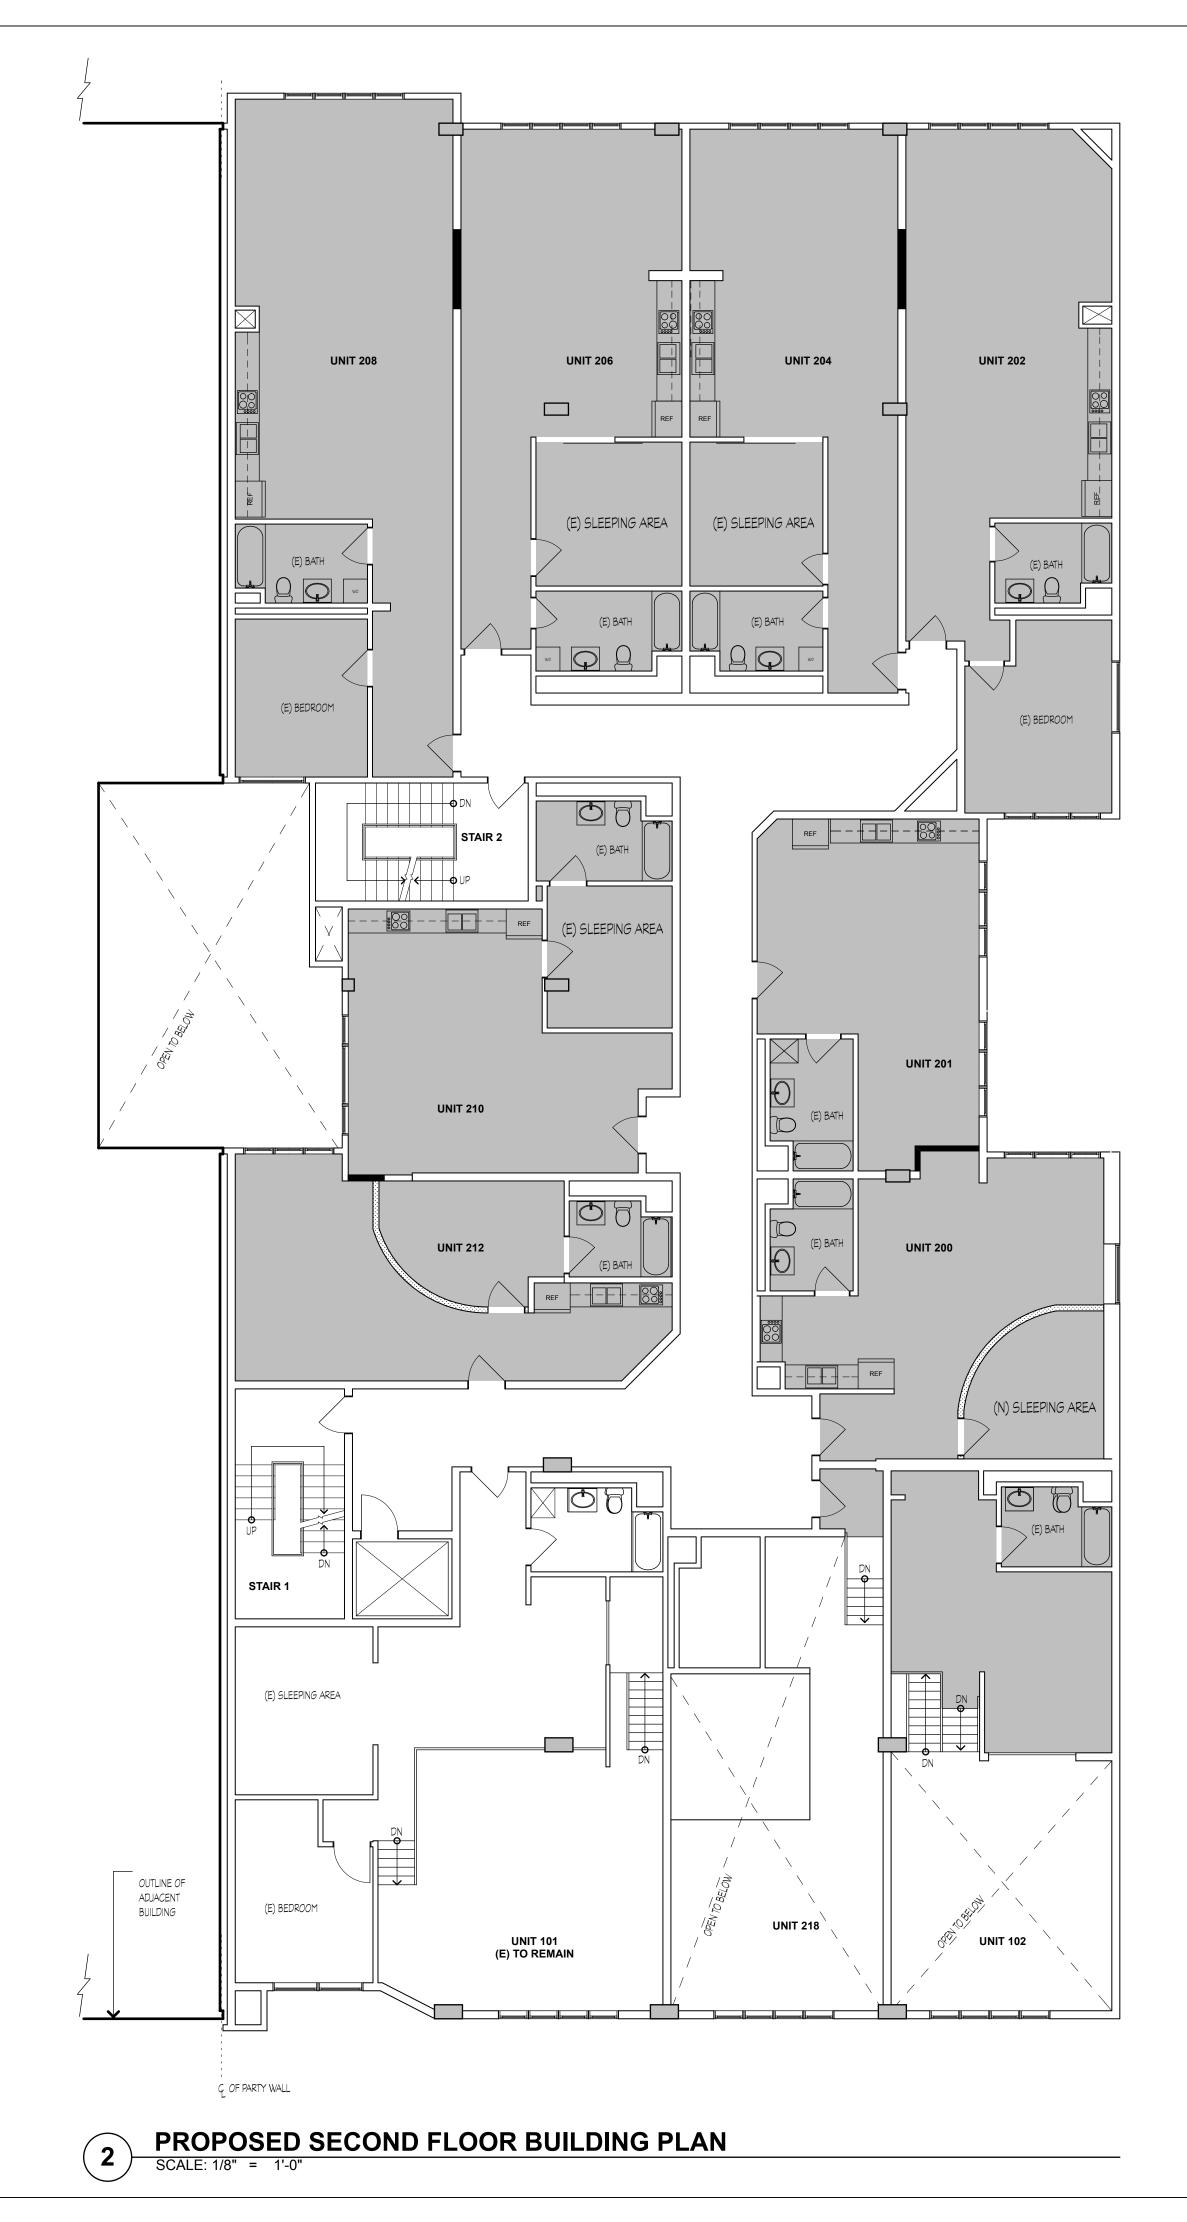

SEE SHEET A2.0 FOR BUILDING PLAN LEGEND AND NOTES NOT SHOWN.

UNIT	DATA		42 UNITS		
UNIT #	NOTES	EXISTING SQ FT	PROPOSED SQ FT	UNIT TYPE	
101	LIVE/WORK	-	-	1 BDRM	
102	DWELLING	1,200	1,200	1 BDRM	
103	DWELLING	-	650	STUDIO	
104	LIVE/WORK	1,161	511	STUDIO	
106	DWELLING	1,687	898	1 BDRM	
108	LIVE/WORK	-	789	1 BDRM	
110	LIVE/WORK	-	-	2 BDRM	
114	DWELLING	1,258	658	STUDIO	
116	LIVE/WORK	-	600	STUDIO	
200	DWELLING	-	650	1 BDRM	
201	LIVE/WORK	1,163	513	1 BDRM	
202	DWELLING	1,667	878	1 BDRM	
204	LIVE/WORK	-	789	1 BDRM	
206	DWELLING	-	815	1 BDRM	
208	LIVE/WORK	1,815	1,000	1 BDRM	
210	DWELLING	-	660	STUDIO	
212	LIVE/WORK	1,260	600	STUDIO	
218	LIVE/WORK	713	713	1 BDRM	
301	LIVE/WORK	-	-	STUDIO	
302	LIVE/WORK	-	-	1 BDRM	
303	LIVE/WORK	-	-	1 BDRM	
304	LIVE/WORK	-	-	1 BDRM	
305	LIVE/WORK	-	-	STUDIO	
306	LIVE/WORK	-	-	1 BDRM	
307	LIVE/WORK	-	-	1 BDRM	
308	LIVE/WORK	-	-	1 BDRM	
309	LIVE/WORK	-	-	1 BDRM	
310	LIVE/WORK	-	-	1 BDRM	
311	LIVE/WORK	-	-	1 BDRM	
312	LIVE/WORK	-	-	STUDIO	
401	LIVE/WORK	-	-	STUDIO	
402	LIVE/WORK	-	-	1 BDRM	
403	LIVE/WORK	-	-	1 BDRM	
404	LIVE/WORK	-	-	1 BDRM	
405	LIVE/WORK	-	-	STUDIO	
406	LIVE/WORK	-	-	1 BDRM	
408	DWELLING	2,348	1,366	2 BDRM	
410	LIVE/WORK	-	982	1 BDRM	
412	DWELLING	2,517	1,062	2 BDRM	
414	LIVE/WORK	-	1,455	1 BDRM	
416	LIVE/WORK	-	-	1 BDRM	
418	LIVE/WORK	-	-	1 BDRM	





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530 BRANNAN STREET SAN FRANCISCO, CA 94107

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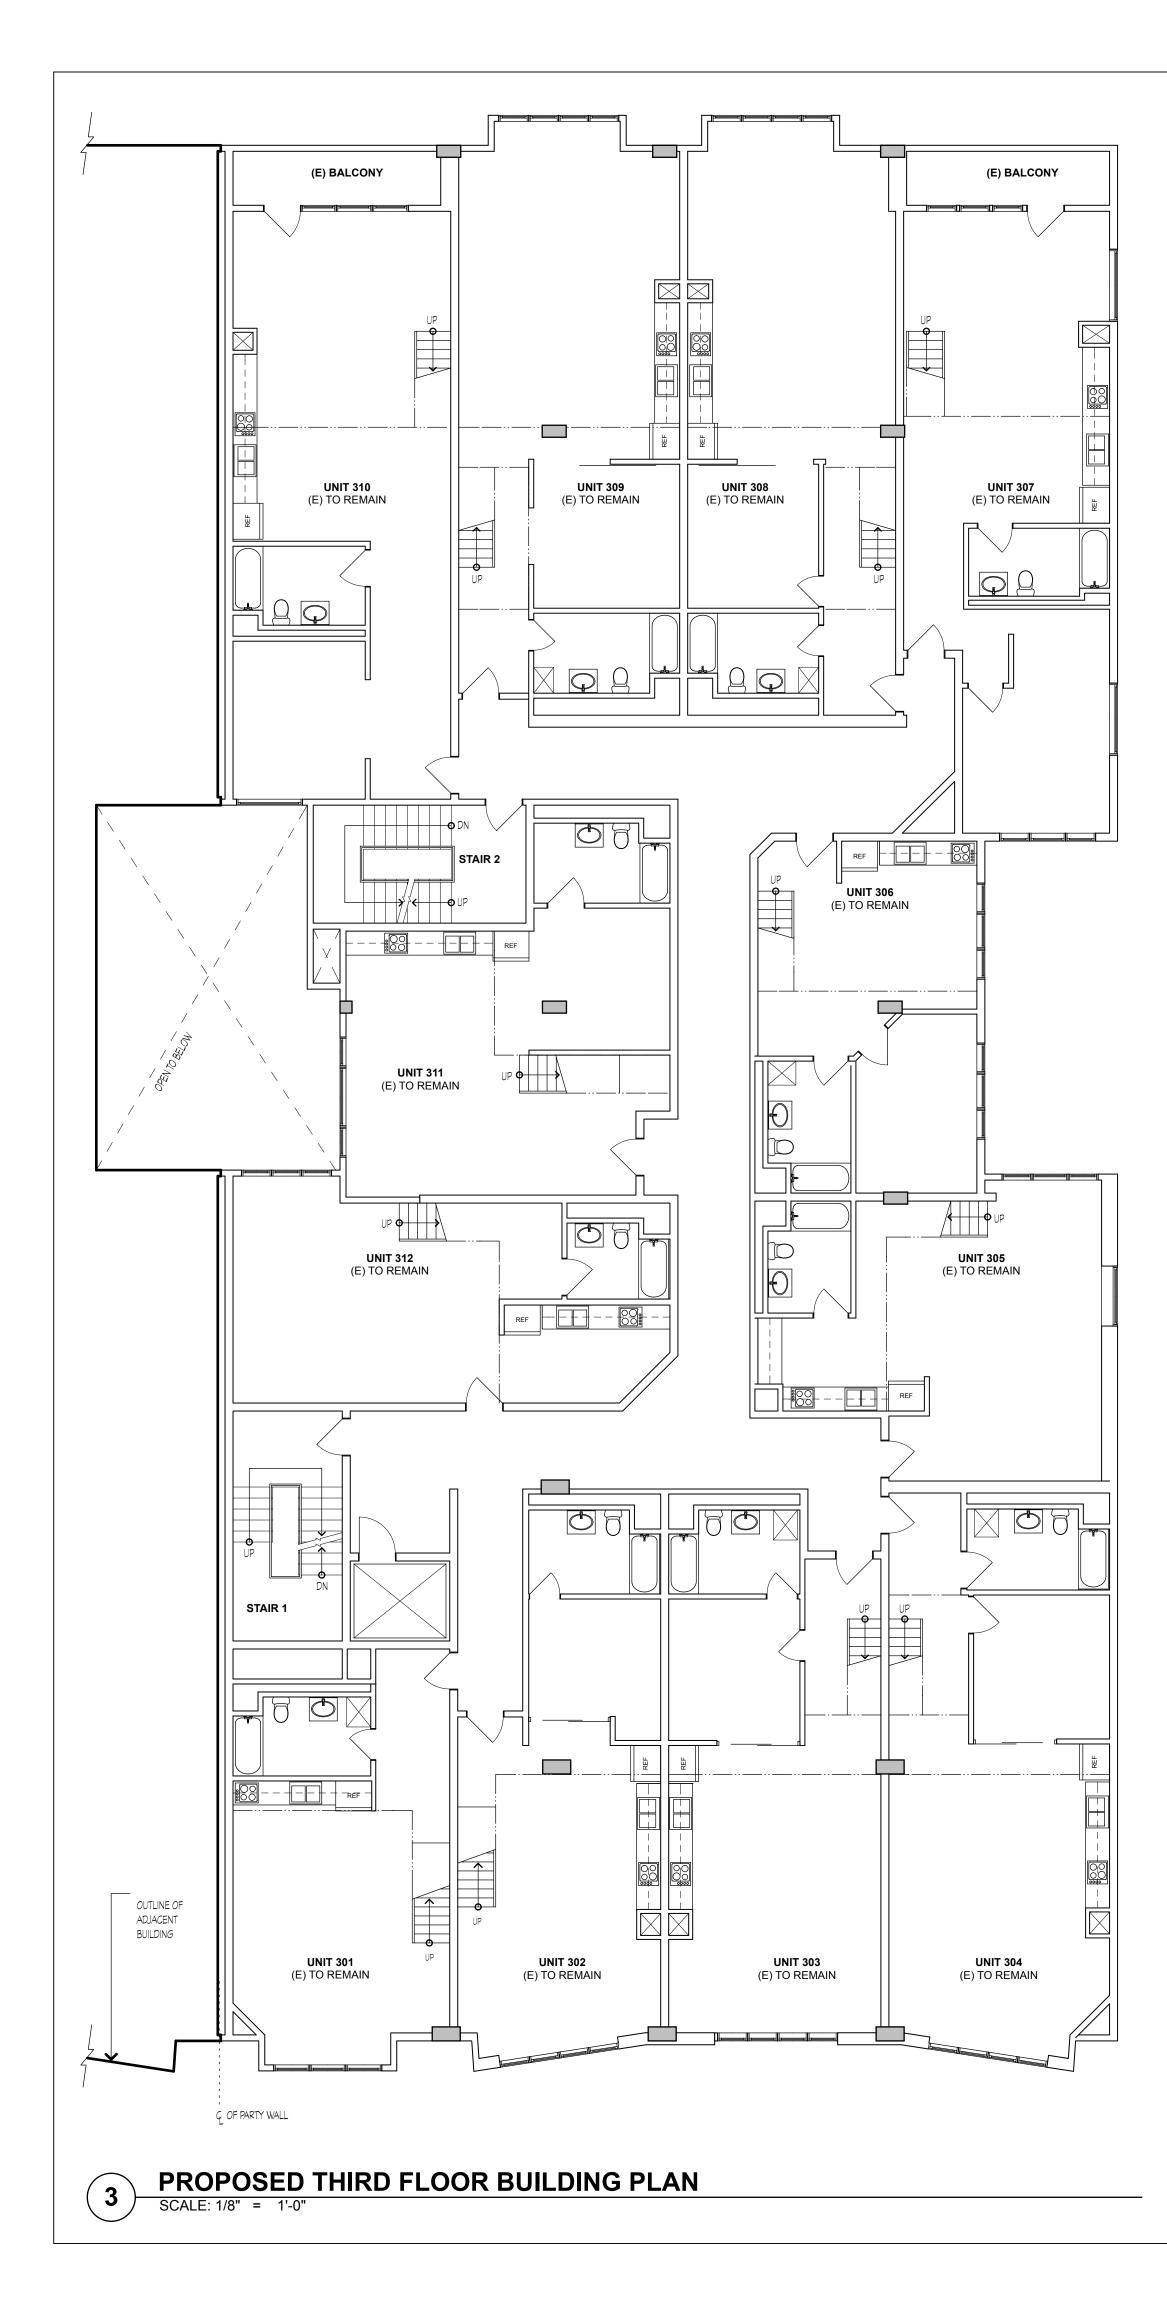
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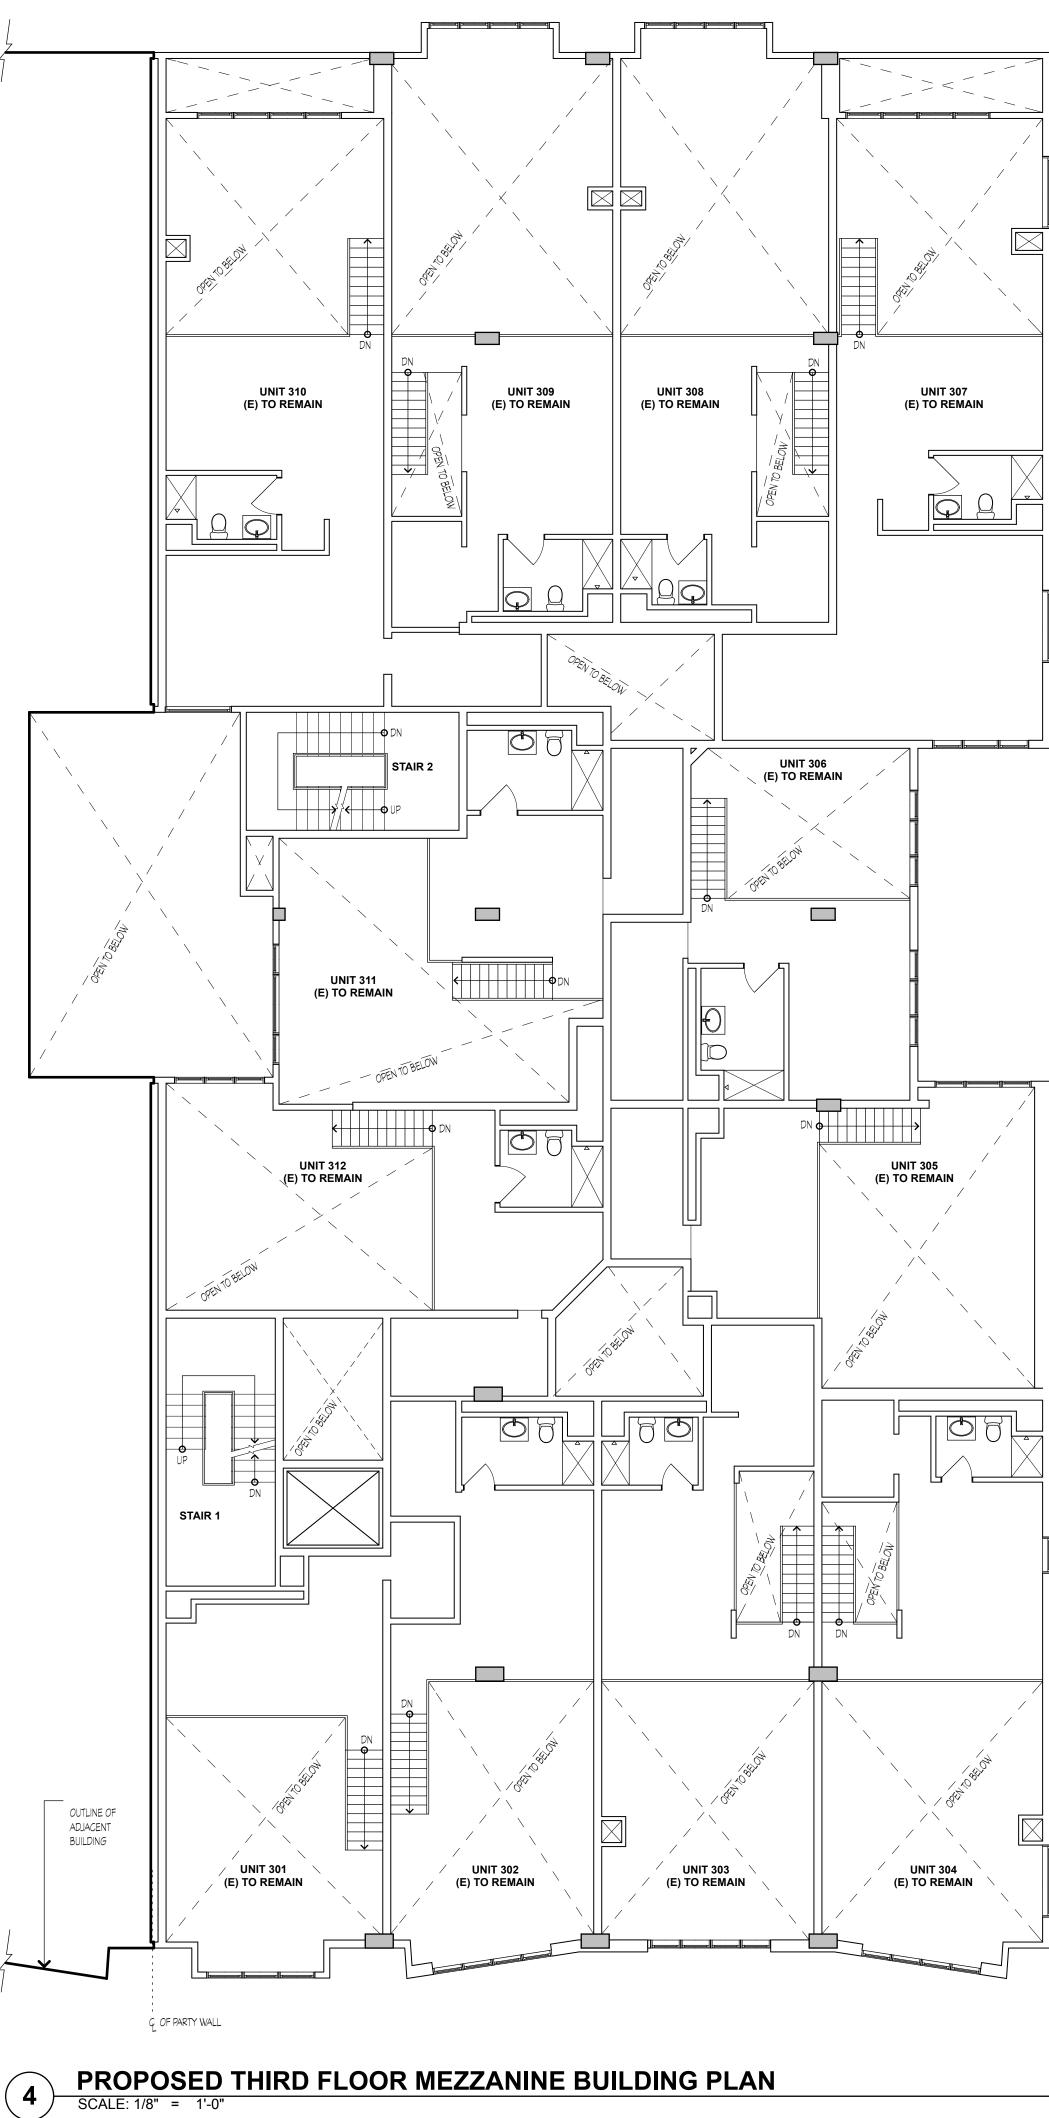
INTERIOR MODIFIC

PROPOSED BUILDING PLAN

JOB: 1303 DRAWN ΡI

SHEET NO.










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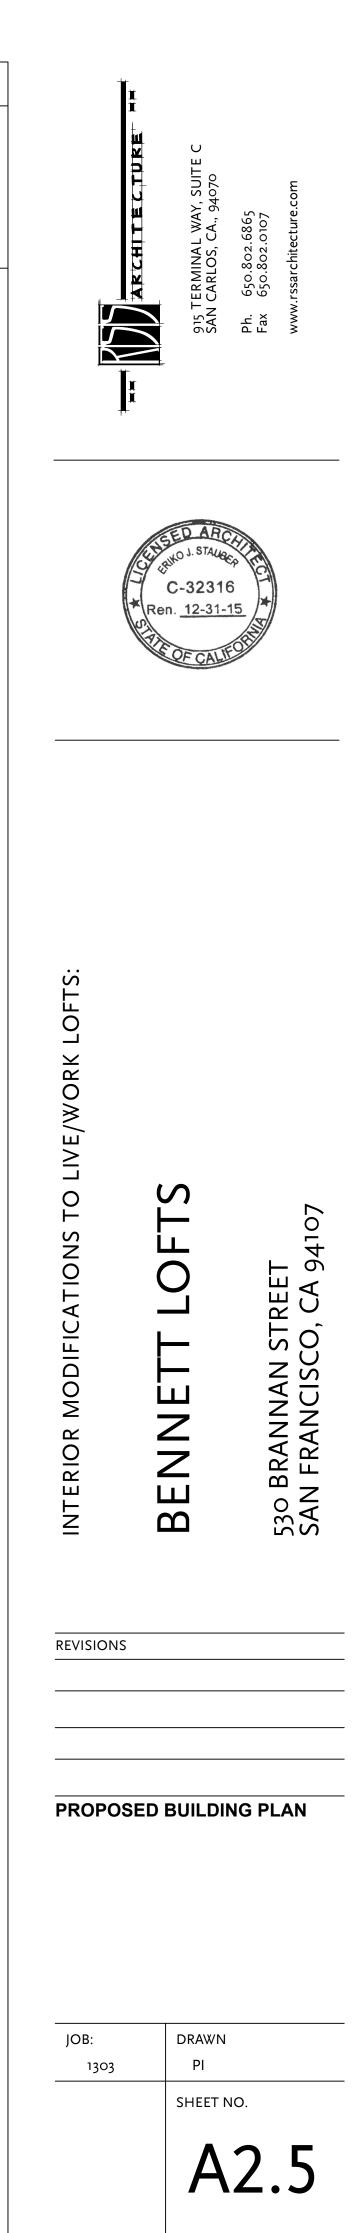
SEE SHEET A2.0 FOR BUILDING PLAN LEGEND AND NOTES NOT SHOWN.



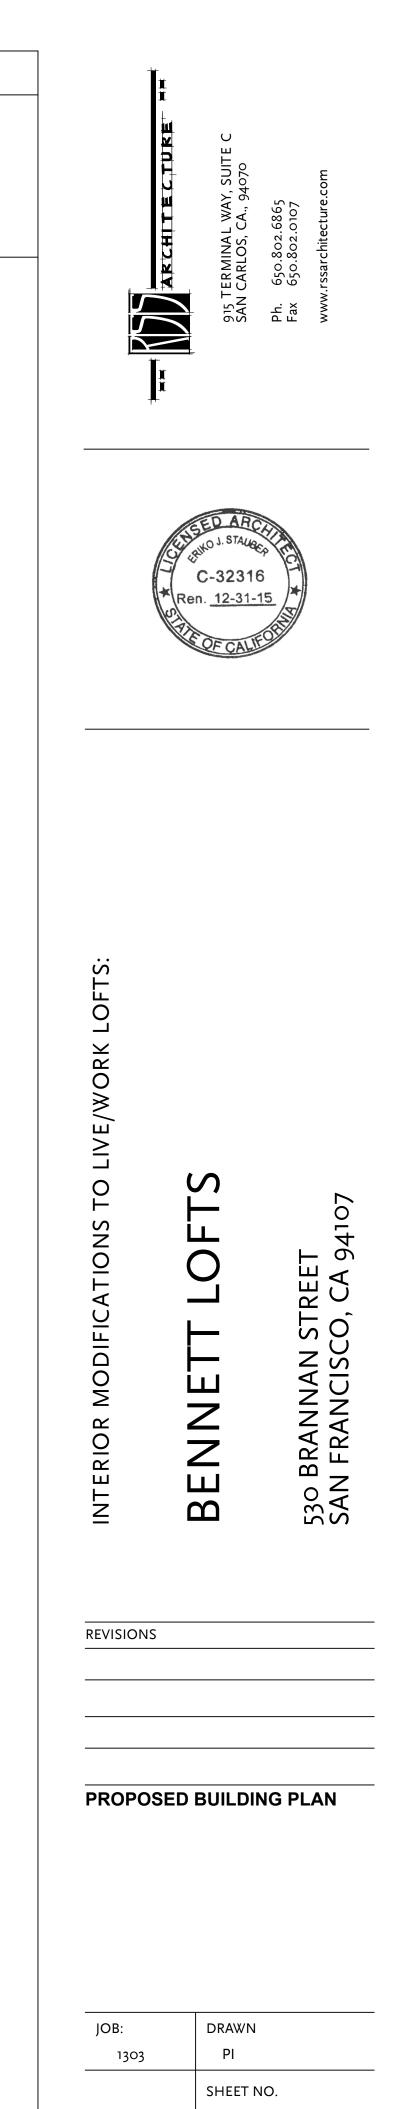

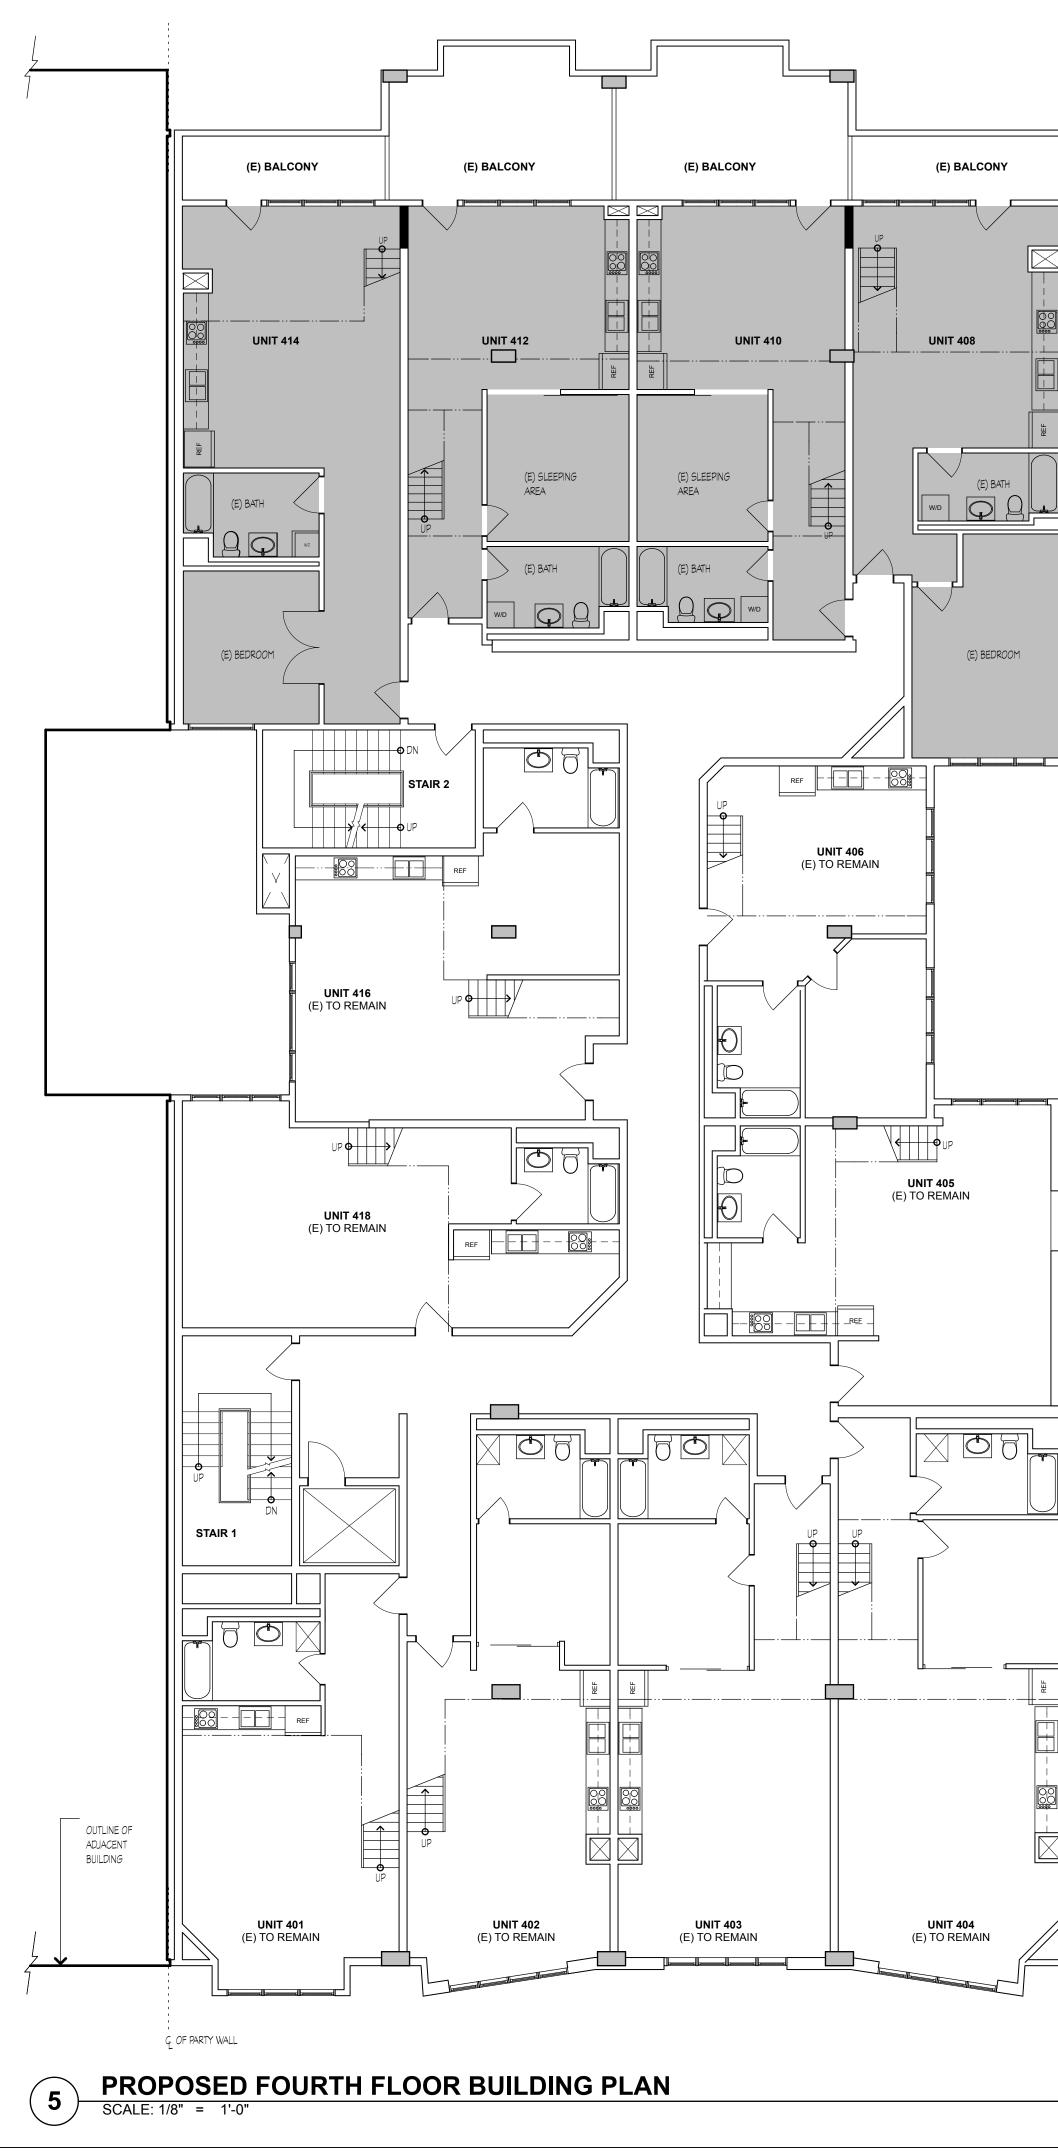


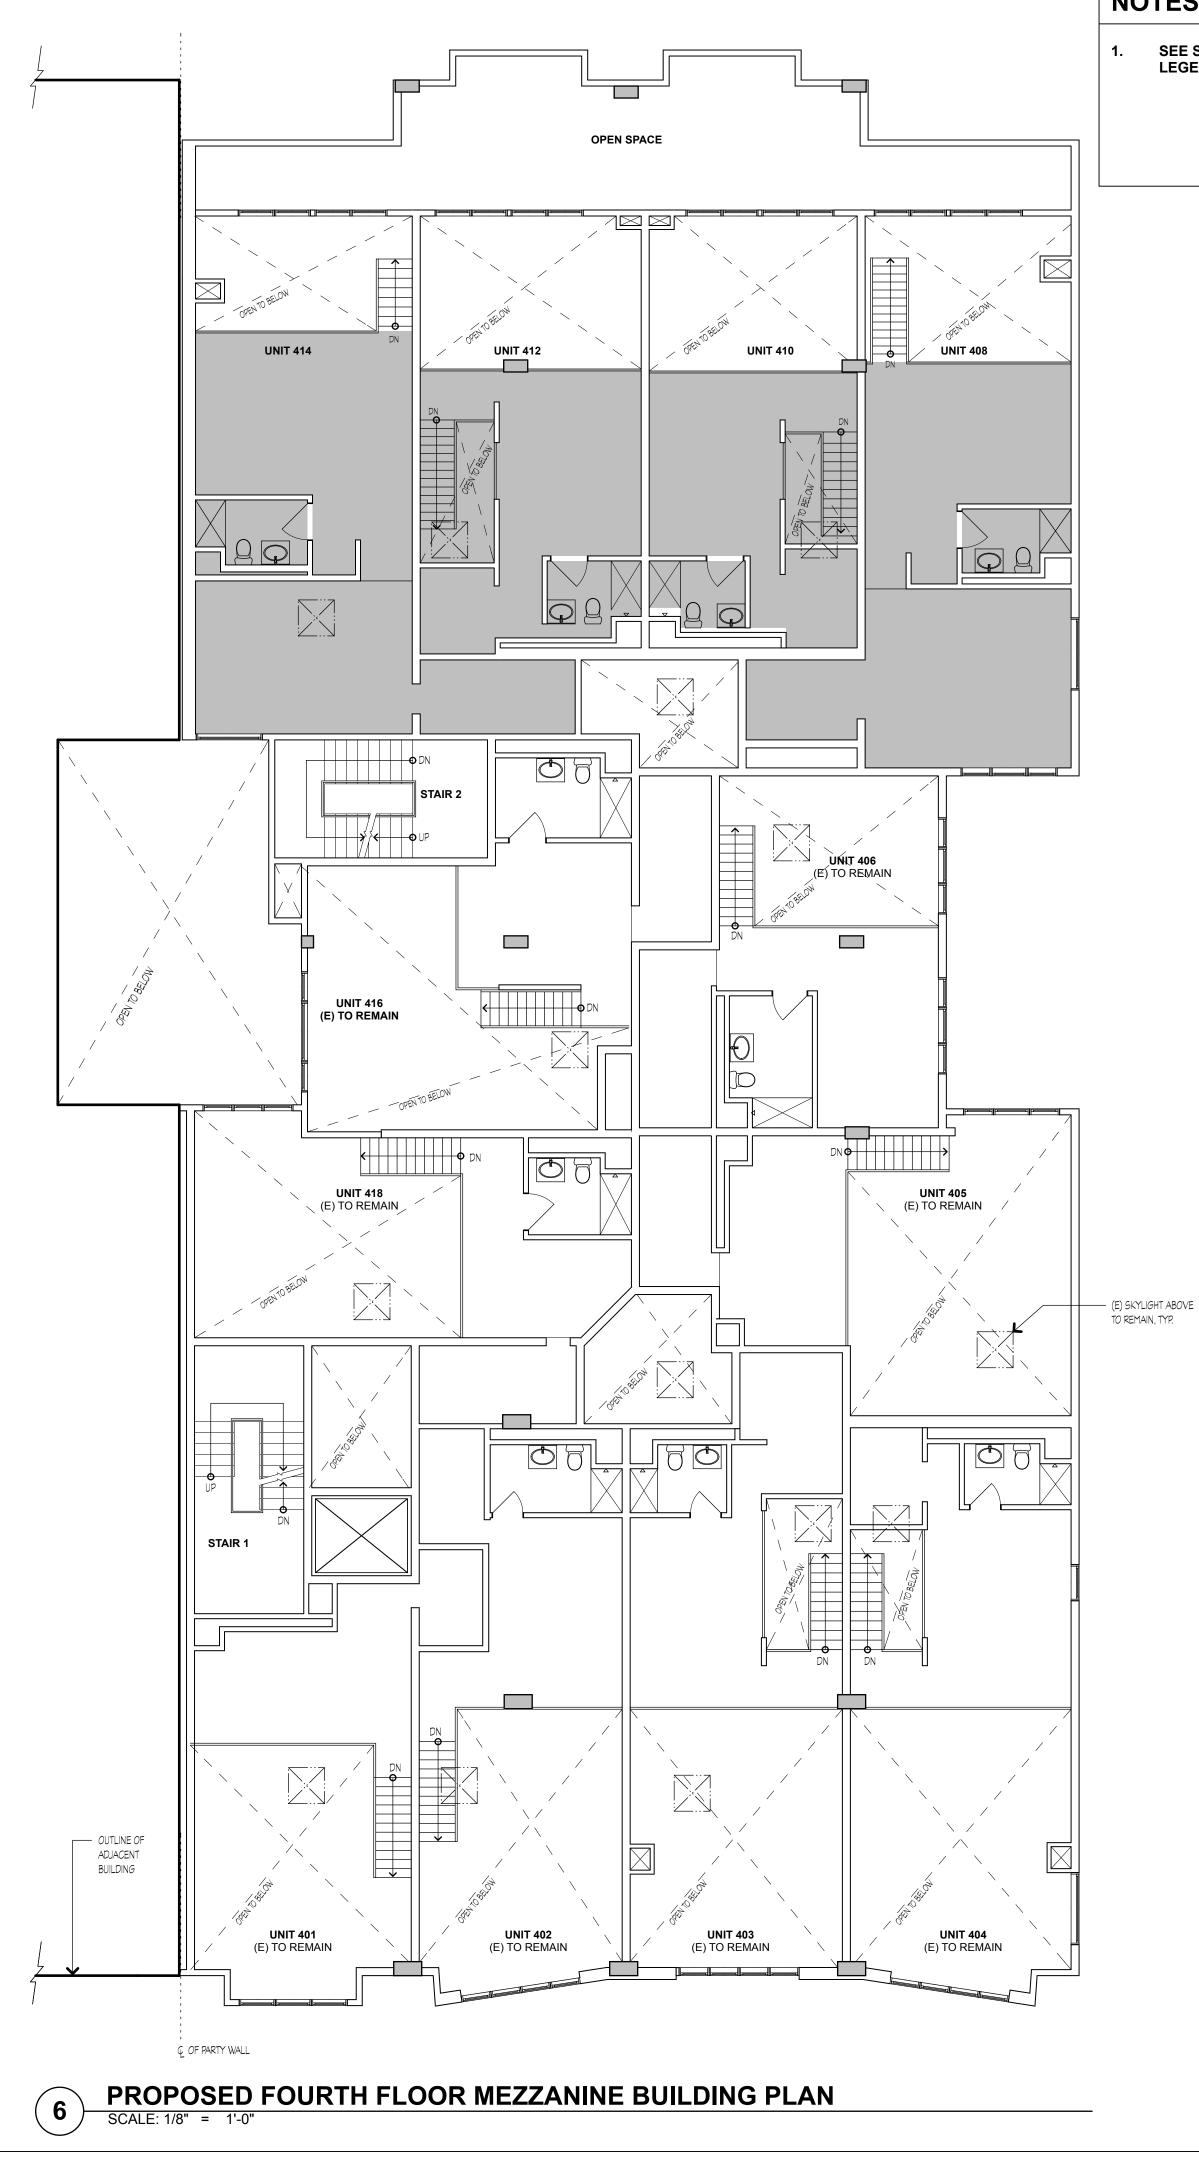SEE SHEET A2.0 FOR BUILDING PLAN LEGEND AND NOTES NOT SHOWN.





STREET VIEW OF BENNETT LOFTS

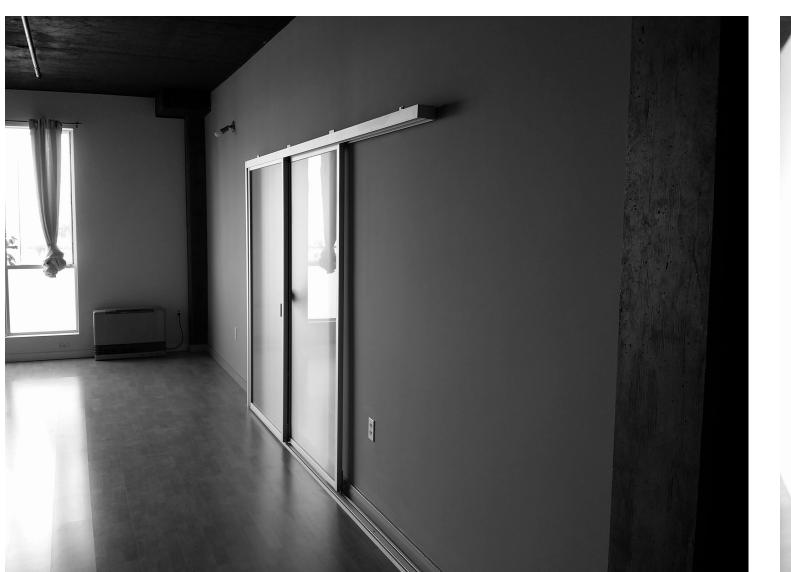



TYPICAL PARTITION WALL **BETWEEN UNITS**



STREET VIEW OF BENNETT LOFTS



<u>LIGHTWELL</u>

TYPICAL KITCHEN AREA

<u>TYPICAL UNIT ENTRY</u>



<u>TYPICAL UNIT ENTRY HALL</u>



TYPICAL SLEEPING AREA

915 TERMI SAN CARL $\left\{ \left\{ \right\} \right\}$ Рh. Fax C-32316 en. 12-31-15 LIVE/WORK LOFTS: L S INTERIOR MODIFICATIONS TO 530 BRANNAN STREET SAN FRANCISCO, CA 94107 LOF BENNETT

REVISIONS

EXISTING PHOTOS

JOB: 1303


DRAWN ΡI

SHEET NO.

A3.0

PERMIT SET 08/21/14



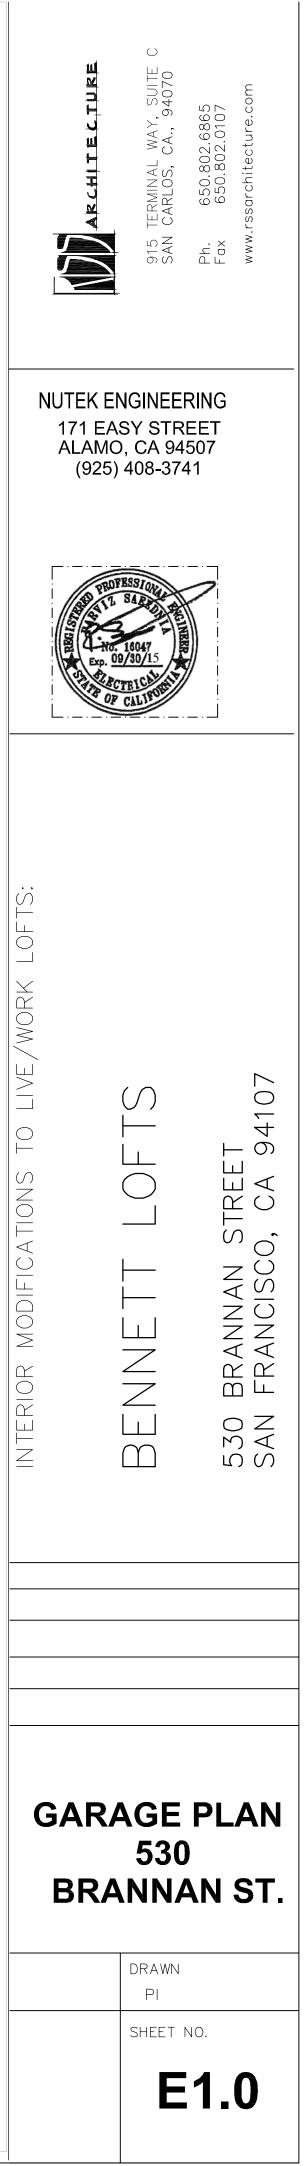

INTERIOR IMPROVEMENTS TO LIVE/WORK LOFTS: 542 BRANNAN STREET, SAN FRANCISCO, CA 94107

GENERAL SCOPE OF WORK PROPERTY MANAGEMENT: LEGALIZE OCCUPANCY CLASSIFICATION USE OF 9 EXISTING LIVE/WORK UNITS FOR RESIDENTIAL USE. ESSEX PROPERTY TRUST, INC. 925 E. MEADOW DRIVE PALO ALTO, CA 94303 CONTACT: JUSTIN CHU TEL: 650.494.3700 **ELECTRICAL ENGINEER:** NUTEK ENGINEERS 600 MAGDALENA AVE LOS ALTOS, CA 94024 CONTACT: PERRY SAEEDNIA TEL: 650.796.7553 **GENERAL NOTES** SYMBOLS CONTRACTOR SHALL NOTIFY ARCHITECT IF THERE ARE ANY DISCREPANCIES BETWEEN THE REFERENCE DRAWINGS AND ACTUAL BUILT CONDITION, PRIOR TO CONSTRUCTION TO RESOLVE. - ELEVATION NUMBER - SHEET NUMBER 2. IT IS THE INTENT OF THESE DOCUMENTS TO MAINTAIN THE EXISTING RATED WALL ASSEMBLIES. DETAIL NUMBER SHEET NUMBER LEGEND NOTES - NOTE NUMBER

BENNETT LOFTS

PROJECT IN	FO
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ARCHITECT: RSS ARCHITECTURE, INC. ANDREW RAYMUNDO, ARCHITECT

CONTACT: JIMMY CHANG 915 TERMINAL WAY, SUITE C

SAN CARLOS, CA 94070 TEL: 650.802.6865

CIVIL ENGINEER: UNDERWOOD & ROSENBLUM, INC. 1630 OAKLAND ROAD, SUITE A114 SAN JOSE, CA 95131


CONTACT: DAVE VOORHIES, P.E.

TEL: 408.453.1222

PROJECT DATA SUMMARY

OCCUPANCY: TYPE OF CONSTRUCTION: APN: ZONING: SPRINKLERS: STORIES: EXISTING LOT AREA: EXISTING BLDG : TOTAL NO. OF EXISTING UNITS NO. OF NEW UNITS TOTAL NO. OF NEW UNITS TOTAL NO. OF PARKING STALLS



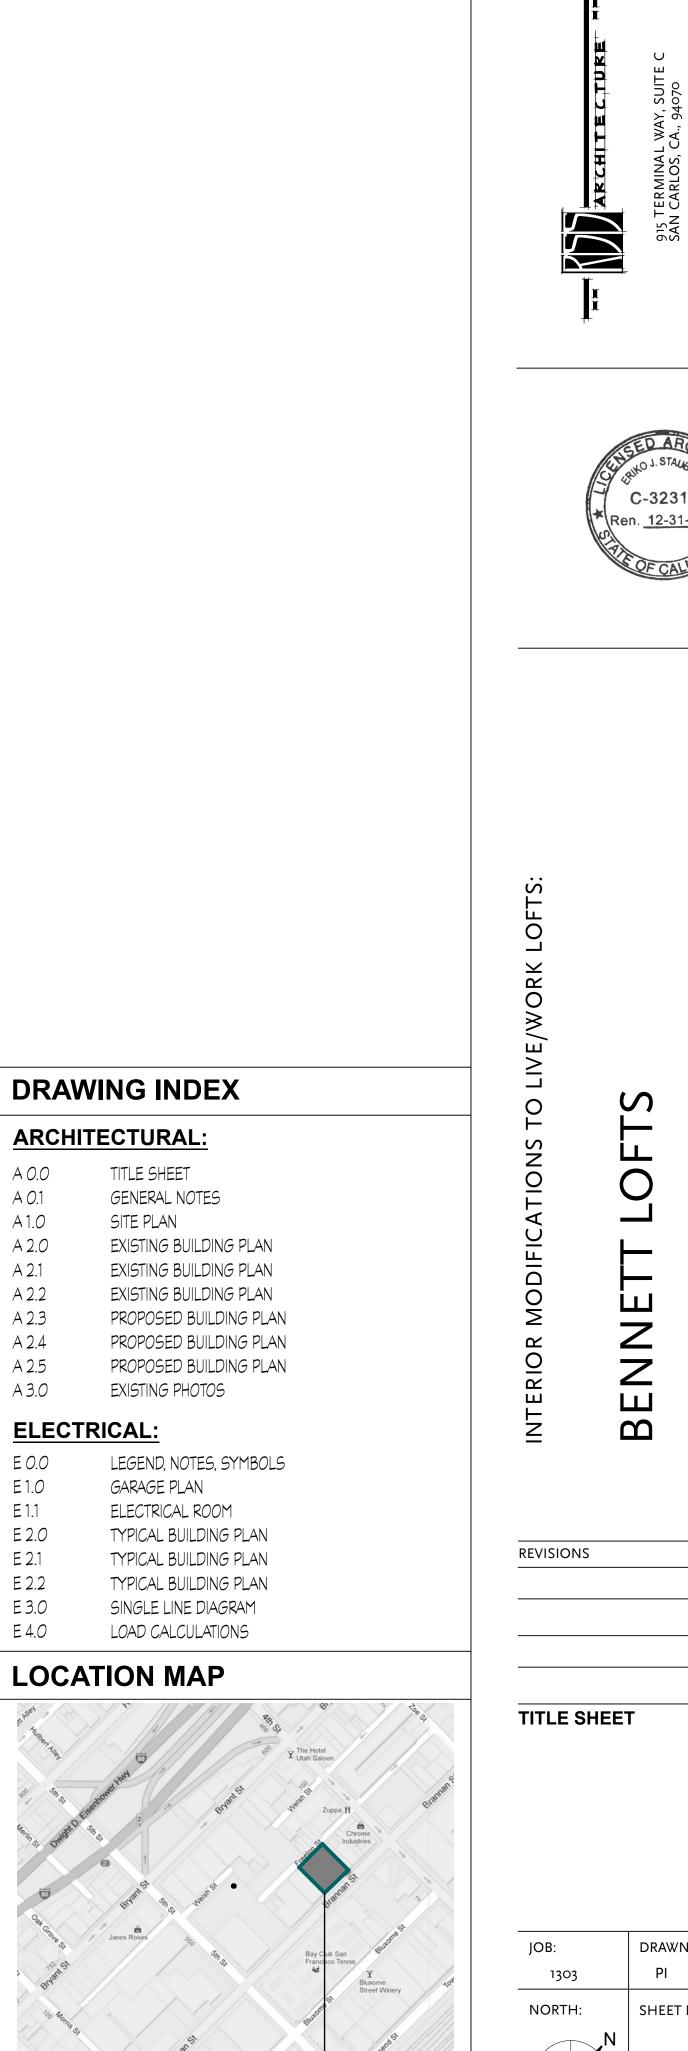

R1-B

||-A

SLI

YES

FOUR

36

45

3777-139-174

12,000 SQ.FT.

11,110 SQ.FT.

33 (UNCHANGED)

A 0.0

A 0.1

A 1.0

A 2.0

A 2.1

A 2.2

A 2.3

A 2.4

A 2.5

A 3.0

E *0.0*

E 1.0

E 1.1

E 2.0

E 2.1

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PERMIT SET 06/18/14

PROJECT SITE —

542 BRANNAN STREET SAN FRANCISCO, CA 94107

'ERMINAL W CARLOS. CA

DRAWN ΡI SHEET NO. AU.U

GENERAL

NO GUARANTEE FOR QUALITY OF CONSTRUCTION IS IMPLIED OR INTENDED BY THESE ARCHITECTURAL DOCUMENTS. THE GENERAL CONTRACTOR SHALL ASSUME FULL RESPONSIBILITY FOR ANY AND ALL CONSTRUCTION DEFICIENCIES.

CONSTRUCTION IS ALWAYS LESS THAN PERFECT SINCE BUILDINGS REQUIRE THE COORDINATION AND INSTALLATION OF MANY INDIVIDUAL PARTS BY THE VARIOUS CONSTRUCTION INDUSTRY TRADES. THESE DOCUMENTS CANNOT PORTRAY ALL COMPONENTS OR ASSEMBLIES EXACTLY. IT IS THE INTENT OF THESE ARCHITECTURAL DOCUMENTS THAT THEY REPRESENT A REASONABLE STANDARD OF CARE IN THEIR CONTENT. IT SHALL BE THE CONTRACTOR'S RESPONSIBILITY TO FULLY RECOGNIZE AND PROVIDE THAT STANDARD OF CARE.

THE CONSTRUCTION ASSEMBLIES DEPICTED IN THESE DOCUMENTS MAY PROVIDE FOR THE CONTACT OF DISSIMILAR MATERIALS WHICH, WHEN FINISH COATED OR SUBJECTED TO MOIST WEATHER CONDITIONS, MAY RESULT IN DISCOLORATION OF SOME OF THE MATERIAL SURFACES. THESE CONDITIONS MAY REQUIRE PERIODIC INSPECTION, MAINTENANCE AND/OR RE-COATING AT CLOSER INTERVALS THAN OTHER NON-AFFECTED SURFACES.

THESE ARCHITECTURAL CONSTRUCTION DRAWINGS DESCRIBE THE REQUIREMENTS OF THE PROJECT FOR A BUILDING PERMIT AND TO PREPARE ESTIMATES OF QUANTITY AND COSTS OF MATERIALS REQUIRED TO CONSTRUCT THE PROJECT. THESE DRAWINGS PROVIDE FOR ONLY SCHEMATIC PLUMBING/MECHANICAL EQUIPMENT LAYOUT AND SCHEMATIC ELECTRICAL POWER AND LIGHTING LAYOUT AS PREPARED BY THE ARCHITECT WITHOUT ENGINEERING DESIGNS, DETAILS, CALCULATIONS OR SPECIFICATIONS.

BY USE OF THESE DOCUMENTS, THE CONTRACTOR ACKNOWLEDGES THAT RSS ARCHITECTURE, AS THE ARCHITECT, IS THE AUTHOR OF, AND THEREFORE RESPONSIBLE FOR THE INTERPRETATION OF THESE DESIGN DOCUMENTS AND THAT THE CONTENT, CONCEPTS OR BASIC DESIGN DEMONSTRATED BY THE DOCUMENTS SHALL NOT BE FURTHER DEVELOPED, INTERPRETED, CLARIFIED OR TRANSFERRED WITHOUT WRITTEN CONSENT FROM THE ARCHITECT.

CHANGES TO THE PLANS AND SPECIFICATIONS BY MEANS OF SHOP DRAWINGS BECOME THE RESPONSIBILITY OF THE PERSON INITIATING SUCH CHANGES.

ALL GENERAL NOTES, SHEET NOTES AND LEGEND NOTES FOUND IN THESE DOCUMENTS SHALL APPLY, TYPICALLY, THROUGHOUT. IF INCONSISTENCIES ARE FOUND IN THE VARIOUS NOTATIONS, NOTIFY THE ARCHITECT IMMEDIATELY IN WRITING REQUESTING CLARIFICATION. IT IS THE EXPRESS INTENT OF THE PARTIES HERETO THAT THE ARCHITECT IS EXCULPATED FROM ANY LIABILITY WHATSOEVER, OCCASIONED BY THE CONTRACTOR'S FAILURE TO CARRY OUT THE WORK IN ACCORDANCE WITH THE CONTRACT DOCUMENTS.

INSOFAR AS THERE ARE MANY VARIABLES INVOLVED IN THE EXECUTION OF THE WORK DESCRIBED IN THESE DOCUMENTS, THE ARCHITECT DOES NOT CARRY ANY WARRANTY EXPRESSED OR IMPLIED FOR THE WORK OF THE TRADES.

THESE DOCUMENTS ARE COMPLETE AS PREPARED BY THE ARCHITECT. ADDITIONAL DOCUMENTS, INCLUDING WRITTEN SPECIFICATIONS, MAY BE PREPARED BY OTHERS AND USED TO SUPPLEMENT THE WORK OF THE CONTRACTOR. THE CONTRACTOR SHALL BE RESPONSIBLE FOR COORDINATING ALL SUPPLEMENTAL WORK IN CONFORMANCE WITH THESE DOCUMENTS.

THE CONTRACTOR SHALL, BY THE USE OF THESE DOCUMENTS, BE REQUIRED TO PROVIDE UNDERSTANDABLE AND THOROUGH INSTRUCTIONS TO THE OWNER ABOUT HIS/HER RESPONSIBILITIES FOR ON-GOING MAINTENANCE. THESE INSTRUCTIONS SHALL DESCRIBE PERIODIC INSPECTIONS AND PROCEDURES FOR MAINTENANCE OF BUILDING SYSTEMS AND MATERIALS, INCLUDING BUT NOT LIMITED TO: DRAINAGE, EROSION CONTROL, PLUMBING, MECHANICAL, PAVING, WATERPROOFING, DECKING, ROOFING, GLAZING, PAINTING, SEALANTS, ETC. THE CONTRACTOR SHALL OBTAIN INFORMATION AND INSTRUCTIONS FROM THE VARIOUS SUBCONTRACTORS, INSTALLERS AND MANUFACTURERS REGARDING MAINTENANCE OF THEIR SPECIFIC PORTIONS OF WORK AND MATERIALS. ALL WARRANTIES AND/OR GUARANTEES SHALL BE IDENTIFIED. THESE INSTRUCTIONS SHALL BE WRITTEN SO AS TO HAVE THE HOMEOWNER PROMPTLY ALERT THE CONTRACTOR AS TO ANY UNUSUAL WEARING OF MATERIALS OR MALFUNCTION OF COMPONENTS AND/OR ASSEMBLIES OF THE CONSTRUCTION. THE INSTRUCTIONS SHALL IDENTIFY THE EXPECTED USUAL WEARING. MOVEMENTS OR DEFORMATION OF MATERIALS AND THEIR PROJECTED LIFE.

ALL WORK SHALL COMPLY WITH APPLICABLE CODES AND TRADE STANDARDS WHICH GOVERN EACH PHASE OF THE WORK; INCLUDING, BUT NOT LIMITED TO: 2013 CALIFORNIA BUILDING CODE (CBC); CALIFORNIA MECHANICAL CODE (CMC); CALIFORNIA ELECTRICAL CODE (CEC); UNIFORM FIRE CODE (UFC); AMERICAN CONCRETE INSTITUTE (ACI); CALIFORNIA PLUMBING CODE (CPC), AND ALL APPLICABLE STATE AND/OR LOCAL CODES AND/OR LEGISLATION.

SITE EXAMINATION

THE CONTRACTOR AND ALL SUBCONTRACTORS SHALL THOROUGHLY EXAMINE THE SITE AND FAMILIARIZE THEMSELVES WITH THE CONDITIONS UNDER WHICH THE WORK IS TO BE PERFORMED. THE CONTRACTOR SHALL VERIFY, AT THE SITE, ALL MEASUREMENTS AFFECTING HIS WORK AND SHALL BE RESPONSIBLE FOR THE CORRECTIONS OF SAME. NO EXTRA COMPENSATION WILL BE ALLOWED TO THE CONTRACTOR FOR EXPENSES DUE TO HIS NEGLECT TO EXAMINE OR FAILURE TO DISCOVER CONDITIONS WHICH AFFECT HIS WORK.

DIMENSION CONTROL

IT IS THE RESPONSIBILITY OF THE CONTRACTOR AND ALL SUBCONTRACTORS TO CHECK AND VERIFY ALL CONDITIONS, DIMENSIONS, LINES AND LEVELS INDICATED. PROPER FIT AND ATTACHMENT OF ALL PARTS IS REQUIRED. SHOULD THERE BE ANY DISCREPANCIES, THE CONTRACTOR AND ALL SUBCONTRACTORS SHALL IMMEDIATELY NOTIFY THE ARCHITECT FOR CORRECTION OR ADJUSTMENT. IN THE EVENT OF FAILURE TO DO SO, THE CONTRACTOR SHALL BE RESPONSIBLE FOR CORRECTION OF ANY ERROR.

ALL DIMENSIONS AND CONDITIONS SHALL BE CHECKED AND VERIFIED ON THE JOB BY EACH SUBCONTRACTOR BEFORE HE BEGINS HIS WORK. ANY ERRORS, OMISSIONS OR DISCREPANCIES SHALL BE BROUGHT TO THE ATTENTION OF THE OWNER OR CONTRACTOR BEFORE CONSTRUCTION BEGINS. COMMENCEMENT OF WORK BY THE CONTRACTOR AND/OR ANY SUBCONTRACTOR SHALL INDICATE A KNOWLEDGE AND ACCEPTANCE OF ALL CONDITIONS DESCRIBED IN THESE CONSTRUCTION DOCUMENTS, OR EXISTING ON SITE, WHICH COULD AFFECT THEIR WORK.

DIMENSION CONTROL HAS BEEN TAKEN FROM READILY OBSERVABLE EXISTING CONDITIONS AND FIELD MEASUREMENTS. ADJUSTMENTS MAY HAVE TO BE EMPLOYED SHOULD AS-BUILT CONDITIONS VARY FROM ORIGINAL DOCUMENTS.

CONTROL OF APPROVAL

CONTRACTOR SHALL INCLUDE AND IMPLEMENT IN THE WORK ALL PERTINENT REQUIREMENTS FOR THIS PROJECT AS SET FORTH IN THE CONDITIONS OF APPROVAL BY THE CITY AGENCIES. A COPY OF THESE CONDITIONS IS AVAILABLE FROM THE OWNER AND ARCHITECT.

CONTINUING OPERATIONS

WHEN IT IS NECESSARY THAT THE OWNER CONTINUE PRESENT OCCUPANCY DURING THE RENOVATION WORK, THE CONTRACTOR SHALL, AFTER CONSULTING WITH THE OWNER, SCHEDULE THE WORK SO AS NOT TO INTERFERE WITH NORMAL HOUSEHOLD OPERATIONS.

WORK SEQUENCE

IN THE EVENT THAT SPECIAL SEQUENCING OF THE WORK IS REQUIRED BY THE OWNER, THE CONTRACTOR SHALL ARRANGE A CONFERENCE BEFORE ANY SUCH WORK IS BEGUN

MOISTURE PROTECTION

IT IS THE INTENT OF THESE DOCUMENTS TO PROVIDE DETAILS FOR CONSTRUCTION WHICH WILL TO THE BEST OF THE ARCHITECT'S KNOWLEDGE, THE CONSTRUCTION ASSEMBLIES RESULT IN A MOISTURE RESISTANT BUILDING ENVELOPE. IT IS THE RESPONSIBILITY OF THE REPRESENTED AND DETAILED IN THESE DOCUMENTS CONFORM TO THE STATE OF CALIFORNIA CONTRACTOR TO NOTIFY THE ARCHITECT OF ANY EXCEPTION HE MAY TAKE TO ANY OF THE ENERGY CONSERVATION REGULATIONS AS MANDATED IN THE TITLE 24 ENERGY COMPLIANCE DETAILS OR METHODS DESCRIBED HEREIN. IF THE CONTRACTOR IS AWARE OF ALTERNATE STANDARDS. WHILE THESE REGULATIONS RESULT IN A VERY TIGHT AIR AND MOISTURE MATERIALS OR METHODS THAT WILL BETTER SATISFY THIS INTENT, HE SHALL SO NOTIFY THE EXTERIOR ENVELOPE, THE SELECTION OF SPECIFIC VAPOUR RETARDERS AND AIR BARRIERS, ARCHITECT, IN WRITING, ALLOWING THE ARCHITECT TO MODIFY HIS DOCUMENTS ACCORDINGLY. AND PREVAILING CLIMATIC CONDITIONS MAY AFFECT OR IMPACT OTHER MEMBERS WITHIN THE FLOOR, WALL, CEILING AND ROOF ASSEMBLIES. THE CONTRACTOR, SUBCONTRACTOR AND SHOULD ANY SPECIAL SITUATION OCCUR DURING CONSTRUCTION, INCLUDING VARIOUS MATERIAL SUPPLIERS SHALL HAVE FULL RESPONSIBILITY IN SELECTION OF THESE MATERIALS CLIMATIC CONDITIONS, WHICH NECESSITATE APPLICATIONS OR METHODS TO INSURE THE AND SHALL EACH MAKE KNOWN TO ALL OTHERS ANY AND ALL EFFECTS OR IMPACTS THAT PROTECTION OF MATERIALS AND ASSEMBLIES, THE CONTRACTOR OR SUBCONTRACTOR (S) MAY OCCUR AND AFFECT THE SELECTION OF OTHER ASSEMBLY MATERIALS OR PROCEDURES SHALL SO NOTICE AND IMPLEMENT ANY OR ALL PROTECTIVE MEASURES. NECESSARY FOR PROPER CONSTRUCTION. THE CONTRACTOR SHALL FURTHER BE RESPONSIBLE FOR TESTING OF THESE ASSEMBLIES SHOULD IT BE REQUIRED OR DETERMINED ALL DOWNSPOUTS, SCUPPERS AND LEADERHEADS SHALL BE SIZED TO ACCOMMODATE TO STUDY THE PERFORMANCE OF THESE ASSEMBLIES AGAINST MOISTURE INFILTRATION, TRIBUTARY ROOF AREAS SERVED. IT SHALL BE THE RESPONSIBILITY OF THE INSTALLER TO MOISTURE ENTRAPMENT AND/OR ADVERSE AFFECTS ON THE DURABILITY, AESTHETICS, PROVIDE ANY AND ALL DESIGN, CALCULATIONS AND DATA THAT MAY BE REQUIRED IN ENERGY USE EFFICIENCY AND REASONABLE COMFORT WITHIN THE BUILDING(S) AS MAY BE

SUPPORT OF THIS SYSTEM. ALL RESPONSIBILITY FOR THE SYSTEM AND ITS FUNCTION SHALL CAUSED BY MOISTURE INFILTRATION AND ENTRAPMENT. BE BORNE BY THE SYSTEM DESIGNER AND/OR INSTALLER.

DEMOLITION NOTES

THESE ARCHITECTURAL DRAWINGS SHALL BE USED TO DETERMINE THE LIMITS OF NEW CONSTRUCTION AND EXISTING CONSTRUCTION TO REMAIN. THESE DRAWINGS ARE NOT INTENDED TO SHOW ALL EXISTING CONSTRUCTION. THE GENERAL CONTRACTOR SHALL BE RESPONSIBLE FOR DETERMINING THE EXTENT AND SCOPE OF EXISTING CONSTRUCTION TO BE REMOVED.

THE GENERAL CONTRACTOR SHALL PERFORM WORK IN OR ON THE EXISTING BUILDING. THIS CONSISTS PRINCIPALLY OF, BUT NOT NECESSARILY LIMITED TO, THE CUTTING AND REPAIR OR REPLACEMENT OF PORTIONS OF THE EXISTING BUILDING AS SHOWN, OR AS NECESSARY FOR INSTALLATION OR ERECTION OF NEW WORK, OR REMODELLING CALLED FOR ON DRAWINGS OR IN SPECIFICATIONS.

THE GENERAL CONTRACTOR SHALL MAKE ALL NECESSARY ARRANGEMENTS WITH OWNER FOR ENTRY AND EXECUTION OF WORK IN OR ON THE EXISTING BUILDING.

THE GENERAL CONTRACTOR SHALL ACCEPT THE SITE AS THEY FIND IT AND BE FAMILIAR WITH ITS CHARACTER AND THE TYPE OF WORK TO BE REMOVED. HE SHALL ENTIRELY DEMOLISH ON THE SITE ANY STRUCTURE OR PORTION THEREOF INDICATED TO BE REMOVED, AND SHALL NOT REMOVE ANY STRUCTURE FROM THE SITE, EITHER AS A WHOLE OR SUBSTANTIALLY AS A WHOLE WHERE NOT INDICATED. THE OWNER ASSUMES NO RESPONSIBILITY FOR THE CONDITION OF THE PORTIONS OF BUILDING TO BE REMOVED AND/OR DEMOLISHED.

THE GENERAL CONTRACTOR SHALL SEE THAT ALL SERVICES, TO THE AREAS TO BE DEMOLISHED, SUCH AS WATER, GAS, STEAM, ELECTRICITY AND TELEPHONE LINES, ARE DISCONNECTED AT THE ENTRIES AS APPLICABLE, ALL IN ACCORDANCE WITH THE RESTRICTIVE RULES AND REGULATIONS GOVERNING THE UTILITIES INVOLVED.

THE CONTRACTOR SHALL BE RESPONSIBLE FOR THE LOCATION OF ALL EXISTING UTILITIES AND COORDINATE THEIR REMOVAL TO AVOID ANY INTERRUPTION OF SERVICE TO ADJACENT PROPERTIES.

THE GENERAL CONTRACTOR SHALL PROVIDE AND INSTALL SHORING REQUIRED IN CONNECTION WITH THE DEMOLITION OPERATIONS, AND THE SUPPORTS SHALL HOLD THE EXISTING WORK THAT IS TO REMAIN IN PROPER POSITION UNTIL NEW SUPPORTING MEMBERS. AND INJURIES TO THE PUBLIC.

AFTER WORK HAS BEEN STARTED, IT SHALL BE CARRIED OUT TO COMPLETION, PROMPTLY, EXPEDITIOUSLY, AND IN AN ORDERLY MANNER, USING METHODS COMMONLY EMPLOYED, AND AS PROVIDED UNDER THE CITY OR COUNTY CODE FOR DEMOLITION WORK AS APPLICABLE.


GENERALLY, THE GENERAL CONTRACTOR SHALL DO ANY CUTTING AND REMOVE ANY OR ALL ITEMS, WHETHER SPECIFICALLY MENTIONED OR INDICATED, WHICH OBVIOUSLY WILL INTERFERE WITH OR BECOME INCONGRUOUS TO PROPOSED CONSTRUCTION FINISHES. WHEN ITEM(S) IS/ARE QUESTIONABLE, HE SHALL NOTIFY THE ARCHITECT. THE GENERAL CONTRACTOR SHALL EXERCISE UTMOST CARE TO SEE THAT MINIMUM CUTTING IS DONE.

SALVAGE

ALL ITEMS DEEMED SALVAGEABLE BY THE OWNER WILL EITHER BE INDICATED ON THE DRAWINGS, AND SHALL BE REMOVED PRIOR TO THE START OF DEMOLITION, OR WILL BE DIRECTED BY THE OWNER TO BE STORED BY THE CONTRACTOR AND SHALL REMAIN THE PROPERTY OF THE OWNER. ITEMS TO BE RELOCATED WILL BE INDICATED ON THE DRAWINGS WITH THE EXCEPTION OF ANY SALVAGEABLE ITEMS, AS DIRECTED BY THE OWNER TO BE RETAINED, ALL REMOVED STRUCTURES AND MATERIALS SHALL BECOME THE PROPERTY OF THE CONTRACTOR. NO DEBRIS OR CONTRACTOR SALVAGEABLE ITEMS SHALL BE STORED OR ACCUMULATED ON THE PREMISES.

SITE PROTECTION

THE GENERAL CONTRACTOR SHALL PROTECT ALL INTERIOR AND EXTERIOR EXISTING CONSTRUCTION THAT IS TO REMAIN, INCLUDING LANDSCAPING ALONG THE PROPERTY LINES, AS WELL AS ON ADJACENT LOTS. ANY DAMAGE OR LOSS RESULTING FROM NEW CONSTRUCTION WORK SHALL BE CORRECTED OR REPLACED BY THE CONTRACTOR AT NO ADDITIONAL COST TO THE OWNER.

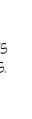

THE GENERAL CONTRACTOR SHALL BE FAMILIAR WITH MUNICIPAL REGULATIONS AND CARRY OUT THE WORK IN COMPLIANCE WITH ALL FEDERAL AND STATE REQUIREMENTS TO REDUCE FIRE HAZARDS AND INJURIES TO THE PUBLIC.

THE GENERAL CONTRACTOR SHALL PROVIDE AND INSTALL A TEMPORARY CONSTRUCTION FENCE, MEETING CITY STANDARDS, DURING CONSTRUCTION AND TAKE ALL MEASURES TO PROTECT THE PUBLIC FROM INJURY CAUSED ON SITE.

GLAZING REQUIREMENTS

ALL WINDOWS AND DOORS MUST MEET THE AIR AND INFILTRATION STANDARDS OF THE CURRENT ANSI AND SHALL BE CERTIFIED AND LABELLED.

HEATING DESIGN TEMPERATURE

MINIMUM INSIDE WINTER DESIGN TEMPERATURE IS 70 DEGREES

VAPOUR RETARDER AND AIR BARRIER

HAZARDOUS MATERIALS

THE ARCHITECT AND THE ARCHITECT'S CONSULTANTS ARE NOT "OWNER OR OPERATOR" AS DEFINED UNDER NESHAP, SECTION 112 OF THE CLEAN AIR ACT AND THEREFORE SHALL HAVE NO RESPONSIBILITY FOR THE DISCOVERY, PRESENCE, HANDLING, REMOVAL TRANSPORTATION, STORAGE OR DISPOSAL OF OR EXPOSURE OF PERSONS TO HAZARDOUS MATERIAL IN ANY FORM AT THE PROJECT PREMISES, INCLUDING BUT NOT LIMITED TO ASBESTOS, ASBESTOS PRODUCTS, POLYCHLORINATED BIPHENYL (PCB) OR OTHER TOXIC SUBSTANCES.

FLASHING CONDITIONS

FLASHING CONDITIONS SHOWN IN THESE PLANS WILL REQUIRE REMOVAL OF (E) SIDING ON ADJACENT SURFACES. CONTRACTOR TO COORDINATE W/ ARCHITECT FOR FLASHING INSTALLATION FOR AREAS WHERE SIDING IS NOT SCHEDULED FOR REPLACEMENT.

SYMBOLS

or NO. ABBREVIATIONS A.B. ABV A.C. PAVING A/C A.D. ADH. ADJ. AFF. ALT. ALUM. ANG. BA. BD. BDRM. BLDG. BLKG. BM. BOT. CAB. CEM. CLG. CLO. CLR. COL. CONC. CONST. CONT. CTR. DBL. D.F. DIA. DIAG. DIM. DIN. RM. DN. D.S. DTL. DWG. (E) or EXIST EIFS ELEC. EQ. EQPT. E.W. EXT. F.A.U. F.A.R. F.D. FDN. F.E.C. FIN. FLASH'G. FLR. F.O.C. F.O.M. F.O.S. FRM. FT. FTG. GA. GAR. G.D. G.F.I. G.I. GLULAM. GYP. BD. H.B. H.C. HDWD. HORIZ. HR. ΗT HVAC I.I.C. IN. INCL. INSUL. INT. JAN. KIT. LAM. LAUND. LAV. LB. or # LIN. LIV. RM.

REVIATION LIST

ANGLE AND CENTER LINE DIAMETER OR ROUND PFNNY NUMBER SQUARE FOOT ANCHOR BOLT ABOVE ASPHALT CONCRETE PAVING AIR CONDITIONING AREA DRAIN ADHESIVE ADJACENT ABOVE FINISH FLOOR ALTERNATE ALUMINUM ANGLE BATHROOM BOARD BEDROOM BUILDING BLOCKING BEAM BOTTOM CABINET CEMENT CEILING CLOSET CLEAR COLUMN CONCRETE CONSTRUCTION CONTINUOUS CENTER DRYER DOUBLE DOUGLAS FIR OR DRINKING FOUNTAIN DIAMETER DIAGONAL DIMENSION DINING ROOM DOWN DOWNSPOUT DETAIL DRAWING EXISTING EACH EXTERIOR INSULATION FINISH SYSTEM T.O. ELECTRICAL EQUAL EQUIPMENT EACH WAY EXTERIOR FORCED AIR UNIT FLOOR AREA RATIO FLOOR DRAIN FOUNDATION FIRE EXTINGUISHER CABINET FINISH FLASHING FLOOR FACE OF CONCRETE FACE OF MASONRY FACE OF STUD FRAME FEET FOOTING GUAGE GARAGE GARBAGE DISPOSAL GROUND FAULT INTERRUPTER GALVANIZED IRON GLULAM BEAM GYPSUM BOARD HOSE BIB HOLLOW CORE HARDWOOD HORIZONTAL

HOUR HEIGHT HEATING VENTILATION & AIR CONDITIONING IMPACT INSULATION CLASS

CSI

ICBO

NFPA

NRCA

UBC

UFC

WIC

ADA

ADAAG

SMACNA

INCH INCLUDE INSULATION INTERIOR

JANITOR KITCHEN

LAMINATE LAUNDRY LAVATORY POUND LINEN LIVING ROOM LIGHTWEIGHT

LT. WT.

MAT. MAX. MECH. MEMB. MFR. MIN. MSTR. BDRM. MTL. N.I.C. N.T.S. 0.C. 0.Н. OPNG. OPP PAN. PDR. PL. P. LAM. PLAST. PLYWD. PREFAB. P.T. P.T.D.F. P.T. SLAB RAG RFG. REG. REQ'D. RM. RDWD. REF. S.C. SCH. S.G.D. SHT. SIM. SPEC. S.T.C. STL. STOR. STRUCT. SUBFLR. SQ. SQ. FT. TOIL. T.P.H. TYP. U.O.N. VERT. V.G.D.F. W/ W WD. WIN. W.P. W.R. GYP. BD. WT. W.W.F. YD. AGENCIES ACI. AIA AISC AITG ANSI ASTM CAC CBC CEC CMC CPC

MEMBRANE MANUFACTURER MINIMUM MASTER BEDROOM METAL NEW NOT IN CONTRACT NOT TO SCALE OVER ON CENTER (S) OPPOSITE HAND OPENING OPPOSITE PANTRY POWDER ROOM PLATE PLASTIC LAMINATE PLASTER PLYWOOD PREFABRICATED PRESSURE-TREATED PRESSURE TREATED DOUGLAS FIR POST TENSION SLAB RETURN AIR GRILLE REFRIGERATOR REGISTER REQUIRED ROOM REDWOOD REFER SOLID CORE SCHEDULE SLIDING GLASS DOOR SHEET SIMILAR SPECIFICATION SOUND TRANSMISSION CLASS STEEL STORAGE STRUCTURE OR STRUCTURAL SUB-FLOOR SQUARE SQUARE FOOT TELEPHONE TOP OF TOILET TOILET PAPER HOLDER TYPICAL UNLESS OTHERWISE NOTED VERTICAL VERTICAL GRAIN DOUGLAS FIR WITH WASHER WOOD WINDOW WATERPROOFING W.R. GYPSUM BOARD WELDED WIRE FABRIC YARD AMERICAN CONCRETE INSTITUTE THE AMERICAN INSTITUTE OF ARCHITECTS AMERICAN INSTITUTE OF STEEL CONSTRUCTION AMERICAN INSTITUTE OF TIMBER CONSTRUCTION AMERICAN NATIONAL STANDARDS INSTITUTE AMERICAN SOCIETY FOR TESTING & MATERIALS CALIFORNIA ADMINISTRATIVE CODE CALIFORNIA BUILDING CODE CALIFORNIA ELECTRICAL CODE CALIFORNIA MECHANICAL CODE CALIFORNIA PLUMBING CODE CONSTRUCTION SPECIFICATION INSTITUTE INTERNATIONAL CONFERENCE OF BUILDING OFFICIALS NATIONAL FIRE PROTECTION ASSOCIATION

MATERIAL

MAXIMUM

MECHANICAL



GENERAL NOTES

JOB: 1303

DRAWN ΡI

SHEET NO.

PERMIT SET 06/18/14

NATIONAL ROOFING CONTRACTORS ASSOCIATION

SHEET METAL & AIR CONDITIONING CONTRACTORS

NATIONAL ASSOCIATION

UNIFORM FIRE CODE

ABBREVIATED CODES & STANDARDS

UNIFORM BUILDING CODE


UNDERWRITERS LABORATORIES, INC.

AMERICANS WITH DISABILITIES ACT


AMERICANS WITH DISABILITIES ACT

ACCESSIBILITY GUIDELINES

WOODWORK INSTITUTE OF CALIFORNIA

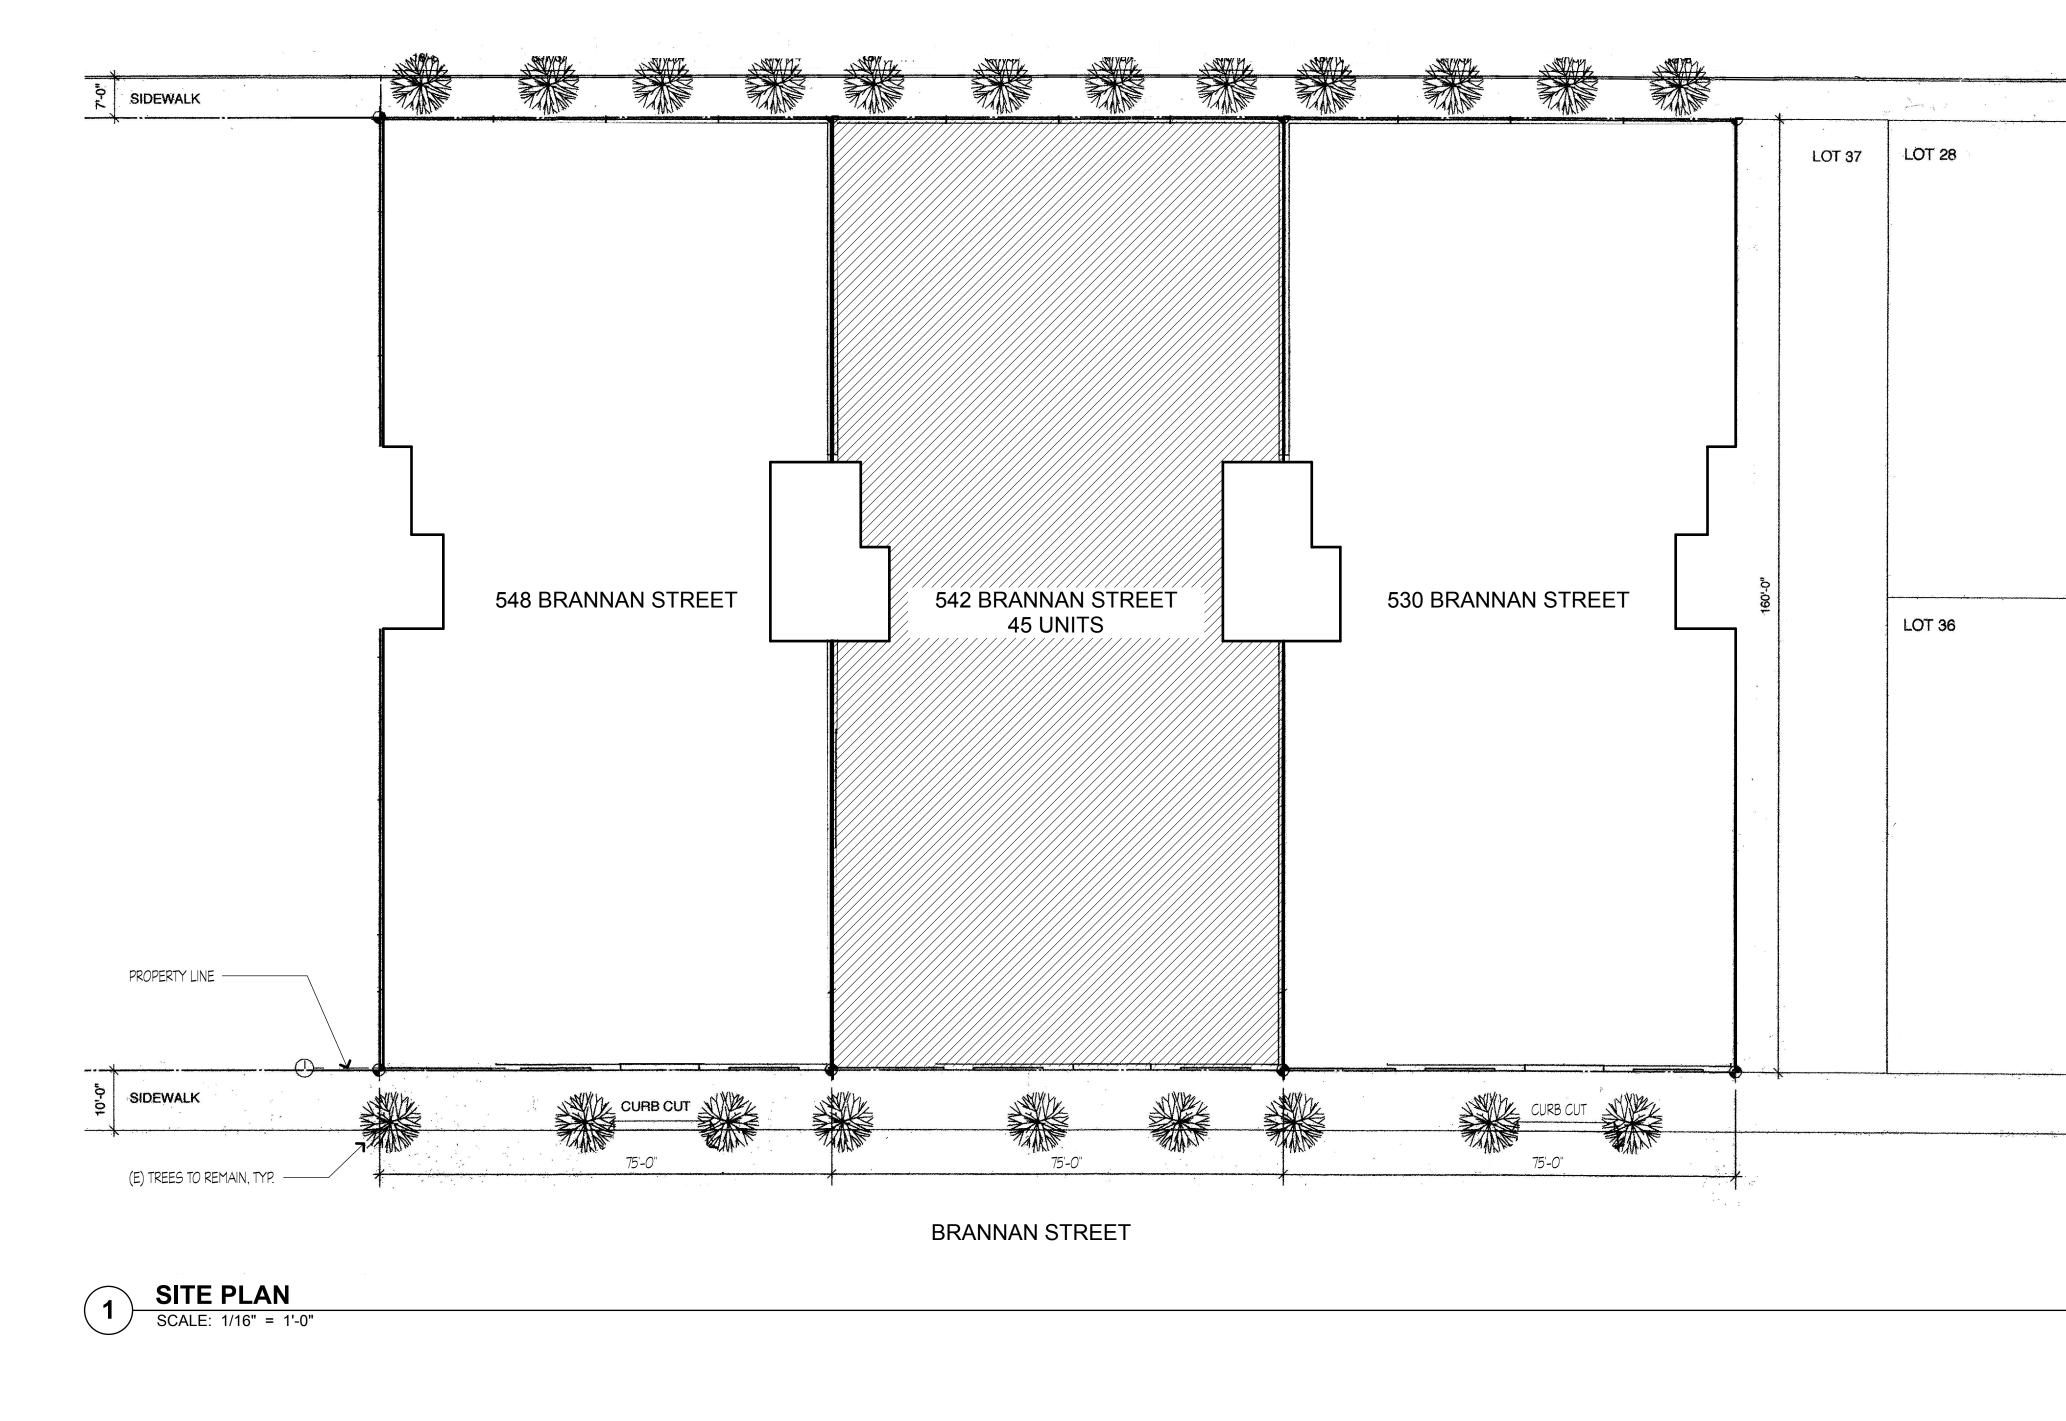

FREELON STREET

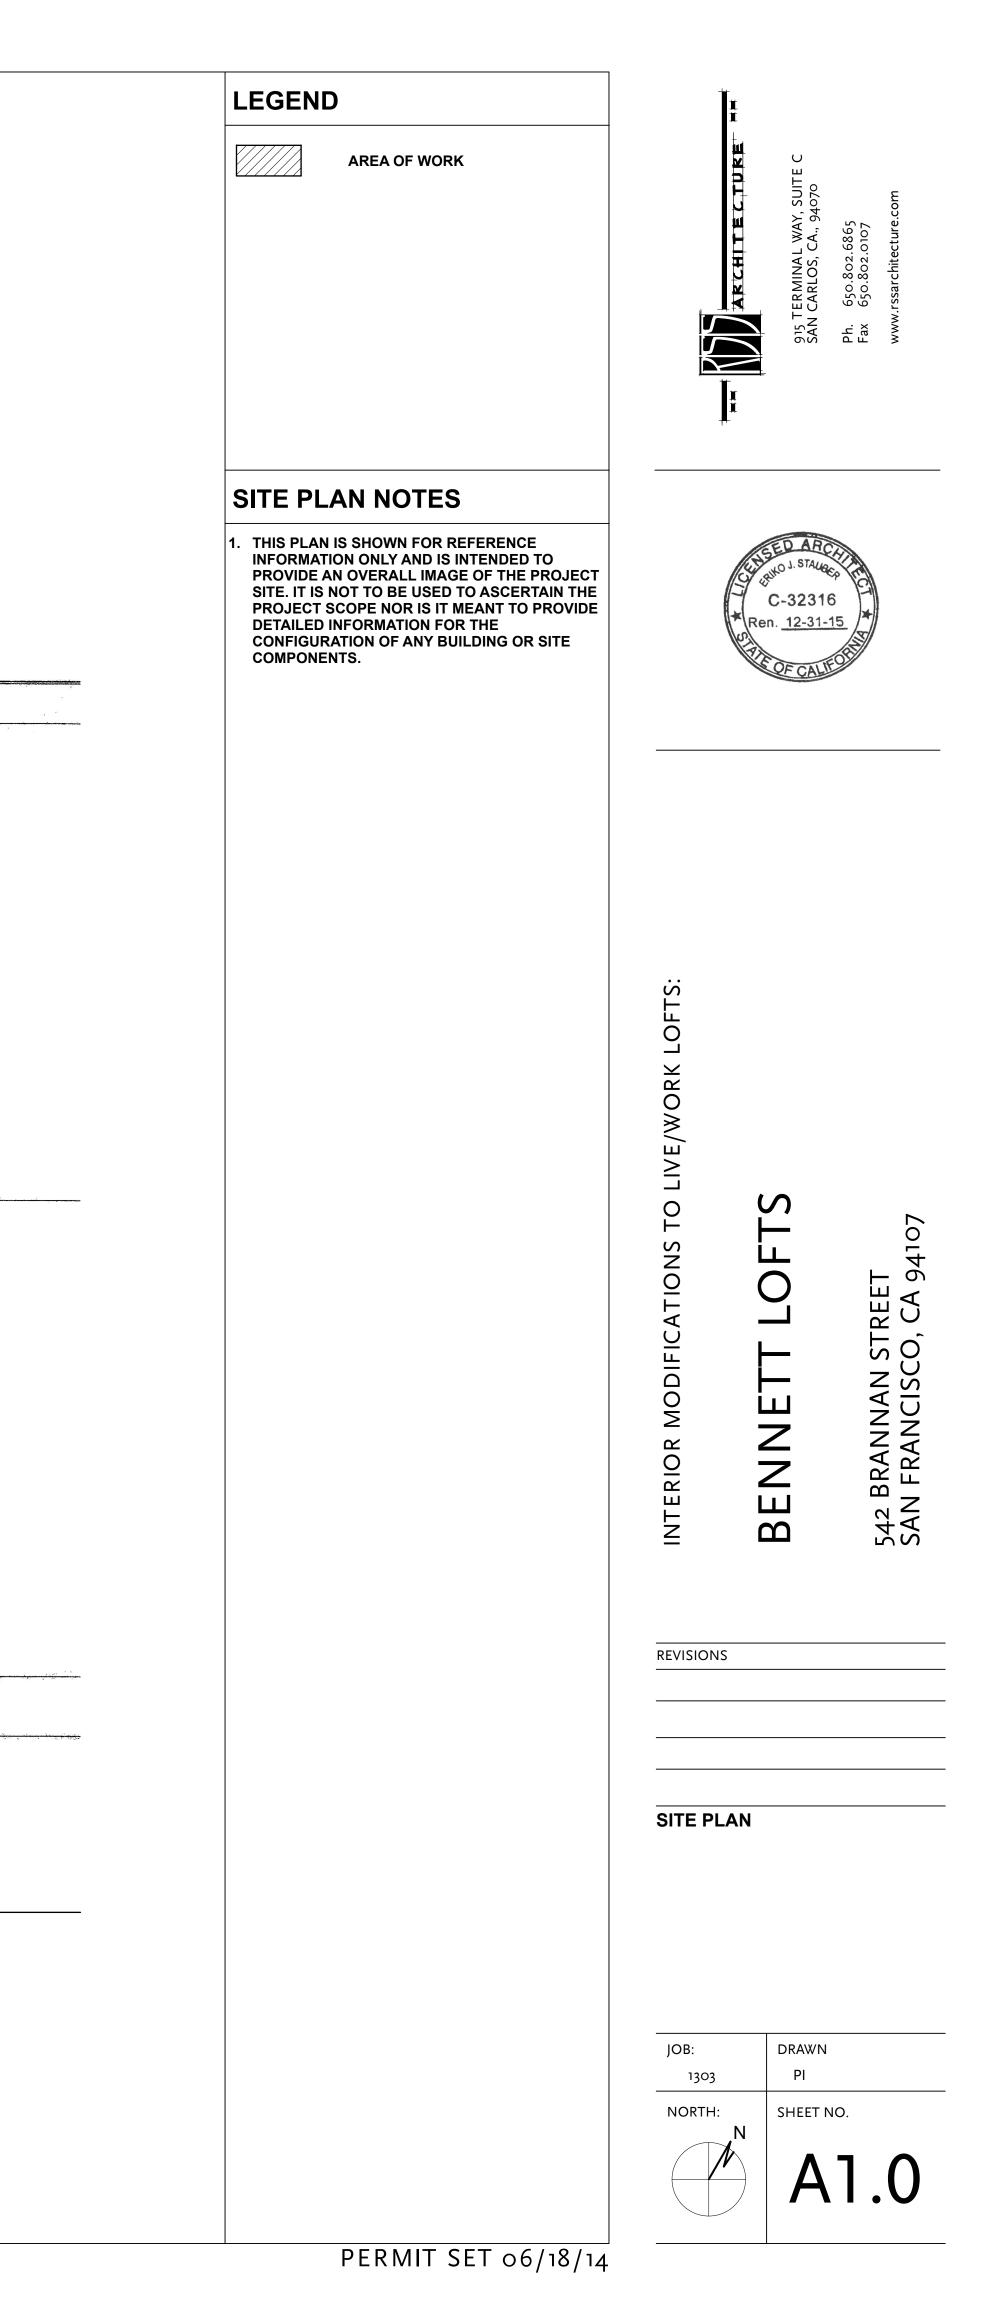




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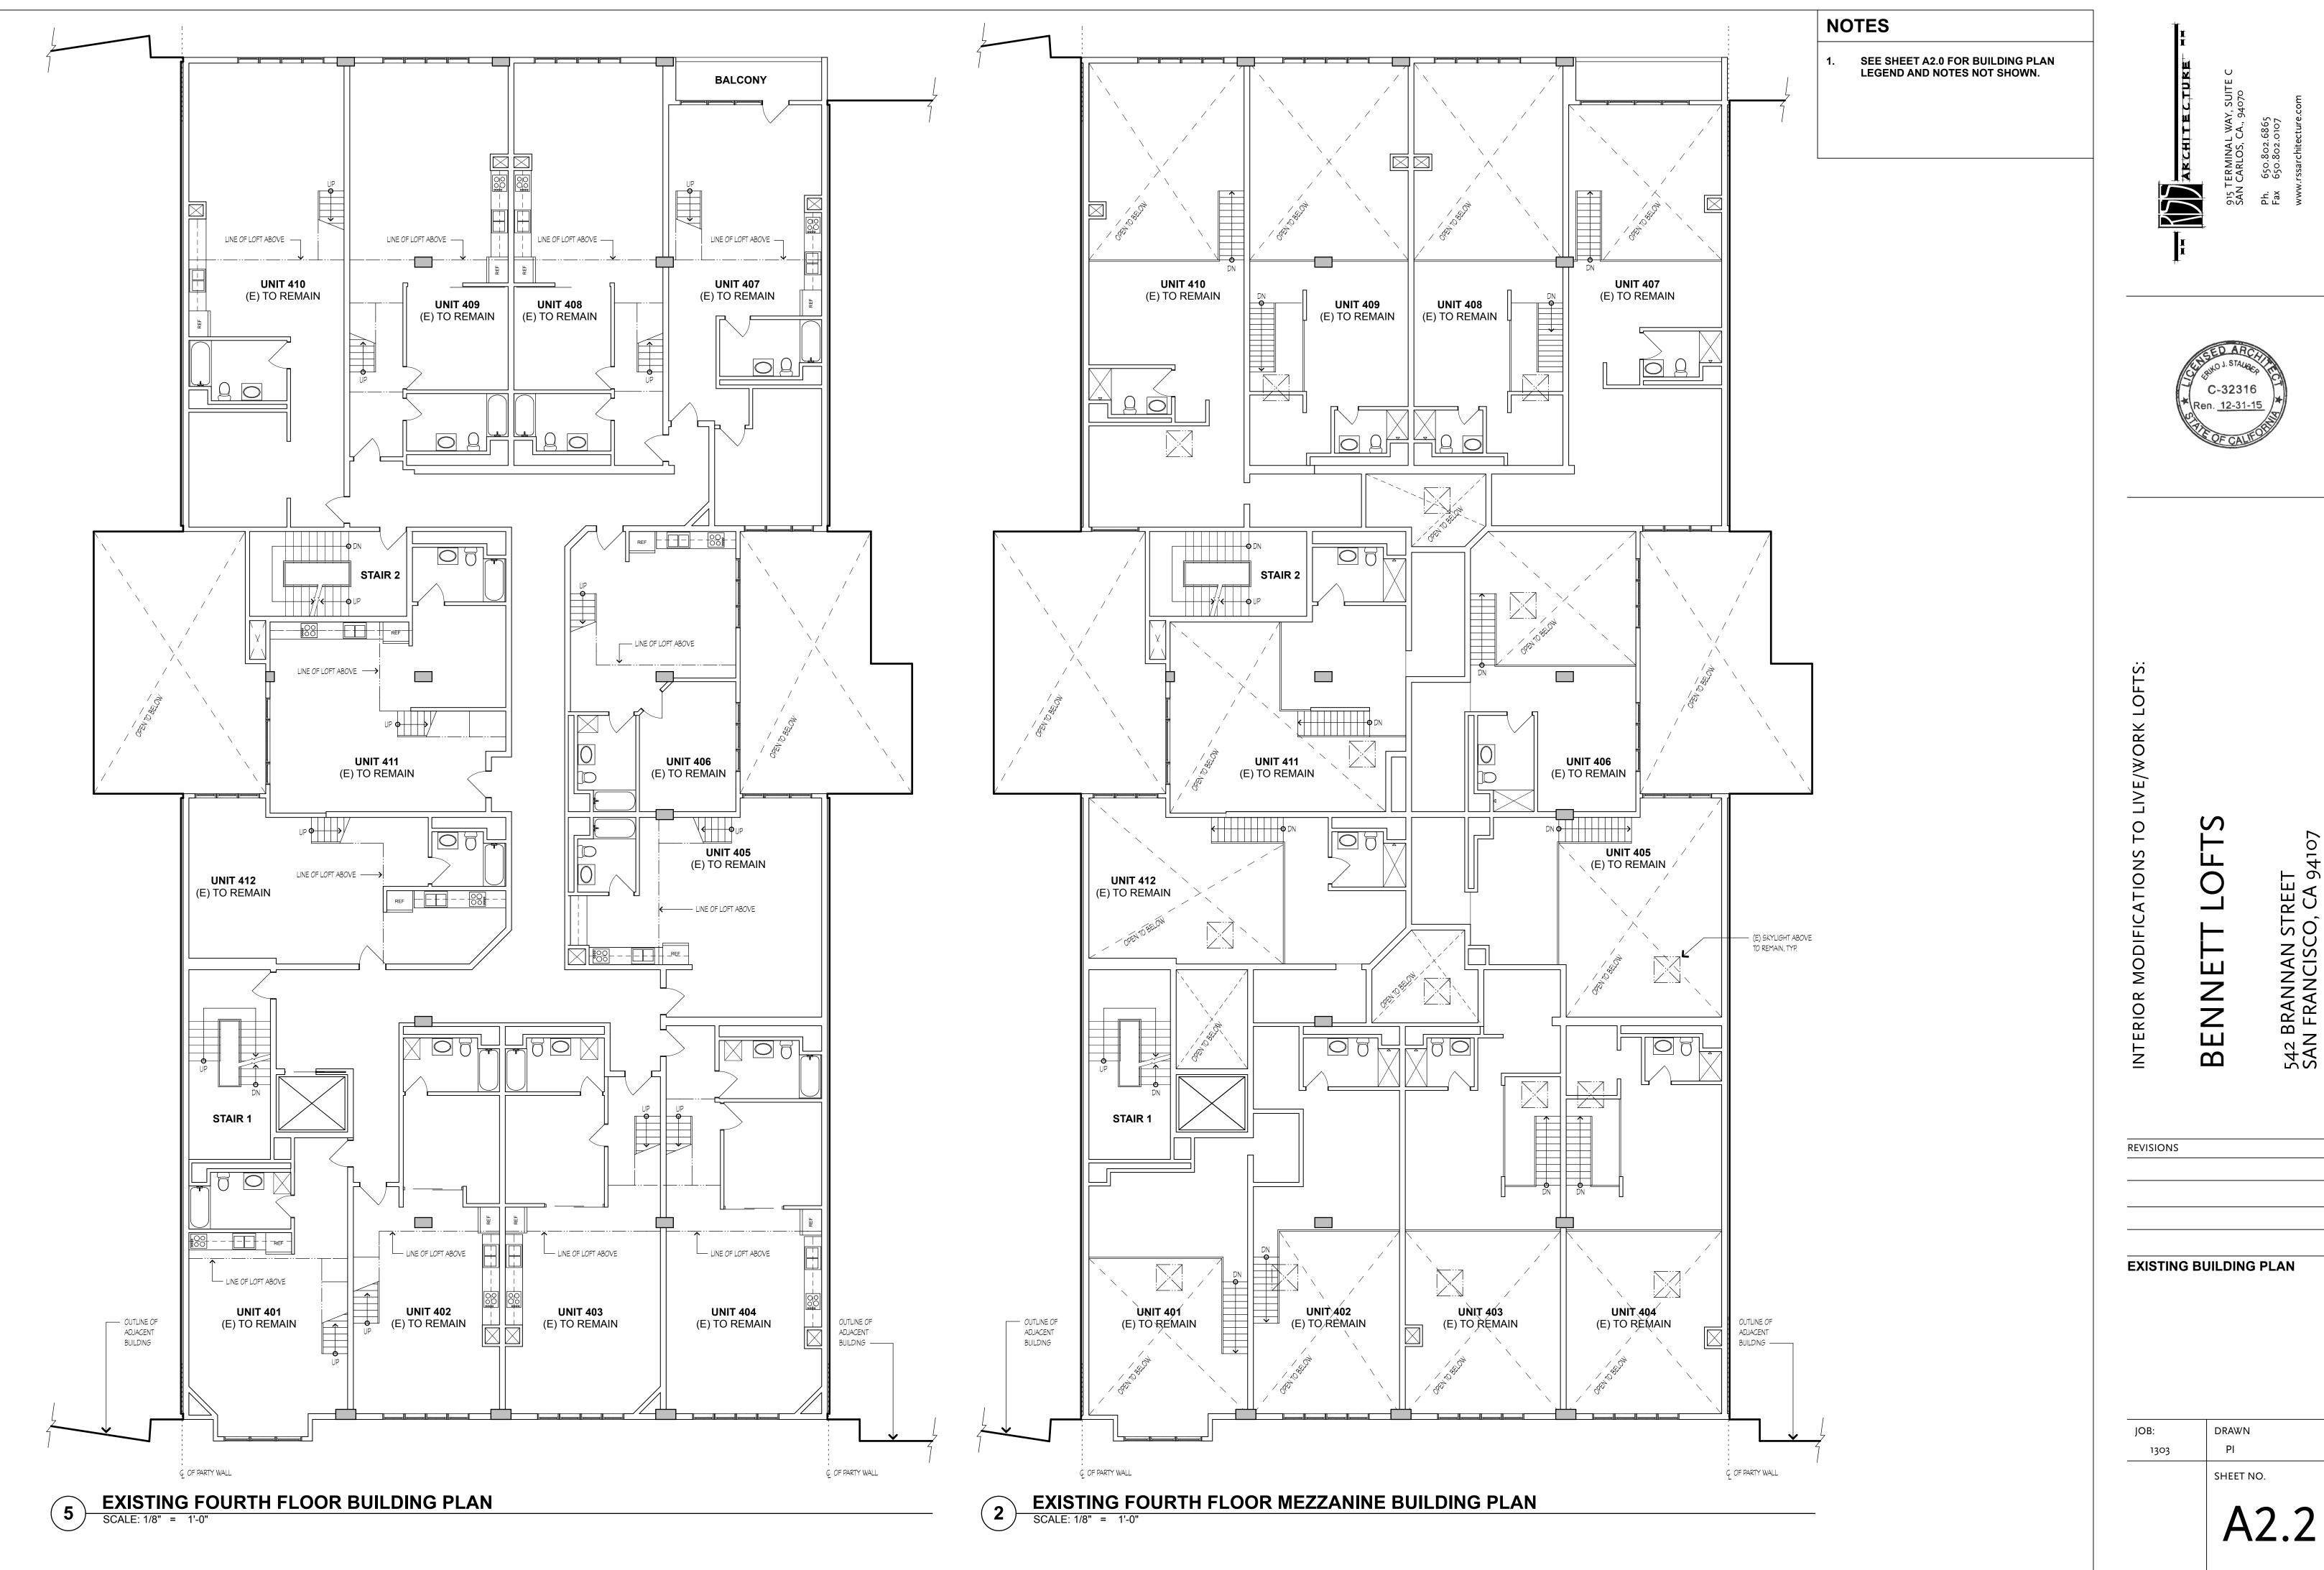
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542 BRANNAN STREET SAN FRANCISCO, CA 94107




SEE SHEET A2.0 FOR BUILDING PLAN LEGEND AND NOTES NOT SHOWN.





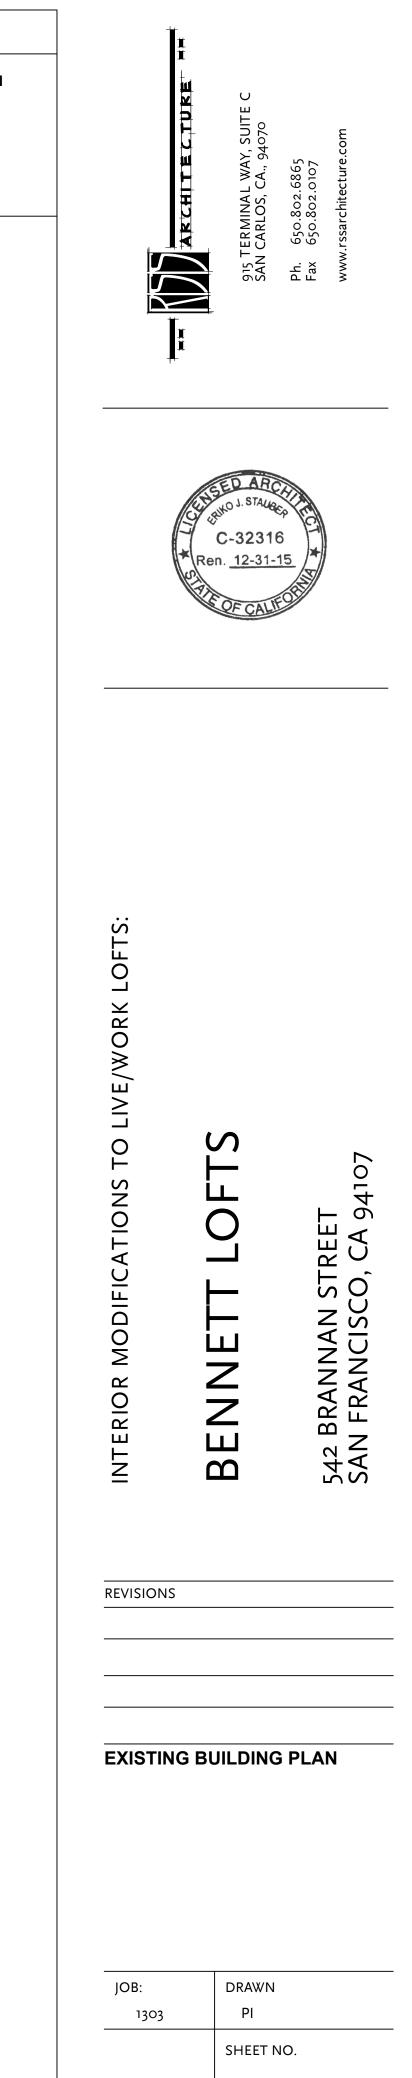

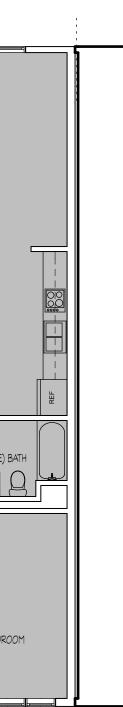

NOTES

SEE SHEET A2.0 FOR BUILDING PLAN LEGEND AND NOTES NOT SHOWN.


UNIT DATA 45				
UNIT #	NOTES	EXISTING SQ FT	PROPOSED SQ FT	UNIT TYPE
101	LIVE/WORK	-	-	1 BDRM
102	DWELLING	1,515	765	1 BDRM
103	LIVE/WORK	-	750	1 BDRM
104	DWELLING	1,210	620	STUDIO
105	LIVE/WORK	-	590	STUDIO
106	DWELLING	1,675	890	1 BDRM
108	LIVE/WORK	-	785	1 BDRM
110	LIVE/WORK	-	-	2 BDRM
114	DWELLING	1,250	650	STUDIO
116	LIVE/WORK	-	600	STUDIO
201	LIVE/WORK	-	-	2 BDRM
202	DWELLING	1,525	775	1 BDRM
203	LIVE/WORK	-	750	1 BDRM
204	DWELLING	1,195	615	STUDIO
205	LIVE/WORK	-	580	STUDIO
206	DWELLING	1,663	878	1 BDRM
207	LIVE/WORK	-	785	1 BDRM
208	DWELLING	_	815	1 BDRM
210	LIVE/WORK	1,765	950	1 BDRM
212	DWELLING	1,270	670	STUDIO
214	LIVE/WORK	-	600	STUDIO
301	LIVE/WORK	-	-	STUDIO
302	LIVE/WORK	-	-	1 BDRM
303	LIVE/WORK	-	-	1 BDRM
304	LIVE/WORK	-	-	1 BDRM
305	LIVE/WORK	-	-	STUDIO
306	LIVE/WORK	-	-	1 BDRM
307	LIVE/WORK	-	-	1 BDRM
308	LIVE/WORK	-	-	1 BDRM
309	LIVE/WORK	-	-	1 BDRM
310	LIVE/WORK	-	-	1 BDRM
311	LIVE/WORK	-	-	1 BDRM
312	LIVE/WORK	-	-	STUDIO
401	LIVE/WORK	-	-	STUDIO
402	LIVE/WORK	-	-	1 BDRM
403	LIVE/WORK	-	-	1 BDRM
404	LIVE/WORK	-	-	1 BDRM
405	LIVE/WORK	-	-	STUDIO
406	LIVE/WORK	-	-	1 BDRM
407	LIVE/WORK	-	_	1 BDRM
408	LIVE/WORK	-	-	1 BDRM
409	LIVE/WORK		-	1 BDRM
410	LIVE/WORK	-	-	1 BDRM
411	LIVE/WORK	_		1 BDRM
412	LIVE/WORK		<u> </u>	STUDIO

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542 BRANNAN STREET SAN FRANCISCO, CA 94107


REVISIONS

PROPOSED BUILDING PLAN


JOB: 1303 DRAWN ΡI
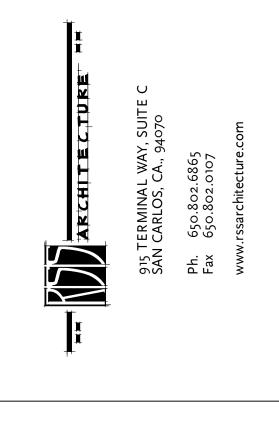
> SHEET NO. A2.3




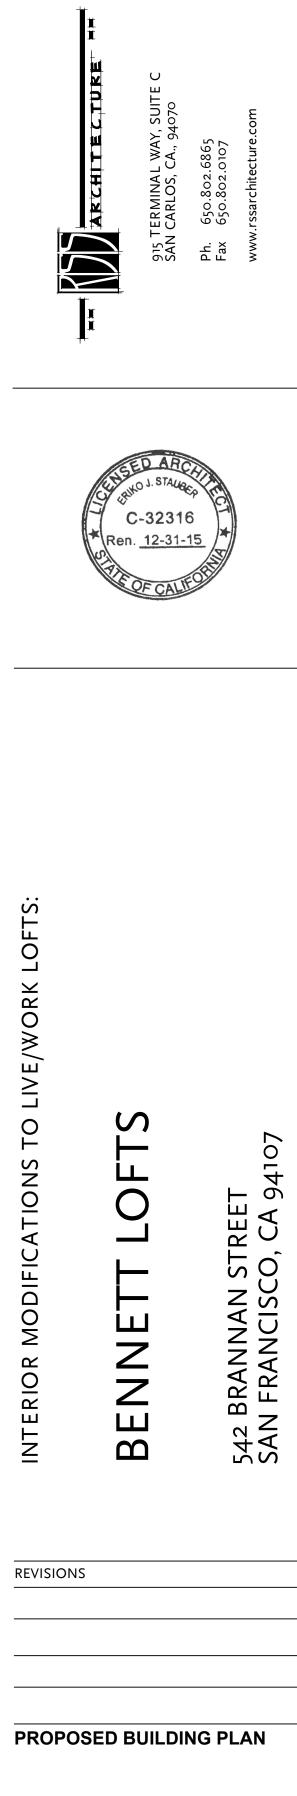

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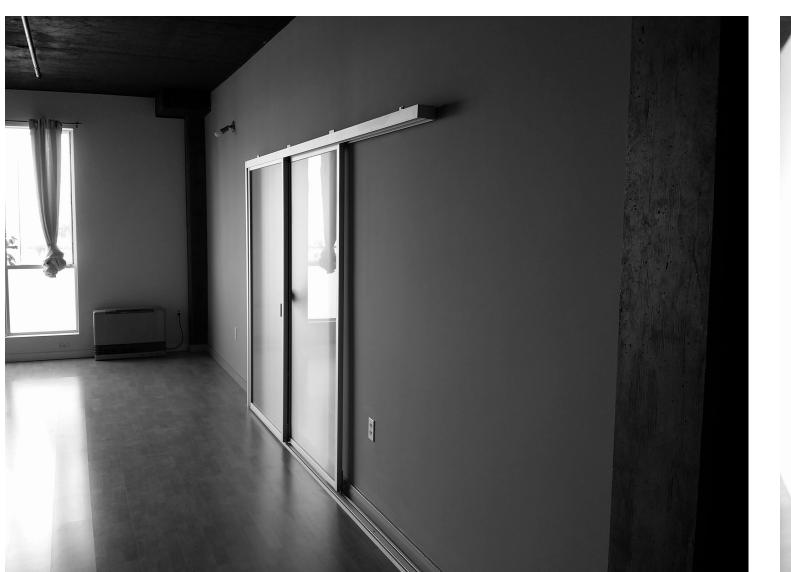


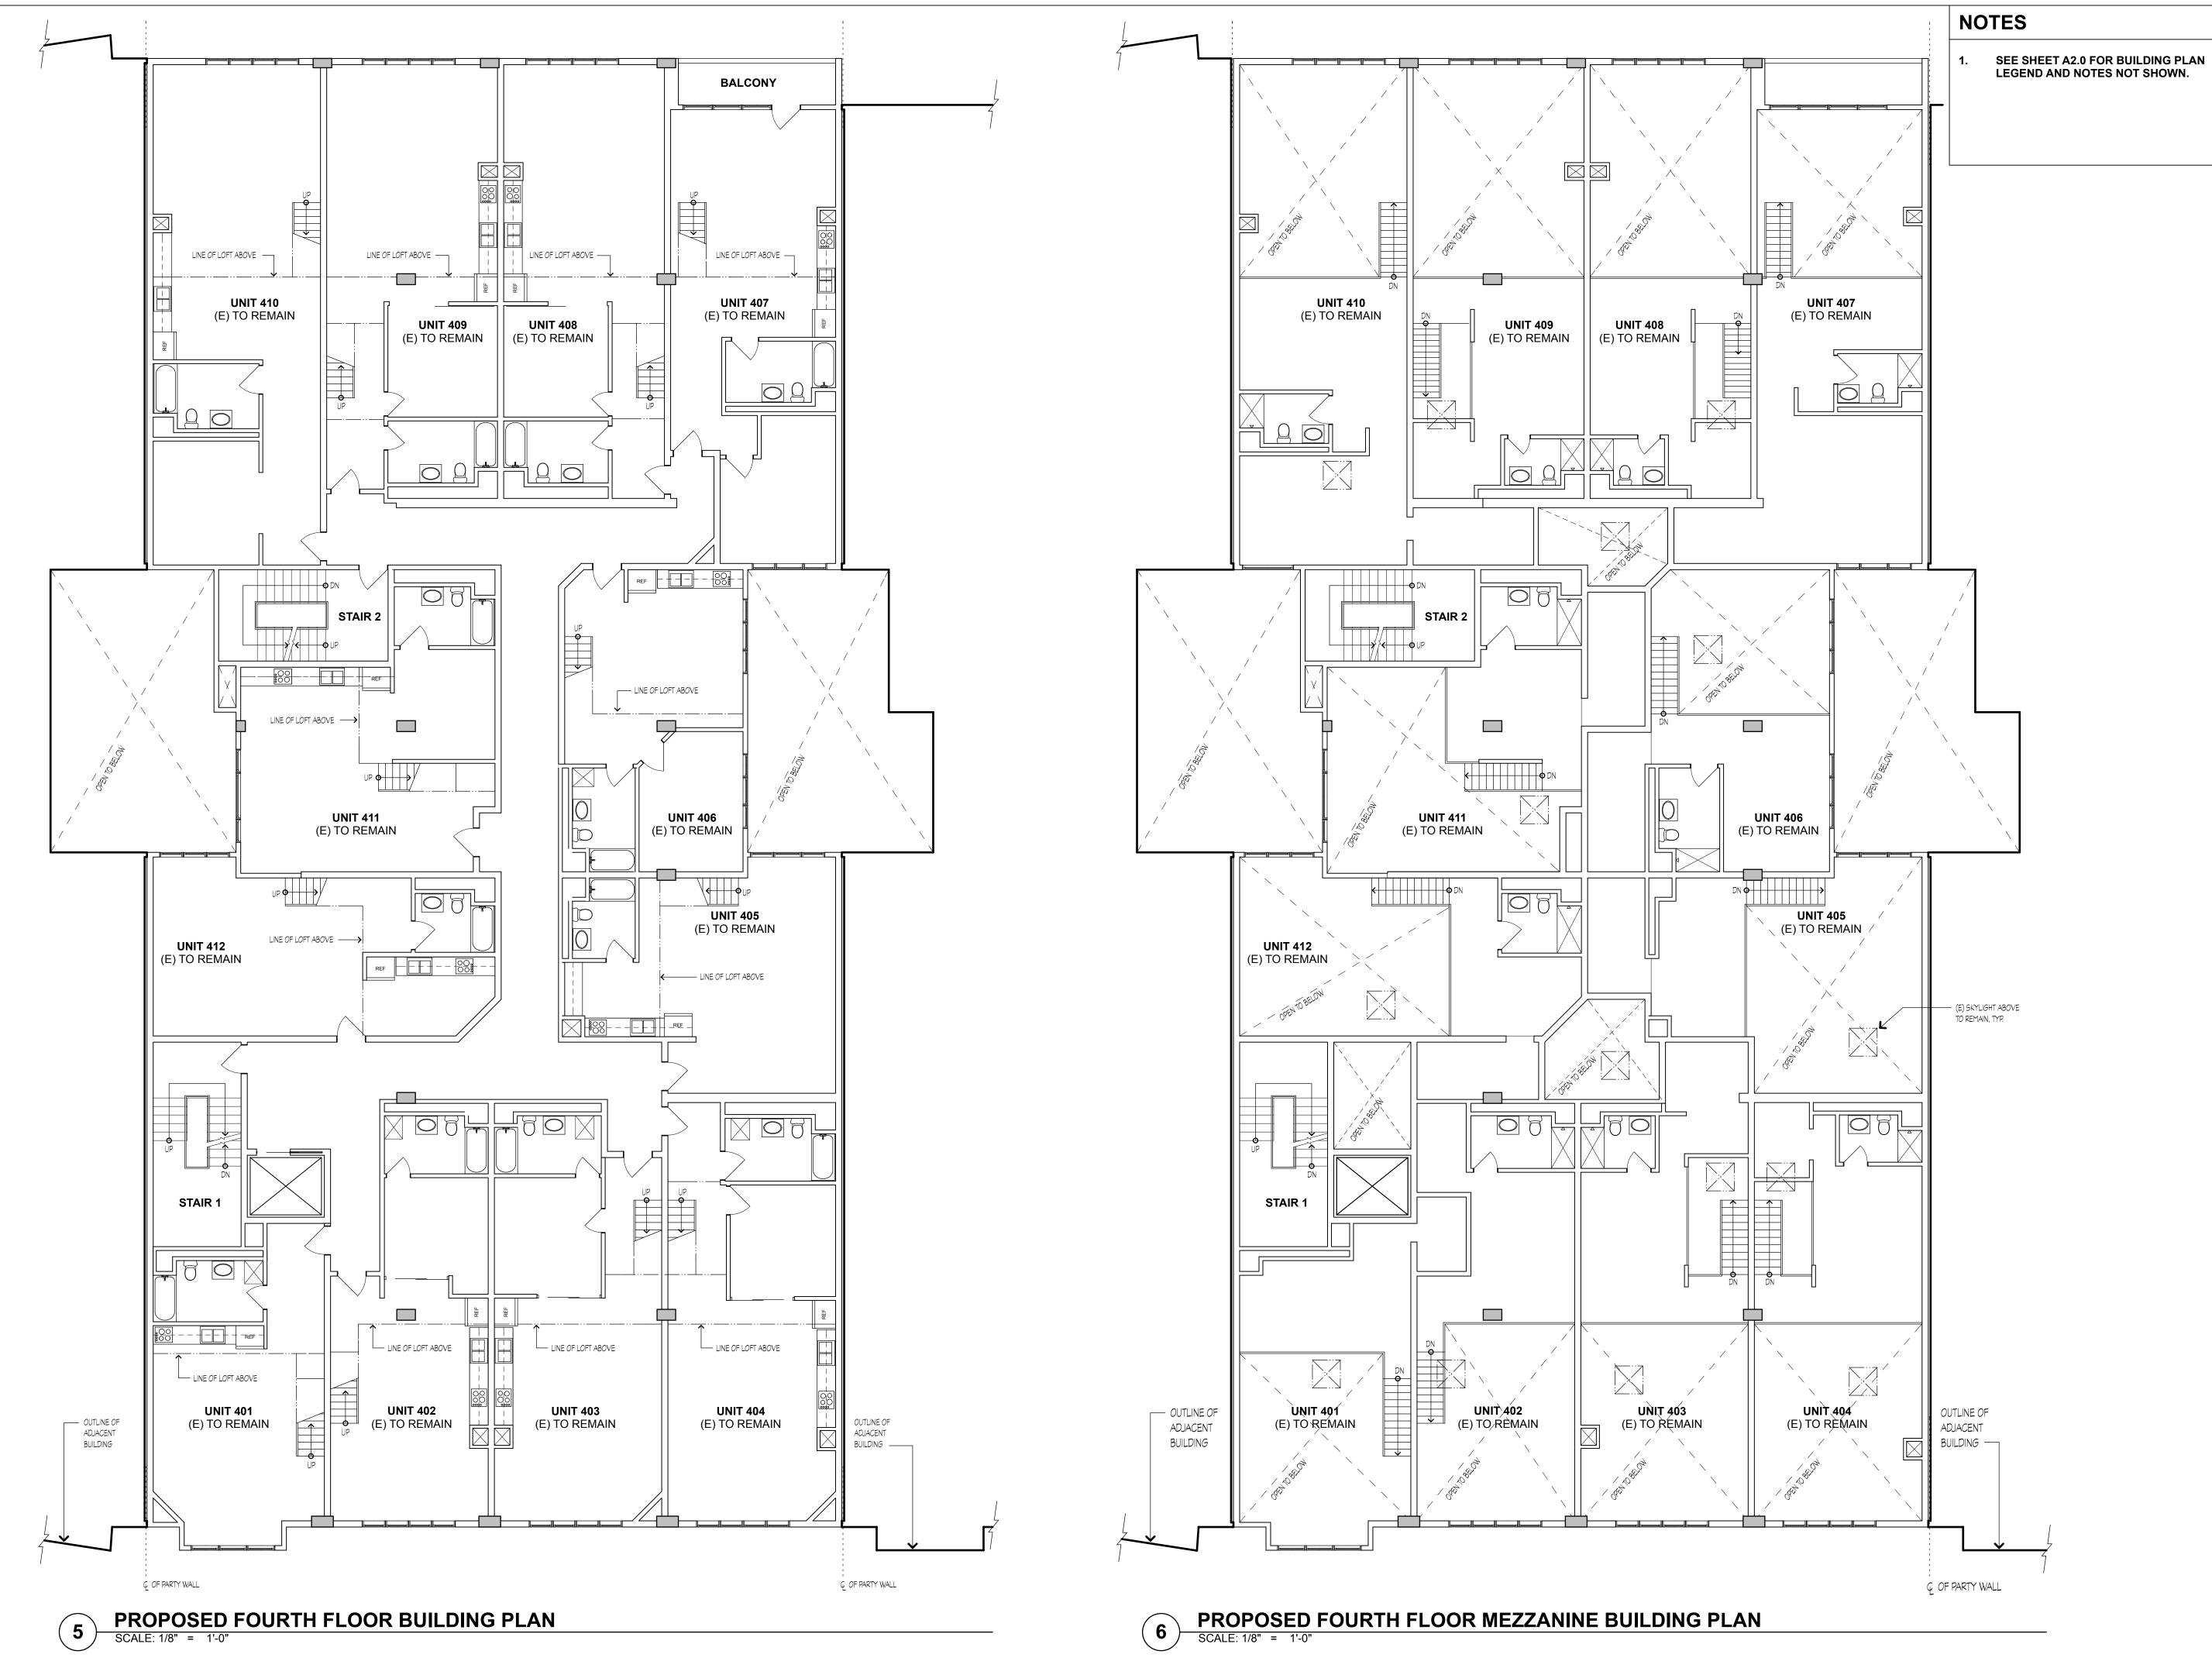



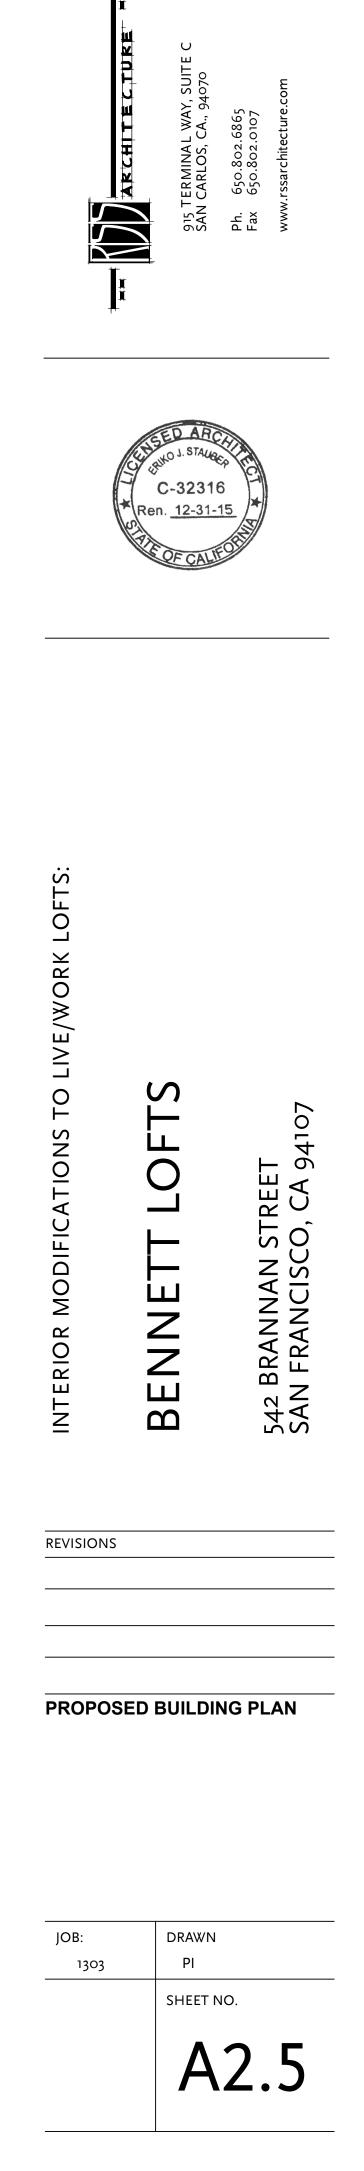

STREET VIEW OF BENNETT LOFTS





TYPICAL PARTITION WALL **BETWEEN UNITS**



STREET VIEW OF BENNETT LOFTS



<u>LIGHTWELL</u>

TYPICAL KITCHEN AREA

<u>TYPICAL UNIT ENTRY</u>



<u>TYPICAL UNIT ENTRY HALL</u>



TYPICAL SLEEPING AREA

CARI $\langle \langle \rangle$ 915 T SAN РҺ. Fax

TS LOF BENNETT

542 BRANNAN STREET SAN FRANCISCO, CA 94107

REVISIONS

LIVE/WORK LOFTS:

INTERIOR MODIFICATIONS TO

EXISTING PHOTOS

JOB: 1303

DRAWN ΡI

SHEET NO.

A3.0

PERMIT SET 06/18/14



INTERIOR IMPROVEMENTS TO LIVE/WORK LOFTS: 548 BRANNAN STREET, SAN FRANCISCO, CA 94107

GE	ENERAL SCOPE OF WORK	
1. 1	LEGALIZE OCCUPANCY CLASSIFICATION USE OF 7 EXISTING LIVE/WORK UNITS FOR RESIDENTIAL USE.	
2. (CONVERT UNIT 114 INTO NEW LEASING OFFICE.	
GE	ENERAL NOTES	
1.	CONTRACTOR SHALL NOTIFY ARCHITECT IF THERE ARE ANY DISCREPANCIES BETWEEN THE REFERENCE DRAWINGS AND ACTUAL BUILT CONDITION, PRIOR TO CONSTRUCTION TO RESOLVE.	
2.	IT IS THE INTENT OF THESE DOCUMENTS TO MAINTAIN THE EXISTING RATED WALL ASSEMBLIES.	

BENNETT LOFTS

PROJECT IN	FO
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PROPERTY MANAGEMENT:

ESSEX PROPERTY TRUST, INC. 925 E. MEADOW DRIVE PALO ALTO, CA 94303

CONTACT: JUSTIN CHU

TEL: 650.494.3700

ELECTRICAL ENGINEER:

NUTEK ENGINEERS 600 MAGDALENA AVE LOS ALTOS, CA 94024

CONTACT: PERRY SAEEDNIA

TEL: 650.796.7553

ARCHITECT: RSS ARCHITECTURE, INC. ANDREW RAYMUNDO, ARCHITECT

CONTACT: JIMMY CHANG 915 TERMINAL WAY, SUITE C SAN CARLOS, CA 94070

TEL: 650.802.6865

CIVIL ENGINEER: UNDERWOOD & ROSENBLUM, INC. 1630 OAKLAND ROAD, SUITE A114 SAN JOSE, CA 95131

CONTACT: DAVE VOORHIES, P.E.


TEL: 408.453.1222

PROJECT DATA SU

OCCUPANCY: TYPE OF CONSTRUCTION: APN: ZONING: SPRINKLERS: STORIES: EXISTING LOT AREA: EXISTING BLDG : TOTAL NO. OF EXISTING UNITS NO. OF NEW UNITS NEW LEASING OFFICE CONVERSION TOTAL NO. OF NEW UNITS

TOTAL NO. OF PARKING STALLS

SYMBOLS APPLICABLE CODE EXTERIOR ELEVATIONS 2013 CALIFORNIA BUILDING CODE - ELEVATION NUMBER - SHEET NUMBER 2013 CALIFORNIA FIRE CODE 2013 CALIFORNIA ELECTRICAL CODE ARCHITECTURAL DETAILS 2013 CALIFORNIA PLUMBING CODE – DETAIL NUMBER - SHEET NUMBER 2013 CALIFORNIA MECHANICAL CODE LEGEND NOTES 2013 ENERGY CODE COMPLIANCE - NOTE NUMBER ALL LOCAL CODES & ORDINANCES BY SAN FRANCISCO

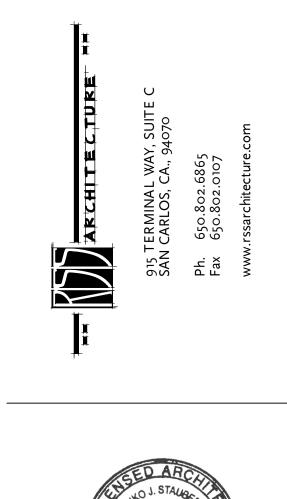



JMMARY	DRA	WING INDEX		
R1-B	ARCH	ITECTURAL:		
II-A 3777-073-106 SLI YES FOUR 12,000 SQ.FT. 11,029 SQ.FT. 34	A 0.0 A 0.1 A 1.0 A 2.0 A 2.1 A 2.2 A 2.3 A 2.4 A 2.5 A 3.0	TITLE SHEET GENERAL NOTES SITE PLAN EXISTING BUILDING PLAN EXISTING BUILDING PLAN EXISTING BUILDING PLAN PROPOSED BUILDING PLAN PROPOSED BUILDING PLAN EXISTING PHOTOS		
7	TRICAL:			
0N 1 42 33 (UNCHANGED)	E 0.0 E 1.0 E 1.1 E 2.0 E 2.1 E 2.2 E 3.0 E 4.0	LEGEND, NOTES, SYMBOLS GARAGE PLAN ELECTRICAL ROOM TYPICAL BUILDING PLAN TYPICAL BUILDING PLAN SINGLE LINE DIAGRAM LOAD CALCULATIONS		
ES	LOC	ATION MAP		
' THE CITY OF	And	Brinnen SS Brinnen SS Plavdom		
		PROJECT SITE		

PERMIT SET 08/21/14



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548 BRANNAN STREET SAN FRANCISCO, CA 94107

REVISIONS

TITLE SHEET

JOB:	DRAWN
1303	PI
NORTH:	SHEET NO.
N	A0.0

GENERAL

NO GUARANTEE FOR QUALITY OF CONSTRUCTION IS IMPLIED OR INTENDED BY THESE ARCHITECTURAL DOCUMENTS. THE GENERAL CONTRACTOR SHALL ASSUME FULL RESPONSIBILITY FOR ANY AND ALL CONSTRUCTION DEFICIENCIES.

CONSTRUCTION IS ALWAYS LESS THAN PERFECT SINCE BUILDINGS REQUIRE THE COORDINATION AND INSTALLATION OF MANY INDIVIDUAL PARTS BY THE VARIOUS CONSTRUCTION INDUSTRY TRADES. THESE DOCUMENTS CANNOT PORTRAY ALL COMPONENTS OR ASSEMBLIES EXACTLY. IT IS THE INTENT OF THESE ARCHITECTURAL DOCUMENTS THAT THEY REPRESENT A REASONABLE STANDARD OF CARE IN THEIR CONTENT. IT SHALL BE THE CONTRACTOR'S RESPONSIBILITY TO FULLY RECOGNIZE AND PROVIDE THAT STANDARD OF CARE.

THE CONSTRUCTION ASSEMBLIES DEPICTED IN THESE DOCUMENTS MAY PROVIDE FOR THE CONTACT OF DISSIMILAR MATERIALS WHICH, WHEN FINISH COATED OR SUBJECTED TO MOIST WEATHER CONDITIONS, MAY RESULT IN DISCOLORATION OF SOME OF THE MATERIAL SURFACES. THESE CONDITIONS MAY REQUIRE PERIODIC INSPECTION, MAINTENANCE AND/OR RE-COATING AT CLOSER INTERVALS THAN OTHER NON-AFFECTED SURFACES.

THESE ARCHITECTURAL CONSTRUCTION DRAWINGS DESCRIBE THE REQUIREMENTS OF THE PROJECT FOR A BUILDING PERMIT AND TO PREPARE ESTIMATES OF QUANTITY AND COSTS OF MATERIALS REQUIRED TO CONSTRUCT THE PROJECT. THESE DRAWINGS PROVIDE FOR ONLY SCHEMATIC PLUMBING/MECHANICAL EQUIPMENT LAYOUT AND SCHEMATIC ELECTRICAL POWER AND LIGHTING LAYOUT AS PREPARED BY THE ARCHITECT WITHOUT ENGINEERING DESIGNS, DETAILS, CALCULATIONS OR SPECIFICATIONS.

BY USE OF THESE DOCUMENTS, THE CONTRACTOR ACKNOWLEDGES THAT RSS ARCHITECTURE, AS THE ARCHITECT, IS THE AUTHOR OF, AND THEREFORE RESPONSIBLE FOR THE INTERPRETATION OF THESE DESIGN DOCUMENTS AND THAT THE CONTENT, CONCEPTS OR BASIC DESIGN DEMONSTRATED BY THE DOCUMENTS SHALL NOT BE FURTHER DEVELOPED, INTERPRETED, CLARIFIED OR TRANSFERRED WITHOUT WRITTEN CONSENT FROM THE ARCHITECT.

CHANGES TO THE PLANS AND SPECIFICATIONS BY MEANS OF SHOP DRAWINGS BECOME THE RESPONSIBILITY OF THE PERSON INITIATING SUCH CHANGES.

ALL GENERAL NOTES, SHEET NOTES AND LEGEND NOTES FOUND IN THESE DOCUMENTS SHALL APPLY, TYPICALLY, THROUGHOUT. IF INCONSISTENCIES ARE FOUND IN THE VARIOUS NOTATIONS, NOTIFY THE ARCHITECT IMMEDIATELY IN WRITING REQUESTING CLARIFICATION. IT IS THE EXPRESS INTENT OF THE PARTIES HERETO THAT THE ARCHITECT IS EXCULPATED FROM ANY LIABILITY WHATSOEVER, OCCASIONED BY THE CONTRACTOR'S FAILURE TO CARRY OUT THE WORK IN ACCORDANCE WITH THE CONTRACT DOCUMENTS.

INSOFAR AS THERE ARE MANY VARIABLES INVOLVED IN THE EXECUTION OF THE WORK DESCRIBED IN THESE DOCUMENTS, THE ARCHITECT DOES NOT CARRY ANY WARRANTY EXPRESSED OR IMPLIED FOR THE WORK OF THE TRADES.

THESE DOCUMENTS ARE COMPLETE AS PREPARED BY THE ARCHITECT. ADDITIONAL DOCUMENTS, INCLUDING WRITTEN SPECIFICATIONS, MAY BE PREPARED BY OTHERS AND USED TO SUPPLEMENT THE WORK OF THE CONTRACTOR. THE CONTRACTOR SHALL BE RESPONSIBLE FOR COORDINATING ALL SUPPLEMENTAL WORK IN CONFORMANCE WITH THESE DOCUMENTS.

THE CONTRACTOR SHALL, BY THE USE OF THESE DOCUMENTS, BE REQUIRED TO PROVIDE UNDERSTANDABLE AND THOROUGH INSTRUCTIONS TO THE OWNER ABOUT HIS/HER RESPONSIBILITIES FOR ON-GOING MAINTENANCE. THESE INSTRUCTIONS SHALL DESCRIBE PERIODIC INSPECTIONS AND PROCEDURES FOR MAINTENANCE OF BUILDING SYSTEMS AND MATERIALS, INCLUDING BUT NOT LIMITED TO: DRAINAGE, EROSION CONTROL, PLUMBING, MECHANICAL, PAVING, WATERPROOFING, DECKING, ROOFING, GLAZING, PAINTING, SEALANTS, ETC. THE CONTRACTOR SHALL OBTAIN INFORMATION AND INSTRUCTIONS FROM THE VARIOUS SUBCONTRACTORS, INSTALLERS AND MANUFACTURERS REGARDING MAINTENANCE OF THEIR SPECIFIC PORTIONS OF WORK AND MATERIALS. ALL WARRANTIES AND/OR GUARANTEES SHALL BE IDENTIFIED. THESE INSTRUCTIONS SHALL BE WRITTEN SO AS TO HAVE THE HOMEOWNER PROMPTLY ALERT THE CONTRACTOR AS TO ANY UNUSUAL WEARING OF MATERIALS OR MALFUNCTION OF COMPONENTS AND/OR ASSEMBLIES OF THE CONSTRUCTION. THE INSTRUCTIONS SHALL IDENTIFY THE EXPECTED USUAL WEARING. MOVEMENTS OR DEFORMATION OF MATERIALS AND THEIR PROJECTED LIFE.

ALL WORK SHALL COMPLY WITH APPLICABLE CODES AND TRADE STANDARDS WHICH GOVERN EACH PHASE OF THE WORK; INCLUDING, BUT NOT LIMITED TO: 2013 CALIFORNIA BUILDING CODE (CBC); CALIFORNIA MECHANICAL CODE (CMC); CALIFORNIA ELECTRICAL CODE (CEC); UNIFORM FIRE CODE (UFC); AMERICAN CONCRETE INSTITUTE (ACI); CALIFORNIA PLUMBING CODE (CPC), AND ALL APPLICABLE STATE AND/OR LOCAL CODES AND/OR LEGISLATION.

SITE EXAMINATION

THE CONTRACTOR AND ALL SUBCONTRACTORS SHALL THOROUGHLY EXAMINE THE SITE AND FAMILIARIZE THEMSELVES WITH THE CONDITIONS UNDER WHICH THE WORK IS TO BE PERFORMED. THE CONTRACTOR SHALL VERIFY, AT THE SITE, ALL MEASUREMENTS AFFECTING HIS WORK AND SHALL BE RESPONSIBLE FOR THE CORRECTIONS OF SAME. NO EXTRA COMPENSATION WILL BE ALLOWED TO THE CONTRACTOR FOR EXPENSES DUE TO HIS NEGLECT TO EXAMINE OR FAILURE TO DISCOVER CONDITIONS WHICH AFFECT HIS WORK.

DIMENSION CONTROL

IT IS THE RESPONSIBILITY OF THE CONTRACTOR AND ALL SUBCONTRACTORS TO CHECK AND VERIFY ALL CONDITIONS, DIMENSIONS, LINES AND LEVELS INDICATED. PROPER FIT AND ATTACHMENT OF ALL PARTS IS REQUIRED. SHOULD THERE BE ANY DISCREPANCIES, THE CONTRACTOR AND ALL SUBCONTRACTORS SHALL IMMEDIATELY NOTIFY THE ARCHITECT FOR CORRECTION OR ADJUSTMENT. IN THE EVENT OF FAILURE TO DO SO, THE CONTRACTOR SHALL BE RESPONSIBLE FOR CORRECTION OF ANY ERROR.

ALL DIMENSIONS AND CONDITIONS SHALL BE CHECKED AND VERIFIED ON THE JOB BY EACH SUBCONTRACTOR BEFORE HE BEGINS HIS WORK. ANY ERRORS, OMISSIONS OR DISCREPANCIES SHALL BE BROUGHT TO THE ATTENTION OF THE OWNER OR CONTRACTOR BEFORE CONSTRUCTION BEGINS. COMMENCEMENT OF WORK BY THE CONTRACTOR AND/OR ANY SUBCONTRACTOR SHALL INDICATE A KNOWLEDGE AND ACCEPTANCE OF ALL CONDITIONS DESCRIBED IN THESE CONSTRUCTION DOCUMENTS, OR EXISTING ON SITE, WHICH COULD AFFECT THEIR WORK.

DIMENSION CONTROL HAS BEEN TAKEN FROM READILY OBSERVABLE EXISTING CONDITIONS AND FIELD MEASUREMENTS. ADJUSTMENTS MAY HAVE TO BE EMPLOYED SHOULD AS-BUILT CONDITIONS VARY FROM ORIGINAL DOCUMENTS.

CONTROL OF APPROVAL

CONTRACTOR SHALL INCLUDE AND IMPLEMENT IN THE WORK ALL PERTINENT REQUIREMENTS FOR THIS PROJECT AS SET FORTH IN THE CONDITIONS OF APPROVAL BY THE CITY AGENCIES. A COPY OF THESE CONDITIONS IS AVAILABLE FROM THE OWNER AND ARCHITECT.

CONTINUING OPERATIONS

WHEN IT IS NECESSARY THAT THE OWNER CONTINUE PRESENT OCCUPANCY DURING THE RENOVATION WORK, THE CONTRACTOR SHALL, AFTER CONSULTING WITH THE OWNER, SCHEDULE THE WORK SO AS NOT TO INTERFERE WITH NORMAL HOUSEHOLD OPERATIONS.

WORK SEQUENCE

IN THE EVENT THAT SPECIAL SEQUENCING OF THE WORK IS REQUIRED BY THE OWNER, THE CONTRACTOR SHALL ARRANGE A CONFERENCE BEFORE ANY SUCH WORK IS BEGUN

MOISTURE PROTECTION

IT IS THE INTENT OF THESE DOCUMENTS TO PROVIDE DETAILS FOR CONSTRUCTION WHICH WILL TO THE BEST OF THE ARCHITECT'S KNOWLEDGE, THE CONSTRUCTION ASSEMBLIES RESULT IN A MOISTURE RESISTANT BUILDING ENVELOPE. IT IS THE RESPONSIBILITY OF THE REPRESENTED AND DETAILED IN THESE DOCUMENTS CONFORM TO THE STATE OF CALIFORNIA CONTRACTOR TO NOTIFY THE ARCHITECT OF ANY EXCEPTION HE MAY TAKE TO ANY OF THE ENERGY CONSERVATION REGULATIONS AS MANDATED IN THE TITLE 24 ENERGY COMPLIANCE DETAILS OR METHODS DESCRIBED HEREIN. IF THE CONTRACTOR IS AWARE OF ALTERNATE STANDARDS. WHILE THESE REGULATIONS RESULT IN A VERY TIGHT AIR AND MOISTURE MATERIALS OR METHODS THAT WILL BETTER SATISFY THIS INTENT, HE SHALL SO NOTIFY THE EXTERIOR ENVELOPE, THE SELECTION OF SPECIFIC VAPOUR RETARDERS AND AIR BARRIERS, ARCHITECT, IN WRITING, ALLOWING THE ARCHITECT TO MODIFY HIS DOCUMENTS ACCORDINGLY. AND PREVAILING CLIMATIC CONDITIONS MAY AFFECT OR IMPACT OTHER MEMBERS WITHIN THE FLOOR, WALL, CEILING AND ROOF ASSEMBLIES. THE CONTRACTOR, SUBCONTRACTOR AND SHOULD ANY SPECIAL SITUATION OCCUR DURING CONSTRUCTION, INCLUDING VARIOUS MATERIAL SUPPLIERS SHALL HAVE FULL RESPONSIBILITY IN SELECTION OF THESE MATERIALS CLIMATIC CONDITIONS, WHICH NECESSITATE APPLICATIONS OR METHODS TO INSURE THE AND SHALL EACH MAKE KNOWN TO ALL OTHERS ANY AND ALL EFFECTS OR IMPACTS THAT PROTECTION OF MATERIALS AND ASSEMBLIES, THE CONTRACTOR OR SUBCONTRACTOR (S) MAY OCCUR AND AFFECT THE SELECTION OF OTHER ASSEMBLY MATERIALS OR PROCEDURES SHALL SO NOTICE AND IMPLEMENT ANY OR ALL PROTECTIVE MEASURES. NECESSARY FOR PROPER CONSTRUCTION. THE CONTRACTOR SHALL FURTHER BE RESPONSIBLE FOR TESTING OF THESE ASSEMBLIES SHOULD IT BE REQUIRED OR DETERMINED ALL DOWNSPOUTS, SCUPPERS AND LEADERHEADS SHALL BE SIZED TO ACCOMMODATE TO STUDY THE PERFORMANCE OF THESE ASSEMBLIES AGAINST MOISTURE INFILTRATION, TRIBUTARY ROOF AREAS SERVED. IT SHALL BE THE RESPONSIBILITY OF THE INSTALLER TO MOISTURE ENTRAPMENT AND/OR ADVERSE AFFECTS ON THE DURABILITY, AESTHETICS, PROVIDE ANY AND ALL DESIGN, CALCULATIONS AND DATA THAT MAY BE REQUIRED IN ENERGY USE EFFICIENCY AND REASONABLE COMFORT WITHIN THE BUILDING(S) AS MAY BE

SUPPORT OF THIS SYSTEM. ALL RESPONSIBILITY FOR THE SYSTEM AND ITS FUNCTION SHALL CAUSED BY MOISTURE INFILTRATION AND ENTRAPMENT. BE BORNE BY THE SYSTEM DESIGNER AND/OR INSTALLER.

DEMOLITION NOTES

THESE ARCHITECTURAL DRAWINGS SHALL BE USED TO DETERMINE THE LIMITS OF NEW CONSTRUCTION AND EXISTING CONSTRUCTION TO REMAIN. THESE DRAWINGS ARE NOT INTENDED TO SHOW ALL EXISTING CONSTRUCTION. THE GENERAL CONTRACTOR SHALL BE RESPONSIBLE FOR DETERMINING THE EXTENT AND SCOPE OF EXISTING CONSTRUCTION TO BE REMOVED.

THE GENERAL CONTRACTOR SHALL PERFORM WORK IN OR ON THE EXISTING BUILDING. THIS CONSISTS PRINCIPALLY OF, BUT NOT NECESSARILY LIMITED TO, THE CUTTING AND REPAIR OR REPLACEMENT OF PORTIONS OF THE EXISTING BUILDING AS SHOWN, OR AS NECESSARY FOR INSTALLATION OR ERECTION OF NEW WORK, OR REMODELLING CALLED FOR ON DRAWINGS OR IN SPECIFICATIONS.

THE GENERAL CONTRACTOR SHALL MAKE ALL NECESSARY ARRANGEMENTS WITH OWNER FOR ENTRY AND EXECUTION OF WORK IN OR ON THE EXISTING BUILDING.

THE GENERAL CONTRACTOR SHALL ACCEPT THE SITE AS THEY FIND IT AND BE FAMILIAR WITH ITS CHARACTER AND THE TYPE OF WORK TO BE REMOVED. HE SHALL ENTIRELY DEMOLISH ON THE SITE ANY STRUCTURE OR PORTION THEREOF INDICATED TO BE REMOVED, AND SHALL NOT REMOVE ANY STRUCTURE FROM THE SITE, EITHER AS A WHOLE OR SUBSTANTIALLY AS A WHOLE WHERE NOT INDICATED. THE OWNER ASSUMES NO RESPONSIBILITY FOR THE CONDITION OF THE PORTIONS OF BUILDING TO BE REMOVED AND/OR DEMOLISHED.

THE GENERAL CONTRACTOR SHALL SEE THAT ALL SERVICES, TO THE AREAS TO BE DEMOLISHED, SUCH AS WATER, GAS, STEAM, ELECTRICITY AND TELEPHONE LINES, ARE DISCONNECTED AT THE ENTRIES AS APPLICABLE, ALL IN ACCORDANCE WITH THE RESTRICTIVE RULES AND REGULATIONS GOVERNING THE UTILITIES INVOLVED.

THE CONTRACTOR SHALL BE RESPONSIBLE FOR THE LOCATION OF ALL EXISTING UTILITIES AND COORDINATE THEIR REMOVAL TO AVOID ANY INTERRUPTION OF SERVICE TO ADJACENT PROPERTIES.

THE GENERAL CONTRACTOR SHALL PROVIDE AND INSTALL SHORING REQUIRED IN CONNECTION WITH THE DEMOLITION OPERATIONS, AND THE SUPPORTS SHALL HOLD THE EXISTING WORK THAT IS TO REMAIN IN PROPER POSITION UNTIL NEW SUPPORTING MEMBERS. AND INJURIES TO THE PUBLIC.

AFTER WORK HAS BEEN STARTED, IT SHALL BE CARRIED OUT TO COMPLETION, PROMPTLY, EXPEDITIOUSLY, AND IN AN ORDERLY MANNER, USING METHODS COMMONLY EMPLOYED, AND AS PROVIDED UNDER THE CITY OR COUNTY CODE FOR DEMOLITION WORK AS APPLICABLE.


GENERALLY, THE GENERAL CONTRACTOR SHALL DO ANY CUTTING AND REMOVE ANY OR ALL ITEMS, WHETHER SPECIFICALLY MENTIONED OR INDICATED, WHICH OBVIOUSLY WILL INTERFERE WITH OR BECOME INCONGRUOUS TO PROPOSED CONSTRUCTION FINISHES. WHEN ITEM(S) IS/ARE QUESTIONABLE, HE SHALL NOTIFY THE ARCHITECT. THE GENERAL CONTRACTOR SHALL EXERCISE UTMOST CARE TO SEE THAT MINIMUM CUTTING IS DONE.

SALVAGE

ALL ITEMS DEEMED SALVAGEABLE BY THE OWNER WILL EITHER BE INDICATED ON THE DRAWINGS, AND SHALL BE REMOVED PRIOR TO THE START OF DEMOLITION, OR WILL BE DIRECTED BY THE OWNER TO BE STORED BY THE CONTRACTOR AND SHALL REMAIN THE PROPERTY OF THE OWNER. ITEMS TO BE RELOCATED WILL BE INDICATED ON THE DRAWINGS. WITH THE EXCEPTION OF ANY SALVAGEABLE ITEMS, AS DIRECTED BY THE OWNER TO BE RETAINED, ALL REMOVED STRUCTURES AND MATERIALS SHALL BECOME THE PROPERTY OF THE CONTRACTOR. NO DEBRIS OR CONTRACTOR SALVAGEABLE ITEMS SHALL BE STORED OR ACCUMULATED ON THE PREMISES.

SITE PROTECTION

THE GENERAL CONTRACTOR SHALL PROTECT ALL INTERIOR AND EXTERIOR EXISTING CONSTRUCTION THAT IS TO REMAIN, INCLUDING LANDSCAPING ALONG THE PROPERTY LINES, AS WELL AS ON ADJACENT LOTS. ANY DAMAGE OR LOSS RESULTING FROM NEW CONSTRUCTION WORK SHALL BE CORRECTED OR REPLACED BY THE CONTRACTOR AT NO ADDITIONAL COST TO THE OWNER.

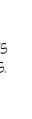

THE GENERAL CONTRACTOR SHALL BE FAMILIAR WITH MUNICIPAL REGULATIONS AND CARRY OUT THE WORK IN COMPLIANCE WITH ALL FEDERAL AND STATE REQUIREMENTS TO REDUCE FIRE HAZARDS AND INJURIES TO THE PUBLIC.

THE GENERAL CONTRACTOR SHALL PROVIDE AND INSTALL A TEMPORARY CONSTRUCTION FENCE, MEETING CITY STANDARDS, DURING CONSTRUCTION AND TAKE ALL MEASURES TO PROTECT THE PUBLIC FROM INJURY CAUSED ON SITE.

GLAZING REQUIREMENTS

ALL WINDOWS AND DOORS MUST MEET THE AIR AND INFILTRATION STANDARDS OF THE CURRENT ANSI AND SHALL BE CERTIFIED AND LABELLED.

HEATING DESIGN TEMPERATURE

MINIMUM INSIDE WINTER DESIGN TEMPERATURE IS 70 DEGREES

VAPOUR RETARDER AND AIR BARRIER

HAZARDOUS MATERIALS

THE ARCHITECT AND THE ARCHITECT'S CONSULTANTS ARE NOT "OWNER OR OPERATOR" AS DEFINED UNDER NESHAP, SECTION 112 OF THE CLEAN AIR ACT AND THEREFORE SHALL HAVE NO RESPONSIBILITY FOR THE DISCOVERY, PRESENCE, HANDLING, REMOVAL TRANSPORTATION, STORAGE OR DISPOSAL OF OR EXPOSURE OF PERSONS TO HAZARDOUS MATERIAL IN ANY FORM AT THE PROJECT PREMISES, INCLUDING BUT NOT LIMITED TO ASBESTOS, ASBESTOS PRODUCTS, POLYCHLORINATED BIPHENYL (PCB) OR OTHER TOXIC SUBSTANCES.

FLASHING CONDITIONS

FLASHING CONDITIONS SHOWN IN THESE PLANS WILL REQUIRE REMOVAL OF (E) SIDING ON ADJACENT SURFACES. CONTRACTOR TO COORDINATE W/ ARCHITECT FOR FLASHING INSTALLATION FOR AREAS WHERE SIDING IS NOT SCHEDULED FOR REPLACEMENT.

SYMBOLS

or NO. ABBREVIATIONS A.B. ABV A.C. PAVING A/C A.D. ADH. ADJ. AFF. ALT. ALUM. ANG. BA. BD. BDRM. BLDG. BLKG. BM. BOT. CAB. CEM. CLG. CLO. CLR. COL. CONC. CONST. CONT. CTR. DBL. D.F. DIA. DIAG. DIM. DIN. RM. DN. D.S. DTL. DWG. (E) or EXIST EIFS ELEC. EQ. EQPT. E.W. EXT. F.A.U. F.A.R. F.D. FDN. F.E.C. FIN. FLASH'G. FLR. F.O.C. F.O.M. F.O.S. FRM. FT. FTG. GA. GAR. G.D. G.F.I. G.I. GLULAM. GYP. BD. H.B. H.C. HDWD. HORIZ. HR. ΗT HVAC I.I.C. IN. INCL. INSUL. INT. JAN. KIT. LAM. LAUND. LAV. LB. or # LIN. LIV. RM.

REVIATION LIST

ANGLE AND CENTER LINE DIAMETER OR ROUND PFNNY NUMBER SQUARE FOOT ANCHOR BOLT ABOVE ASPHALT CONCRETE PAVING AIR CONDITIONING AREA DRAIN ADHESIVE ADJACENT ABOVE FINISH FLOOR ALTERNATE ALUMINUM ANGLE BATHROOM BOARD BEDROOM BUILDING BLOCKING BEAM BOTTOM CABINET CEMENT CEILING CLOSET CLEAR COLUMN CONCRETE CONSTRUCTION CONTINUOUS CENTER DRYER DOUBLE DOUGLAS FIR OR DRINKING FOUNTAIN DIAMETER DIAGONAL DIMENSION DINING ROOM DOWN DOWNSPOUT DETAIL DRAWING EXISTING EACH EXTERIOR INSULATION FINISH SYSTEM T.O. ELECTRICAL EQUAL EQUIPMENT EACH WAY EXTERIOR FORCED AIR UNIT FLOOR AREA RATIO FLOOR DRAIN FOUNDATION FIRE EXTINGUISHER CABINET FINISH FLASHING FLOOR FACE OF CONCRETE FACE OF MASONRY FACE OF STUD FRAME FEET FOOTING GUAGE GARAGE GARBAGE DISPOSAL GROUND FAULT INTERRUPTER GALVANIZED IRON GLULAM BEAM GYPSUM BOARD HOSE BIB HOLLOW CORE HARDWOOD HORIZONTAL HOUR HEIGHT

HEATING VENTILATION & AIR CONDITIONING IMPACT INSULATION CLASS INCH

NFPA

NRCA

UBC

UFC

WIC

ADA

ADAAG

INCLUDE INSULATION INTERIOR

JANITOR KITCHEN

LAMINATE LAUNDRY LAVATORY POUND LINEN LIVING ROOM LIGHTWEIGHT

LT. WT.

MAT. MAX. MECH. MEMB. MFR. MIN. MSTR. BDRM. MTL. N.I.C. N.T.S. 0.C. 0.Н. OPNG. OPP PAN. PDR. PL. P. LAM. PLAST. PLYWD. PREFAB. P.T. P.T.D.F. P.T. SLAB RAG RFG. REG. REQ'D. RM. RDWD. REF. S.C. SCH. S.G.D. SHT. SIM. SPEC. S.T.C. STL. STOR. STRUCT. SUBFLR. SQ. SQ. FT. TOIL. T.P.H. TYP. U.O.N. VERT. V.G.D.F. W/ W WD. WIN. W.P. W.R. GYP. BD. WT. W.W.F. YD. AGENCIES ACI. AIA AISC AITG ANSI ASTM CAC CBC CEC CMC CPC CSI ICBO

MINIMUM MASTER BEDROOM METAL NEW NOT IN CONTRACT NOT TO SCALE OVER ON CENTER (S) OPPOSITE HAND OPENING OPPOSITE PANTRY POWDER ROOM PLATE PLASTIC LAMINATE PLASTER PLYWOOD PREFABRICATED PRESSURE-TREATED PRESSURE TREATED DOUGLAS FIR POST TENSION SLAB RETURN AIR GRILLE REFRIGERATOR REGISTER REQUIRED ROOM REDWOOD REFER SOLID CORE SCHEDULE SLIDING GLASS DOOR SHEET SIMILAR SPECIFICATION SOUND TRANSMISSION CLASS STEEL STORAGE STRUCTURE OR STRUCTURAL SUB-FLOOR SQUARE SQUARE FOOT TELEPHONE TOP OF TOILET TOILET PAPER HOLDER TYPICAL UNLESS OTHERWISE NOTED VERTICAL VERTICAL GRAIN DOUGLAS FIR WITH WASHER WOOD WINDOW WATERPROOFING W.R. GYPSUM BOARD WELDED WIRE FABRIC YARD AMERICAN CONCRETE INSTITUTE THE AMERICAN INSTITUTE OF ARCHITECTS AMERICAN INSTITUTE OF STEEL CONSTRUCTION AMERICAN INSTITUTE OF TIMBER CONSTRUCTION AMERICAN NATIONAL STANDARDS INSTITUTE AMERICAN SOCIETY FOR TESTING & MATERIALS CALIFORNIA ADMINISTRATIVE CODE CALIFORNIA BUILDING CODE CALIFORNIA ELECTRICAL CODE CALIFORNIA MECHANICAL CODE CALIFORNIA PLUMBING CODE CONSTRUCTION SPECIFICATION INSTITUTE INTERNATIONAL CONFERENCE OF BUILDING OFFICIALS NATIONAL FIRE PROTECTION ASSOCIATION NATIONAL ROOFING CONTRACTORS ASSOCIATION SMACNA SHEET METAL & AIR CONDITIONING CONTRACTORS NATIONAL ASSOCIATION UNIFORM BUILDING CODE UNIFORM FIRE CODE UNDERWRITERS LABORATORIES, INC. WOODWORK INSTITUTE OF CALIFORNIA **ABBREVIATED CODES & STANDARDS** AMERICANS WITH DISABILITIES ACT AMERICANS WITH DISABILITIES ACT


MATERIAL

MAXIMUM

MECHANICAL

MANUFACTURER

MEMBRANE

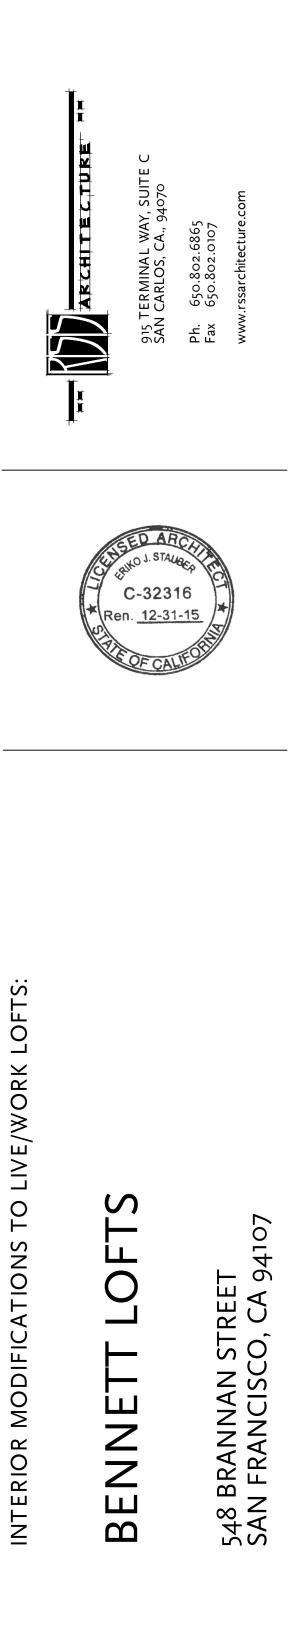

REVISIONS

GENERAL NOTES


JOB: 1303

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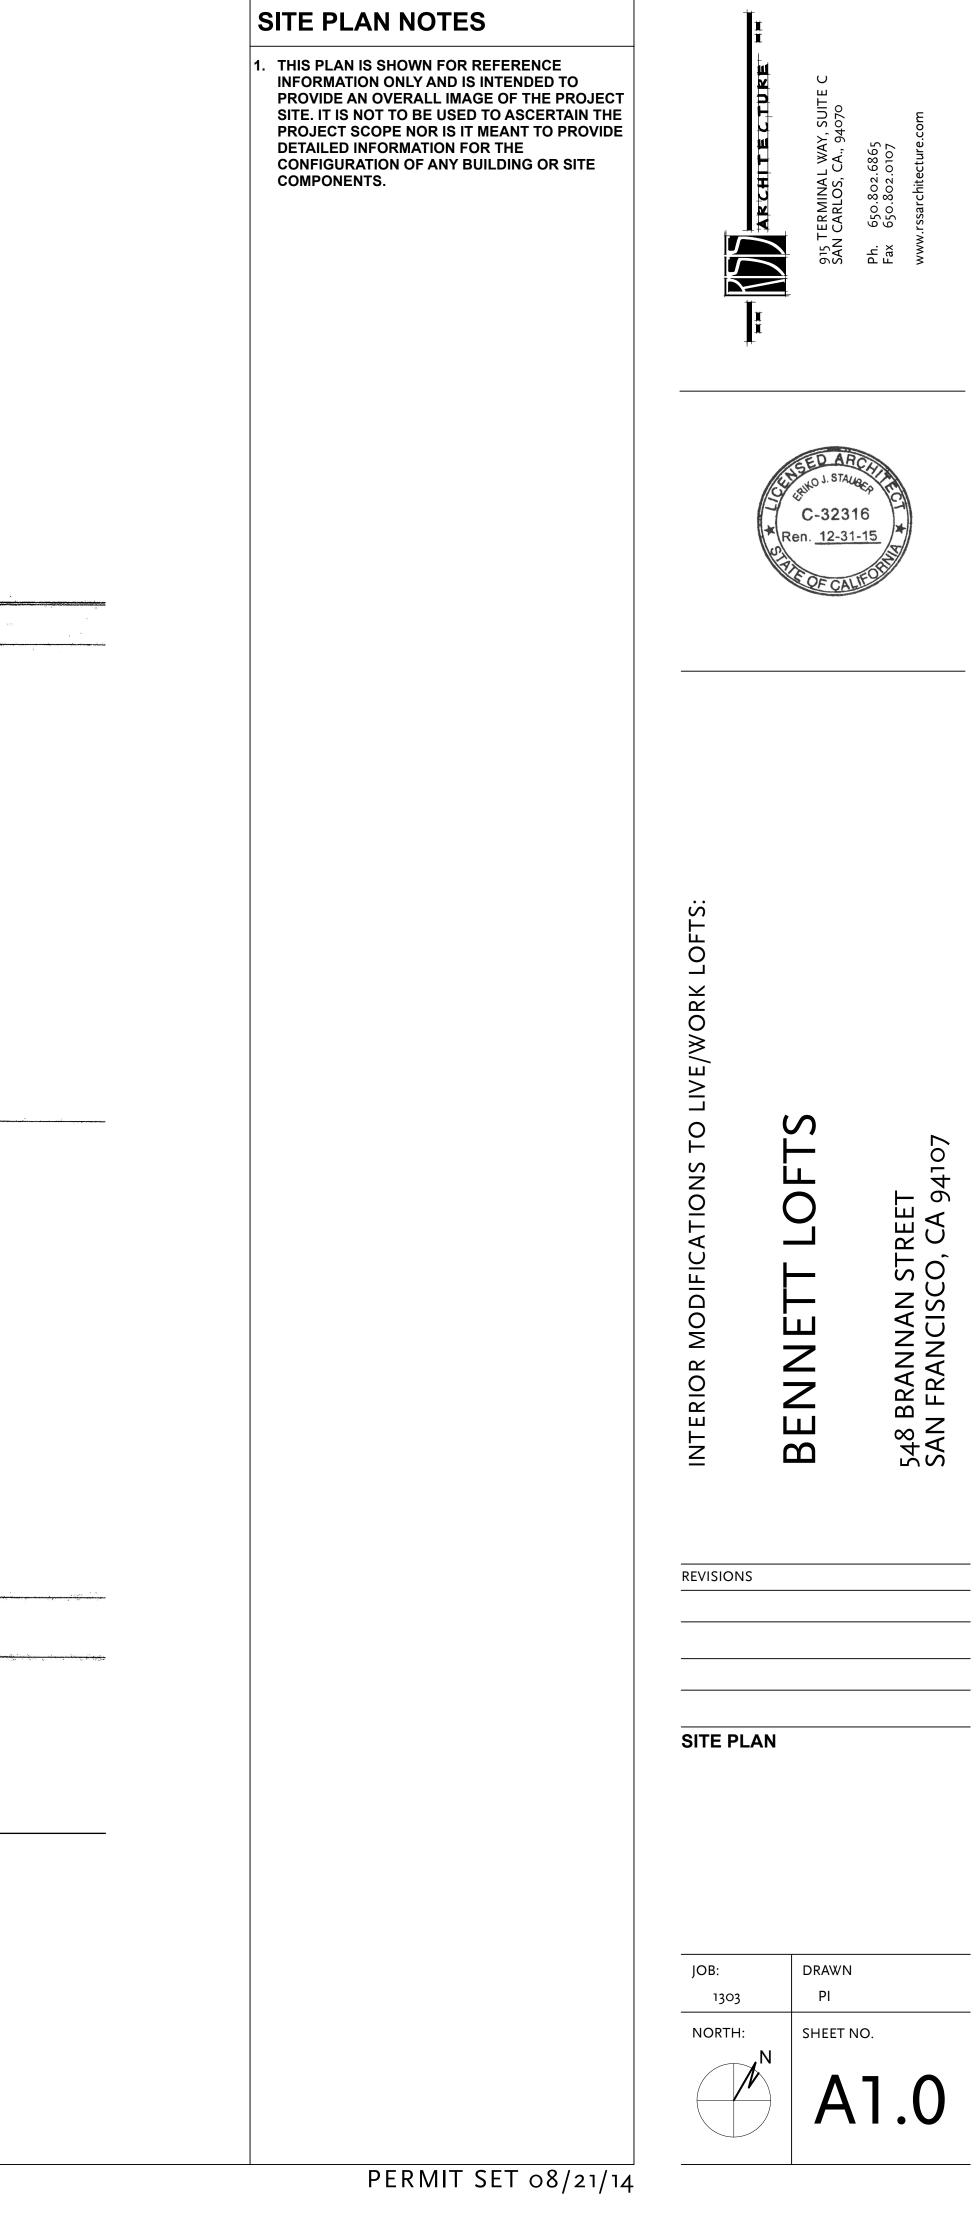
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PERMIT SET 08/21/14


ACCESSIBILITY GUIDELINES



FREELON STREET

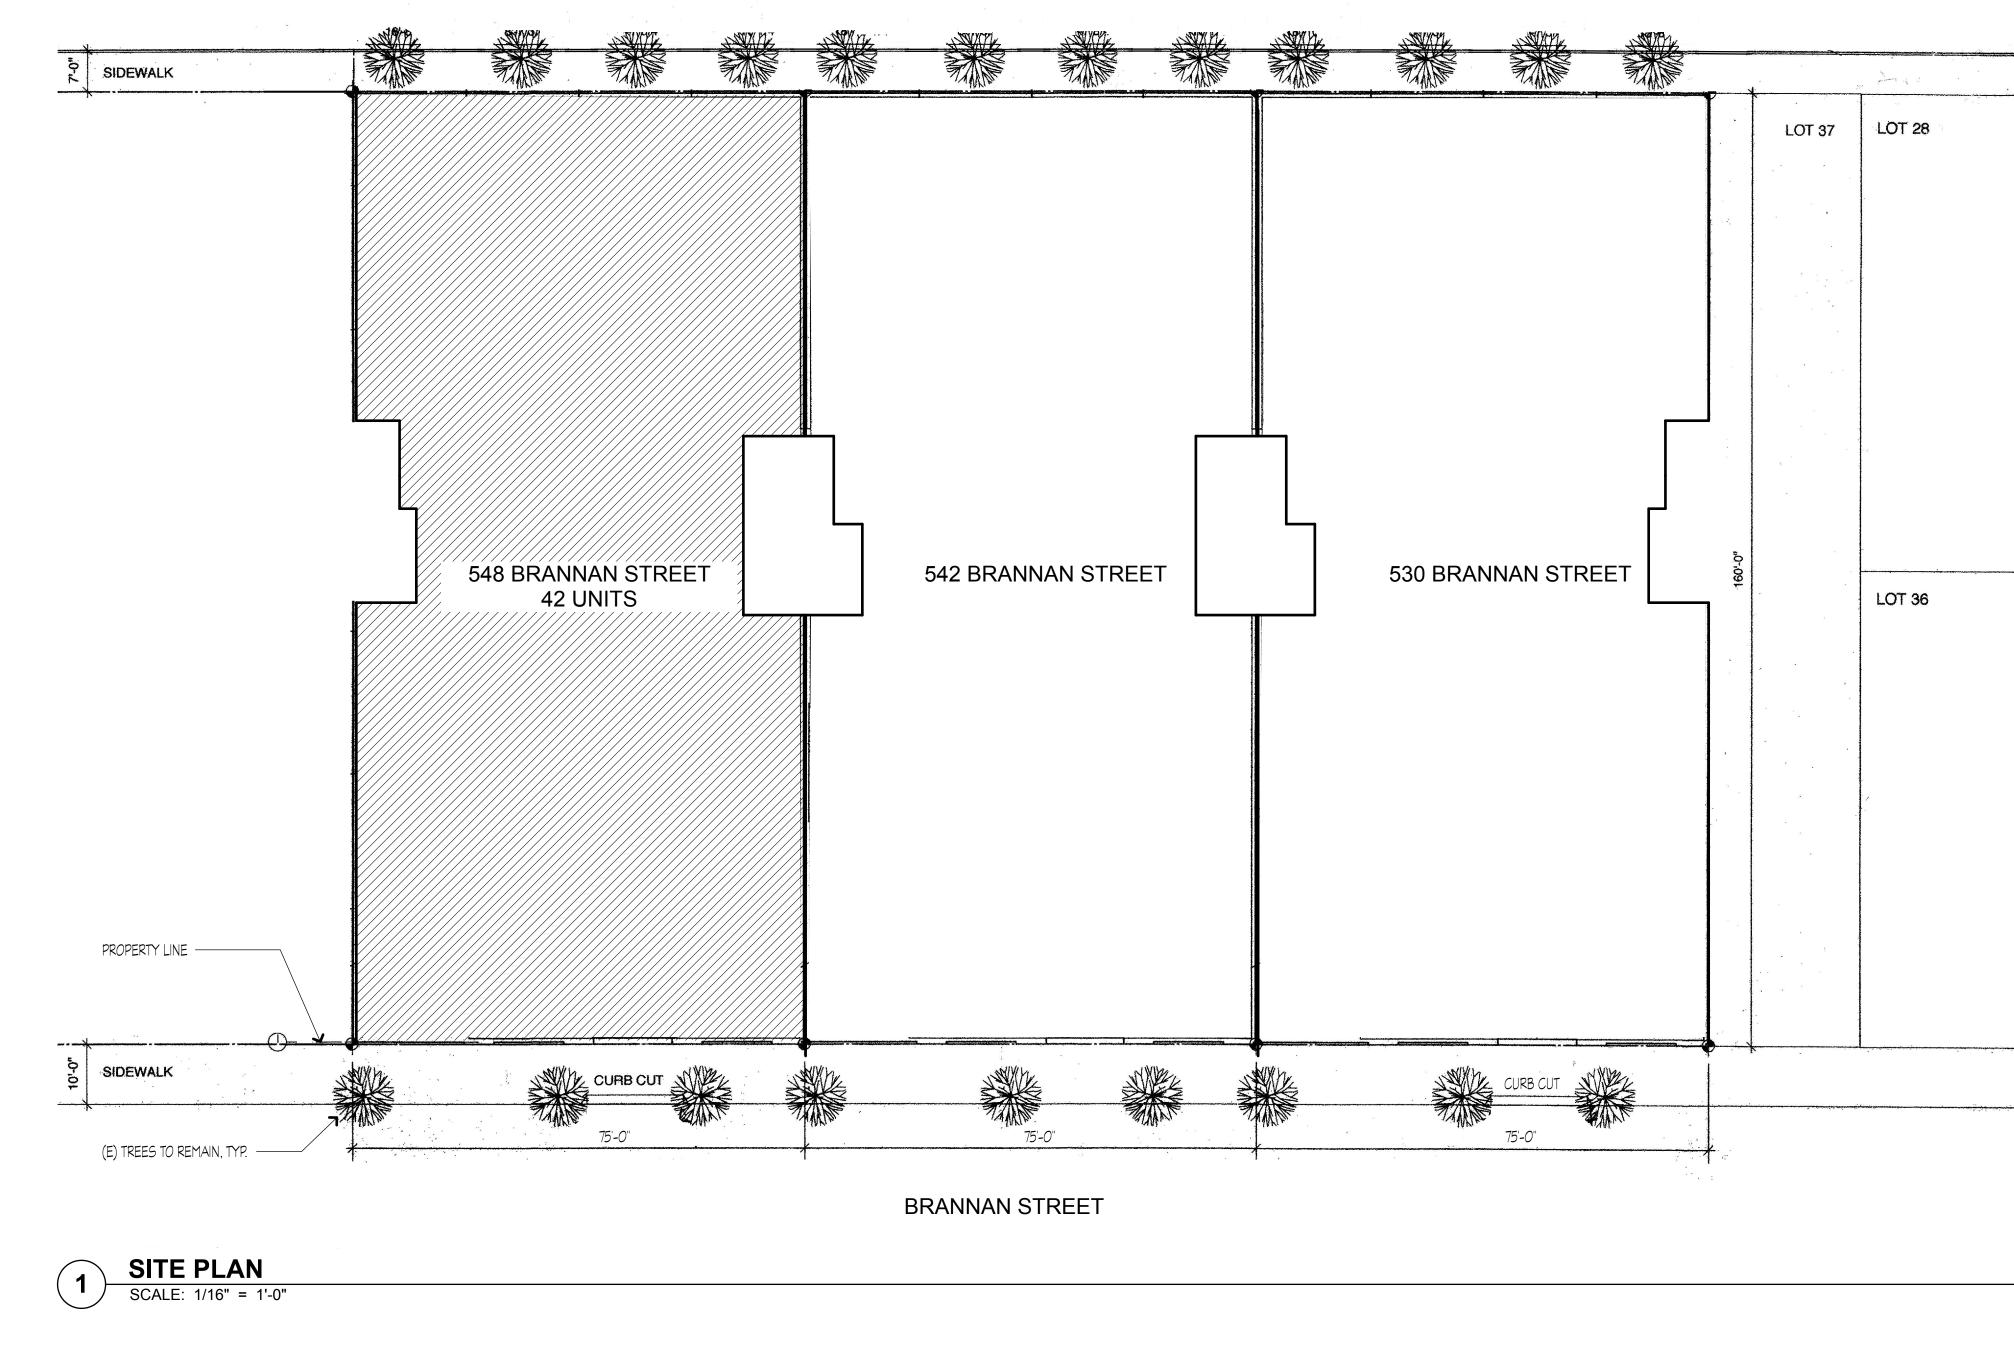


EXISTING FIRST FLOOR BUILDING PLAN SCALE: 1/8" = 1'-0"

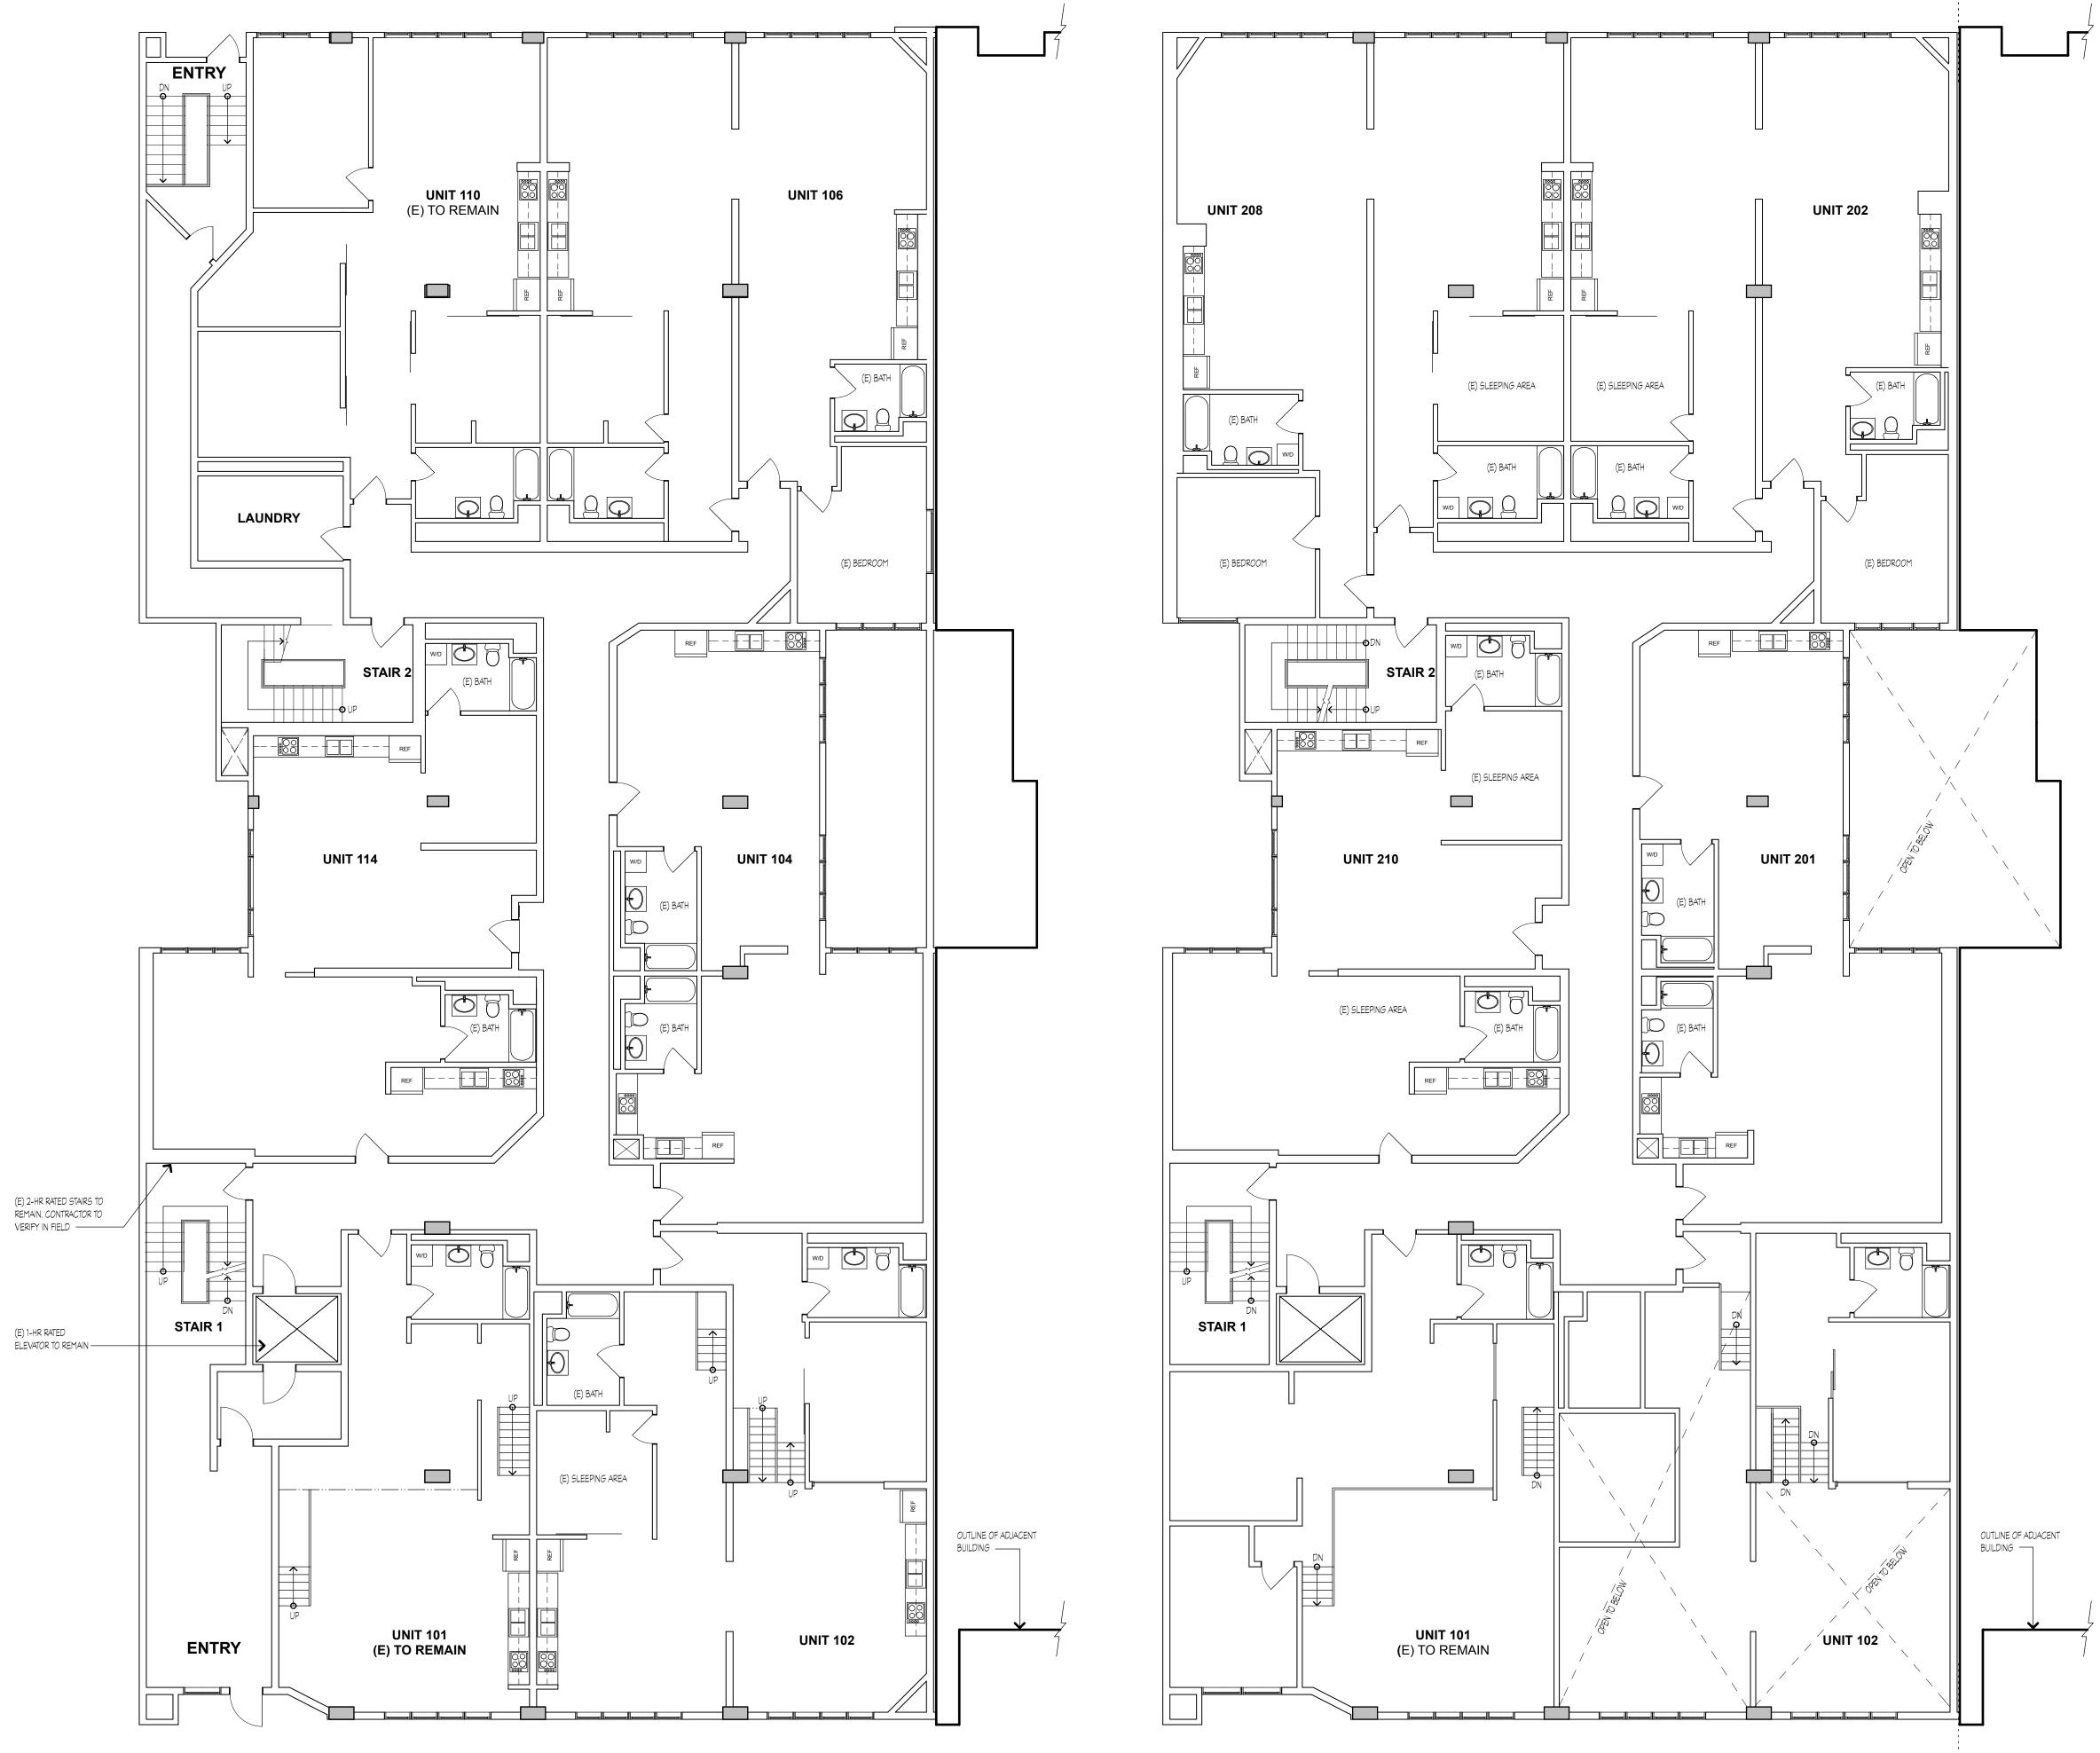


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LOFT LIVE/WORK ЦО INTERIOR MODIFICATIONS

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REVISIONS

EXISTING BUILDING PLAN

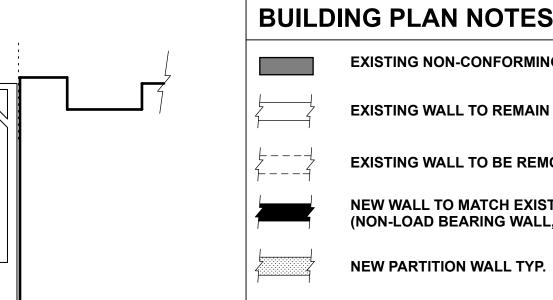
JOB: 1303 DRAWN ΡI

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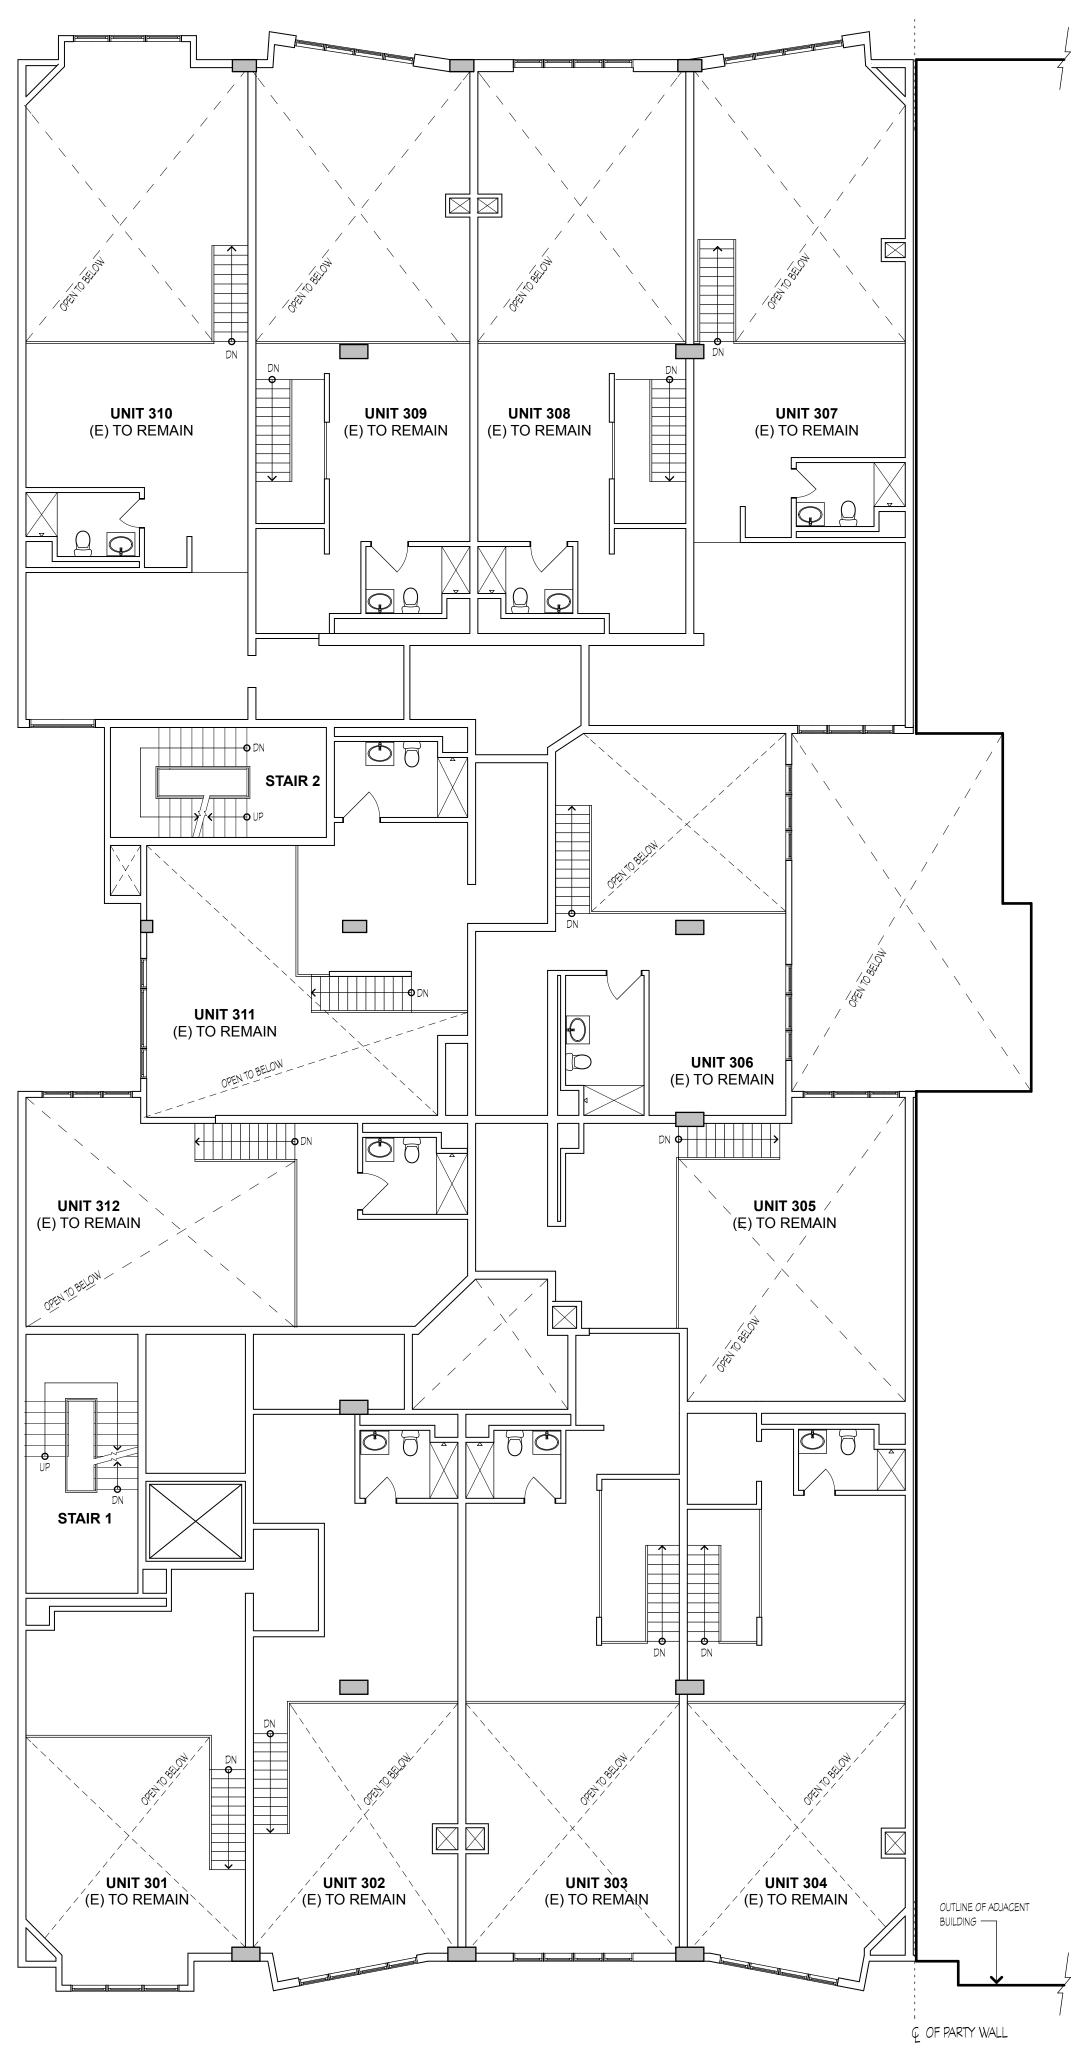
EXISTING THIRD FLOOR BUILDING PLAN SCALE: 1/8" = 1'-0"

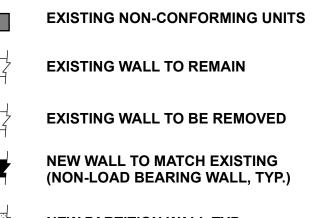3



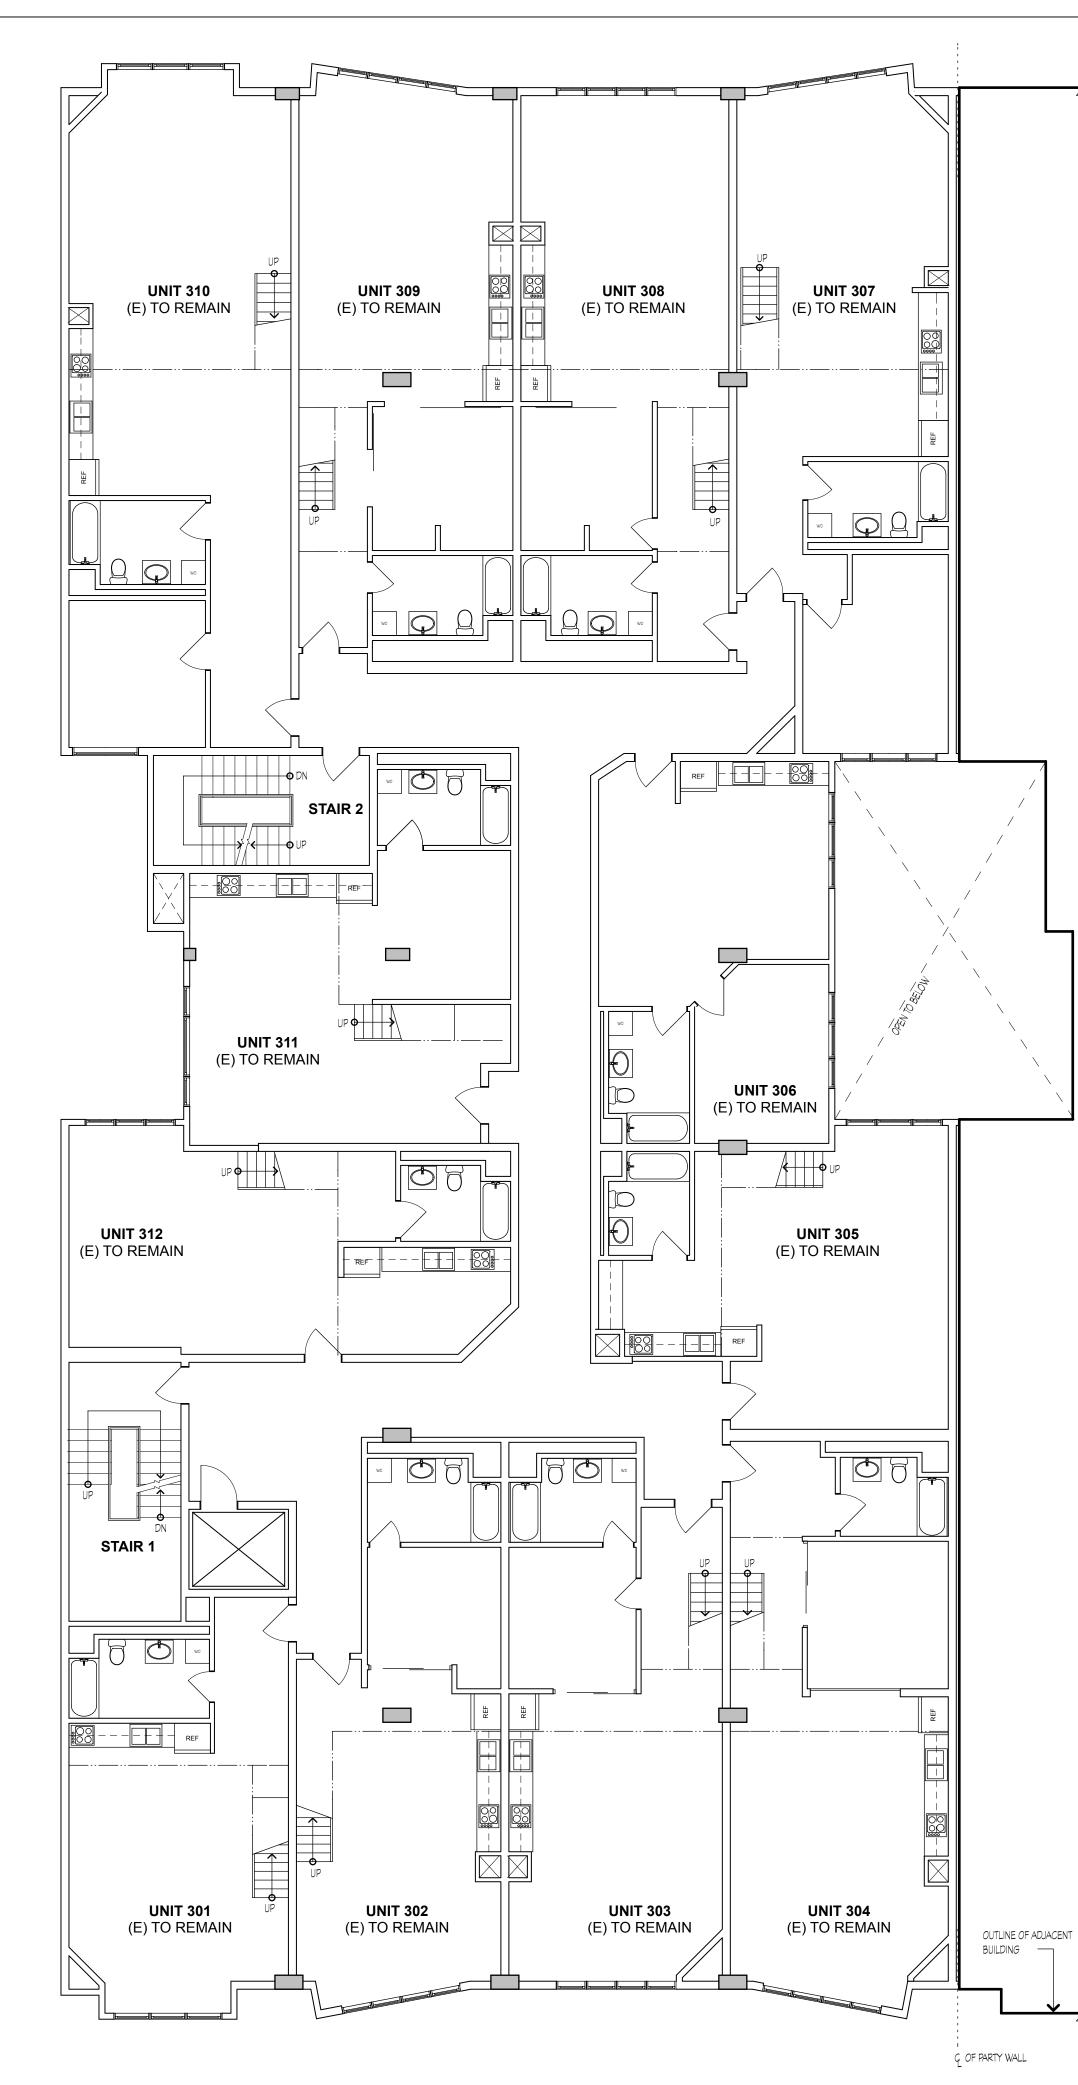


EXISTING THIRD FLOOR MEZZANINE BUILDING PLAN SCALE: 1/8" = 1'-0"



NOTES


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SEE SHEET A2.0 FOR BUILDING PLAN LEGEND AND NOTES NOT SHOWN.

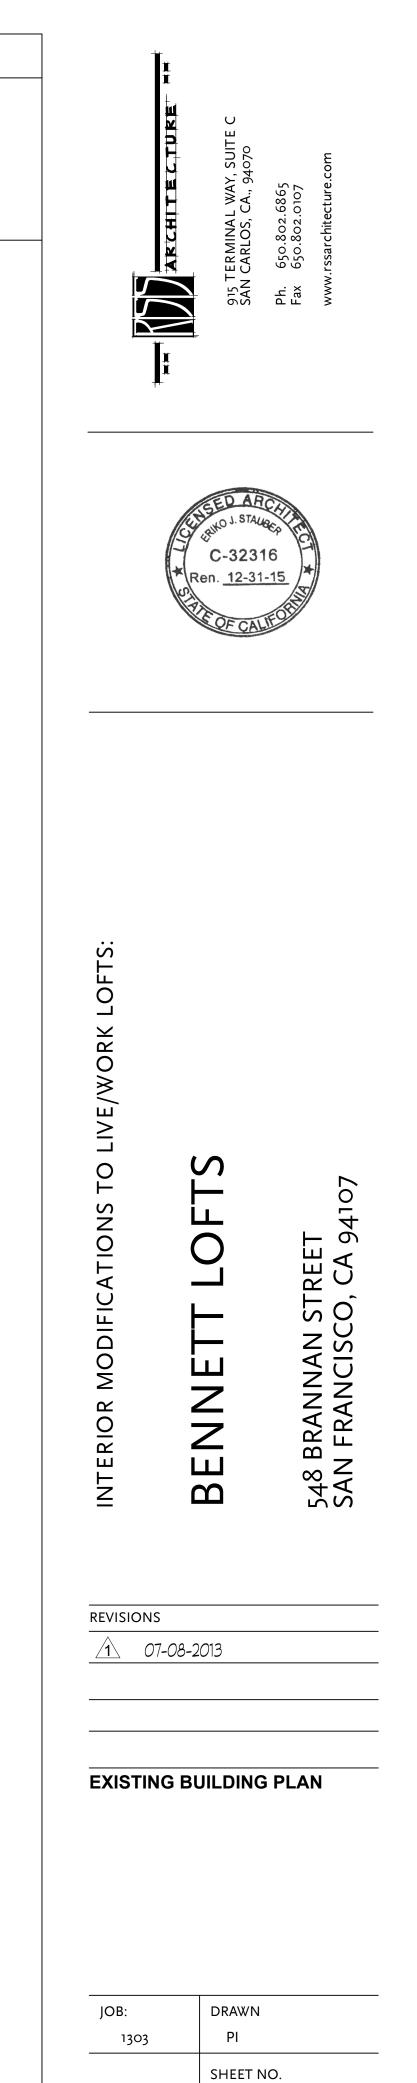


EXISTING FOURTH FLOOR BUILDING PLAN SCALE: 1/8" = 1'-0"

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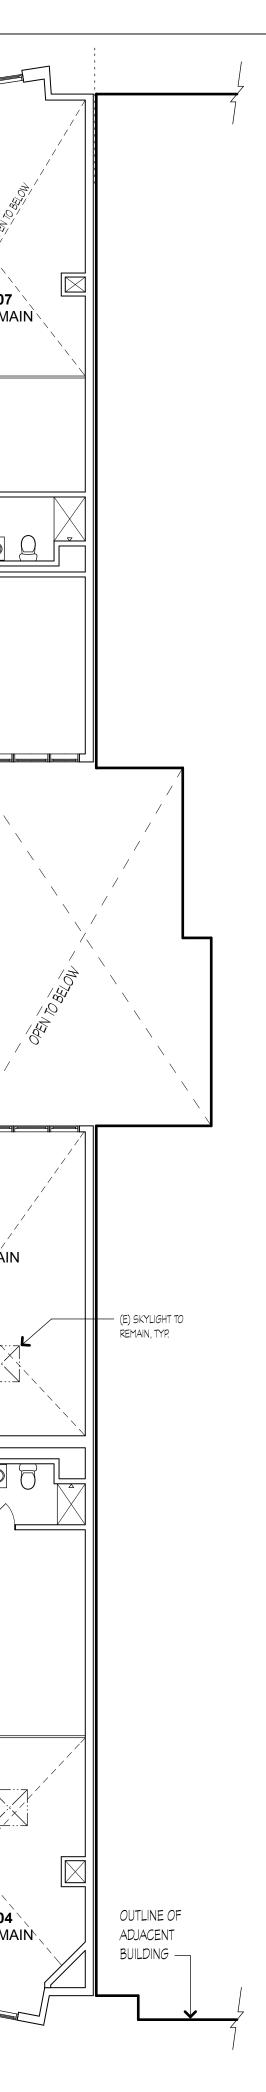


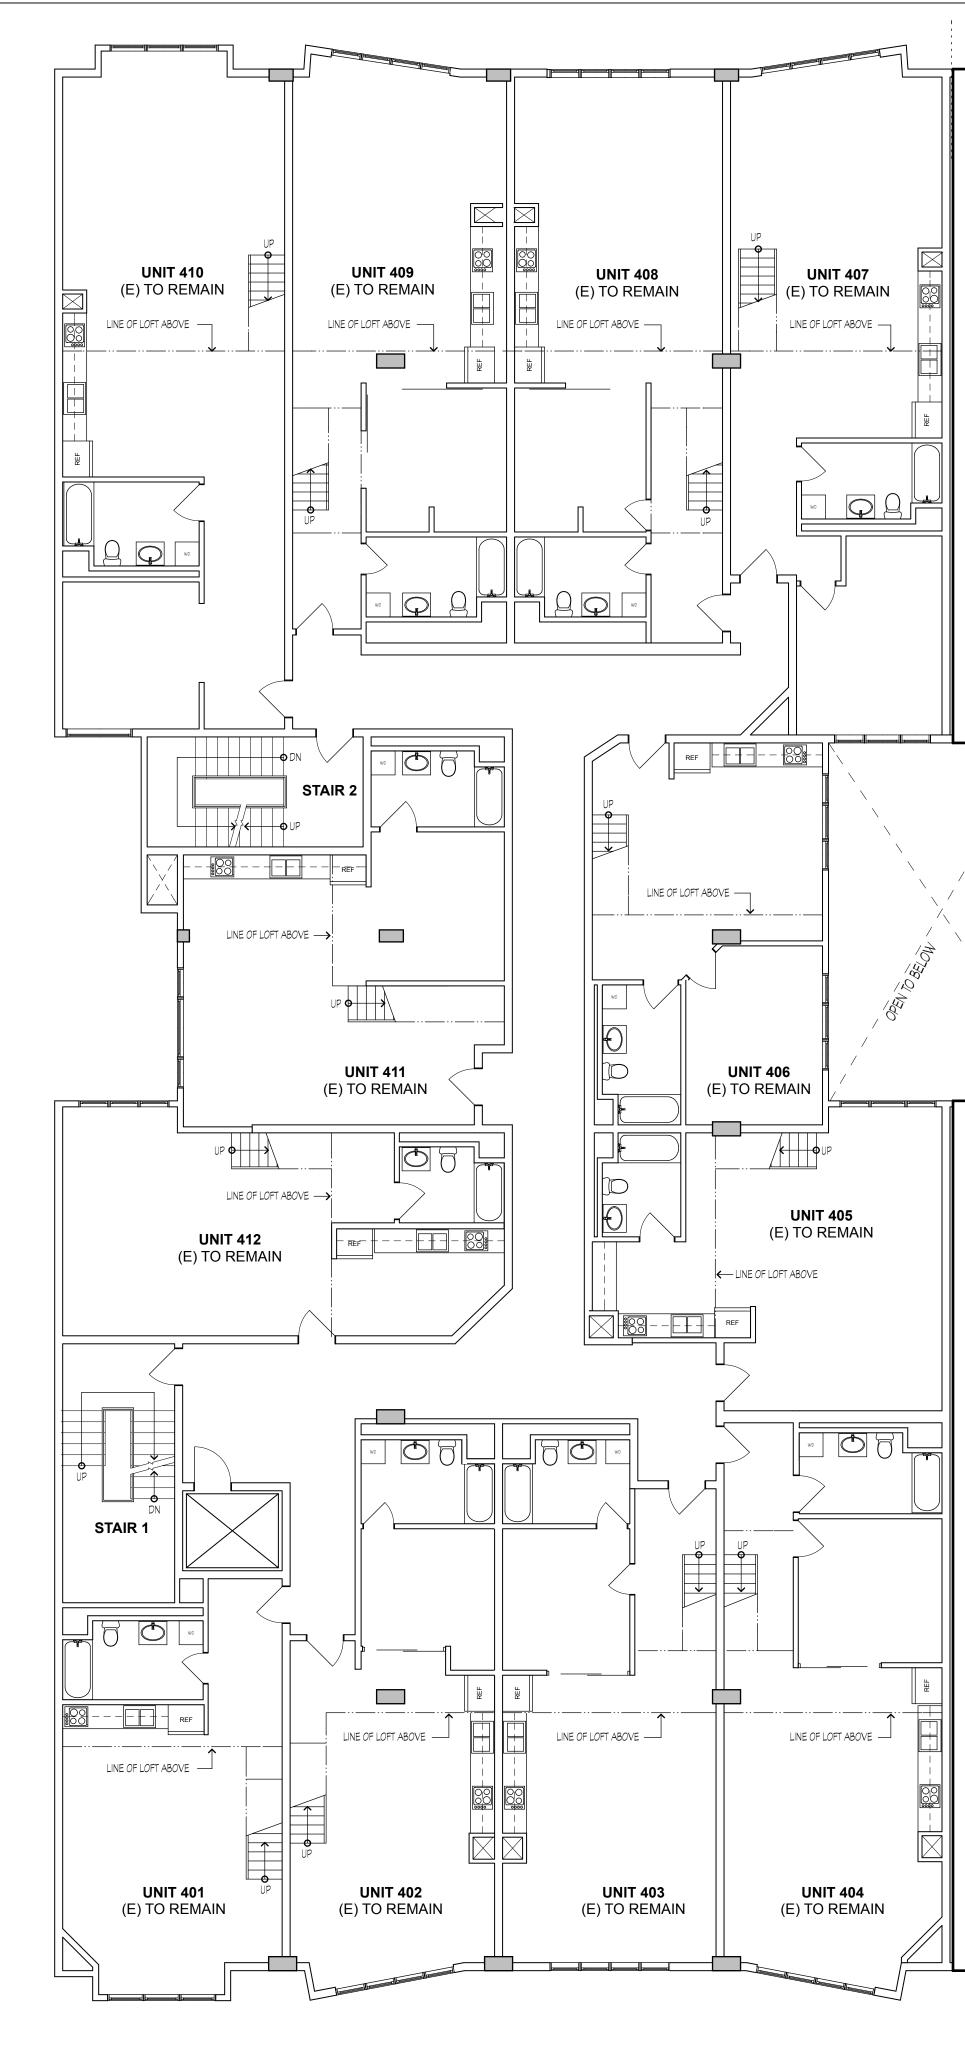

EXISTING FOURTH FLOOR MEZZANINE BUILDING PLAN SCALE: 1/8" = 1'-0"

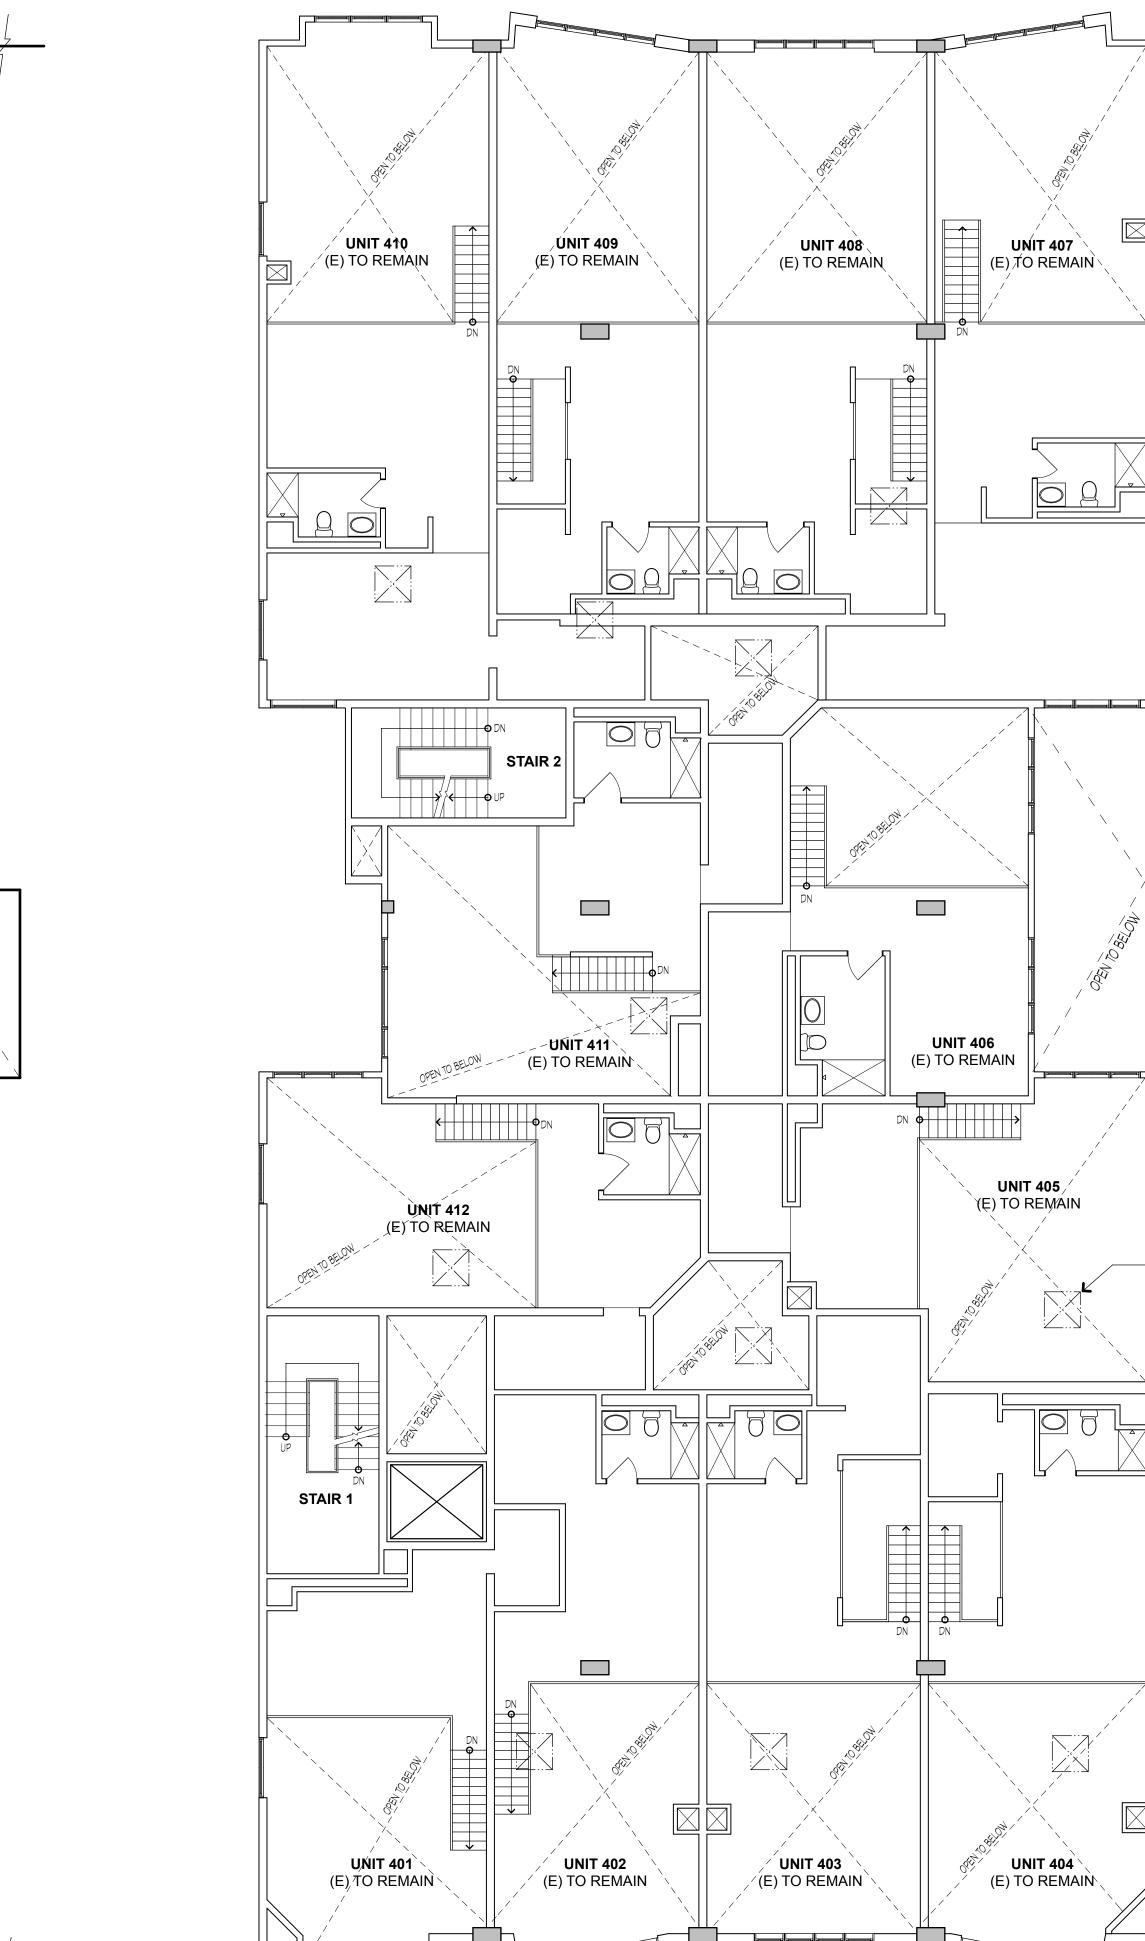


OUTLINE OF ADJACENT BUILDING



NOTES

SEE SHEET A2.0 FOR BUILDING PLAN LEGEND AND NOTES NOT SHOWN.

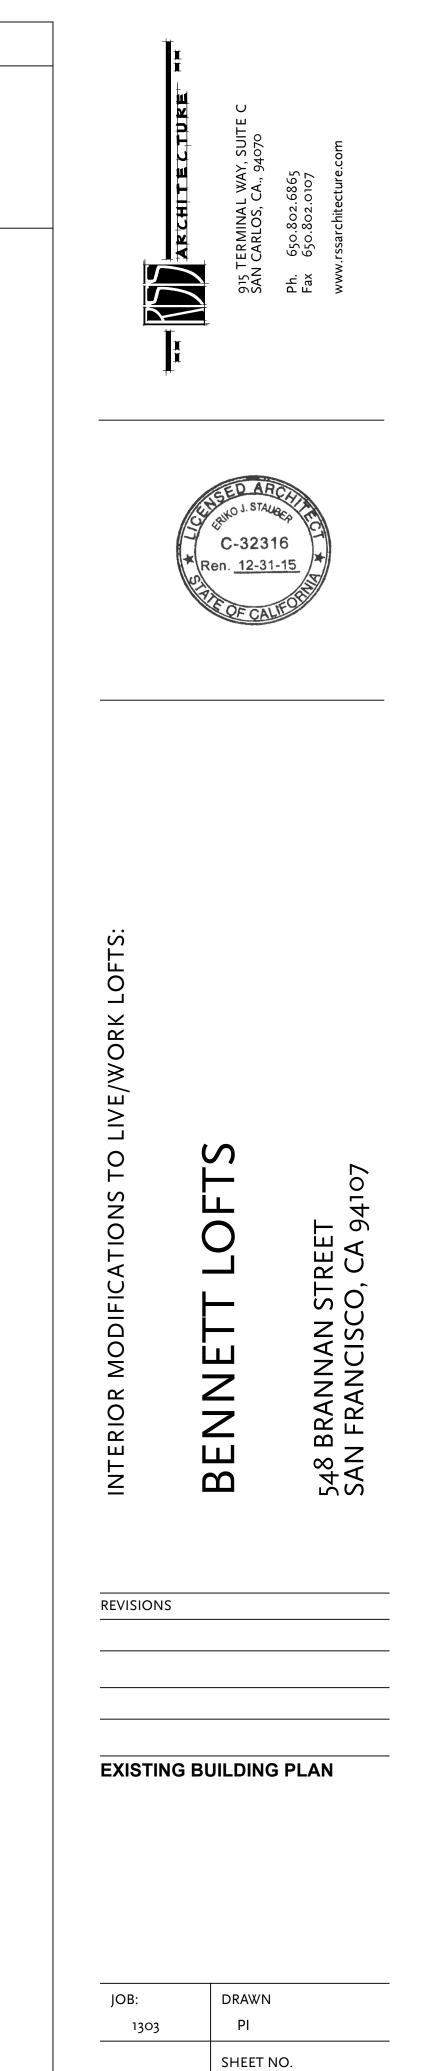

TYPICAL FIRST FLOOR BUILDING PLAN SCALE: 1/8" = 1'-0"

1




TYPICAL SECOND FLOOR BUILDING PLAN SCALE: 1/8" = 1'-0" 2

€ OF PARTY WALL




SEE SHEET A2.0 FOR BUILDING PLAN LEGEND AND NOTES NOT SHOWN.

UNIT DATA 42 UNITS						
UNIT #	NOTES	EXISTING SQ FT	PROPOSED SQ FT	UNIT TYPE		
101	LIVE/WORK	-	-	1 BDRM		
102	DWELLING	1,910	1,190	1 BDRM		
103	DWELLING	-	660	STUDIO		
104	LIVE/WORK	1,235	575	STUDIO		
106	DWELLING	1,670	880	1 BDRM		
108	LIVE/WORK	-	790	1 BDRM		
110	LIVE/WORK	-	-	2 BDRM		
114	LIVE/WORK	1,245	655	STUDIO		
116	DWELLING	-	590	STUDIO		
200	DWELLING	-	650	STUDIO		
201	LIVE/WORK	1,230	580	STUDIO		
202	DWELLING	1,635	845	1 BDRM		
204	LIVE/WORK	-	790	1 BDRM		
206	DWELLING	-	800	1 BDRM		
208	LIVE/WORK	1,730	930	1 BDRM		
210	DWELLING	1,280	680	STUDIO		
212	LIVE/WORK	-	600	STUDIO		
218	LIVE/WORK	-	720	1 BDRM		
301	LIVE/WORK	-	-	STUDIO		
302	LIVE/WORK	-	-	1 BDRM		
303	LIVE/WORK	-	-	1 BDRM		
304	LIVE/WORK	-	-	1 BDRM		
305	LIVE/WORK	-	-	STUDIO		
306	LIVE/WORK	-	-	1 BDRM		
307	LIVE/WORK	-	-	1 BDRM		
308	LIVE/WORK	-	-	1 BDRM		
309	LIVE/WORK	-	-	1 BDRM		
310	LIVE/WORK	-	-	1 BDRM		
311	LIVE/WORK	-	-	1 BDRM		
312	LIVE/WORK	-	-	STUDIO		
401	LIVE/WORK	-	-	STUDIO		
402	LIVE/WORK	-	-	1 BDRM		
403	LIVE/WORK	-	-	1 BDRM		
404	LIVE/WORK	-	-	1 BDRM		
405	LIVE/WORK	-	-	STUDIO		
406	LIVE/WORK	-	-	STUDIO		
407	LIVE/WORK	-	-	1 BDRM		
408	LIVE/WORK	-	-	1 BDRM		
409	LIVE/WORK	-	-	1 BDRM		
410	LIVE/WORK	-	-	1 BDRM		
411	LIVE/WORK	-	-	1 BDRM		
412	LIVE/WORK	-	-	STUDIO		

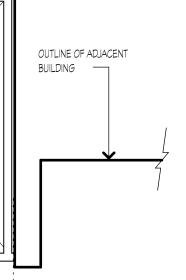

© OF PARTY WALL

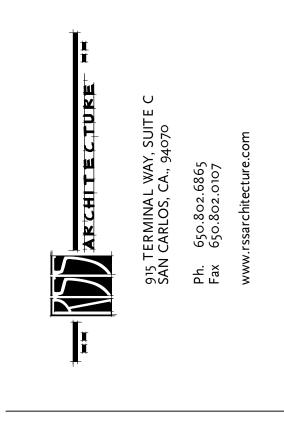



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REVISIONS

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INTERIOR MODIF


PROPOSED BUILDING PLAN

JOB: 1303 DRAWN ΡI

SHEET NO.

A2.3




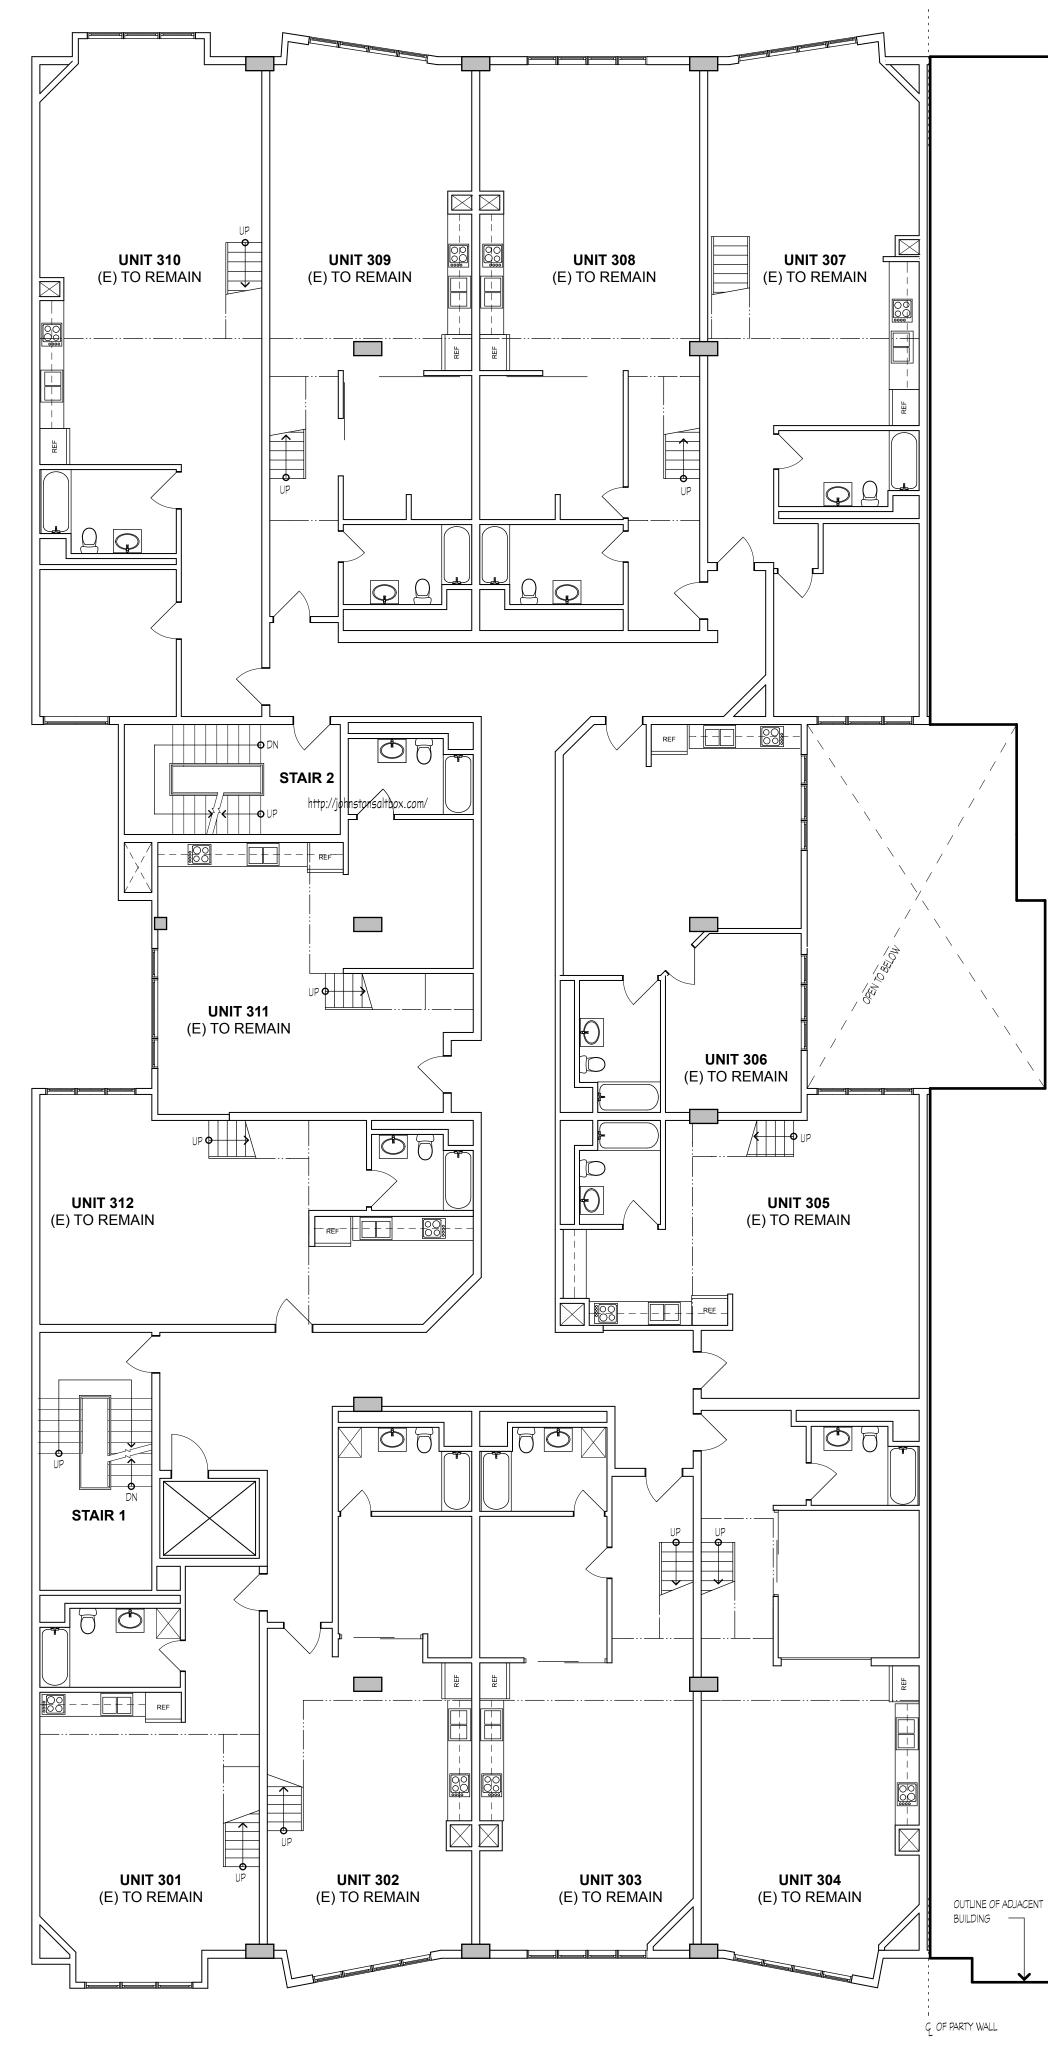


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TYPICAL THIRD FLOOR MEZZANINE BUILDING PLAN SCALE: 1/8" = 1'-0"




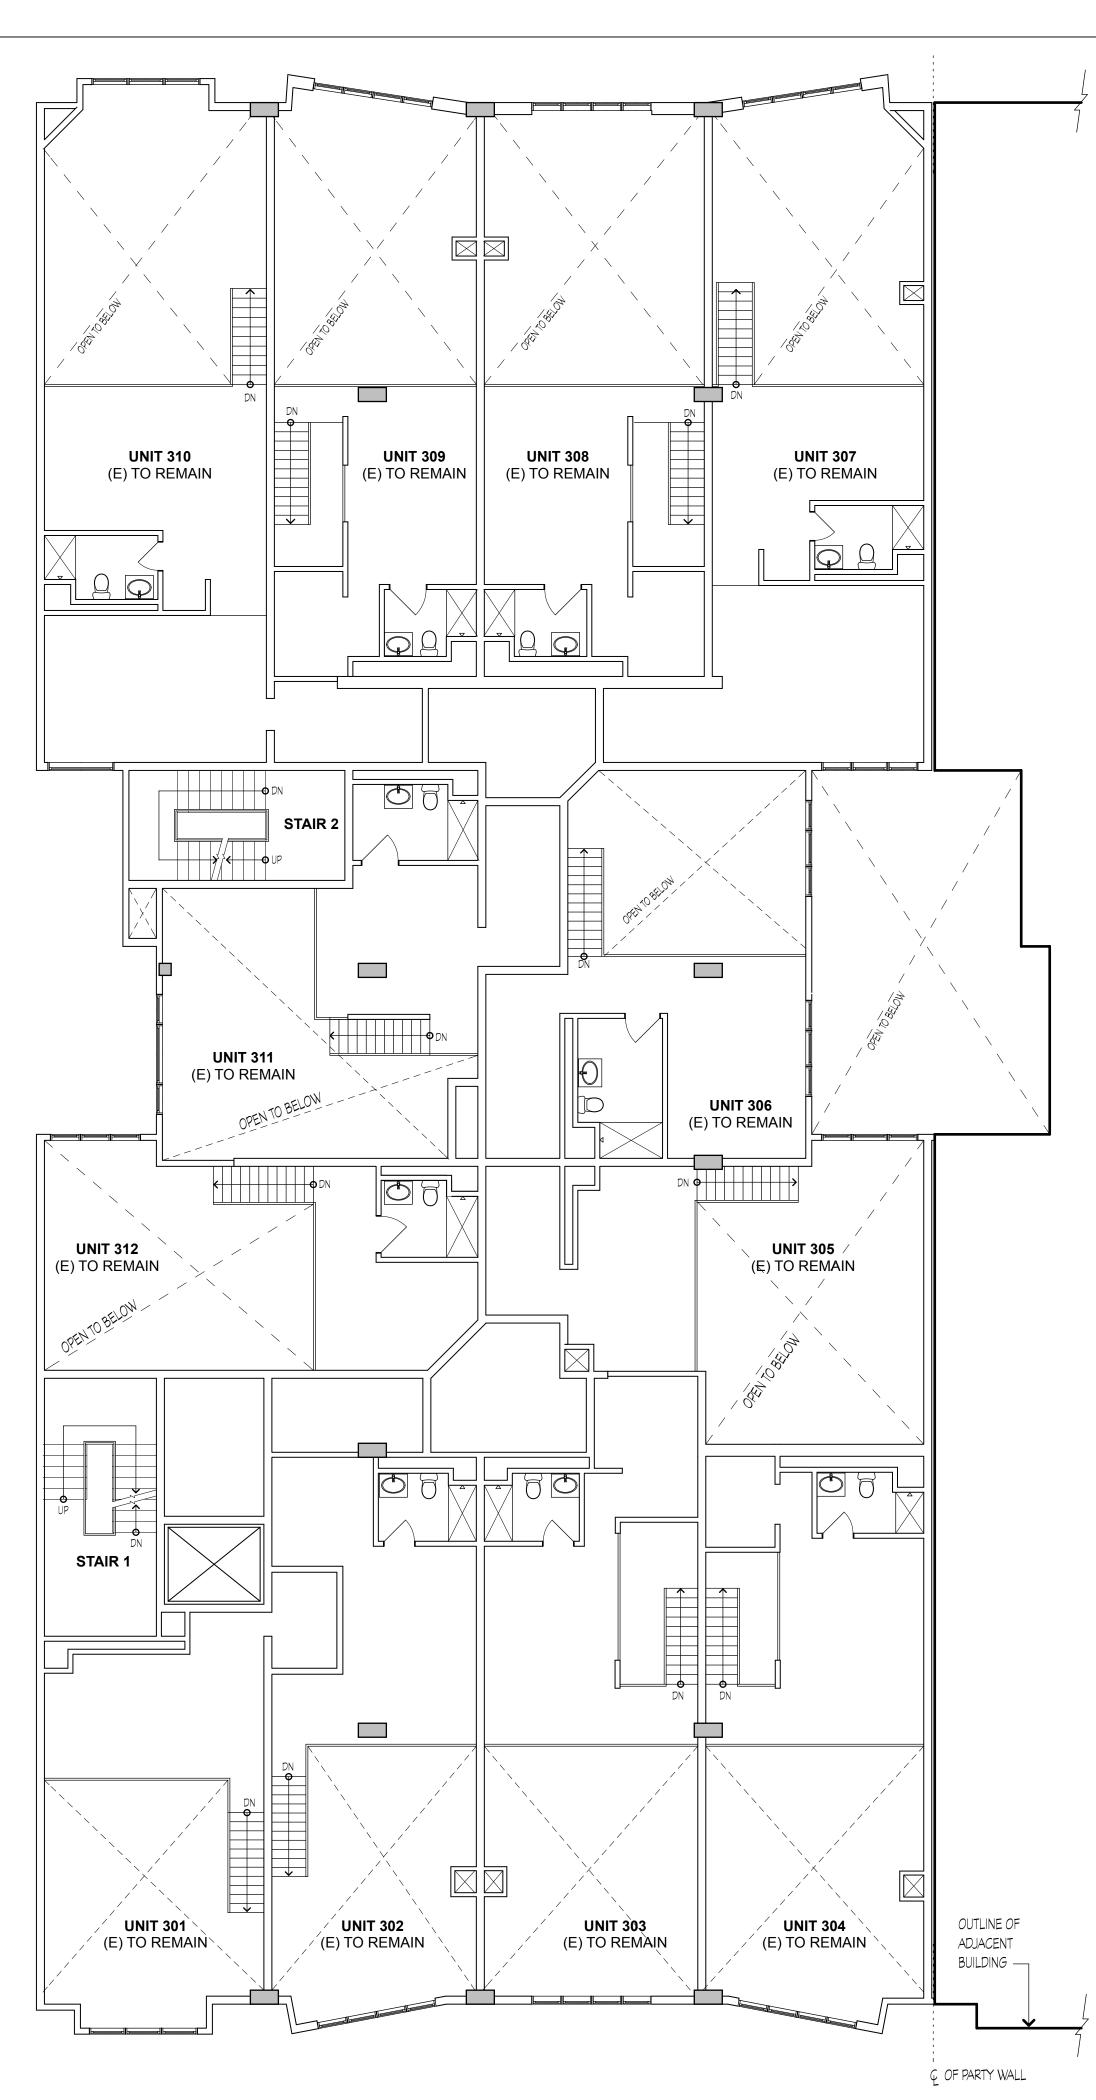

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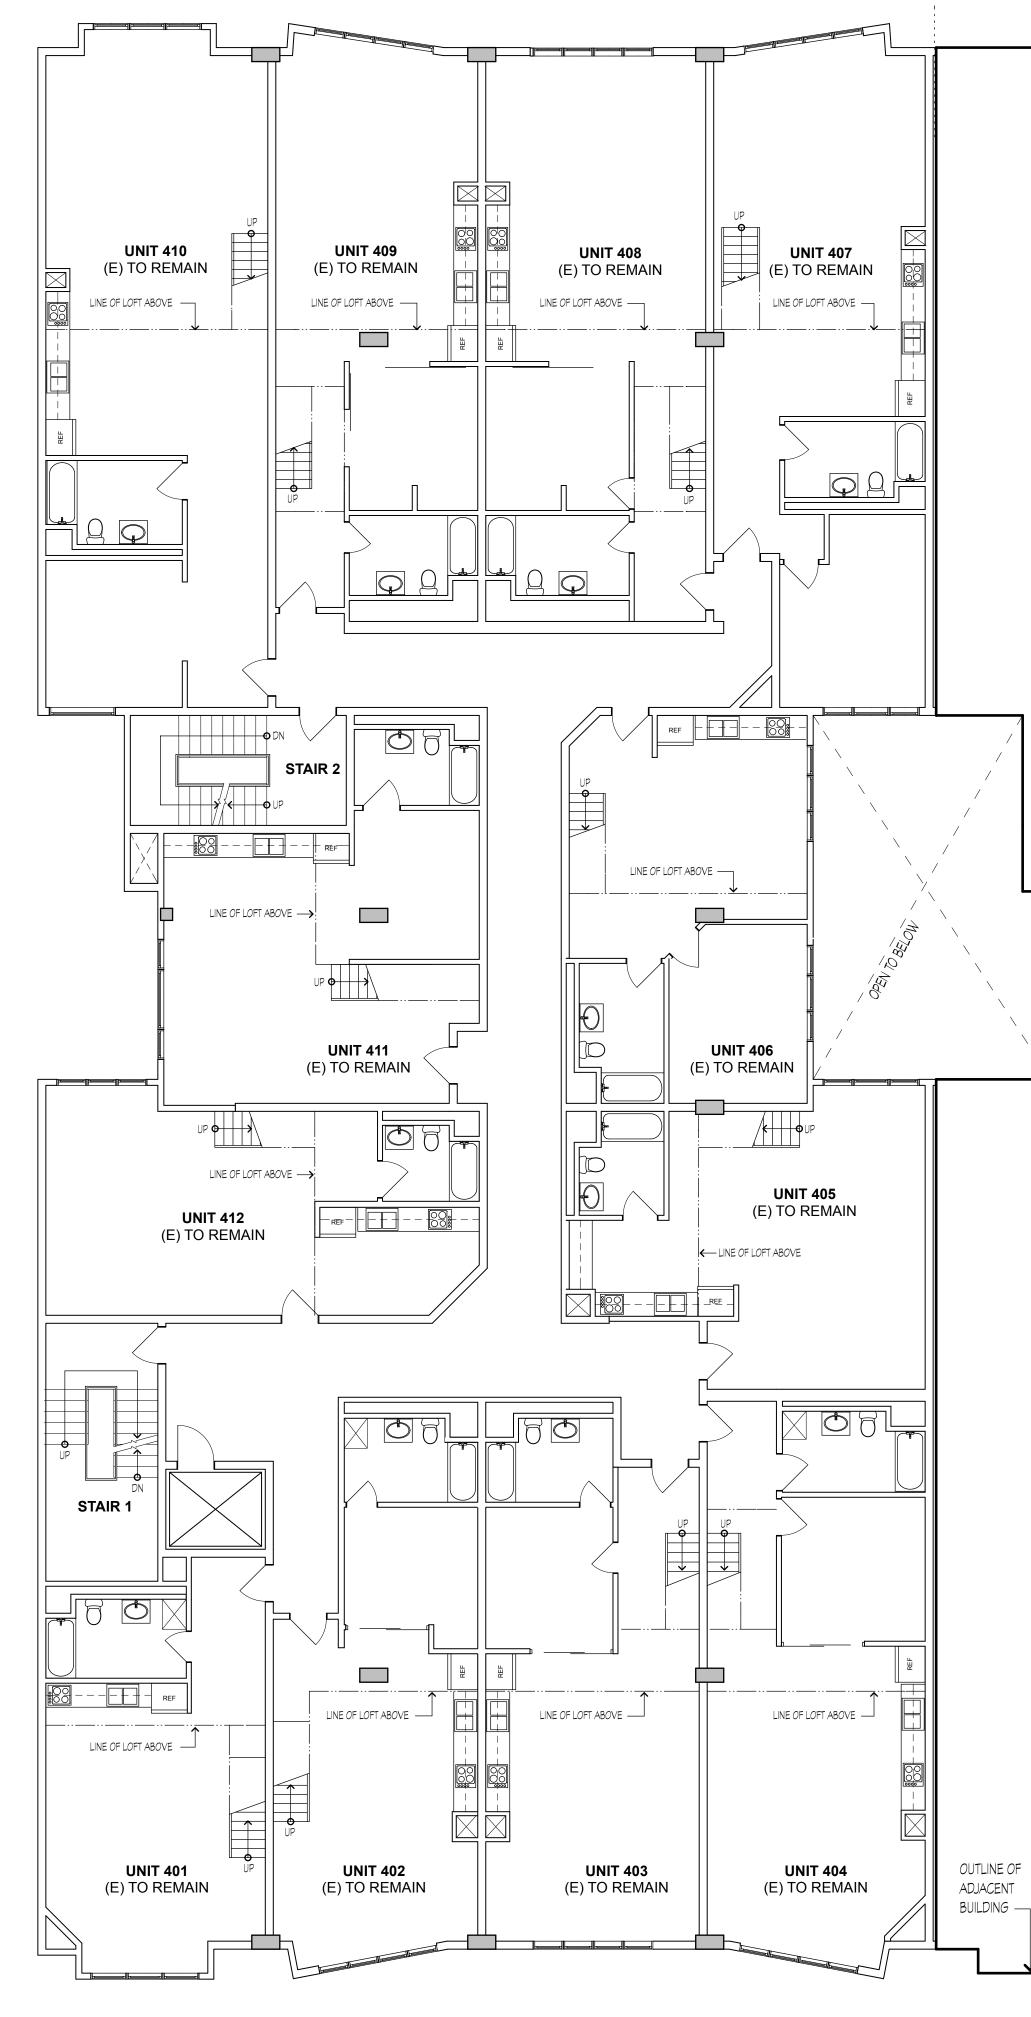
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SEE SHEET A2.0 FOR BUILDING PLAN LEGEND AND NOTES NOT SHOWN.

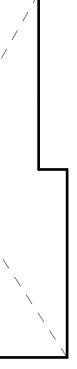


TYPICAL FOURTH FLOOR BUILDING PLAN SCALE: 1/8" = 1'-0"

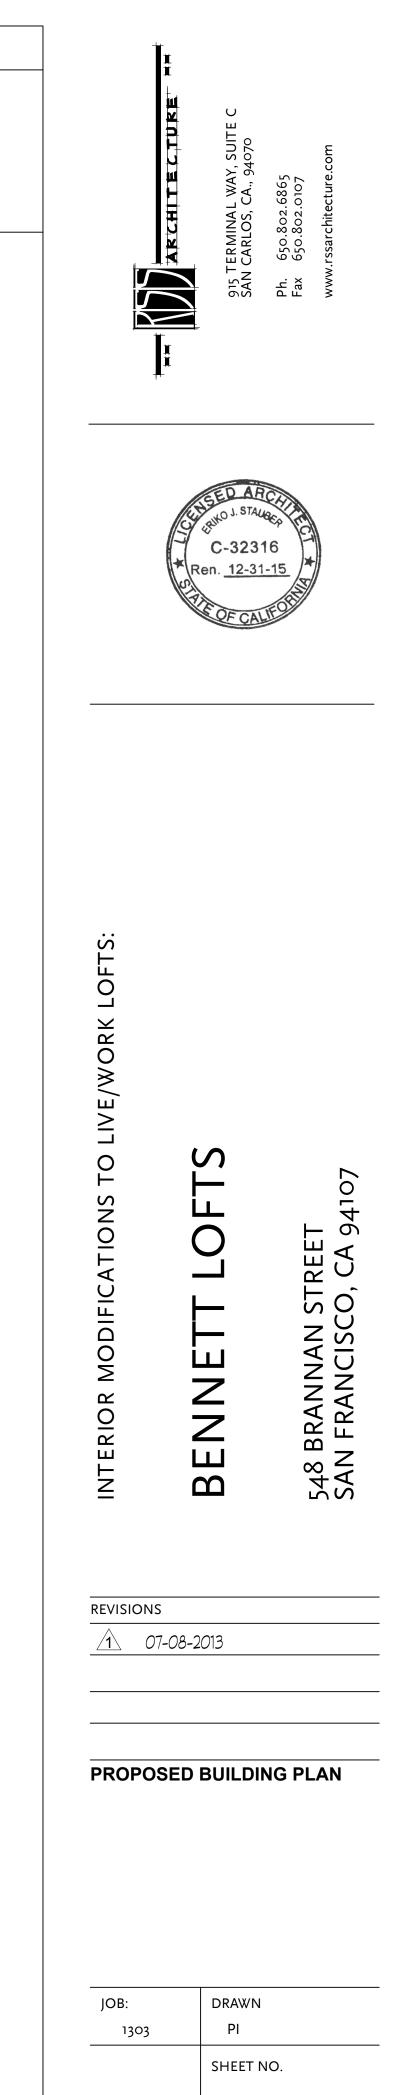
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TYPICAL FOURTH FLOOR MEZZANINE BUILDING PLAN SCALE: 1/8" = 1'-0"






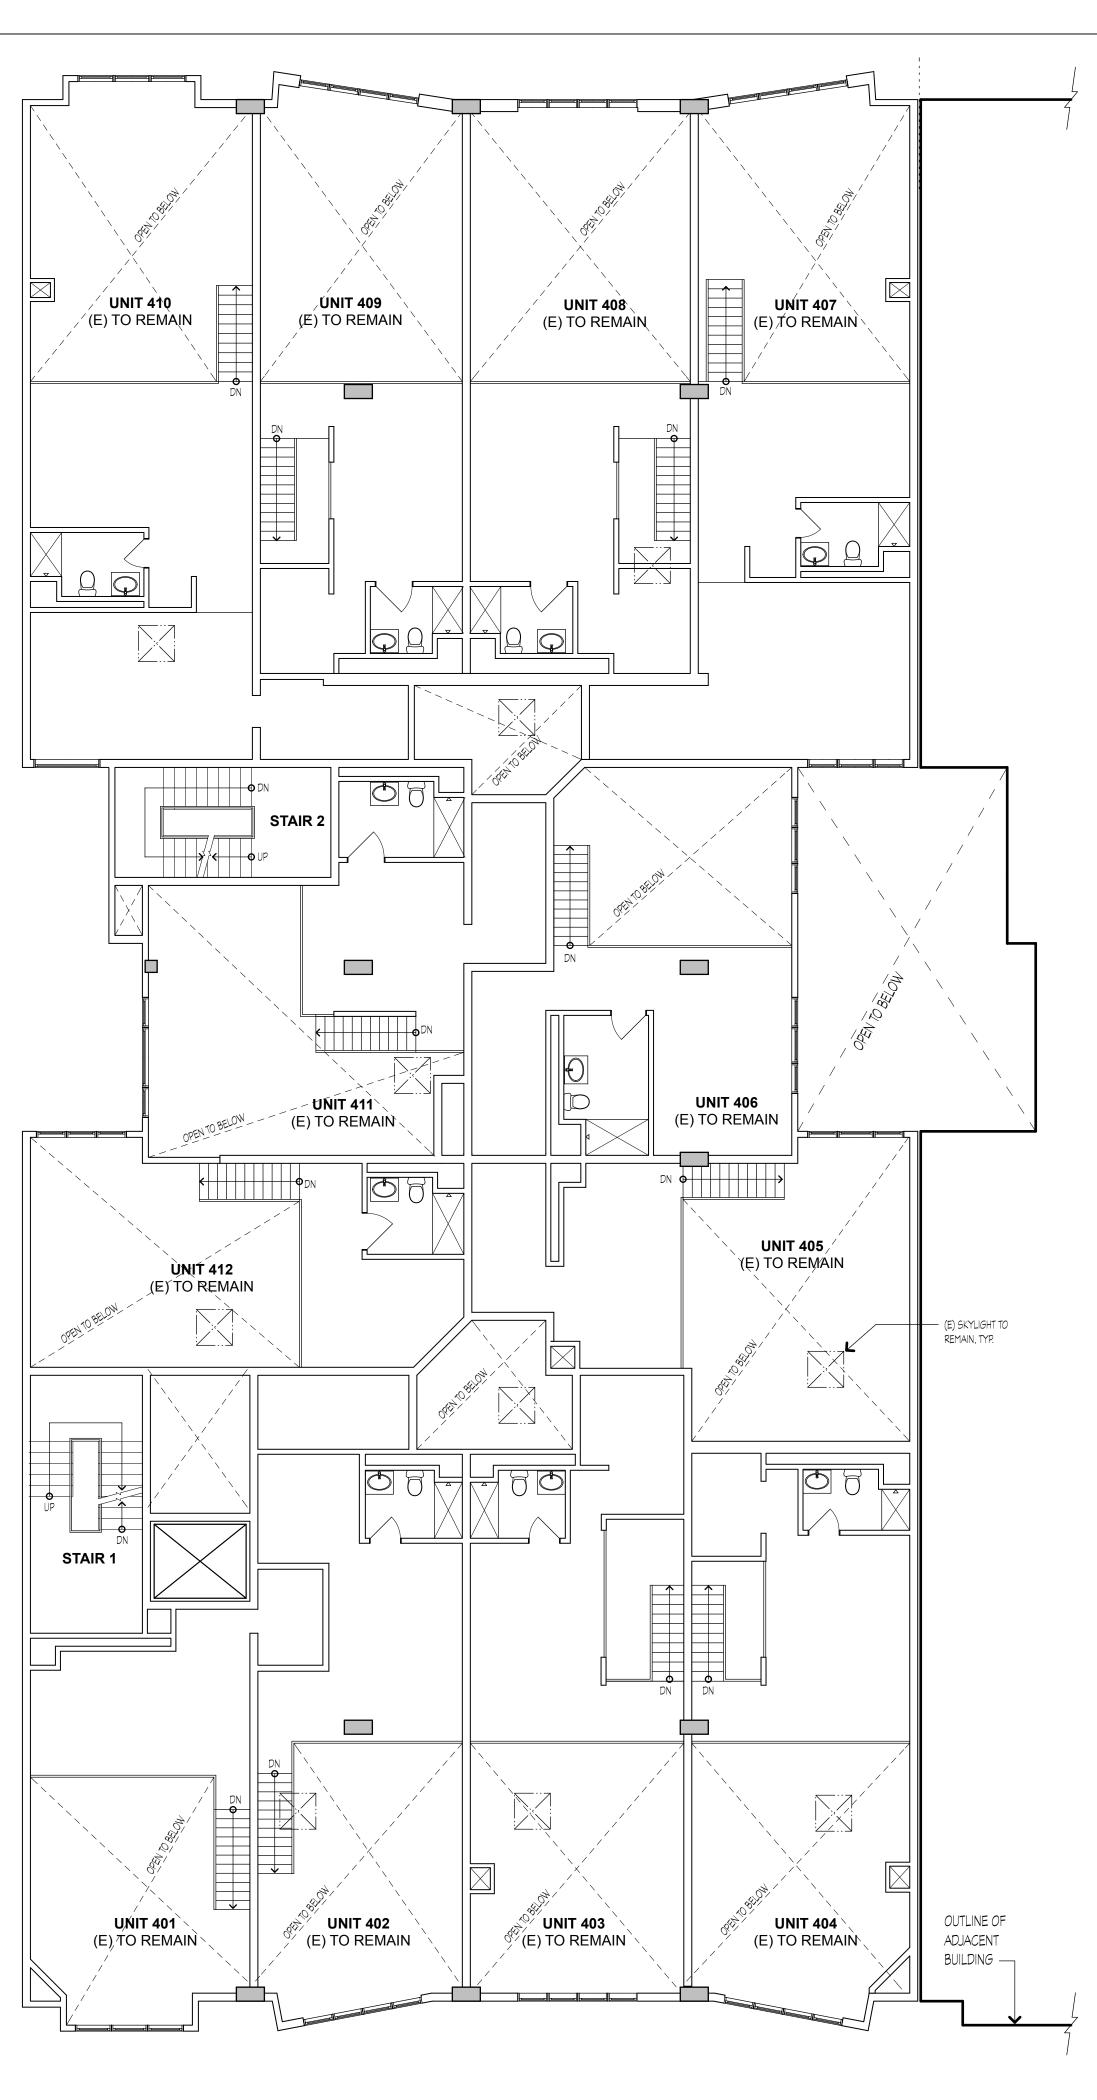

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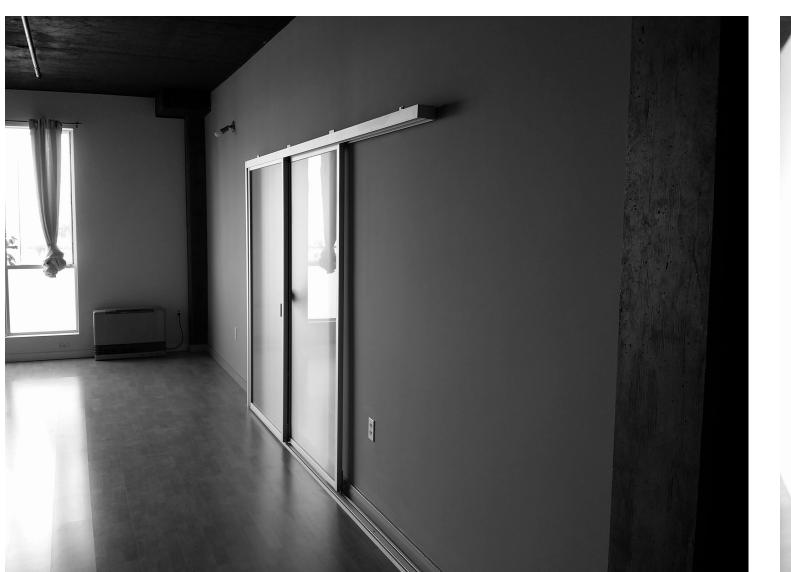
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SEE SHEET A2.0 FOR BUILDING PLAN LEGEND AND NOTES NOT SHOWN.

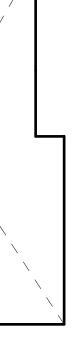

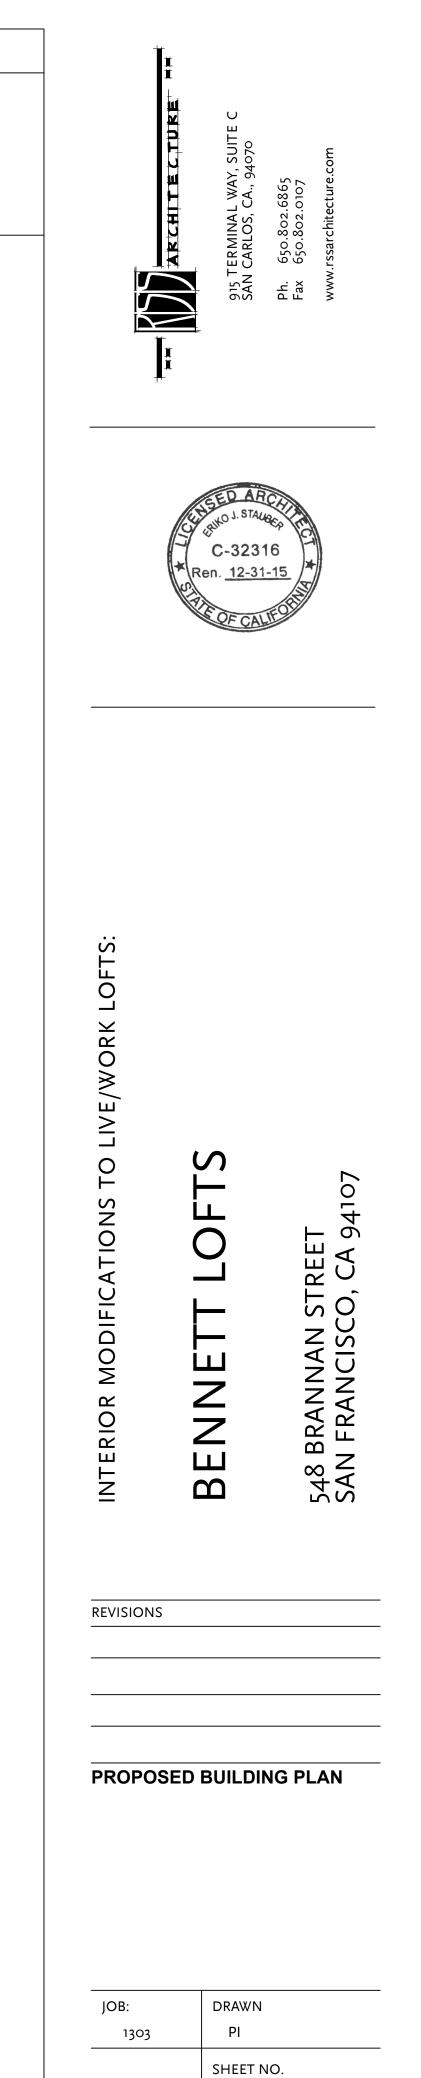

STREET VIEW OF BENNETT LOFTS





TYPICAL PARTITION WALL **BETWEEN UNITS**



STREET VIEW OF BENNETT LOFTS



<u>LIGHTWELL</u>

TYPICAL KITCHEN AREA

<u>TYPICAL UNIT ENTRY</u>



<u>TYPICAL UNIT ENTRY HALL</u>

TYPICAL SLEEPING AREA

915 TERMI SAN CARL $\left\{ \left\{ \right\} \right\}$ Рh. Fax



TS LOF BENNETT

548 BRANNAN STREET SAN FRANCISCO, CA 94107

REVISIONS

LIVE/WORK LOFTS:

INTERIOR MODIFICATIONS TO

EXISTING PHOTOS

JOB: 1303

DRAWN ΡI

SHEET NO.

A3.0

PERMIT SET 08/21/14

