## GENERAL NOTES

AND ANY OTHER GOVERNING CODES AND ORDINANCES.

- 1. ALL CONSTRUCTION AND INSTALLATION SHALL CONFORM TO THE FOLLOWING CODES:
- 1997 UNIFORM BUILDING, PLUMBING, & MECHANICAL CODES 1996 NATIONAL ELECTRICAL CODE 2001 AB970 STATE ENERGY CONSERVATION STANDARDS
- IN THE EVENT OF CONFLICT, THE MOST STRINGENT REQUIREMENTS SHALL APPLY.
- 2. THE CONTRACTOR SHALL REVIEW AND VERIFY ALL DIMENSIONS OF BUILDING AND SITE AND NOTIFY THE ARCHITECT OF ANY DISCREPANCIES BEFORE PROCEEDING WITH CONSTRUCTION.
- 3. THE GENERAL CONTRACTOR SHALL VERIFY AND ASSUME RESPONSIBILITY FOR ALL DIMENSIONS AND SITE CONDITIONS. THE GENERAL CONTRACTOR SHALL INSPECT THE EXISTING PREMISES AND TAKE NOTE OF EXISTING CONDITIONS PRIOR TO SUBMITTING PRICES. NO CLAIM SHALL BE ALLOWED FOR DIFFICULTIES ENCOUNTERED WHICH COULD HAVE REASONABLY BEEN INFERRED FROM SUCH AN EXAMINATION.
- 4. CONTRACTOR SHALL BE RESPONSIBLE FOR COORDINATION BETWEEN ARCHITECTURAL, STRUCTURAL, LANDSCAPE, CIVIL, MECHANICAL, PLUMBING, ELECTRICAL, AND FIRE PROTECTION. THIS INCLUDES REVIEWING REQUIREMENTS OF INDIVIDUAL SYSTEMS BEFORE ORDERING AND INSTALLATION OF ANY WORK. VERIFY ALL ARCHITECTURAL DETAILS AND ALL FINISH CONDITIONS (WHETHER DEPICTED IN DRAWINGS OR NOT) WITH SAME DISCIPLINES.
- 5. ANY ERRORS, OMISSIONS, OR CONFLICTS FOUND IN THE VARIOUS PARTS OF THE CONSTRUCTION DOCUMENTS SHALL BE BROUGHT TO THE ATTENTION OF THE ARCHITECT AND THE OWNER BEFORE PROCEEDING WITH THE WORK.
- 6. DO NOT SCALE DRAWINGS. WRITTEN DIMENSIONS GOVERN.

ABBREVIATIONS

ABOVE FINISHED FLOOR

ANCHOR BOLT

AGGREGATE

ALUMINUM

ALTERNATE

BOARD

BUILDING

BLOCKING

BLOCK

BEAM

BOTTOM

BETWEEN

CEILING

CLEAR

COLUMN

DEGREE

DIAGONAL

DOWN

DRAWING

EXISTING

EXPANSION JOINT

FINISH SYSTEM

ELECTRICAL

ELEVATION

EMERGENCY

ENCLOSURE

EQUIPMENT

EACH WAY

EXPANSION

FIRE ALARM

FOUNDATION

FINSH FLOOR

F.H.C. FIRE HOSE CABINET

FLOOR DRAIN

FIRE EXTINGUISHER

EXTERIOR

EQUAL

EXTERIOR INSULATION AND

ELECTRIC WATER COOLER

FIRE DEPARTMENT CONNECTION

FIRE EXTINGUISHER CABINET

EACH

EL. ELEV. ELEVATION

DOWNSPOUT

CONCRETE

CONNECTION

CONTINUOUS

CERAMIC TILE

DRINKING FOUNTAIN

CAULKING

BOTH WAYS

CONTROL JT.

BUILT UP ROOFING

CONCRETE MASONRY UNIT

APPROXIMAT**!** 

ARCHITECTURAL

AB.

A.F.F.

AGGR.

ALT.

APPROX.

ARCH.

BLDG.

BLK'G.

BD.

BLK

BM.

вот.

BTWN.

B.U.R.

B.W.

C.J.

CLG.

CLR.

C.M.U.

CONC.

CONN.

CONT.

DEG.

D.F.

DIAG.

DN.

(E)

EA.

E.J.

ELEC.

ELEV.

EMER

ENCL.

EQUIP.

EQ.

E.W.

E.W.C.

EXT.

F.A.

F.D.

FDN.

F.E.

F.E.C.

F.F.

DWG.

DET./DTL. DETAIL

DIA. Ø DIAMETER

COL.

CLKG.

- 7. ALL CLEAR DIMENSIONS ARE NOT TO BE ADJUSTED WITHOUT APPROVAL OF THE ARCHITECT.
- 8. WHEN SHOWN IN PLAN, ALL DIMENSIONS ARE TO FACE OF GYPSUM BOARD, CONCRETE, CENTERLINE OF COLUMNS, OR CENTERLINE OF STUD WITHIN WALL ASSEMBLIES, UNLESS OTHERWISE NOTED.

FINISH

FLOOR

F.L.

FLR.

FND

F.O.B.

F.O.C.

F.S.

FTG.

FURR.

GALV.

HDWE

H.M.

JNT.

LAM.

LAV.

M.H.

MIN.

MISC.

M.O.

MTL.

ARCHITECTURAL SYMBOLS

HR.

FT.

FLUOR.

FLOW LINE

FLUORESCENT

FACE OF BRICK

FOOT OR FEET

FACE OF CONCRETE

GENERAL CONTRACTOR

FOUNDATION

FULL SIZE

FOOTING

FURRING

GALVINIZED

GAUGE

GLASS

GRADE

GYP. BD. GYPSUM BOARD

GYPSUM

HOSE BIBB

HOLLOW CORE

HANDICAPPER

HOLLOW METAL

AIR CONDITIONING

INSIDE DIAMETER

INSULATION

INTERIOR

**JANITOR** 

KITCHEN

LAMINATE

LIGHT

MAXIMUM

MECHANICAL

MEMBRANE

MANHOLE

MINIMUM

METAL

MULLION

NORTH

NUMBER

NOMINAL

NEW

MANUFACTURER

MISCELLANEOUS

MASONRY OPENING

NOT IN CONTRACT

OUTSIDE DIAMETER

NOT TO SCALE

ON CENTER

LAVATORY

LABORATORY

JOINT

JOIST

HEATING, VENTILATION AND

HARDWOOD

HARDWARF

HOUR

HEIGHT

- 9. WHEN SHOWN IN SECTION OR ELEVATION, ALL DIMENSIONS ARE TO TOP OF PLATE OR TOP OF CONCRETE UNLESS OTHERWISE NOTED.
- 10. DETAILS SHOWN ARE TYPICAL, SIMILAR DETAILS APPLY IN SIMILAR CONDITIONS.
- 11. THE CONTRACTOR SHALL BE RESPONSIBLE FOR APPLYING AND OBTAINING ALL REQUIRED INSPECTIONS TO CONFORM WITH LOCAL BUILDING AND FIRE CODES.
- 12. PROVIDE AND INSTALL 2x FLAT WOOD BLOCKING FOR ALL BATH ACCESSORIES, HANDRAILS, CABINETS, TOWEL BARS, WALL MOUNTED FIXTURES AND ANY OTHER ITEMS ATTACHED TO WALLS.
- 13. ALL CHANGES IN FLOOR MATERIALS OCCUR AT CENTERLINE OF DOOR OR FRAMED OPENINGS UNLESS OTHERWISE INDICATED ON THE DRAWINGS.
- 14. INSTALL ALL FIXTURES, EQUIPMENT, AND MATERIALS PER MANUFACTURER'S RECOMMENDATIONS AND THE REQUIREMENTS OF THE CODES. ALL APPLIANCES, FIXTURES, AND EQUIPMENT ASSOCIATED WITH PLUMBING, ELECTRICAL, AND MECHANICAL SYSTEMS SHALL BE LISTED BY A NATIONALLY RECOGNIZED AND APPROVED AGENCY.
- 15. VERIFY CLEARANCES FOR FLUES, VENTS, CHASES, SOFFITS, FIXTURES, FIREPLACES, ETC., BEFORE ANY CONSTRUCTION, ORDERING OF, OR INSTALLATION OF ANY ITEM OF WORK.
- 16. PROVIDE FIRE-BLOCKING & DRAFTSTOPPING @ ALL CONCEALED DRAFT OPENINGS (VERTICAL & HORIZONTAL). AS PER 1997/98 UBC 708, FIREBLOCKING & DRAFTSTOPS SHALL BE PROVIDED IN THE FOLLOWING LOCATIONS:
- 1) IN CONCEALED SPACES OF STUD WALLS AND PARTITIONS, INCLUDING FURRED SPACES, AT THE CEILING AND FLOOR LEVELS AND AT 10-FOOT INTERVALS BOTH VERTICAL AND HORIZONTAL.
- 2) IN CONCEALED SPACES BETWEEN STAIR STRINGERS AT THE TOP AND BOTTOM OF THE RUN

AND BETWEEN STUDS ALONG AND IN LINE WITH THE RUN OF STAIRS IF THE WALLS UNDER THE

STAIRS ARE UNFINISHED.

OVERHEAD

OPENING

OPPOSITE

PRE-CAST

PLASTER

PLYWOOD

QUARRY TILE

ROOF DRAIN

REFRIGERATOR

ROUGH OPENING

REFER TO ..

REINFORCED

REQUIRED

SOLID CORE

SCHEDULE

SQUARE FOOT

SPECIFICATION

STAGGERED

STANDARD

STIFFENER

STRUCTURAL

SUSPENDED

TERRAZZO

TOP AND BOTTOM

TONGUE & GROOVE

UNLESS OTHERWISE NOTED

VINYL COMPOSTION TILE

STEEL

TREAD

THICK

TOP OF

TYPICAL

VERIFY

WEST

WITH

WITHOUT

CENTERLINE

NOTE: Clarify with Architect all

abbreviations not listed.

B EQUIPMENT NUMBER

SPOT ELEVATION

PROPERTY LINE

ELEVATION TAG

REVISION

CENTER LINE

VERTICAL

WATER CLOSET

STAINLESS STEEL

SECTION

SHEET

SIMILAR

ROOM

REMODELED OR RELOCATED

PAIR

RISER

PROPERTY LINE

PLASTIC LAMINATE

OPG.

OPP.

PCT.

P.L.

P.LAM.

PLAS.

PR.

Q.T.

R.D.

REFR.

REINF.

REQ'D.

RM

R.O.

S.C.

SECT.

SHT.

SIM.

SPEC.

S.S.

STAGG.

STD.

STIFF

STL.

STRUC.

SUSP.

T & B

T & G

TER.

THK. T/

TYP.

U.O.N.

VCT

VER

VERT.

W.C.

W/O

SQ. OR 中 SQUARE

SCHED.

PLYWD.

3) IN OPENINGS AROUND VENTS, PIPES, DUCTS, CHIMNEYS, FIREPLACES AND SIMILAR OPENINGS WHICH AFFORD A PASSAGE FOR FIRE AT CEILING AND FLOOR LEVELS, WITH NONCOMBUSTIBLE MATERIALS.

SHEET INDEX

- 17. WINDOW SIZES ON DRAWINGS ARE NOMINAL DIMENSIONS. REFER TO MANUFACTURER FOR ACTUAL ROUGH OPENING SIZES.
- 18. MECHANICAL, PLUMBING, ELECTRICAL, AND OTHER PENETRATIONS OF FLOORS, WALLS, AND CEILINGS SHALL BE SEALED AIRTIGHT WITH ACOUSTICAL SEALANT AND FIRESAFING AS REQUIRED.
- 19. ALL EXTERIOR DOORS AND WINDOWS ARE TO BE WEATHERSTRIPPED PER TITLE 24 REQUIREMENTS.
- 20. ALL WALL, FLOOR, ROOF, AND SHAFT CONSTRUCTION TO BE RATED, U.O.N.
- 21. DISCREPANCIES: WHERE A CONFLICT IN REQUIREMENTS OCCURS BETWEEN THE SPECIFICATIONS AND DRAWINGS, OR ON THE DRAWINGS, AND A RESOLUTION IS NOT OBTAINED FROM THE ARCHITECT BEFORE THE BIDDING DATE, THE MORE STRINGENT ALTERNATE WILL BECOME THE CONTRACTUAL REQUIREMENTS.
- 22. CONTRACTOR SHALL NOTIFY GEOTECHNICAL ENGINEER FOR INSPECTION OF COMPRESSION GROUTING, BUILDING PAD, FOUNDATION EXCAVATION, DEPTH, BACK FILL MATERIALS, AND DRAINAGE AS APPLICABLE.
- 23. CONTRACTOR SHALL INSURE THAT GUIDELINES SET FORTH ON SHT. NO.6 ARE MAINTAINED DURING CONSTRUCTION, INSTALLATION, AND FINISHING OF ALL ASPECTS OF THIS PROJECT.
- 24. ALL CONCEALED SPACES UNDER RAISED SLEEPING PLATFORMS MUST BE SPRINKLERED.
- PROVIDE I.C.B.O. EVALUATION SERVICES INC. REPORT ON TEST DATA FOR ALL
- PROVIDE SAFETY GLAZING AT ALL HAZARDOUS LOCATIONS, INCLUDING, BUT NOT LIMITED TO GLAZING WITHIN 18 INCHES OF A WALKING SURFACE. GLAZING IN DOORS AND WINDOWS ADJACENT TO DOORS IN ACCORDANCE WITH SECTION 2406.4.
- ALL TEMPERED GLASS SHALL BE AFFIXED WITH A PERMENANT LABEL PER UBC 2406.2
- ALL SMOKE DETECTORS TO BE HARD WIRED.
- OPENINGS IN 1, 2, OR 3-HOUR RATED ASSEMBLIES SHOULD BE PROTECTED WITH ONE(1), TWO(2) OR THREE(3) HOUR RATED ASSEMBLIES RESPECTIVELY.
- ALL ASSEMBLIES SHOULD BE APPROVED.
- 30. ALL DUCT PENETRATIONS THROUGH RATED WALLS SHOULD BE PROTECTED WITH

# PROJECT DIRECTORY PROJECT ADDRESS:

PROJECT ARCHITECT ANDY RODGERS DESIGN STUDIO 7 LUPINE DRIVE CORTE MADERA, CA 94925 P: 415.309.9612 E: ardesign@att.net

GENERAL CONTRACTOR

### STRUCTURAL ENGINEER

T24 CONSULTANT

BUILDING OWNER ANASTASIA MICHEALS & JAMES MONSCHKE 1784 SANCHEZ STREET

SAN FRANCISCO, CA P: 408.646.4959 E: nasagirl@pacbell.net

## PROJECT INFORMATION

RH2

1784 SANCHEZ STREET SAN FRANCISCO, CA 94131

6653 / 014 BLOCK/LOT:

ZONING:

CONSTRUCTION TYPE: OCCUPANCY:

NUMBER OF FLOORS:

SPRINKLERING: 860 SQ FT TOTAL EXISTING LIVING AREA:

1,322 SF (462 SF ADDED) TOTAL PROPOSED LIVING AREA:

1690 SQ. FT. TOTAL LOT AREA:

24'-10" (MIN.= 33'-9")

PROPOSED REAR SETBACK: 19'-10"

(E) SIDE SETBACK: O FEET / N.A. (NONE REQ'D.)

PROJECT DESCRIPTION:

(E) FRONT SETBACK:

(E) REAR SETBACK:

PROJECT TO CONSIST OF REAR ADDITION TO INCLUDE NEW MASTER BEDROOM, FAMILY RM. AND 2 NEW INTERIOR STAIRS. SCOPE TO INCLUDE SOME NEW DOORS AND WINDOWS AS WELL AS ELECTRICAL AND PLUMBING WORK.

O FEET / N/A (NONE REQ'D.)

design

415 309 9612

415 924 2750

ardesign@att.net

phone

fax

**REVISIONS** 

 $\sim$ ALTERATIONS TO:

SANCHES ST.

FRANCISCO, CALIFORNIA

FRS: anastasia micheals & James monschke

ISSUED FOR SITE PERMIT

TITLE SHEET PLOT PLAN


DATE JUNE 20, 2013 SCALE AS NOTED

JS/AR JOB

SHEET

OF SHEETS

ARCHITECTURAL TITLE SHEET, NOTES, SITE PLAN Α2 FLOOR PLANS (E) & PROPOSED, DOOR & WINDOW SCHEDULE ELEVATIONS (E) & PROPOSED Α3 **ELEVATIONS PROPOSED & SECTIONS** SITE PLAN BACK YARD

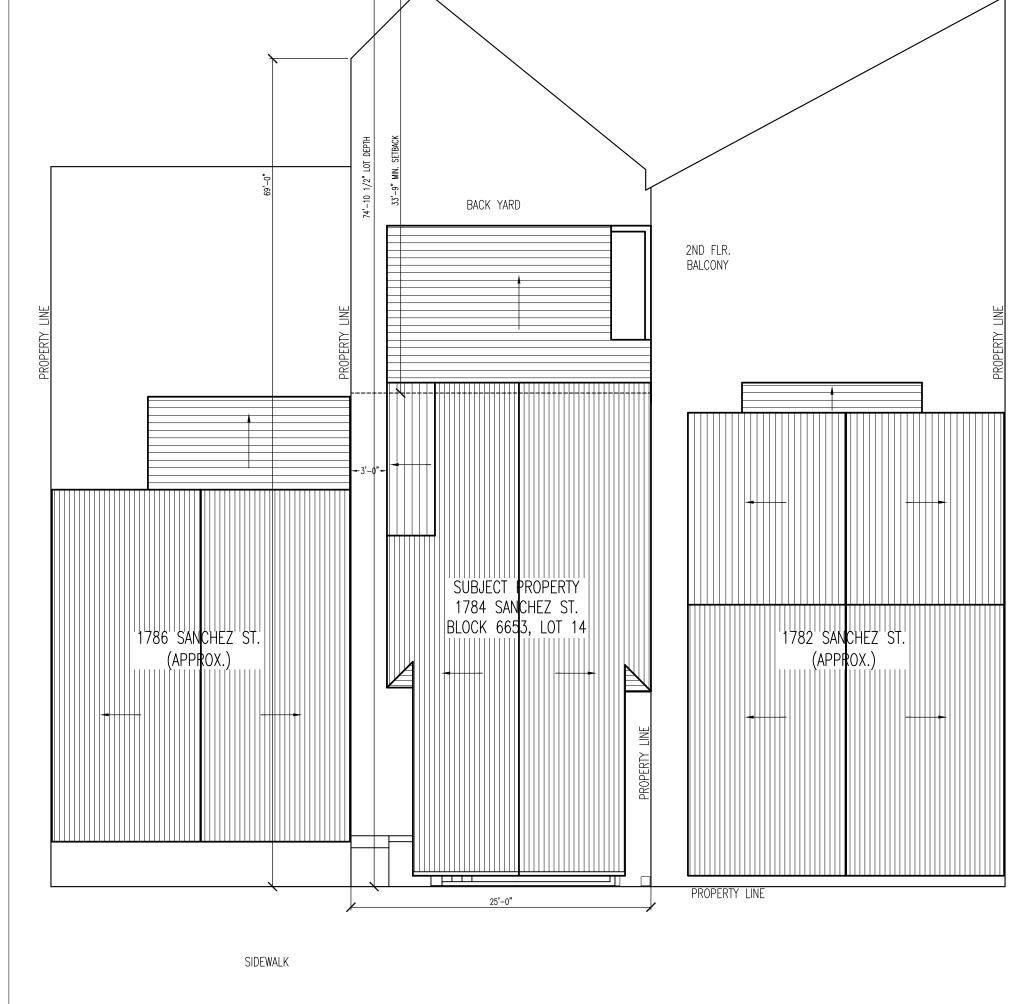

SANCHEZ STREET

BACK YARD SUBJECT PROPERTY 1784 SANCHEZ ST. | BLOCK 6653, LOT 14 1786 SANCHEZ ST. '1782' SANCHEZ' ST. (APPROX.) (APPROX.) |<del>|-||||||</del>| | <del>| •| | | | | | |</del> | SIDEWALK

SANCHEZ STREET

 $\int$  SCALE: 1/8" = 1'-0"

PROPOSED SITE PLAN  $\angle$  / SCALE: 1/8" = 1'-0"

EXISTING SITE PLAN

SECTION.
SECTION LETTER
SHEET NUMBER 3 DETAIL:

A3.8 DETAIL NUMBER SHEET NUMBER

(214) DOOR NUMBER WINDOW TYPE

A1 SHEET NUMBER NORTH DESIGNATION


ROOF SLOPE INDICATION

ELEVATION:

SHEET LAYOUT DESIGNATION 4 VIEW NUMBER

ELEVATION.

ELEVATION LETTER A451 SHEET NUMBER

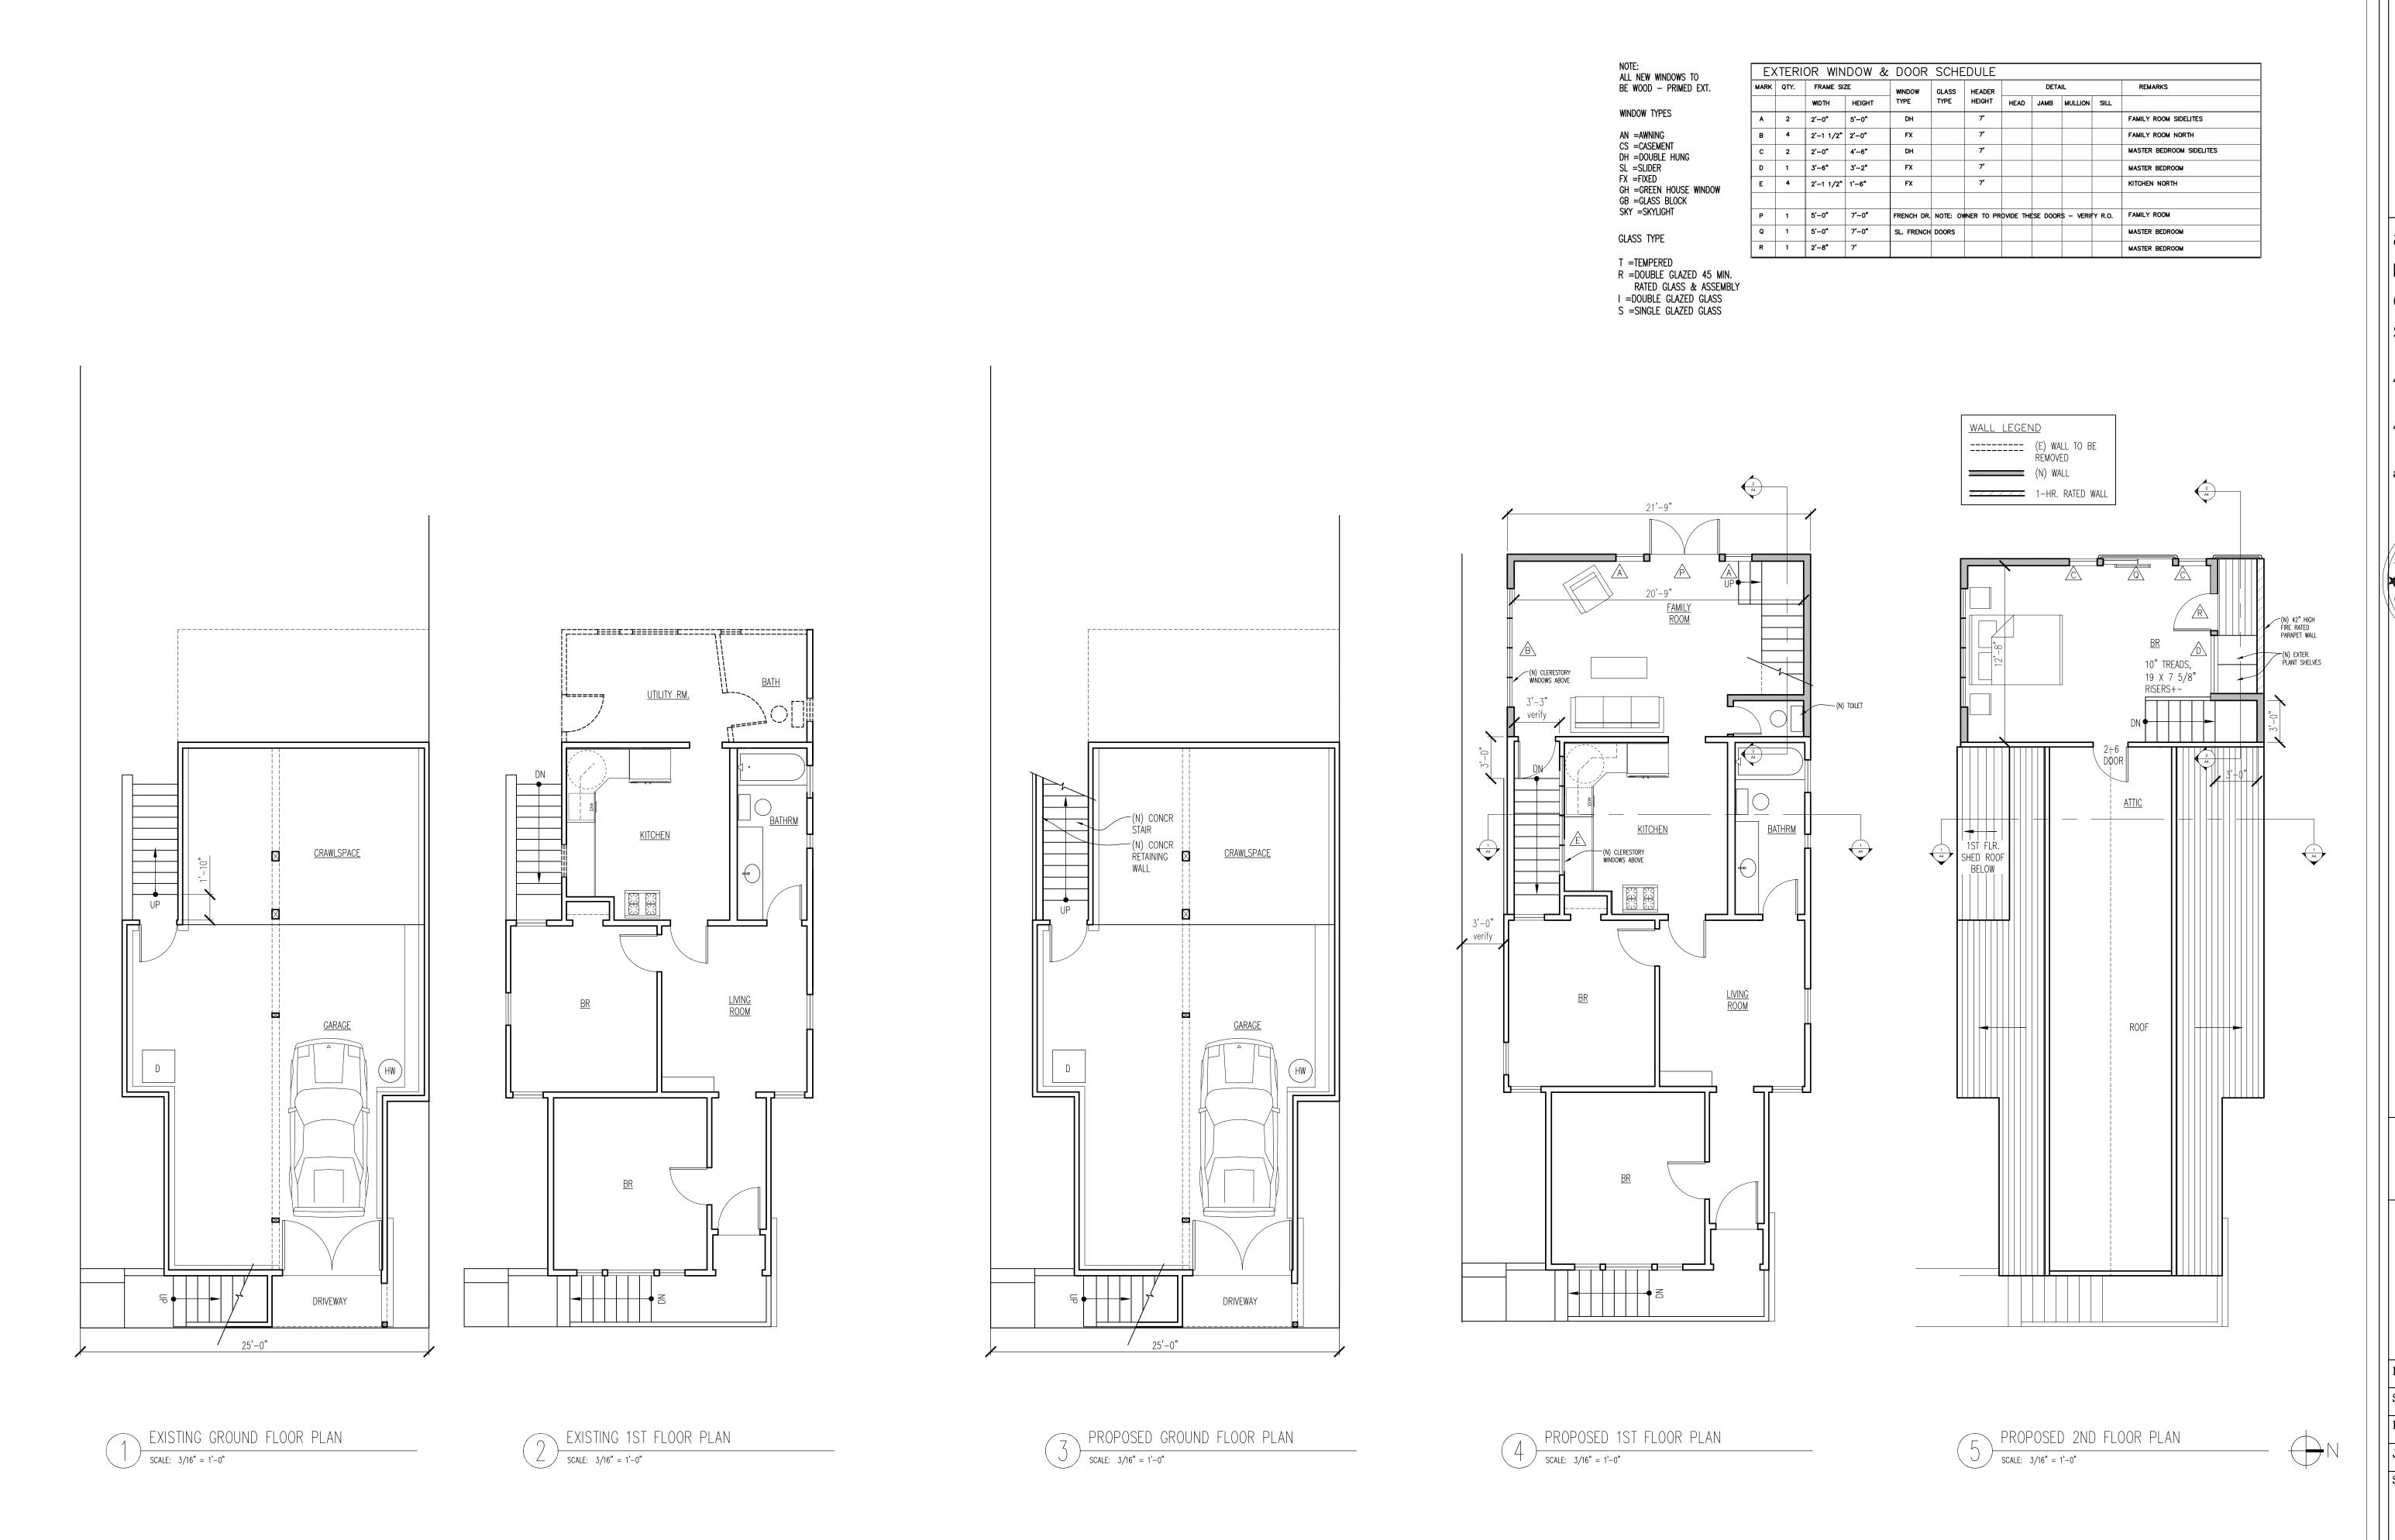


REVISIONS

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fax



SAN FRANCISCO, CALIFORNIA

OWNERS: ANASTASIA MICHEALS & JAMES MONSCHKE

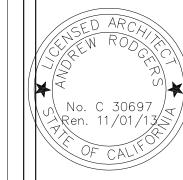ISSUED FOR SITE PERMIT

PLANS

DATE JUNE 20, 2013

SCALE AS NOTED

DRAWN JS / AR

JOB SHEET

OF SHEETS




SCALE: 1/4" = 1'-0"

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ALTERATIONS TO:
SAN CHESCO, CALIFORNIA
OWNERS: ANASTASIA MICHEALS & JAMES MONSCHKE

ISSUED FOR SITE PERMIT

ELEVATIONS

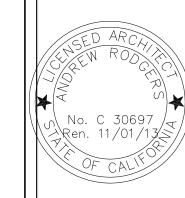DATE JUNE 20, 2013

SCALE AS NOTED DRAWN JS / AR

JOB

OF

GRAPHIC SCALE

**A3** 

SHEETS

