

SAN FRANCISCO PLANNING DEPARTMENT

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Disclaimer for Review of Plans

The San Francisco Planning Code requires that the plans of certain proposed projects be provided to members of the public prior to the City's approval action on the project. Accordingly, any images of plans featured on this website are provided for the primary purpose of facilitating public input prior to the City's action. The City and County of San Francisco does not own the copyright to these images. Please be aware that the unauthorized reproduction, distribution, or alteration of these images may result in a violation of Federal Copyright Law (17 U.S.C.A. Sections 101 et seq.) and that any party who seeks to reproduce or alter these images does so at his or her own risk.

Additionally, plans provided on this website are limited to site plans, elevations and/or section details (floor plans and structural details may not be included). These are DRAFT PLANS being provided for public review PRIOR to the City's approval action on the project. Final plans may differ from those that are currently available for review.

1650 Mission St. Suite 400 San Francisco, CA 94103-2479

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SAN FRANCISCO PLANNING DEPARTMENT

1650 Mission Street, Suite 400 • San Francisco, CA 94103 • Fax (415) 558-6409

NOTICE OF PUBLIC HEARING

Hearing Date:Wednesday, March 26, 2014Time:9:30 AMLocation:City Hall, 1 Dr. Carlton B. Goodlett Place, Room 40Case Type:Variance(Side Yard)Hearing Body:Zoning Administrator						
PORPERT	FY INFOI	RMATION	APPLICAT	ION INFORMATION		
Project Address:	135 Belgra	ave Avenue	Case No.:	2013.0791V		
Cross Street(s):	Stanyan S	t & Bigler Avenue	Building Permit:	201312124044		
Block / Lot No.:	2688/046		Applicant/Agent:	Jennifer Weiss		
Zoning District(s):	RH-1(D) / 4	40-X	Telephone:	415-398-1700		
Area Plan:	N/A		E-Mail:	jweiss@jweissdesign.com		
PROJECT DESCRIPTION						

PROJECT DESCRIPTION

The project proposes to construct second floor horizontal expansions at the front and rear of the twostory, single-family home.

Planning Code Section 133 requires two 5- foot side yards for the subject property. The existing building currently encroaches approximately 1 foot, 6 inches into both required side yards. The proposed horizontal expansions will also encroach approximately 1 foot, 6 inches into both required side yards to match the existing building setback.

ADDITIONAL INFORMATION

FOR MORE INFORMATION, PLEASE CONTACT PLANNING DEPARTMENT STAFF: Planner: Sharon Lai Telephone: 415-575-9087 Mail: sharon.w.lai@sfgov.org

ARCHITECTURAL PLANS: The site plan and elevations of the proposed project are available on the Planning Department's website at: http://sf-planning.org/ftp/files/notice/2013.0791V.pdf

GENERAL INFORMATION ABOUT PROCEDURES

VARIANCE HEARING INFORMATION

Under Planning Code Section 306.3, you, as a property owner or resident within 300 feet of this proposed project or interested party on record with the Planning Department, are being notified of this Variance Hearing. You are not obligated to take any action. For more information regarding the proposed work, or to express concerns about the project, please contact the Applicant/Agent or Planner listed on this notice as soon as possible. Additionally, you may wish to discuss the project with your neighbors and neighborhood association or improvement club, as they may already be aware of the project.

Persons who are unable to attend the public hearing may submit written comments regarding this application to the Zoning Administrator, Planning Department, 1650 Mission Street, Suite 400, San Francisco, CA 94103, by 5:00pm the day prior to the hearing. These comments will be made a part of the official public record, and will be brought to the attention of the person or persons conducting the public meeting or hearing

BUILDING PERMIT APPLICATION INFORMATION

Under Planning Code Section 311/312, the Building Permit Application for this proposal is also subject to a 30-day notification to occupants and owners within 150-feet of the subject property. The mailing of such notification will be perfromed separately.

BOARD OF APPEALS

An appeal of the approval (or denial) of a **variance application** by the Zoning Administrator may be made to the **Board of Appeals within 10 days** after the **Variance Decision Letter** is issued by the Zoning Administrator.

An appeal of the approval (or denial) of a **building permit application** by the Planning Department may be made to the **Board of Appeals within 15 days** after the **building permit** is issued (or denied) by the Director of the Department of Building Inspection.

Appeals must be submitted in person at the **Board's office at 1650 Mission Street**, **3rd Floor**, **Room 304**. For further information about appeals to the Board of Appeals, including current fees, **contact the Board of Appeals** at **(415) 575-6880**.

ABOUT THIS NOTICE

The Planning Department is currently reviewing its processes and procedures for public notification as part of the Universal Planning Notification (UPN) Project. The format of this Public Hearing notice was developed through the UPN Project and is currently being utilized in a limited trial-run for notification of Variance Hearings.

If you have any comments or questions related to the UPN Project or the format of this notice, please visit our website at <u>http://upn.sfplanning.org</u> for more information.

ABBREVIATIONS

ABB	REVIATIONS				
&	AND	GALV.	GALVANIZED	R.	RISER OR REFRIGERATOR
	ANGLE	G.D.	GARBAGE DISPOSAL	RAD.	RADIUS
@	AT	GEN.	GENERAL	RD	ROOF DRAIN
Ø	DIAMETER	GFCI	GROUND FAULT CIRC. INTERRUPTER	RREC.	RECESSED
# မ	NUMBER OR POUND	GL.	GLASS	REF.	REFERENCE
	CENTERLINE	GND.	GROUND	REFL.	REFLECTED
	PERPENDICULAR	GR.	GRADE	REFR.	REFRIGERATOR
F P2	PROPERTY LINE	G.S.M.	GALVANIZED SHEET METAL	REG.	REGISTER
(E)	EXISTING	GWB.	GYPSUM WALL BOARD	REINF.	REINFORCED
(N)		GYP.	GYPSUM	REQ.	REQUIRED
(F)	FUTURE			RET.	
		H.B.	HOSE BIBB	REV.	REVISION/REVISED/REVERSED
ACOUS.	ACOUSTICAL AREA DRAIN	H.C. HD.	HOLLOW CORE HEAD	RM. R.O.	ROOM ROUGH OPENING
ADD'L.	ADDITIONAL	HDWD.	HARDWOOD	R.O.W	RIGHT OF WAY
ADJ.	ADJUSTABLE / ADJACENT	HDR.	HEADER	RWD.	REDWOOD
AFCI	ARC FAULT CIRCUIT INTERRUPTER	HDW.	HARDWARE	RWL	RAIN WATER LEADER
AFF	ABOVE FINISH FLOOR	HORIZ.	HORIZONTAL		
ALT.	ALTERNATE	HR.	HOUR	S.	SOUTH
ALUM.	ALUMINUM	H.R.	HANDRAIL	SBL	SETBACK LINE
ANOD.	ANODIZED	HGT.	HEIGHT	S.C.	SOLID CORE
APPROX.	APPROXIMATE	HW	HOT WATER	S.C.D.	SEE CIVIL DRAWINGS
ARCH.	ARCHITECTURAL			S.D.	STORM DRAIN
		I.D.	INSIDE DIAMETER (DIMENSION)		SCHEDULE
BD.	BOARD	IN.	INCH	SEAL.	SEALANT
	BITUMINOUS	INFO	INFORMATION	SECT.	SECTION
	BUILDING	INSUL.	INSULATION	S.E.D.	SEE ELECTRICAL DRAWINGS
BLK.	BLOCK	INT.	INTERIOR	SEP.	SEPARATION
		107		S.F.	
ВМ. В.О.	BEAM BOTTOM OF	JST. JT.	JOIST JOINT	SHR. SHT.	SHOWER SHEET
BU BU	BUILT-UP	51.	30111	SHTG.	SHEATHING
	BETWEEN	KIT.	KITCHEN	SIM.	SIMILAR
Brinn.			In the second seco	SL.	SLIDING
CAB.	CABINET	LIN.	LINEAR OR LINEN CLOSET	S.L.D.	SEE LANDSCAPE DRAWINGS
CBC	CALIFORNIA BUILDING CODE	LN.	LINE	S.M.D.	SEE MECHANICAL DRAWINGS
CEM.	CEMENT	LN.	LINE	S.P.D.	SEE PLUMBING DRAWINGS
CER.	CERAMIC	LT.	LIGHT	SPEC.	SPECIFICATION OR SPECIAL
C.J.	CONTROL JOINT			SQ.	SQUARE
CLG.	CEILING	MAINT.	MAINTAIN	S.S.	STAINLESS STEEL
CLR.	CLEAR	MAT.	MATERIAL	S.S.D.	SEE STRUCTURAL DRAWINGS
C.M.U.	CONCRETE MASONRY UNIT	MAX.	MAXIMUM	STD.	STANDARD
COL.	COLUMN	MECH.	MECHANICAL	STL.	STEEL
	CONCRETE	MEMB.	MEMBRANE	STOR.	STORAGE
	CONDITION	MET.	METAL		STRUCTURAL
		MFR.		S.W.	SHEAR WALL
CONT. CTR.	CONTINUOUS CENTER	MIN. MIR.	MINIMUM MIRROR	т.	TREAD/TRASH
OIN.	GENTER	MISC.	MISCELLANEOUS	т.&G.	TONGUE AND GROOVE
D.	DRYER	Miee.		1.00.	
	DETAIL	N.	NORTH	TEMP.	TEMPERED
DIM.	DIMENSION	N.I.C.	NOT IN CONTRACT	TER.	TERRAZZO
D.O.	DOOR OPENING	NO.	NUMBER	THK.	THICKNESS
D.S.	DOWNSPOUT	NOM.	NOMINAL	т.о.	TOP OF
DW	DISHWASHER	N.T.S.	NOT TO SCALE	т.v.	TELEVISION
DWG.	DRAWING	0.A.	OVERALL	TYP.	TYPICAL
		OCC.	OCCUPANCY	U.B.C.	UNIFORM BUILDING CODE
E.	EAST	O.C.	ON CENTER	UNF.	UNFINISHED
EA.	EACH	0.D.	OUTSIDE DIAMETER (DIMENSION)		UNLESS OTHERWISE NOTED
EF		OH	OVERHEAD	VAR.	
EL.		OPNG.	OPENING	VB	
ELEC.		OPP.	OPPOSITE	VEN.	VENEER
E.P. EQ.	ELECTRICAL PANEL EQUAL	O/	OVER	VERT.	VERTICAL VERTICAL GRAIN DOUGLAS FIR
EQ. EQMT.	EQUAL	PART.	PARTITION	v.g.d.f. V.I.F.	VERTICAL GRAIN DOUGLAS FIR
EQIVIT.	EXTERIOR	PERIM	PERIMETER	V.I.F. W.	WEST OR WASHER
_/		PL.	PLATE	W/	WITH
F.E.	FIRE EXTINGUISHER	PLAS.	PLASTER	W.C.	WALL COVERING / WATER CLOSET
F.E.C.	FIRE EXTINGUISHER CABINET	PLYWD.	PLYWOOD	WD.	WOOD
FIN.	FINISH, FINISHED	PNL.	PANEL	W.H.	WATER HEATER
FIXT.	FIXTURE	PNT.	PAINT	WIN.	WINDOW
FLR.	FLOOR	PR.	PAIR	W/O	WITHOUT
FLUOR.	FLUORESCENT	PT.	POINT OR PRESSURE TREATED	W.P.	WORK POINT OR WATERPROOFING
FO	FACE OF	PTD.	PAINTED	W.P.M.	WATERPROOF MEMBRANE
FT.	FOOT OR FEET			WSCT.	WAINSCOT
FTG.	FOOTING	QT	QUARRY TILE	WT.	WEIGHT
FURR.	FURRING			W.R.	WATER RESISTANT
FUT.	FUTURE				

ESSED ERENCE ECTED RIGERATOR STER FORCED UIRED AINING SION/REVISED/REVERSED GH OPENING HT OF WAY NOOD WATER LEADER тн BACK LINE D CORE CIVIL DRAWINGS RM DRAIN EDULE ANT ΓΙΟΝ ELECTRICAL DRAWINGS ARATION ARE FEET WER ATHING AR NG LANDSCAPE DRAWINGS MECHANICAL DRAWINGS PLUMBING DRAWINGS CIFICATION OR SPECIAL ARE INLESS STEEL STRUCTURAL DRAWINGS DARD RAGE JCTURAL AR WALL AD/TRASH IGUE AND GROOVE PERED RAZZO KNESS OF VISION CAL ORM BUILDING CODE NISHED ESS OTHERWISE NOTED ES OR BARRIER EER TICAL TICAL GRAIN DOUGLAS FIR IFY IN FIELD ST OR WASHER L COVERING / WATER CLOSET ER HEATER NOC

GENERAL NOTES

- 1. A.I.A. Document A201-General Conditions for considered as part of the requirements for com
- 2. The Contractor shall thoroughly examine the pr Jennifer Weiss Architecture (JWA) immediately Contractor shall verify and be responsible for a
- 3. The work included under this contract shall incl of the project, leaving all work ready for use.
- 4. Any errors, omissions, discrepancies, and conclarification prior to starting or proceeding with
- 5. These plans indicate the general extent of the o inclusive. All demolition and all new work nece be included regardless of whether shown on the specifically indicated to be demolished in the st
- 6. All as-built dimensions reflected in drawings sh provided to the Achitect by outside entities. JW finish unless otherwise noted.
- 7. All drawings and notes are considered comple shown or referred to on any one set of drawing
- 8. Larger scale detailed drawings super-cedes sm 9. The Contractor shall confirm in writing approxi documents, and shall notify JWA in writing of
- 10. The Contractor shall provide a schedule for cor date.
- 11. The Contractor shall take care not to damage e contractor and sub-contractors.
- 12. The Contractor shall review, approve, stamp a work, product data, shop drawings and sample to: windows, doors, casework,metal work and s stone, casework/carpentry, flooring, metal work
- 13. By approving, stamping and submitting shop d and verified materials, field measurements, and information within such submittals with the requ
- 14. The Contractor shall not be relieved of respons of the shop drawings, product data or samples, time of submission and JWA has given written
- 15. The Contractor shall submit to JWA three (3) or samples. 16. JWA assumes no responsibility for dimensions
- 17. Substitutions, revisions and/or changes must h
- 18. The Contractor shall maintain a current and co use by all trades and shall provide all subcontr
- 19. The Contractor shall provide complete project of products furnished under this contract.
- 20. Work under this contract shall be warranted by of the work or designated portions thereof or fo items remaining uncompleted after the date of s such items.
- 21.No work defective in construction or quality or o of the Owner's or JWA's failure to discover of required by guarantees shall be replaced by wo construed as acceptance of defective work or i
- 22.Each trade shall examine the premises to insur work. Areas not appropriate shall be brought to 23. The Contractor shall assist in the coordination
- limited to: furniture, equipment, appliances, plui 24. All installations shall be in accordance with ma
- Sealant, weather-stripping, and flashing locatio 25.JWA is not responsible for any waterproofing of waterproofing consultant hired by the Owner,
- 26. Before starting each portion of the Work, the documents relative to that portion of the Work, existing conditions relative to that portion of the promptly report to JWA any errors, inconsisten Information") in such form as JWA may require.
- 27. JWA will respond to RFI's ("Requests for Infor to the RFI's. JWA's response to such requests promptness. Unless agreed otherwise, JWA w average of 10 working days. Contractor shall a understood that some RFI's and submittals will response time.


SYMBOLS


A1.0	– DETAIL NUMBER – SHEET NUMBER	6	— DOOR NUMBER
	- SECTION NUMBER	6	— WINDOW TYPE
			— LEVEL CHANGE
A1.0-	- SHEET NUMBER	LOWER LEVEL	- DESCRIPTION
		529.0	— DATUM POINT
1-	- ELEVATION NUMBER		- FLOOR ELEVATION
A1.0-	- SHEET NUMBER	φ-	WALL-MOUNTED DUPLEX RECEPTACLE
N		•	- FLOOR RECEPTACLE
	- INTERIOR ELEVATION NUMBER	\$ -	— SWITCH
A1.0	- WALL MARK		— PENDANT LIGHT FIXTURE
S	- SHEET NUMBER	⊢॑	— WALL-MOUNTED LIGHT FIXTURE
		—	— DOWN LIGHT
8'-0" A.F.F.	– CEILING HEIGHT		— EXHAUST FAN
		SD-	- SMOKE DETECTOR
	ALIGN		


	GENERAL INF						
	GENERAL INF		N				
or the Performance of a Contract, is hereby incorporated into these drawings and shall be ompletion of work. e premises and shall base his bid on the existing conditions. The Contractor shall notify	SITE INFORMATION PARCEL NUMBER:	2698.046					
tely of any discrepancies between the drawings and the actual field conditions. The or all dimensions and field conditions.	JOB SITE ADDRESS:	2688-046 135 BELGRAVE AVEN	NUE, SAN FRANCISCO, CA	A 94117			
onflicts found in these construction documents shall be brought to the attention of JWA for		ED & LESLIE FINE					
ith work. ne demolition and new construction necessary for the work, but are not intended to be all	PROPERTY OWNER: ED & LESLIE FINE 135 BELGRAVE AVENUE, SAN FRANCISCO, CA 94117						
ecessary to allow for a finished job in accordance with the intention of these documents shall in the drawings or in the notes. Do not demolish any items that may be structural, unless e structural documents, without prior review and written approval by JWA . Is shall be verified in the field by the Contractor. As-built drawings and site survey were JWA is not responsible for any inaccuracies contained therein. All dimensions are to face of	ZONING: HEIGHT & BULK DISTRICT: SPECIAL USE DISTRICTS:	RH-1(D) 40-X NONE					
plementary, and what is called for by either will be as binding as if called for by all. Any work ings shall be provided as though shown on all related drawings. smaller scaled elevation and plan drawings. oximate on-site delivery dates for all construction items as required by the construction of any possible delays affecting the occupancy. construction as required to meet the Owner's phasing requirements and ultimate completion ge existing construction and shall be responsible for repairing all damages caused by	SETBACKS:	FRONT REAR YARD SIDE (WEST)	REQUIRED AVERAGE OF ADJACENT PROP. = 5.78' 25' 5'-0" *	34'-10 1/2" (EXIST 3'-7 1/2" (EXIST'G VARIANCE AT VE NOTE 03, 2/A3.2)	TO REMAIN; RE RTICAL ADDITIC		
o and submit with reasonable promptness and in such sequence as to cause no delay in the ples for the project Shop drawings should be submitted for all items including, but not limited nd stone. Material submittals should be submitted for all items including, but not limited to:			5'-0" * * PER SF PLANNING COE	3'-5" (EXIST'G TO VARIANCE AT VE NOTE 03, 2/A3.3) DE ARTICLE 1.2, SECT	RTICAL ADDITIC		
ork and plaster.	BUILDING INFORMAT	ΓΙΟΝ					
and field construction criteria related thereto and that s/he has checked and coordinated the equirements of the work and contract documents. onsibility for any deviation from the requirements of the contract documents by JWA 's review les, unless the Contractor has specifically informed JWA in writing of such deviation at the tten approval to the specific deviation.	DESCRIPTION OF WORK:	RECONFIGURATION ENCLOSURE OF EXIS LEVEL AND ROOF HE	OVAL OF ONE WINDOW A OF WINDOWS AT NORTH STING SOUTH DECK TO (EIGHT AT NORTH WING T W SKYLIGHT; REMOVE FI	END OF LIVING ROO CREATE NEW BEDROO O CREATE CODE COM	M. SECOND FLO DM; RAISING OF /IPLIANT BEDRO		
3) prints, typically, of each shop drawing submittal plus three (3) copies of either product data	SQUARE FOOTAGE CALCS:	GARAGE/BSMNT (UNCONDITIONED)	FIRST FLOOR (CONDITIONED)	SECOND FLOOR (CONDITIONED)	ТО		
st have prior written approval by JWA.	EXISTING	722 SQ. FT.	1420 SQ. FT.	1131 SQ. FT.	3273		
complete set of construction documents on the job site during all phases of construction for ntractors with current construction documents as required.	PROPOSED Δ (CHANGE)	722 SQ. FT. 0 SQ. FT.	1420 SQ. FT. 0 SQ. FT.	1474 SQ. FT. +343 SQ. FT.	3616 - +343 \$		
by the Contractor against all defects for one (1) year from the date of substantial completion r for one (1) year after acceptance by the Owner of designated equipment. In the case of of substantial completion, the one-year warranty period shall be from date of acceptance of	CONSTRUCTION TYPE:	V-N	1 030.71. 1	T343 SQ. FT. T	+343 (
or deficient in any requirement of the contract documents will be acceptable in consequence of point out deficiencies of defects during construction. Defective work revealed within the time of work conforming to the intent of the contract. No payment, either partial of final, shall be	USE & OCCUPANCY:	R-3					
or improper materials. sure that conditions are appropriate for their work to commence, prior to commencing their it to the attention of JWA. Commencing work implies acceptance of existing conditions. on of, and be responsible for, the complete installation of N.I.C. items, including, but not plumbing fixtures, dishwashers, refrigerator, laundry equipment, etc. manufacturer's specifications, industry and building standards, and code requirements. ations in drawings are not intended to be inclusive. g design or waterproofing scope. The General Contractor, its subcontractors, and/or a r, if the Owner so chooses, are responsible for all waterproofing related design and scope. e Contractor shall carefully study and compare the various Drawings and other Contract rk, as well as any information provided by the Owner, shall take field measurements of any the Work, and shall observe any conditions at the site affecting it. The Contractor shall tencies, or omissions discovered by or made known to the Contractor as an RFI ("Request for ire.	nall beCODE SUMMARYing their ons.TO COMPLY WITH THE CURRENT EDITIONS OF THE FOLLOWING CODES:it not2013 CALIFORNIA BUILDING CODE W/ S.F. AMENDMENTSents.2013 CALIFORNIA ELECTRICAL CODE W/ S.F. AMENDMENTS2013 CALIFONIA MECHANICAL CODE W/ S.F. AMENDMENTSor a i scope.2013 CALIFORNIA PLUMBING CODE W/ S.F. AMENDMENTSor a i scope.2013 CALIFORNIA PLUMBING CODE W/ S.F. AMENDMENTS2013 CALIFORNIA PLUMBING CODE W/ S.F. AMENDMENTS2013 CALIFORNIA ENERGY CODEis of any shall2013 SAN FRANCISCO PLANNING CODE						
formation"), and if appropriate, issue supplemental Drawings and Specifications in response ests will be made in writing within any time limits agreed upon or otherwise with reasonable A will respond to RFI's in an average of 5 working days. JWA will respond to submittals in an all allow sufficient time to revise and resubmit submittals, if required. It is acknowledged and will take longer to answer than others. Incomplete or vague submittals will require longer							
	CONTACTS LI	ST					
	CLIENT EDWARD & LESLIE FINE 135 BELGRAVE AVENUE SAN FRANCISCO, CA 941	17					
	ARCHITECT JENNIFER WEISS ARCHI JENNIFER WEISS 1005 SANSOME STREET SAN FRANCISCO, CA 941 P. 415.398.1700 STRUCTURAL ENGINEEN HOLMES CULLEY DENNY KWAN 130 SUTTER STREET, SU SAN FRANCISCO, CA 941 P. 415.693.1600 CONTRACTOR FARALLON RESIDENTIAL MARK MANNING 81 FILBERT ST	SUITE 232 11 R JITE 400 104					


81 FILBERT ST SAUSALITO, CA 94965 P. 415.250.5233


GEOTECHNICAL EARTH MECHANICS ALLEN GRUEN 360 GRAND AVENUE, SUITE 262 OAKLAND CA 94610 P. 510.839.0765

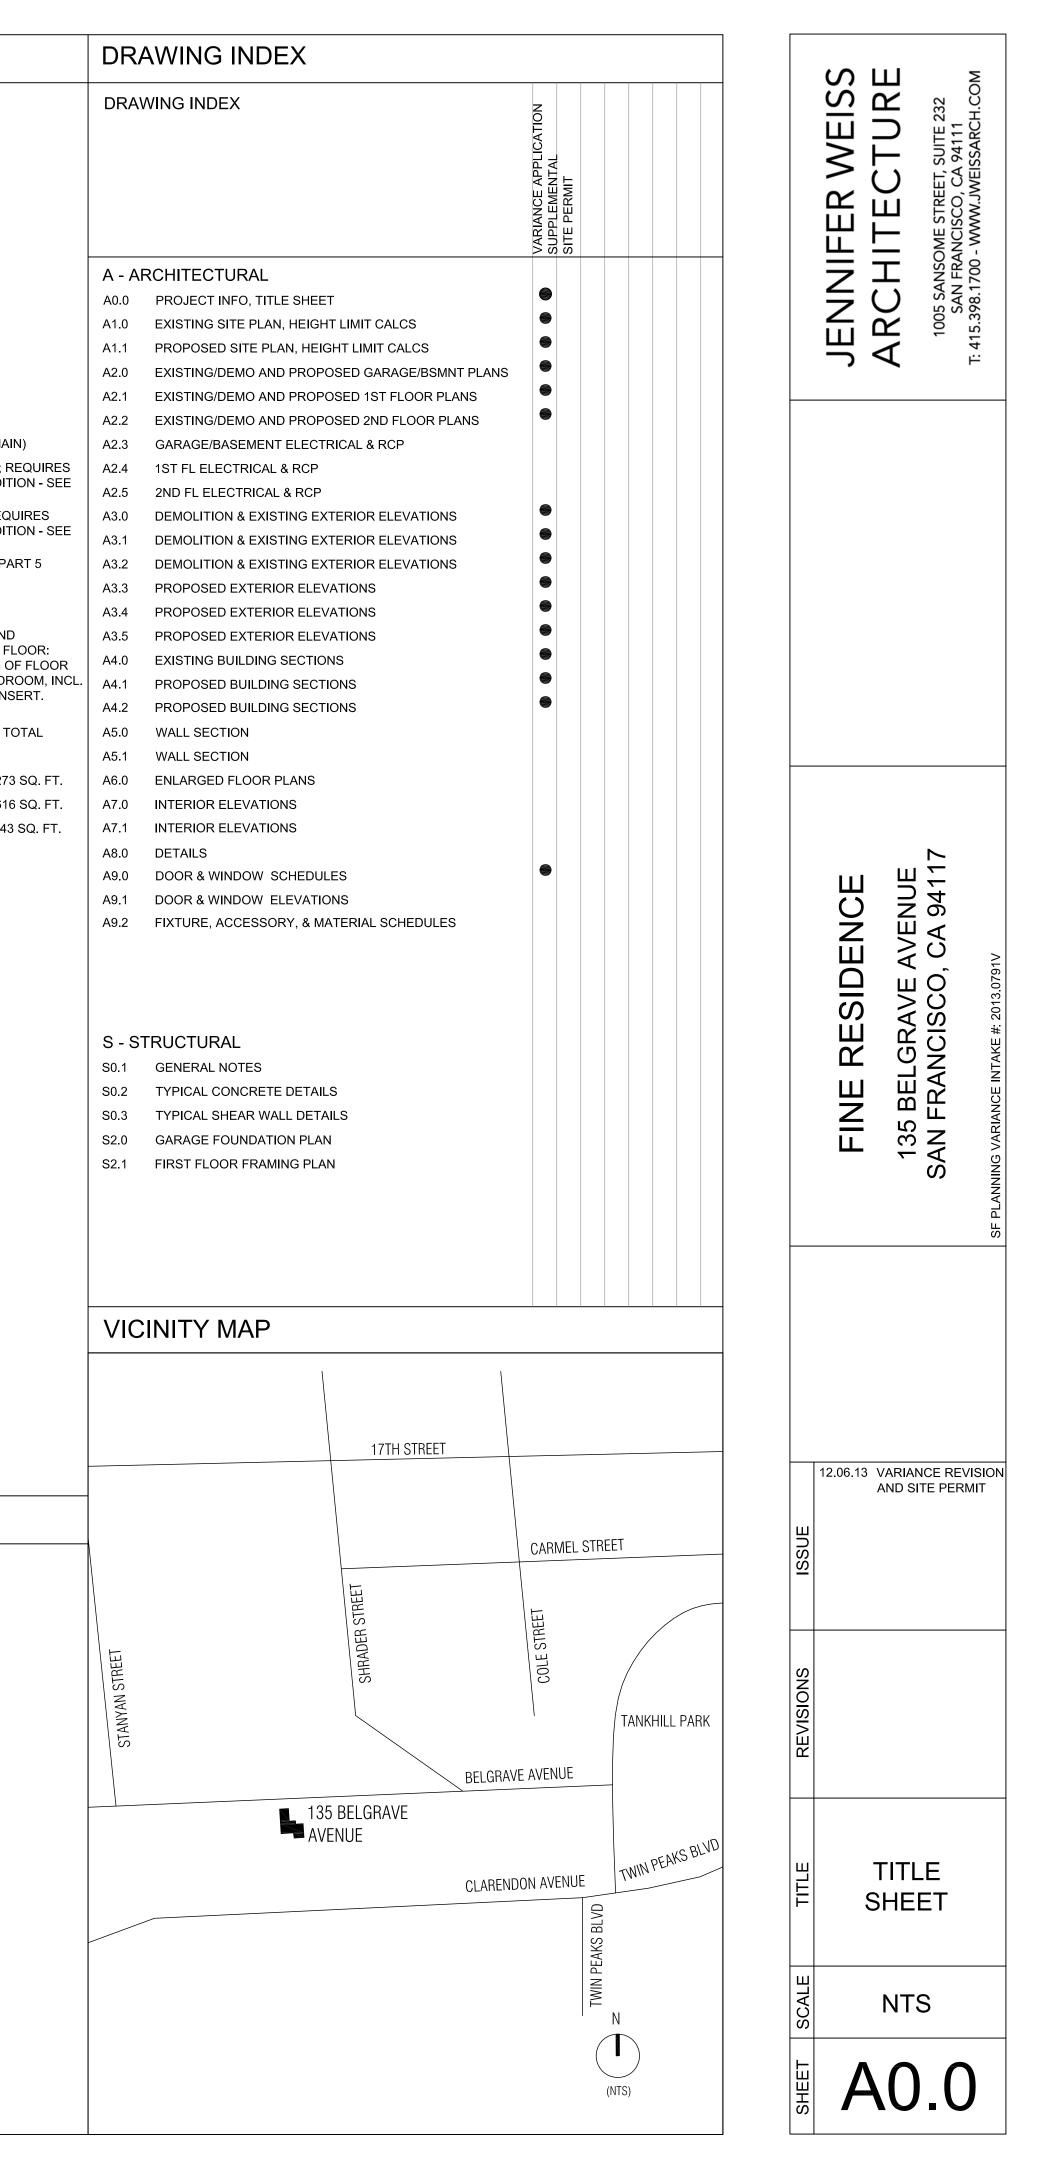


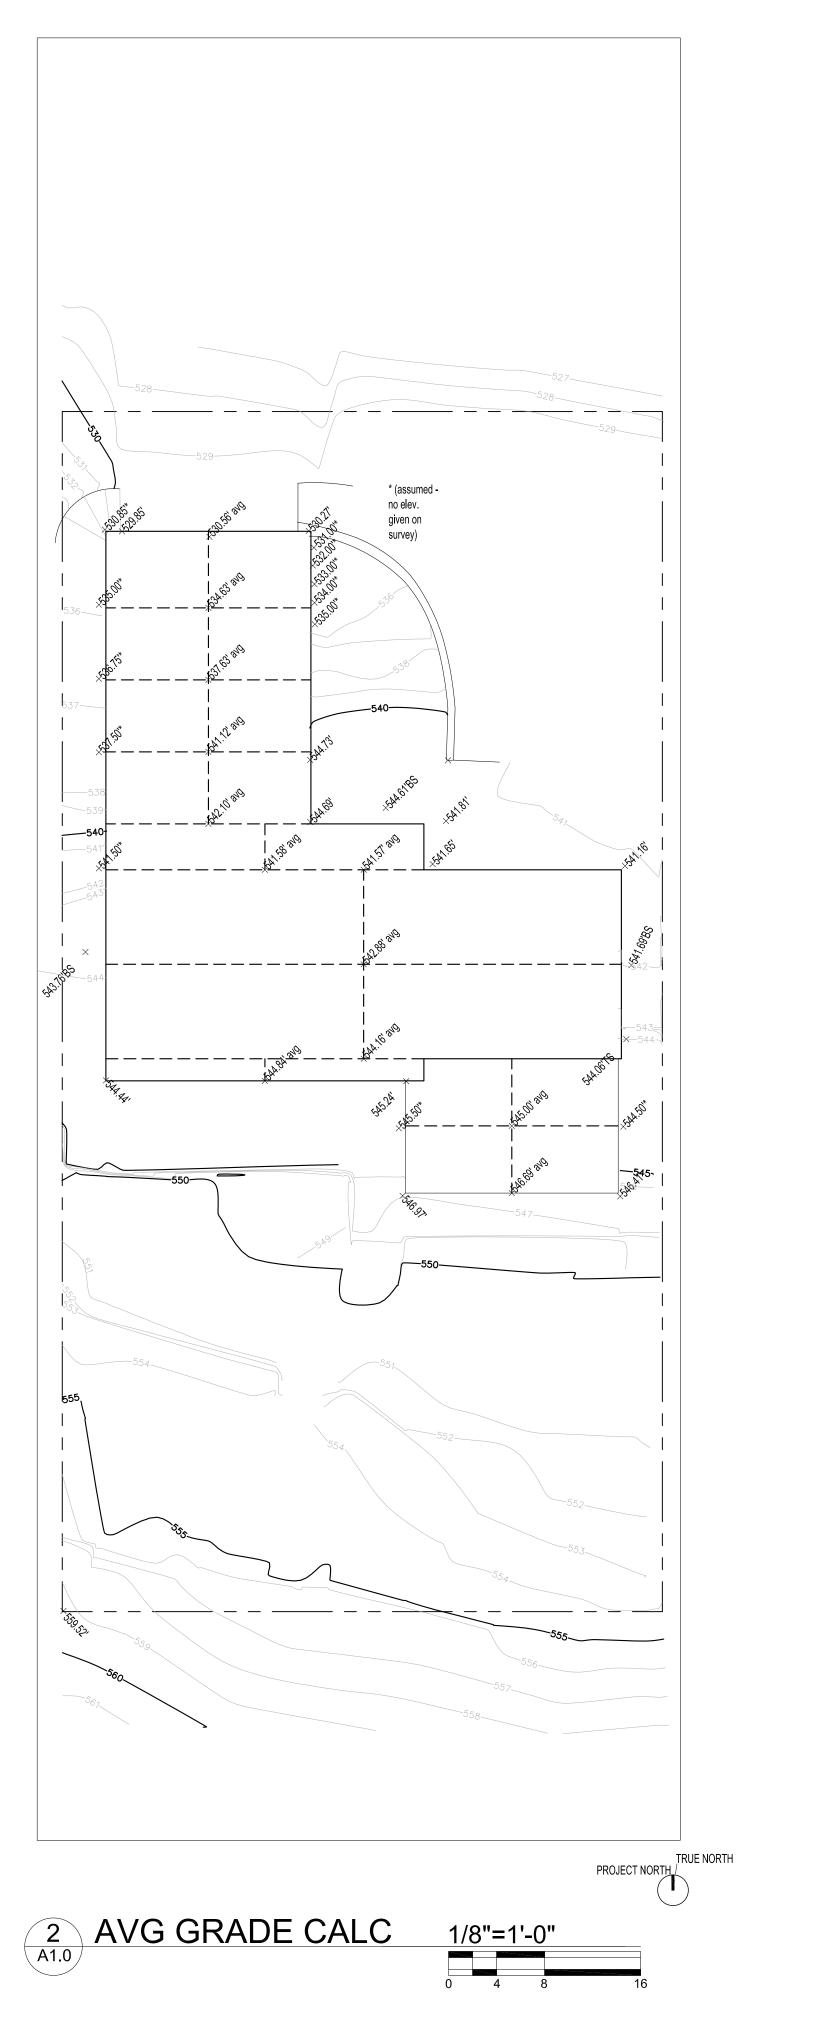


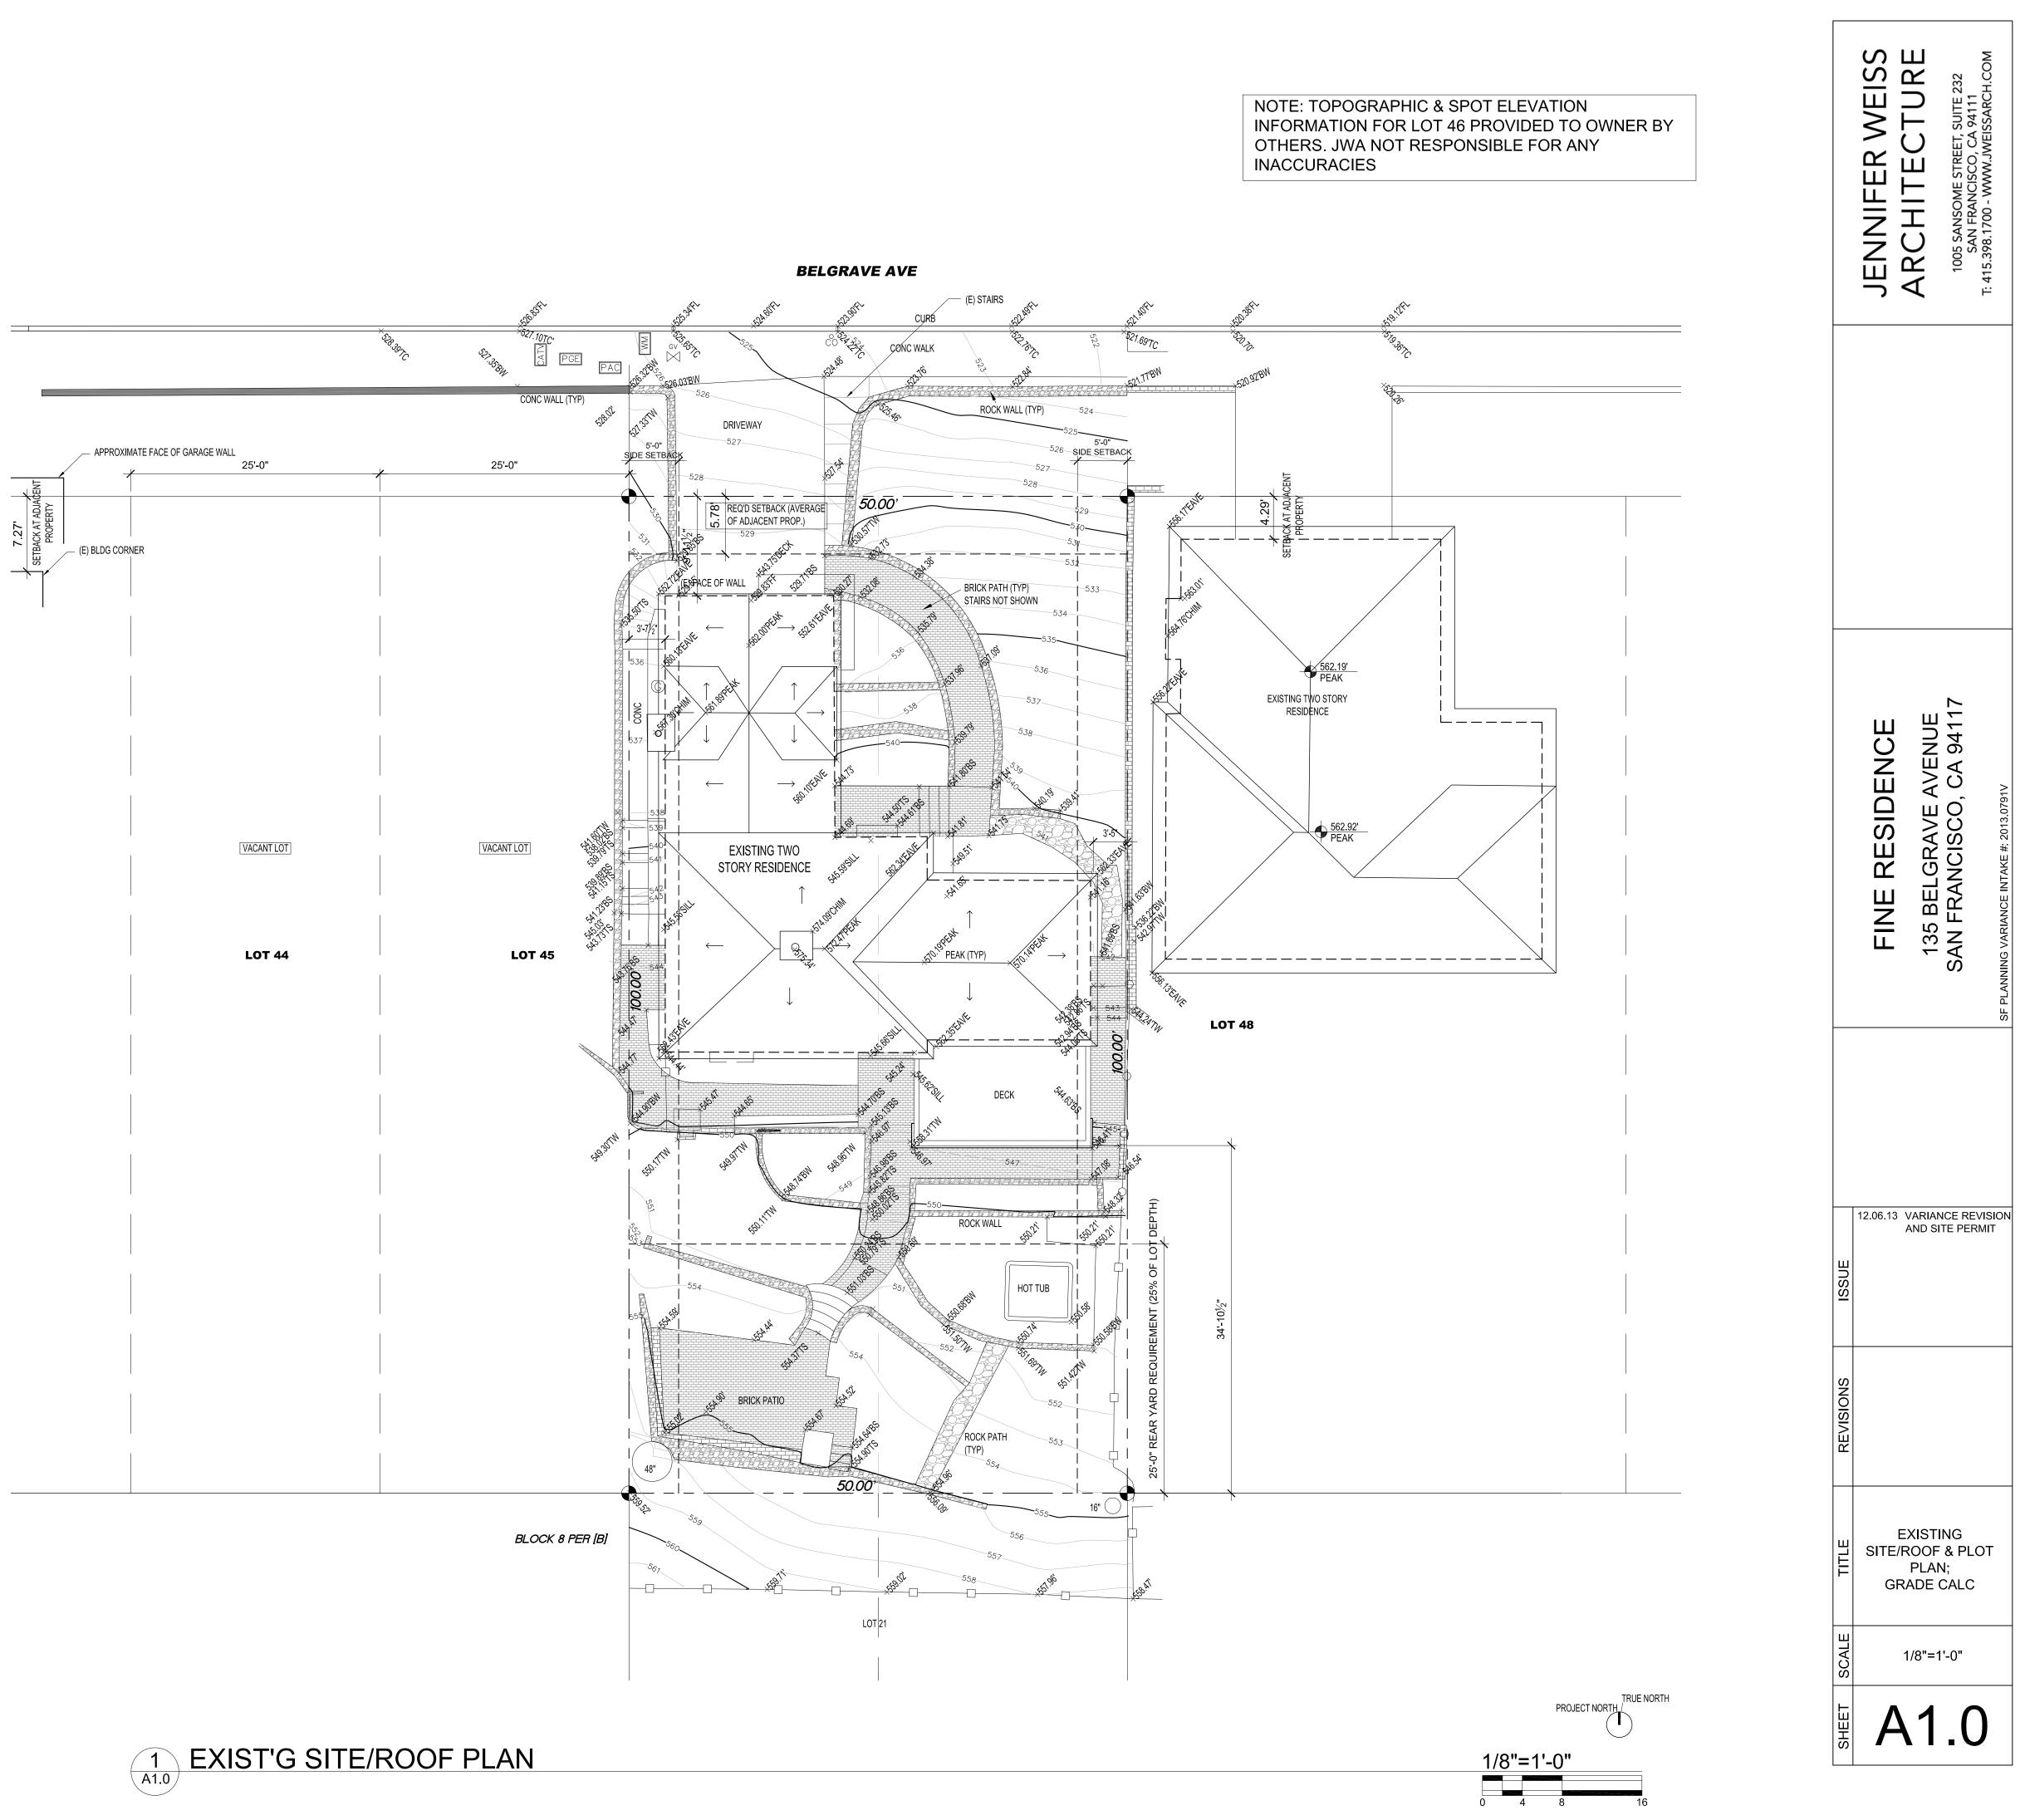


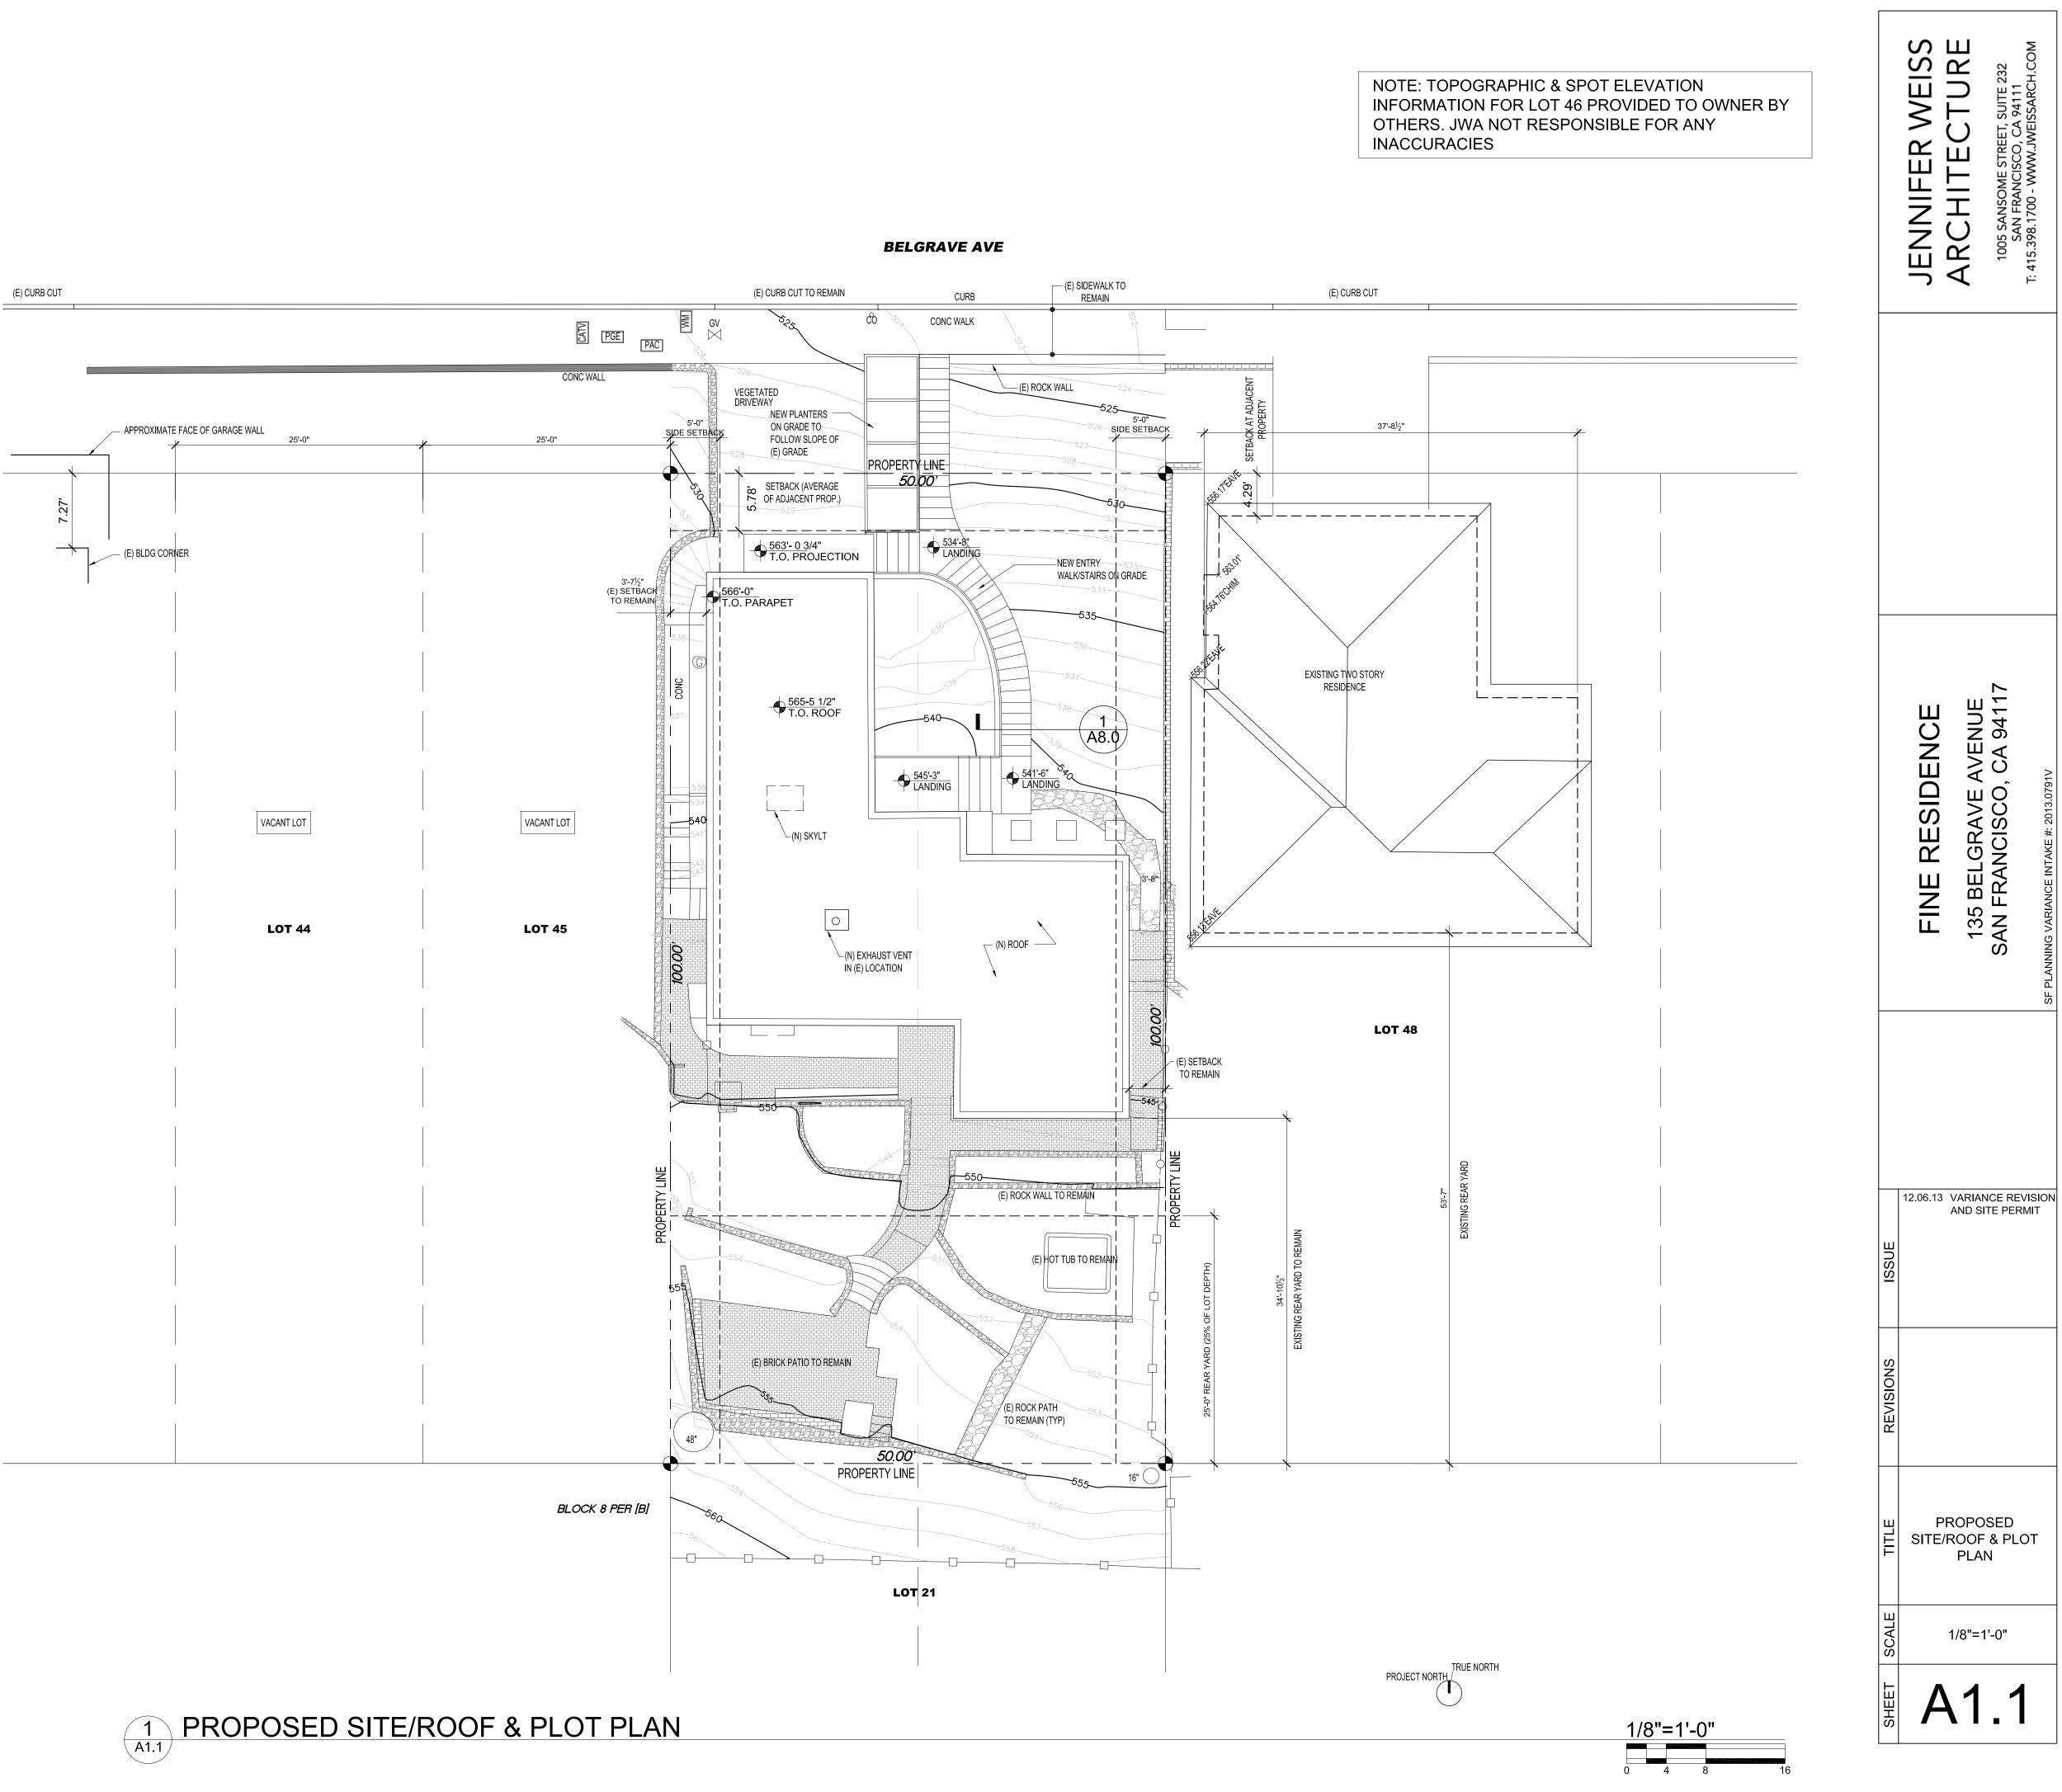

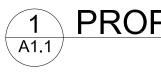

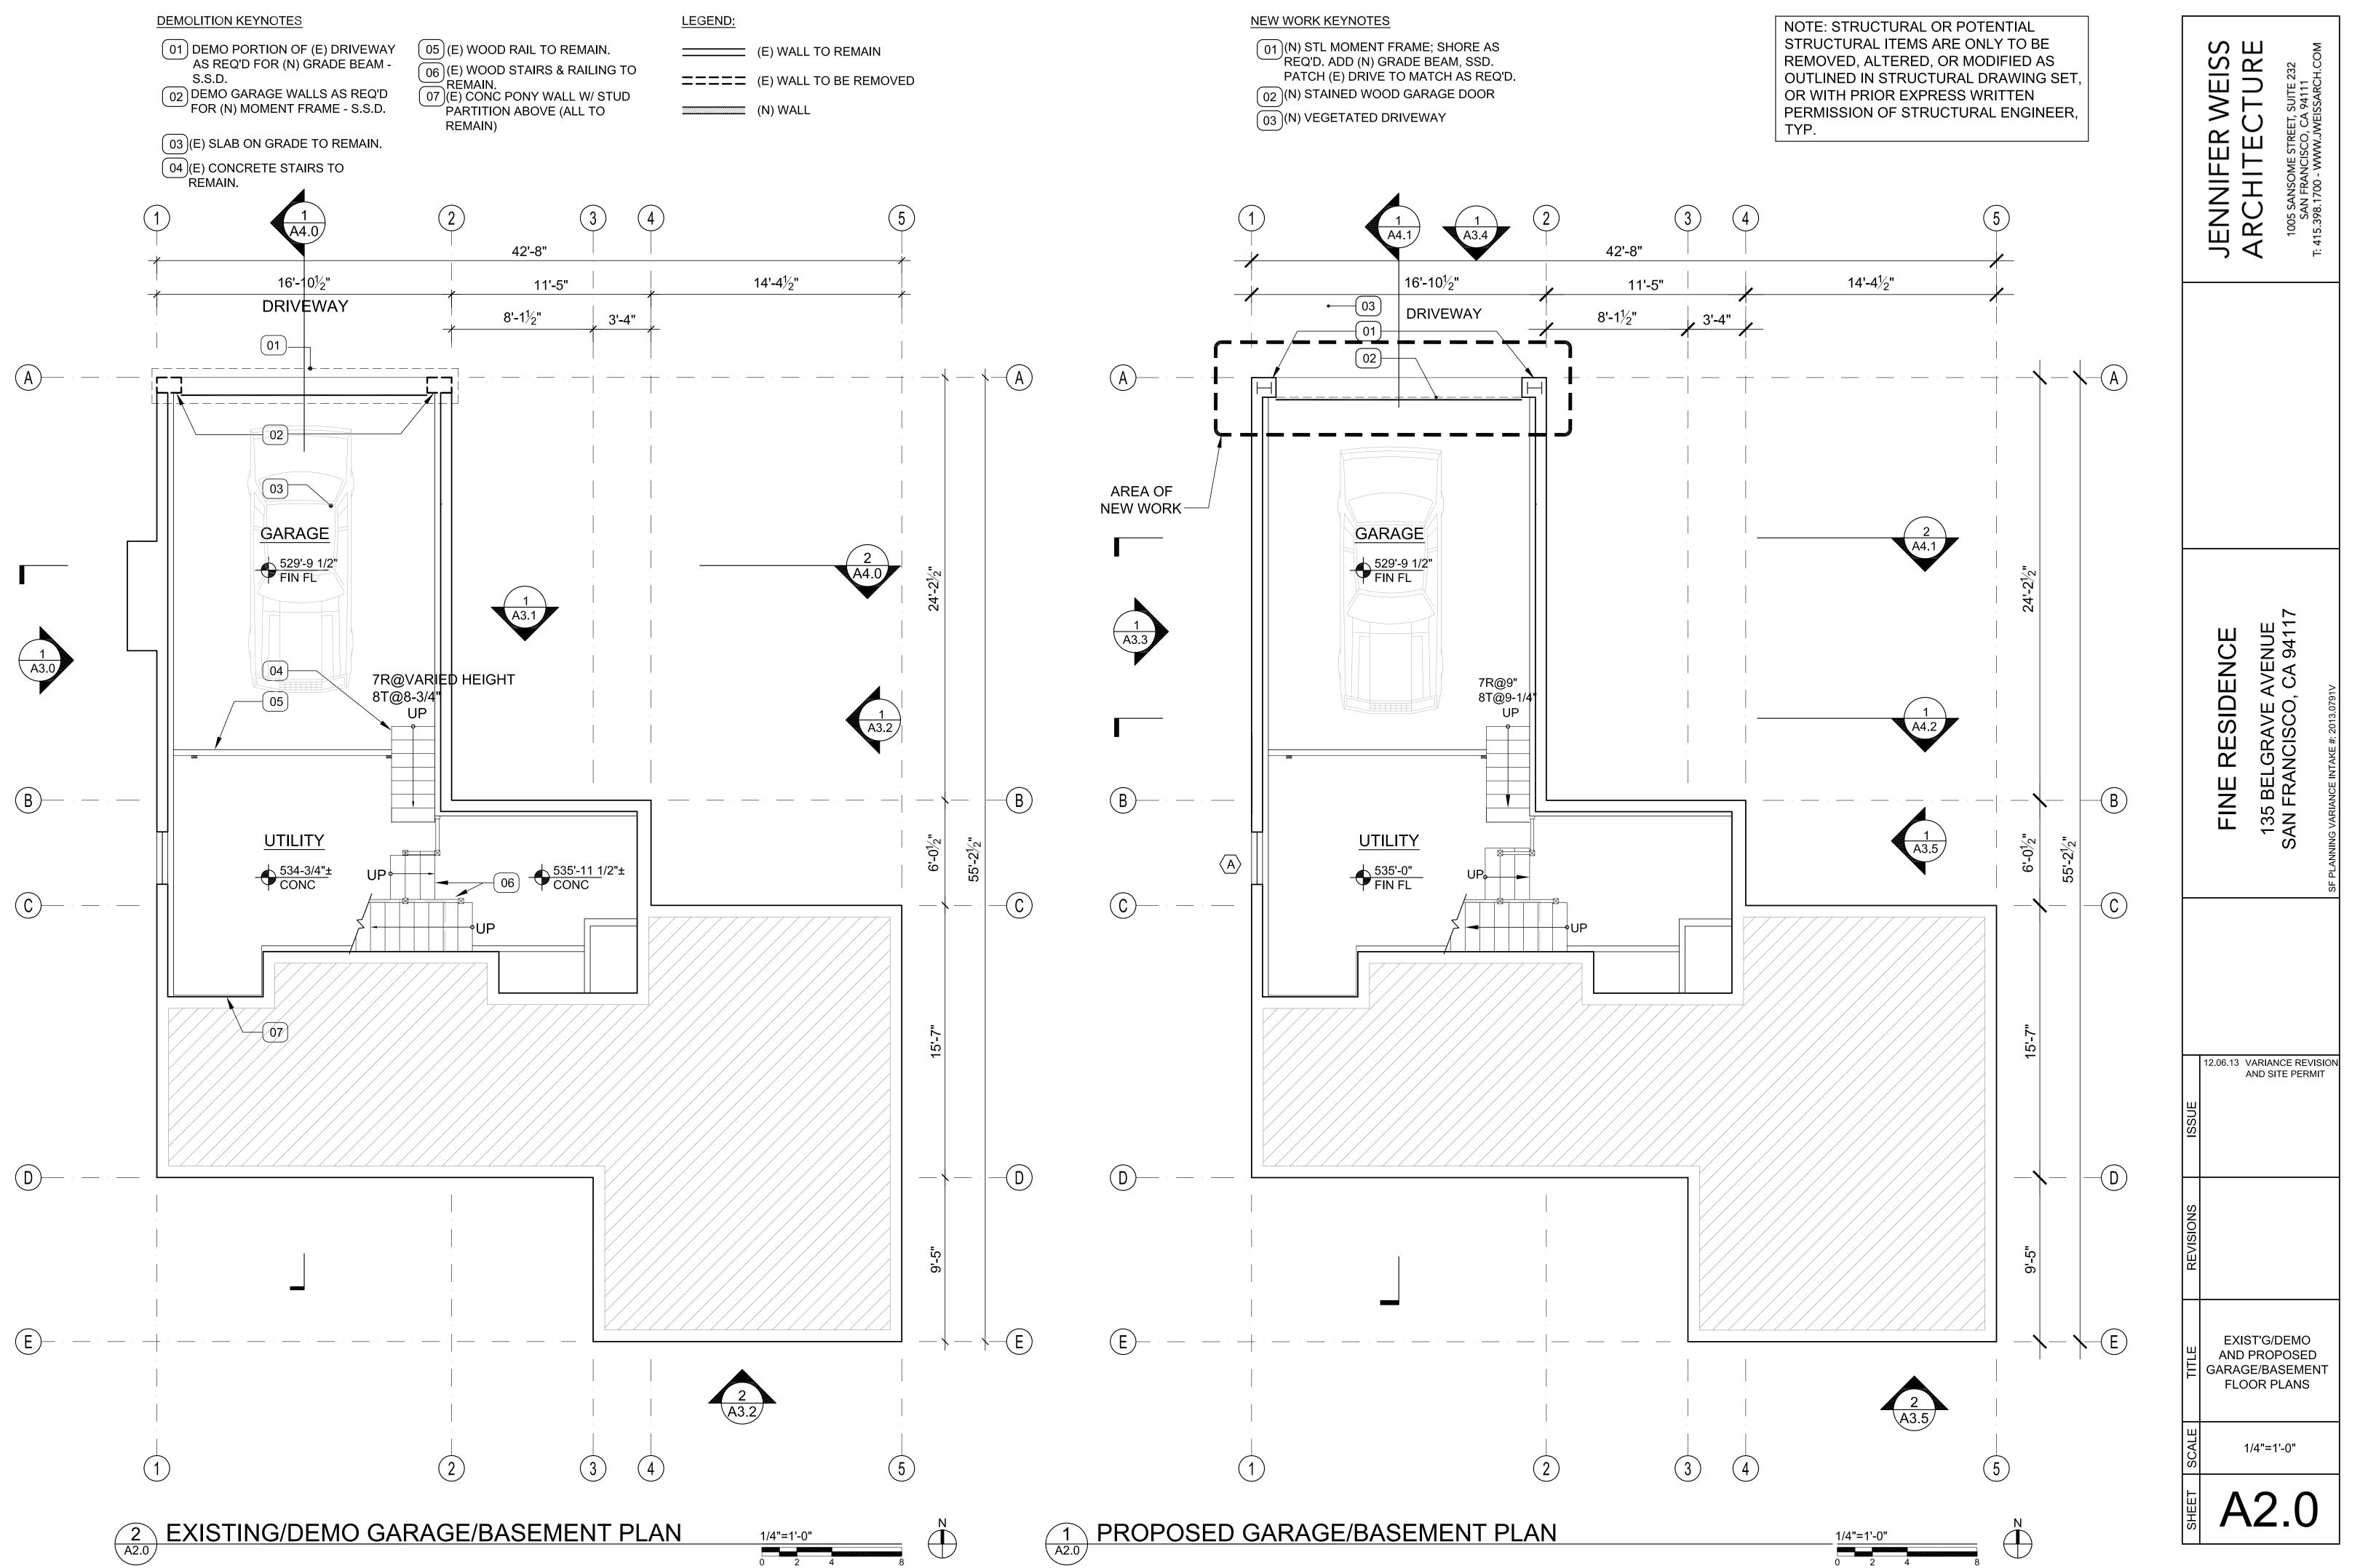

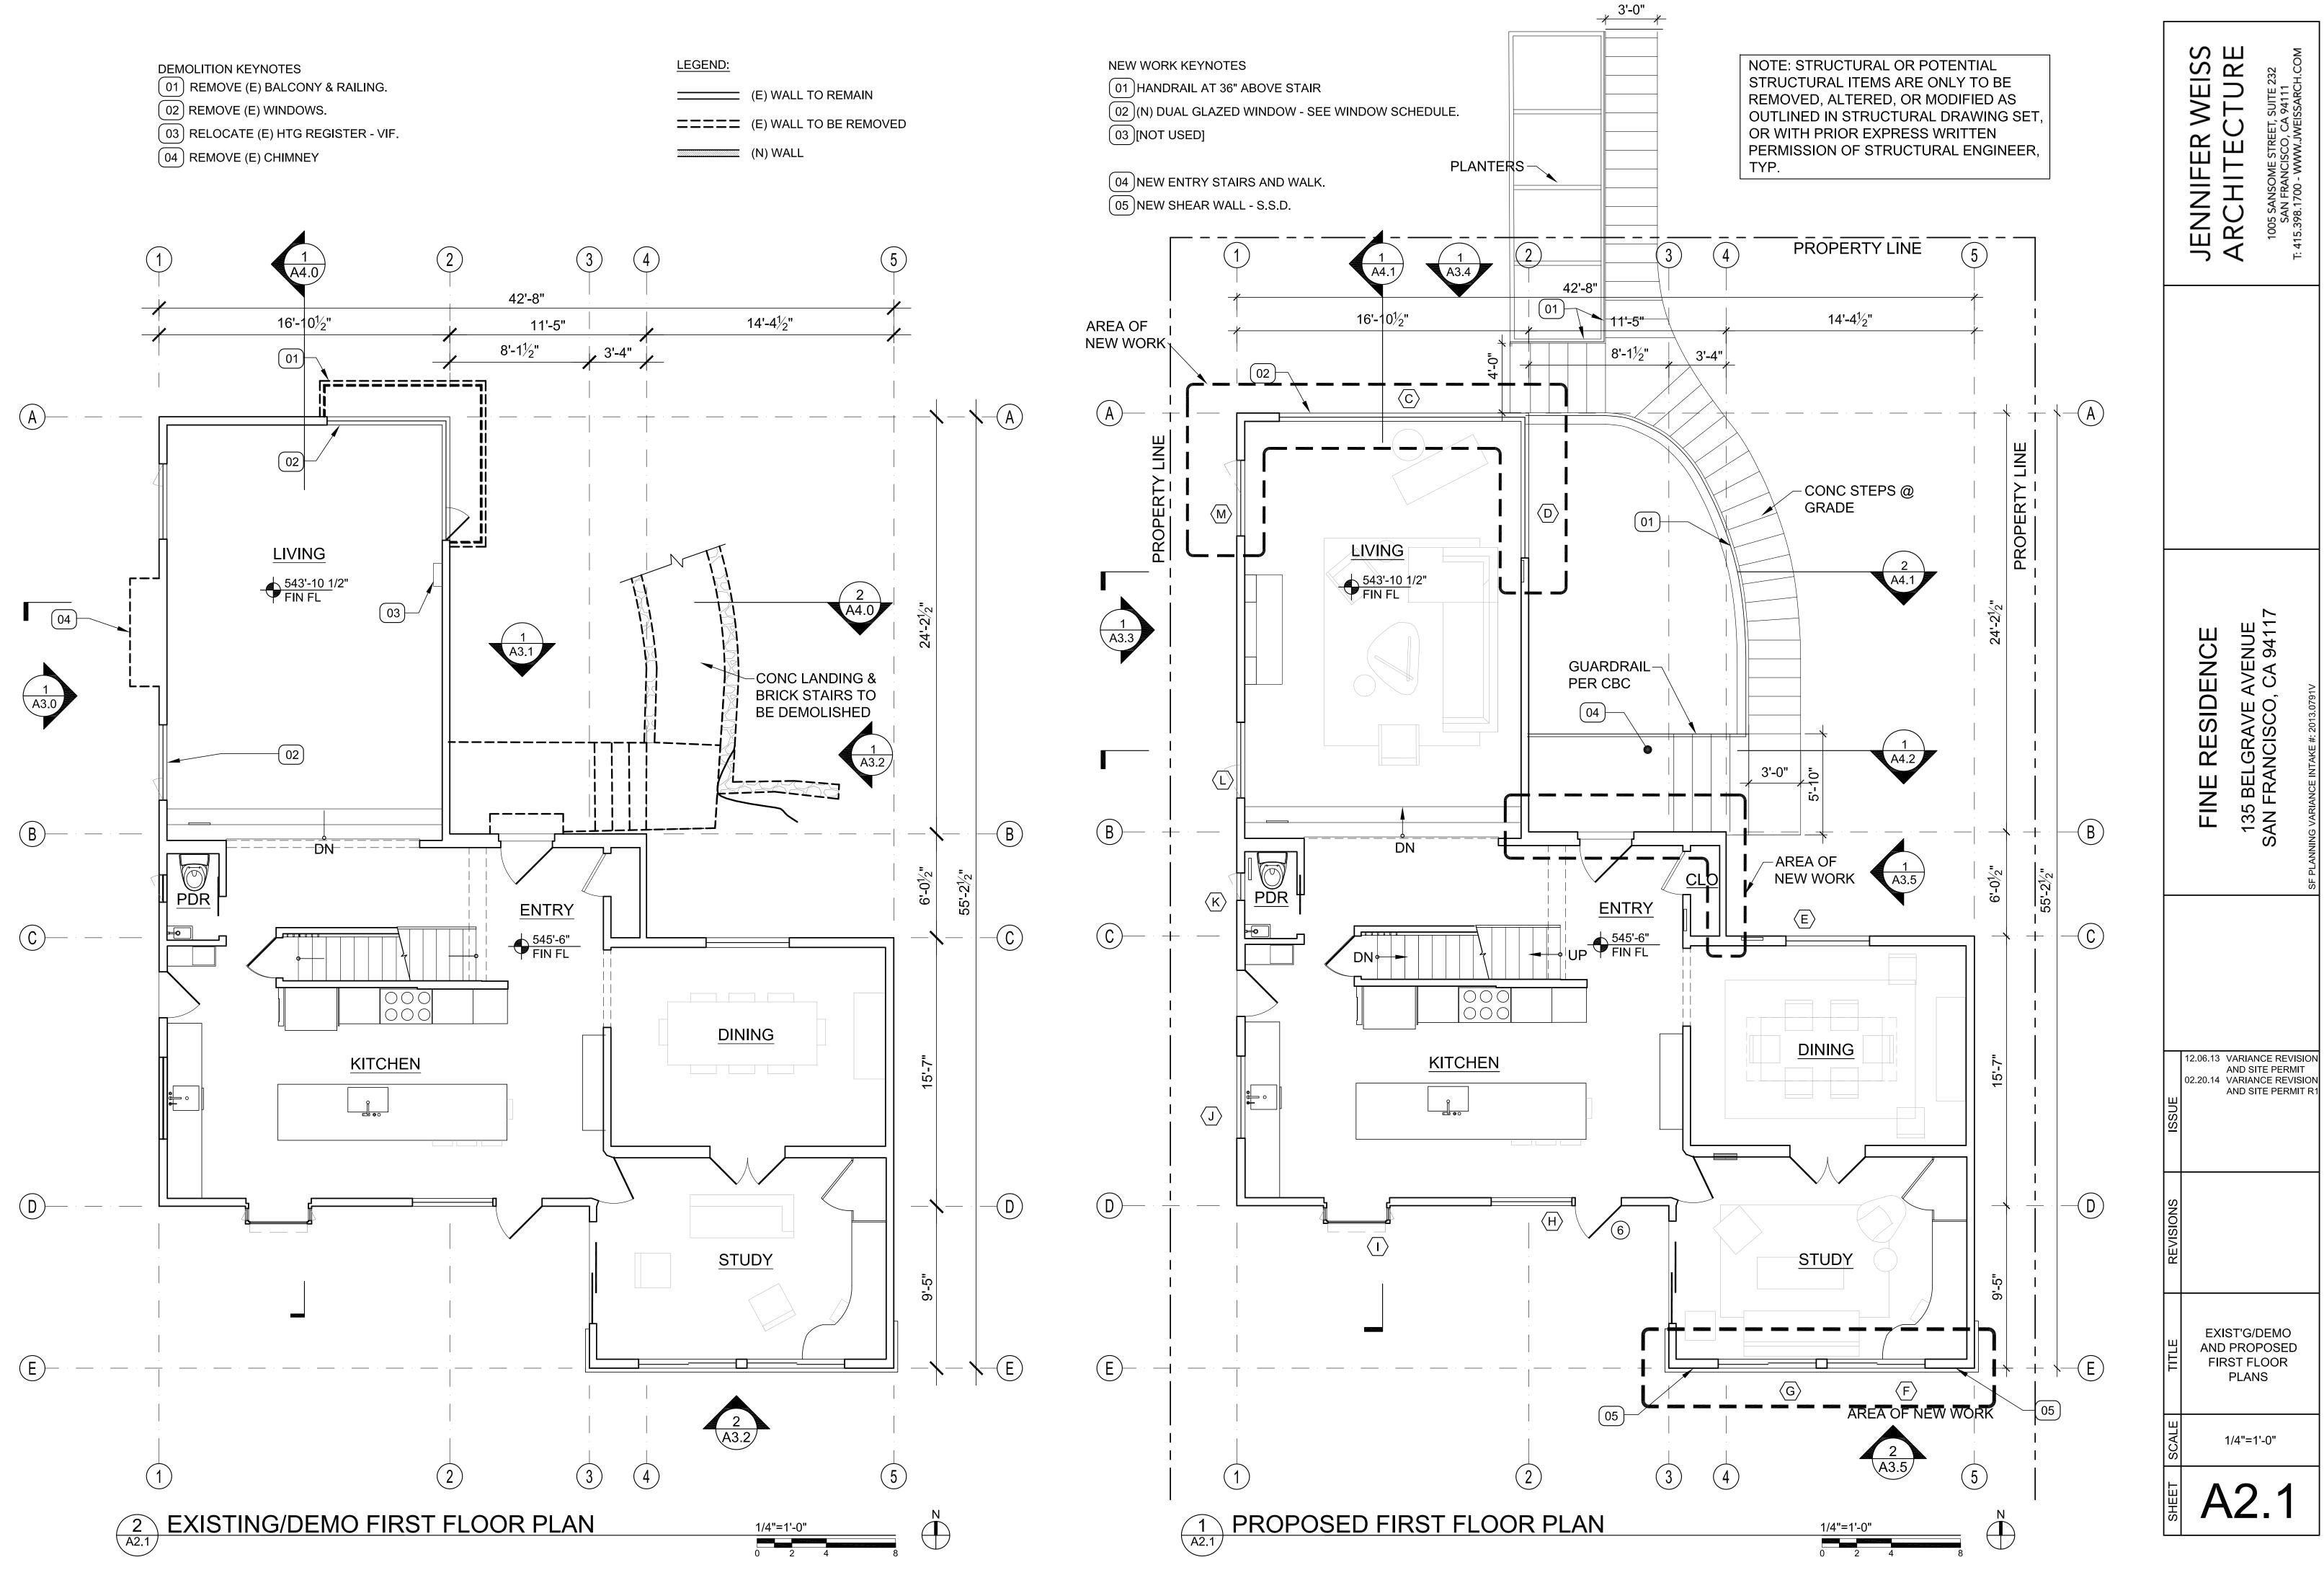

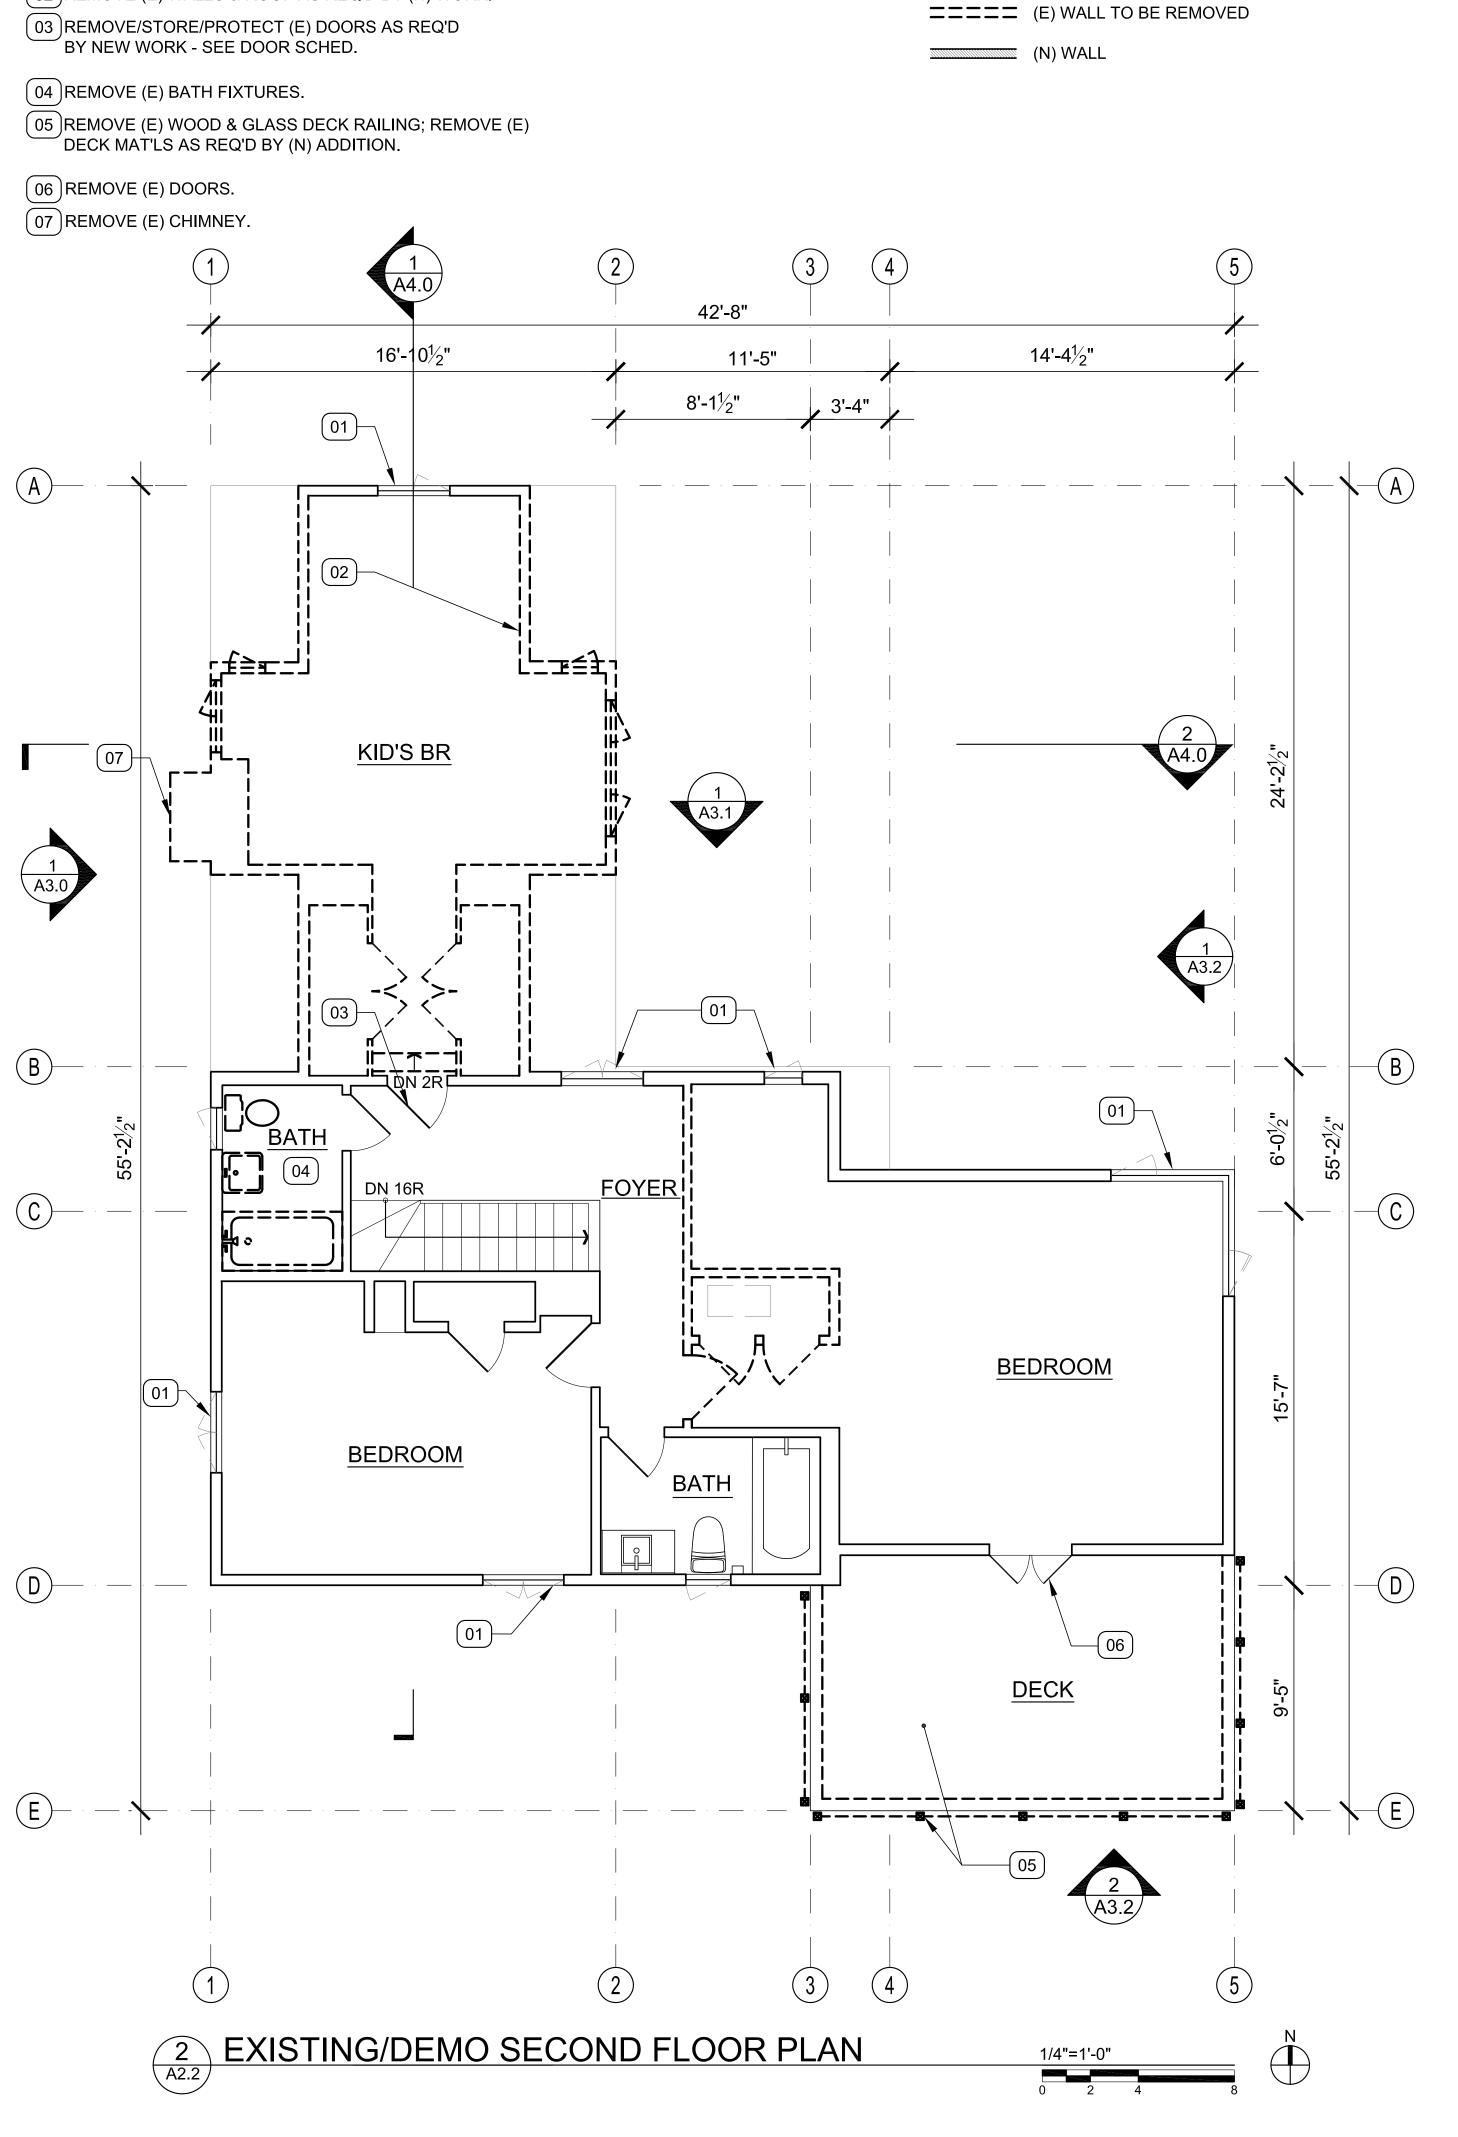

DEMOLITION KEYNOTES: 01 REMOVE (E) WDWS.

(02) REMOVE (E) WALLS & ROOF AS REQ'D BY (N) WORK.

LEGEND:

(E) WALL TO REMAIN

NEW WORK KEYNOTES:

(03)(NOT USED)

(04) (NOT USED)

M. BATH

(01)(N) DUAL GLAZED WINDOW - SEE SCHED.

(05)(N) LAV, CAB, COUNTERTOP, TOILET, TILE


(06) NEW STORAGE/BENCH CASEWORK.

SHOWER & GLASS PARTITIONS / DOORS AT

(02) LINE OF (N) RAISED CLG ABOVE.

- (08) (N) SKYLT ABV SHOWER.
- (09) (N) W-1 FLOORING TO MATCH (E) @ 1ST FL -PROVIDE ALLOWANCE BASED ON SQ. FTG.

- (11) (E) ATTIC ACCESS TO BE RELOCATED.
- (12) (N) GREENHOUSE WDW SIM. TO (E) AT 1ST FL.
- (13) (NOT USED)
- (14) (N) TILE FLOOR T-1

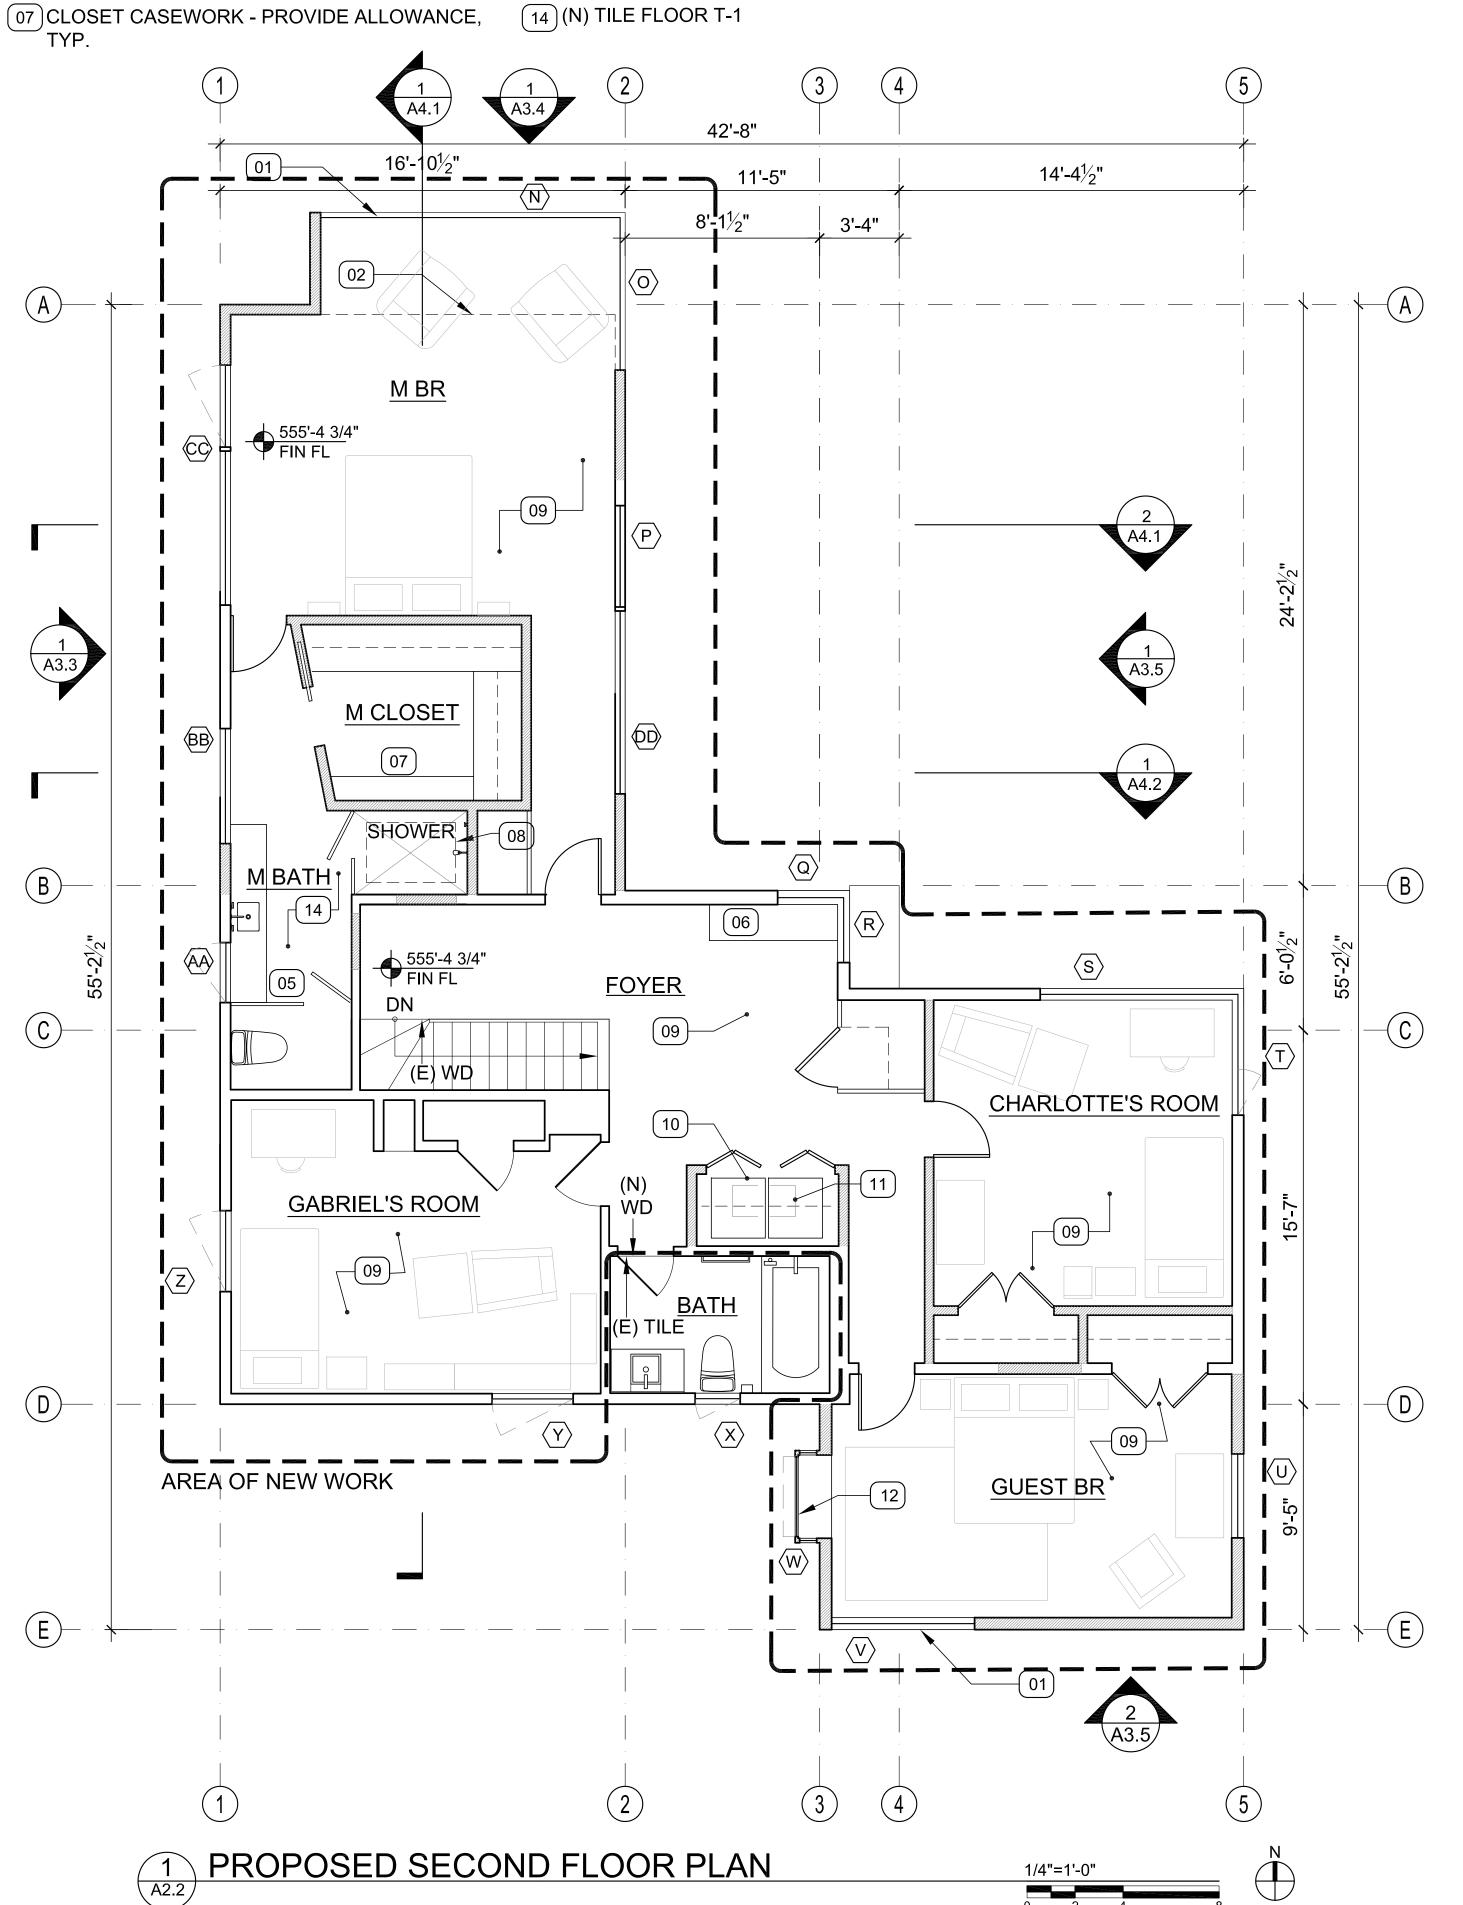


(10) (N) PTD GWB WALLS, TYP. (E) W/D TO BE RELOCATED.

NOTE: STRUCTURAL OR POTENTIAL STRUCTURAL ITEMS ARE ONLY TO BE REMOVED, ALTERED, OR MODIFIED AS OUTLINED IN STRUCTURAL DRAWING SET OR WITH PRIOR EXPRESS WRITTEN PERMISSION OF STRUCTURAL ENGINEER, TYP.

	JENNIFER WEISS		1005 SANSOME STREET, SUITE 232 SAN FRANCISCO, CA 94111 T: 415 308 1700 - WAMMAN INVERSABCH COM	
	FINE RESIDENCE	135 BELGRAVE AVENUE	SAN FRANCISCO, CA 94117	SF PLANNING VARIANCE INTAKE #: 2013.0791V
ISSUE	2.20.14	AND SIT VARIAN	CE REVIS TE PERM CE REVIS TE PERM	IT SION
REVISIONS				
TITLE	AND		POSED FLOOR	
SCALE		1/4"=1	'-0"	
SHEET	A	2	.2	



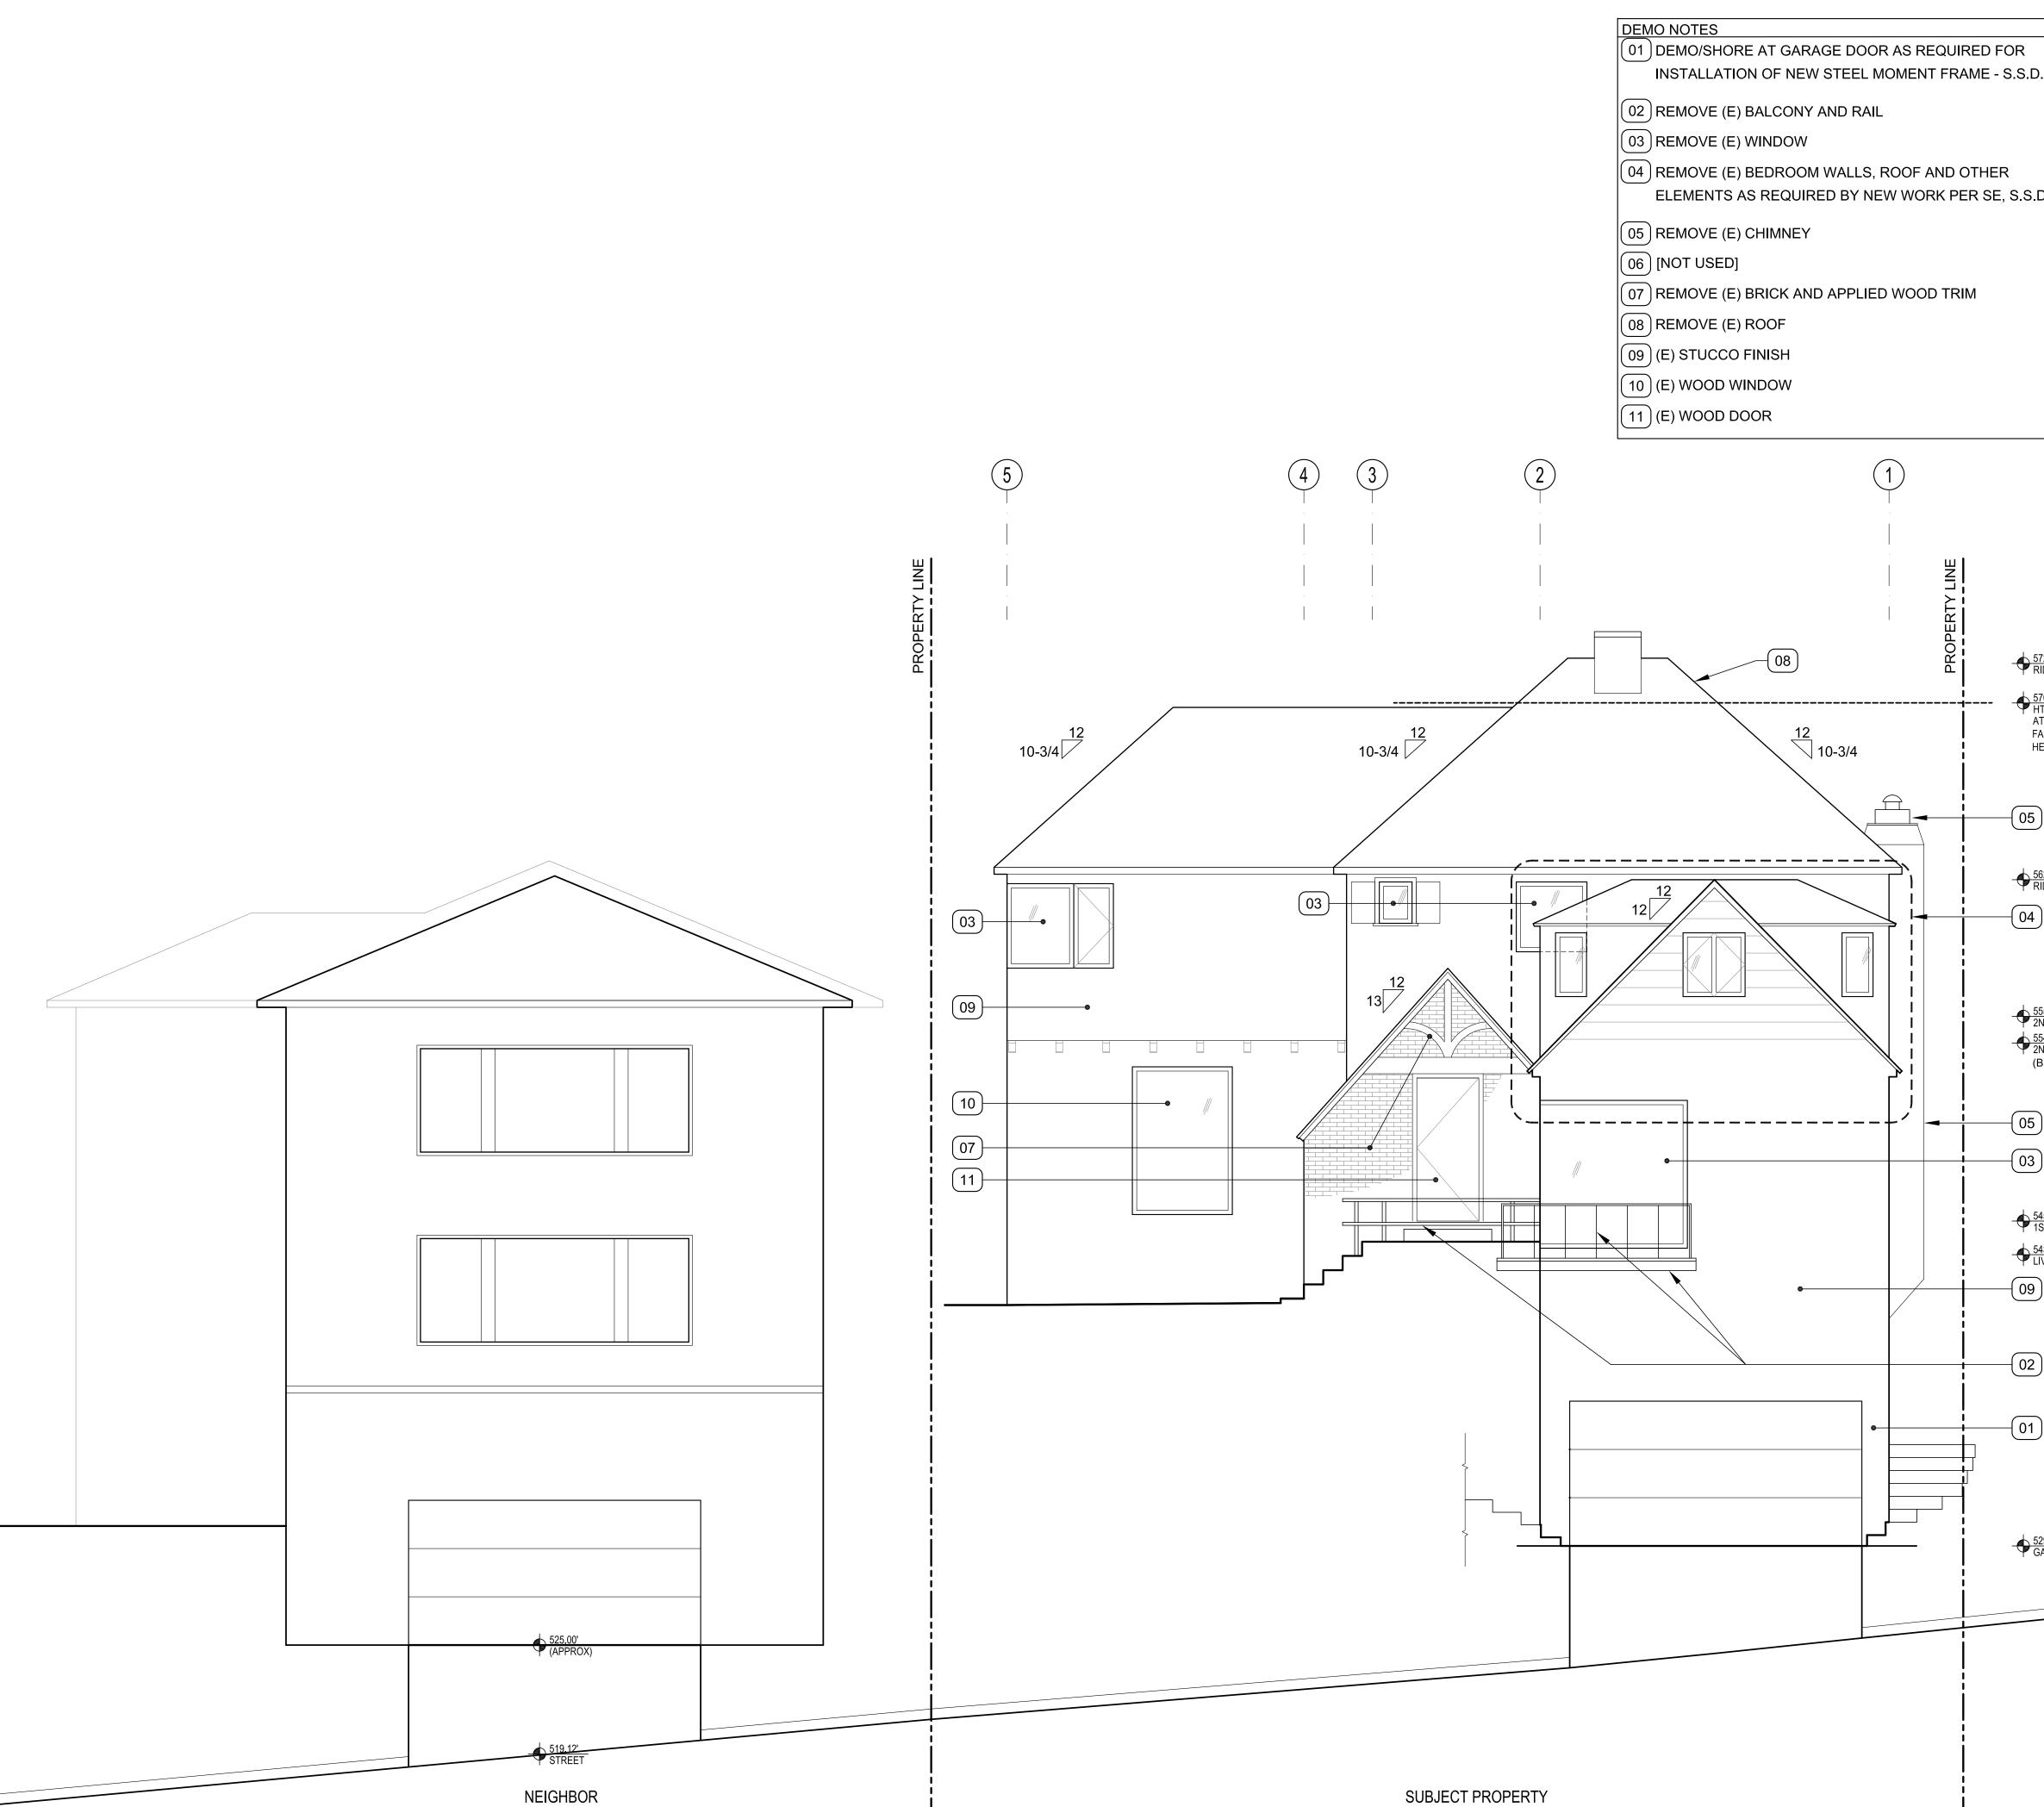

SUBJECT PROPERTY

RED	FOR
ME	- S.S.D.

OR S.S.D. R , S.S.D.	NOTE: STRUCTURAL OR POTENTIAL STRUCTURAL ITEMS ARE ONLY TO BE REMOVED, ALTERED, OR MODIFIED AS OUTLINED IN STRUCTURAL DRAWING SET, OR WITH PRIOR EXPRESS WRITTEN PERMISSION OF STRUCTURAL ENGINEER, TYP. NOTE: NEIGHBORING BUILDING ELEVATIONS ARE APPROXIMATE, TYP. KEY (E) = EXISTING (N) = NEW	JENNIFER WEISS	ARCHITECTURE 1005 SANSOME STREET, SUITE 232 SAN FRANCISCO, CA 94111 T: 415.398.1700 - WWW.JWEISSARCH.COM
			5 BEL FRA
-02 -02 -02 -01 -02 -01 -02 -01 -02 -01 -01 -01 -01 -01 -01 -01 -01			13 VARIANCE REVISION AND SITE PERMIT 14 VARIANCE REVISION AND SITE PERMIT R1
			XISTING/DEMO NORTH EXTERIOR


VACANT LOT (ALSO OWNED BY FINES)

1/4"=1'-0" 0 2 4

NORTH EXTERIOR ELEVATION


1/4"=1'-0"


A3.0

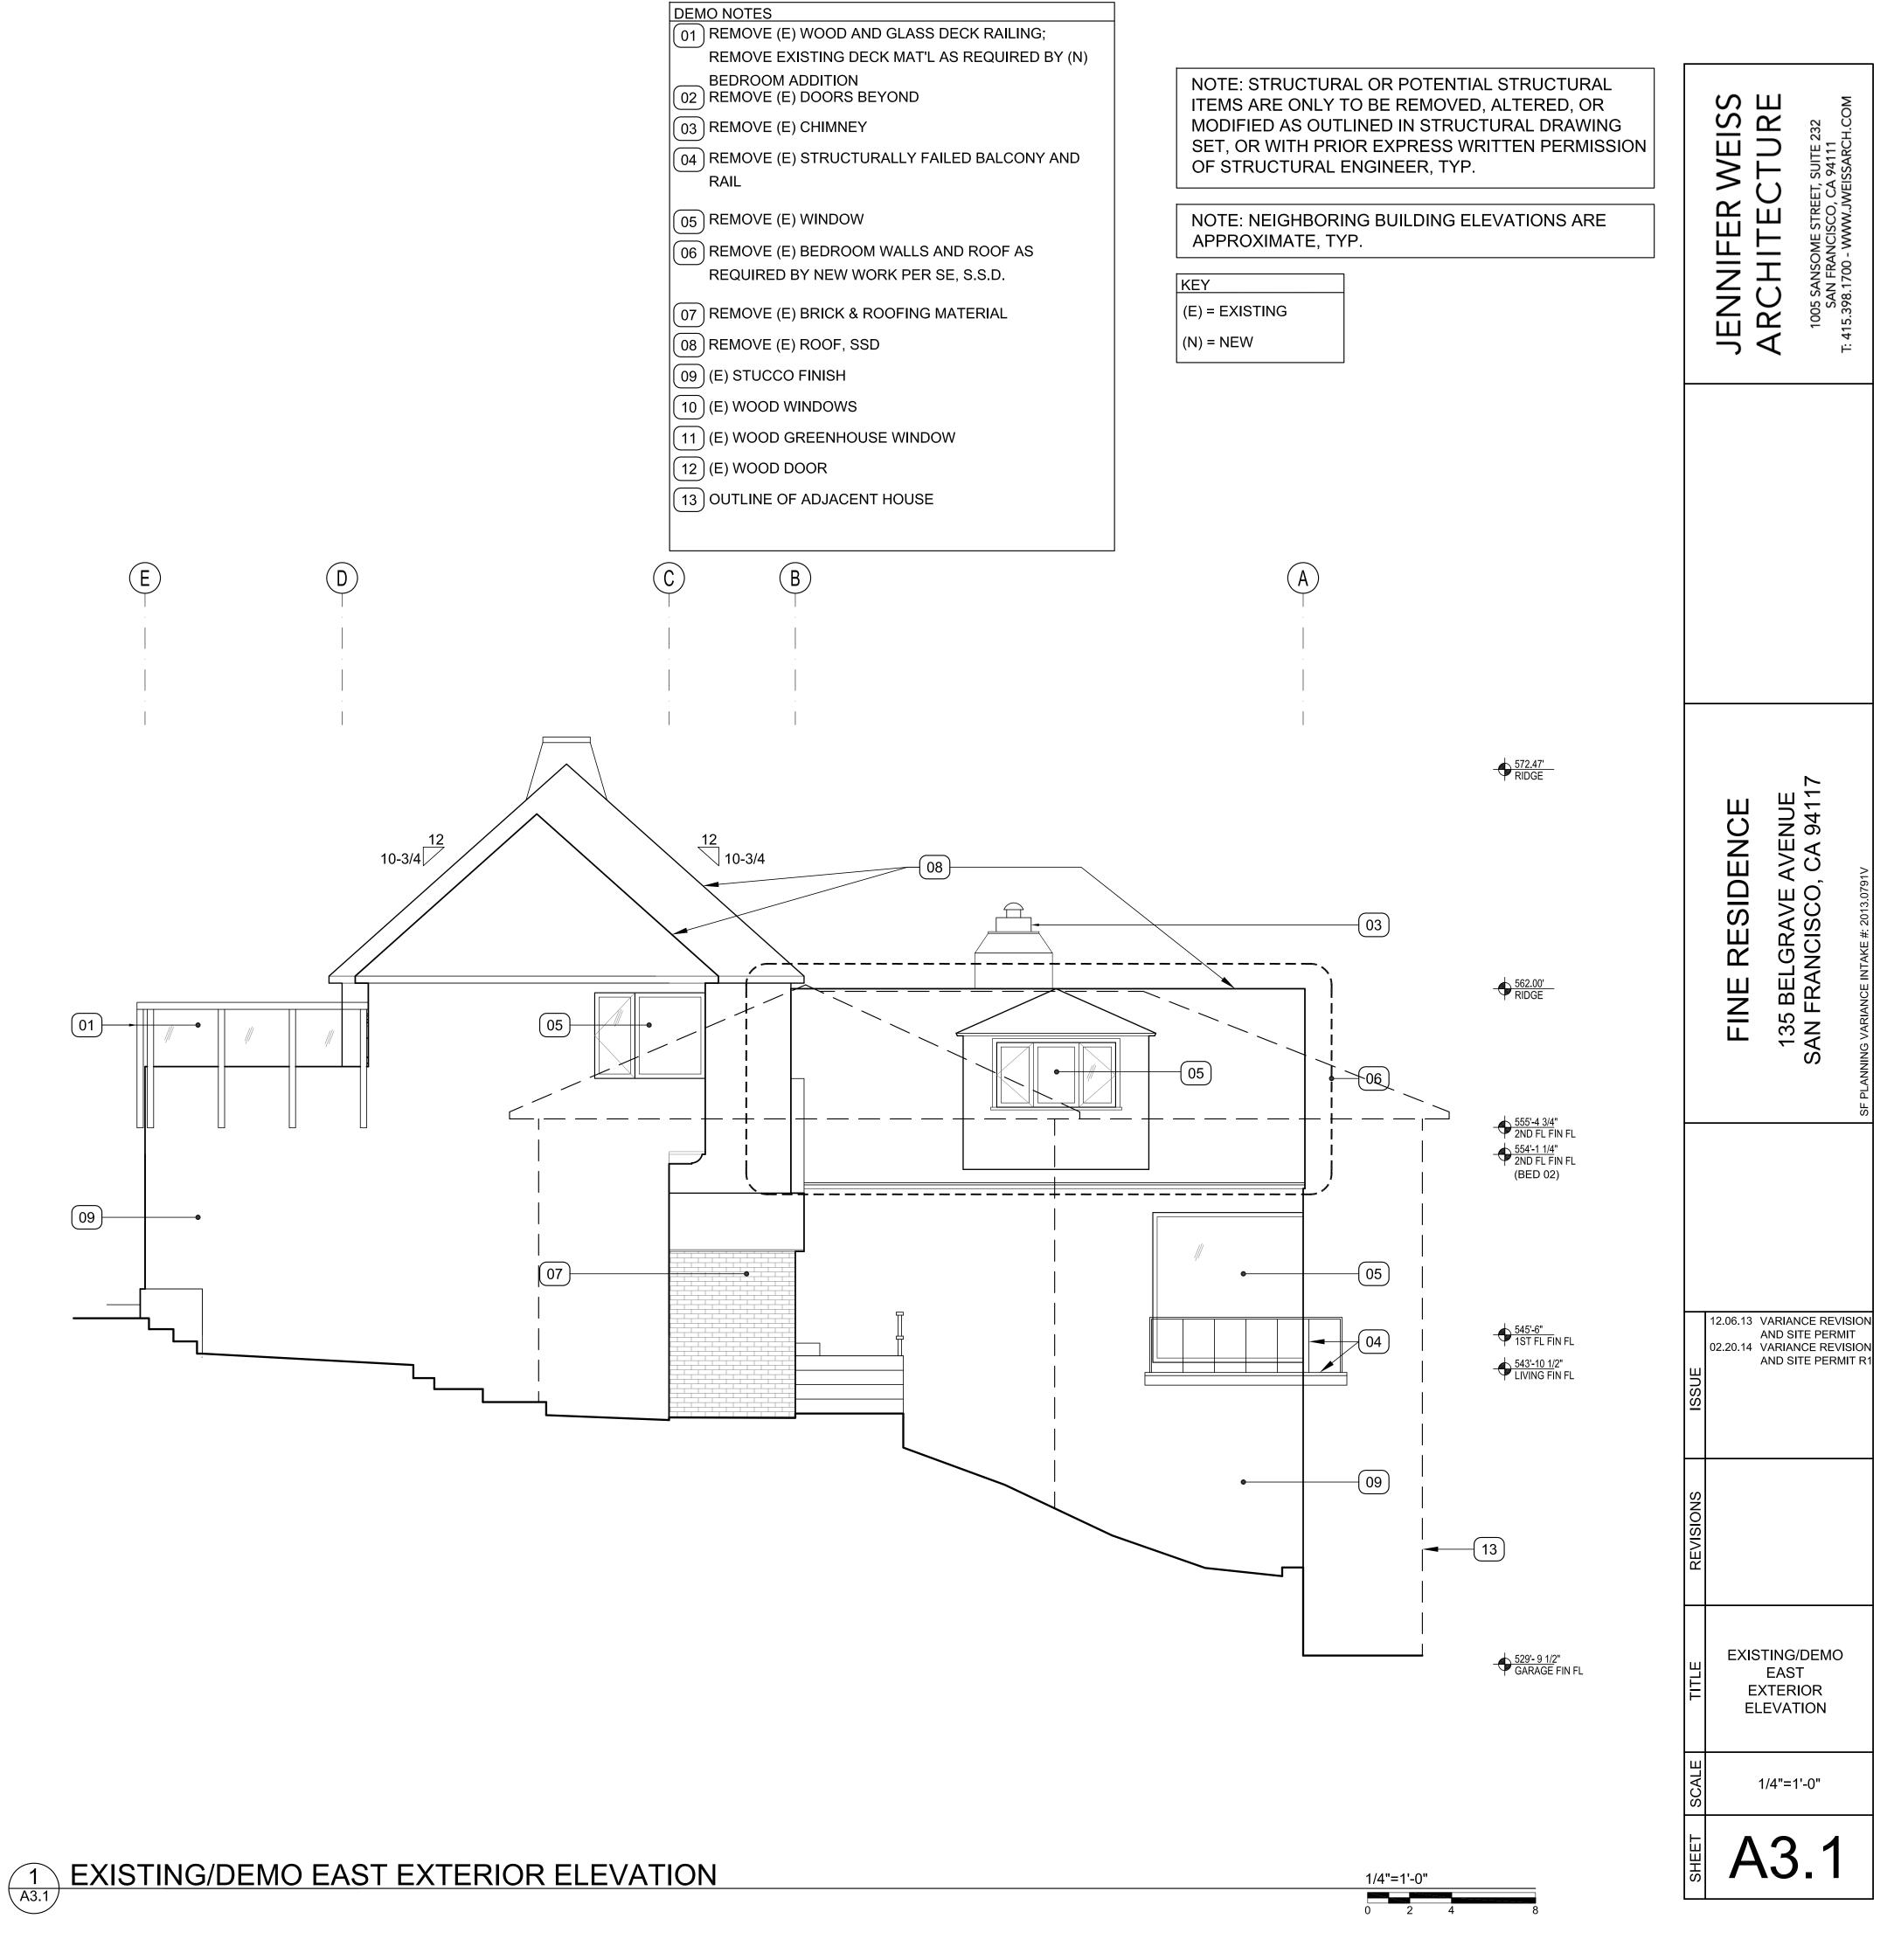



VACANT LOT (ALSO OWNED BY FINES)

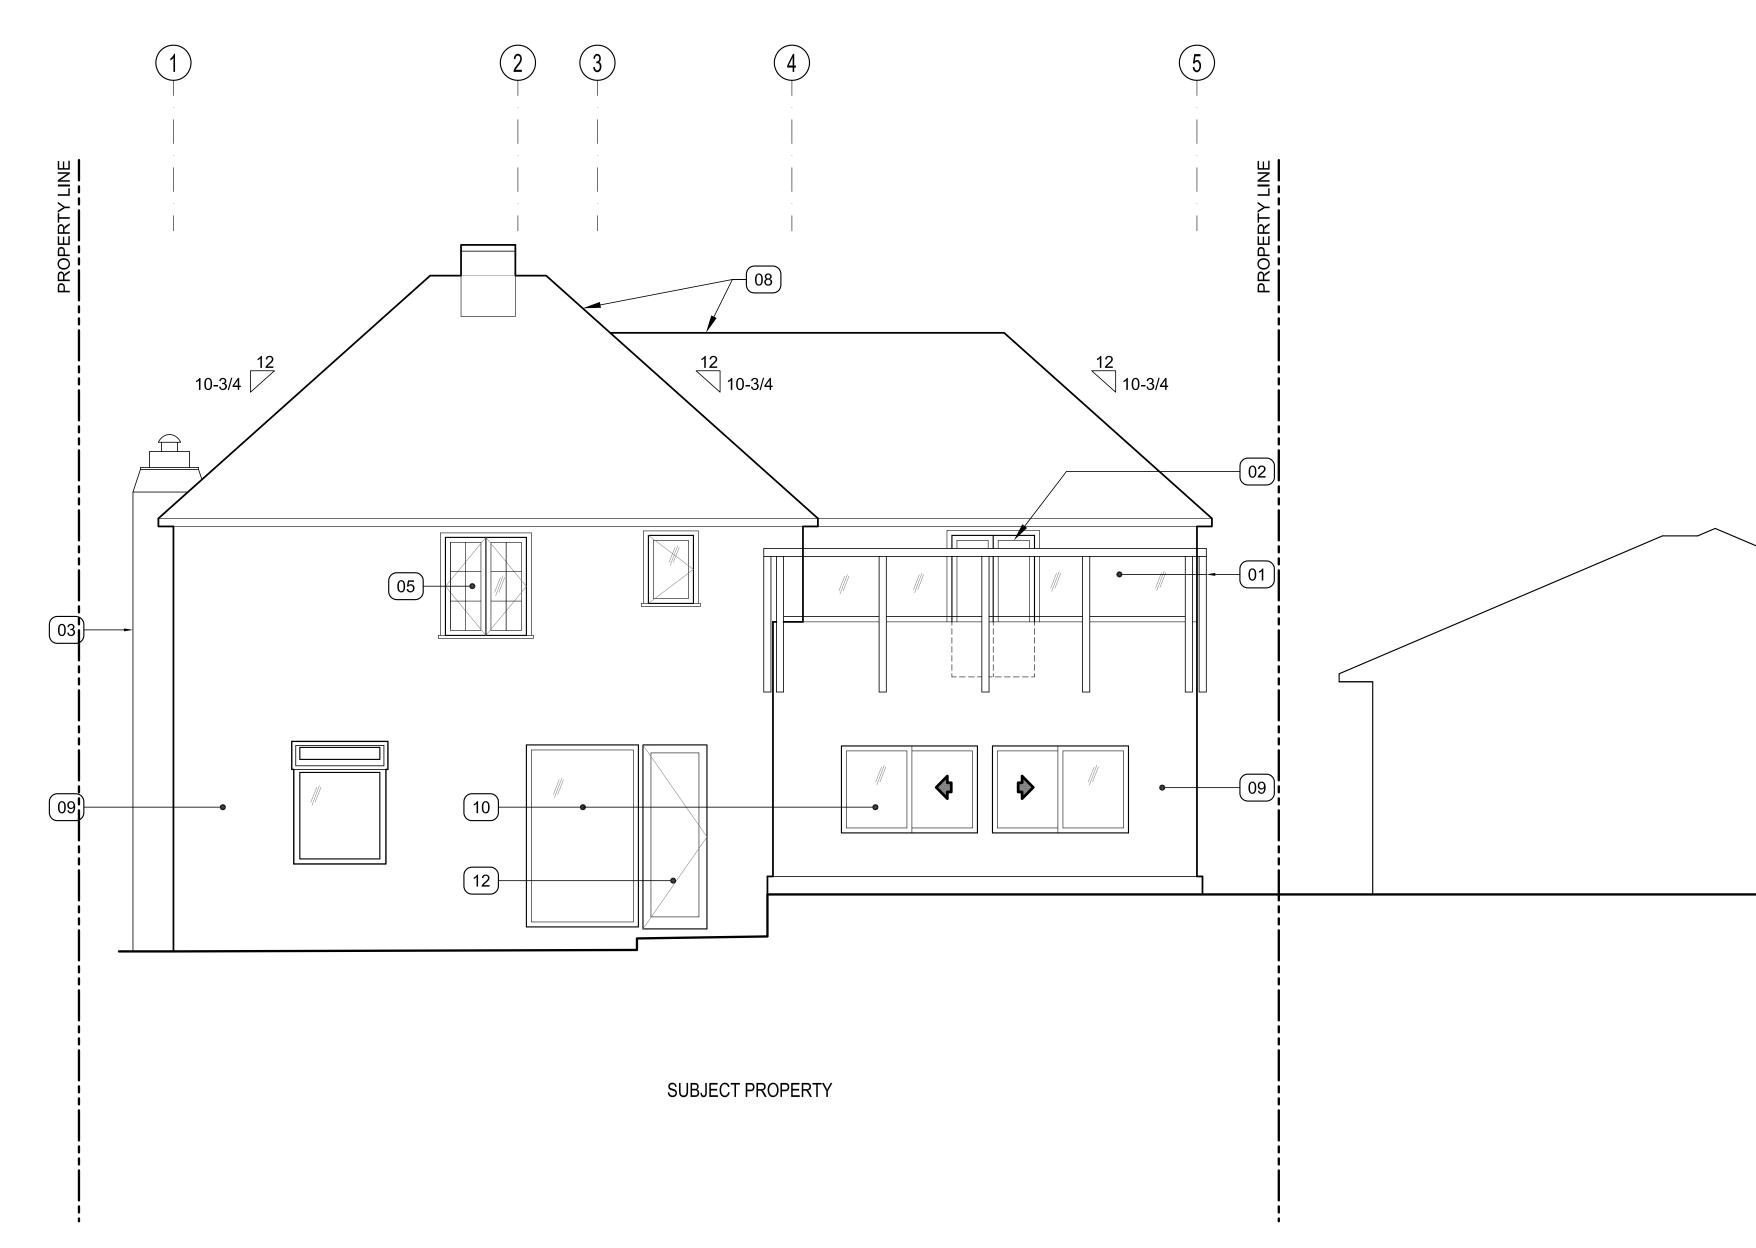

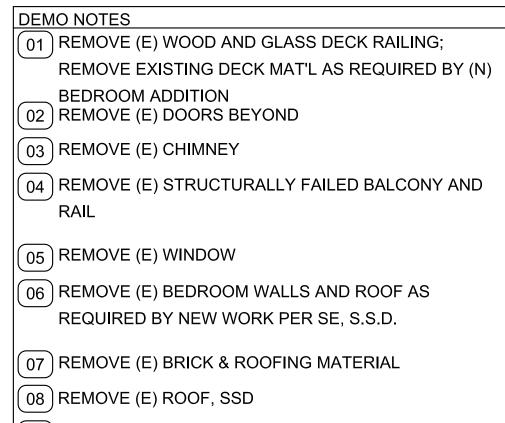

(09) (E) STUCCO FINISH

(10) (E) WOOD WINDOWS

(11) (E) WOOD GREENHOUSE WINDOW

(12) (E) WOOD DOOR

NOTE: STRUCTURAL OR POTENTIAL STRUCTURAL ITEMS ARE ONLY TO BE REMOVED, ALTERED, OR MODIFIED AS OUTLINED IN STRUCTURAL DRAWING SET, OR WITH PRIOR EXPRESS WRITTEN PERMISSION OF STRUCTURAL ENGINEER, TYP. NOTE: NEIGHBORING BUILDING ELEVATIONS ARE APPROXIMATE, TYP. KEY (E) = EXISTING (N) = NEW	JENNIFER WEISS ARCHITECTURE 1005 SANSOME STREET, SUITE 232 SAN FRANCISCO, CA 94111 T: 415.398.1700 - WWW.JWEISSARCH.COM
	FINE RESIDENCE 135 BELGRAVE AVENUE SAN FRANCISCO, CA 94117 SF PLANING VARIANCE INTAKE #: 2013.0791V
	12.06.13 VARIANCE REVISION AND SITE PERMIT 02.20.14 VARIANCE REVISION AND SITE PERMIT R1

ADJACENT NEIGHBOR


1/4"=1'-0" 0 2

EXIST'G/DEMO EXTERIOR

ELEVATIONS


1/4"=1'-0"

A3.2

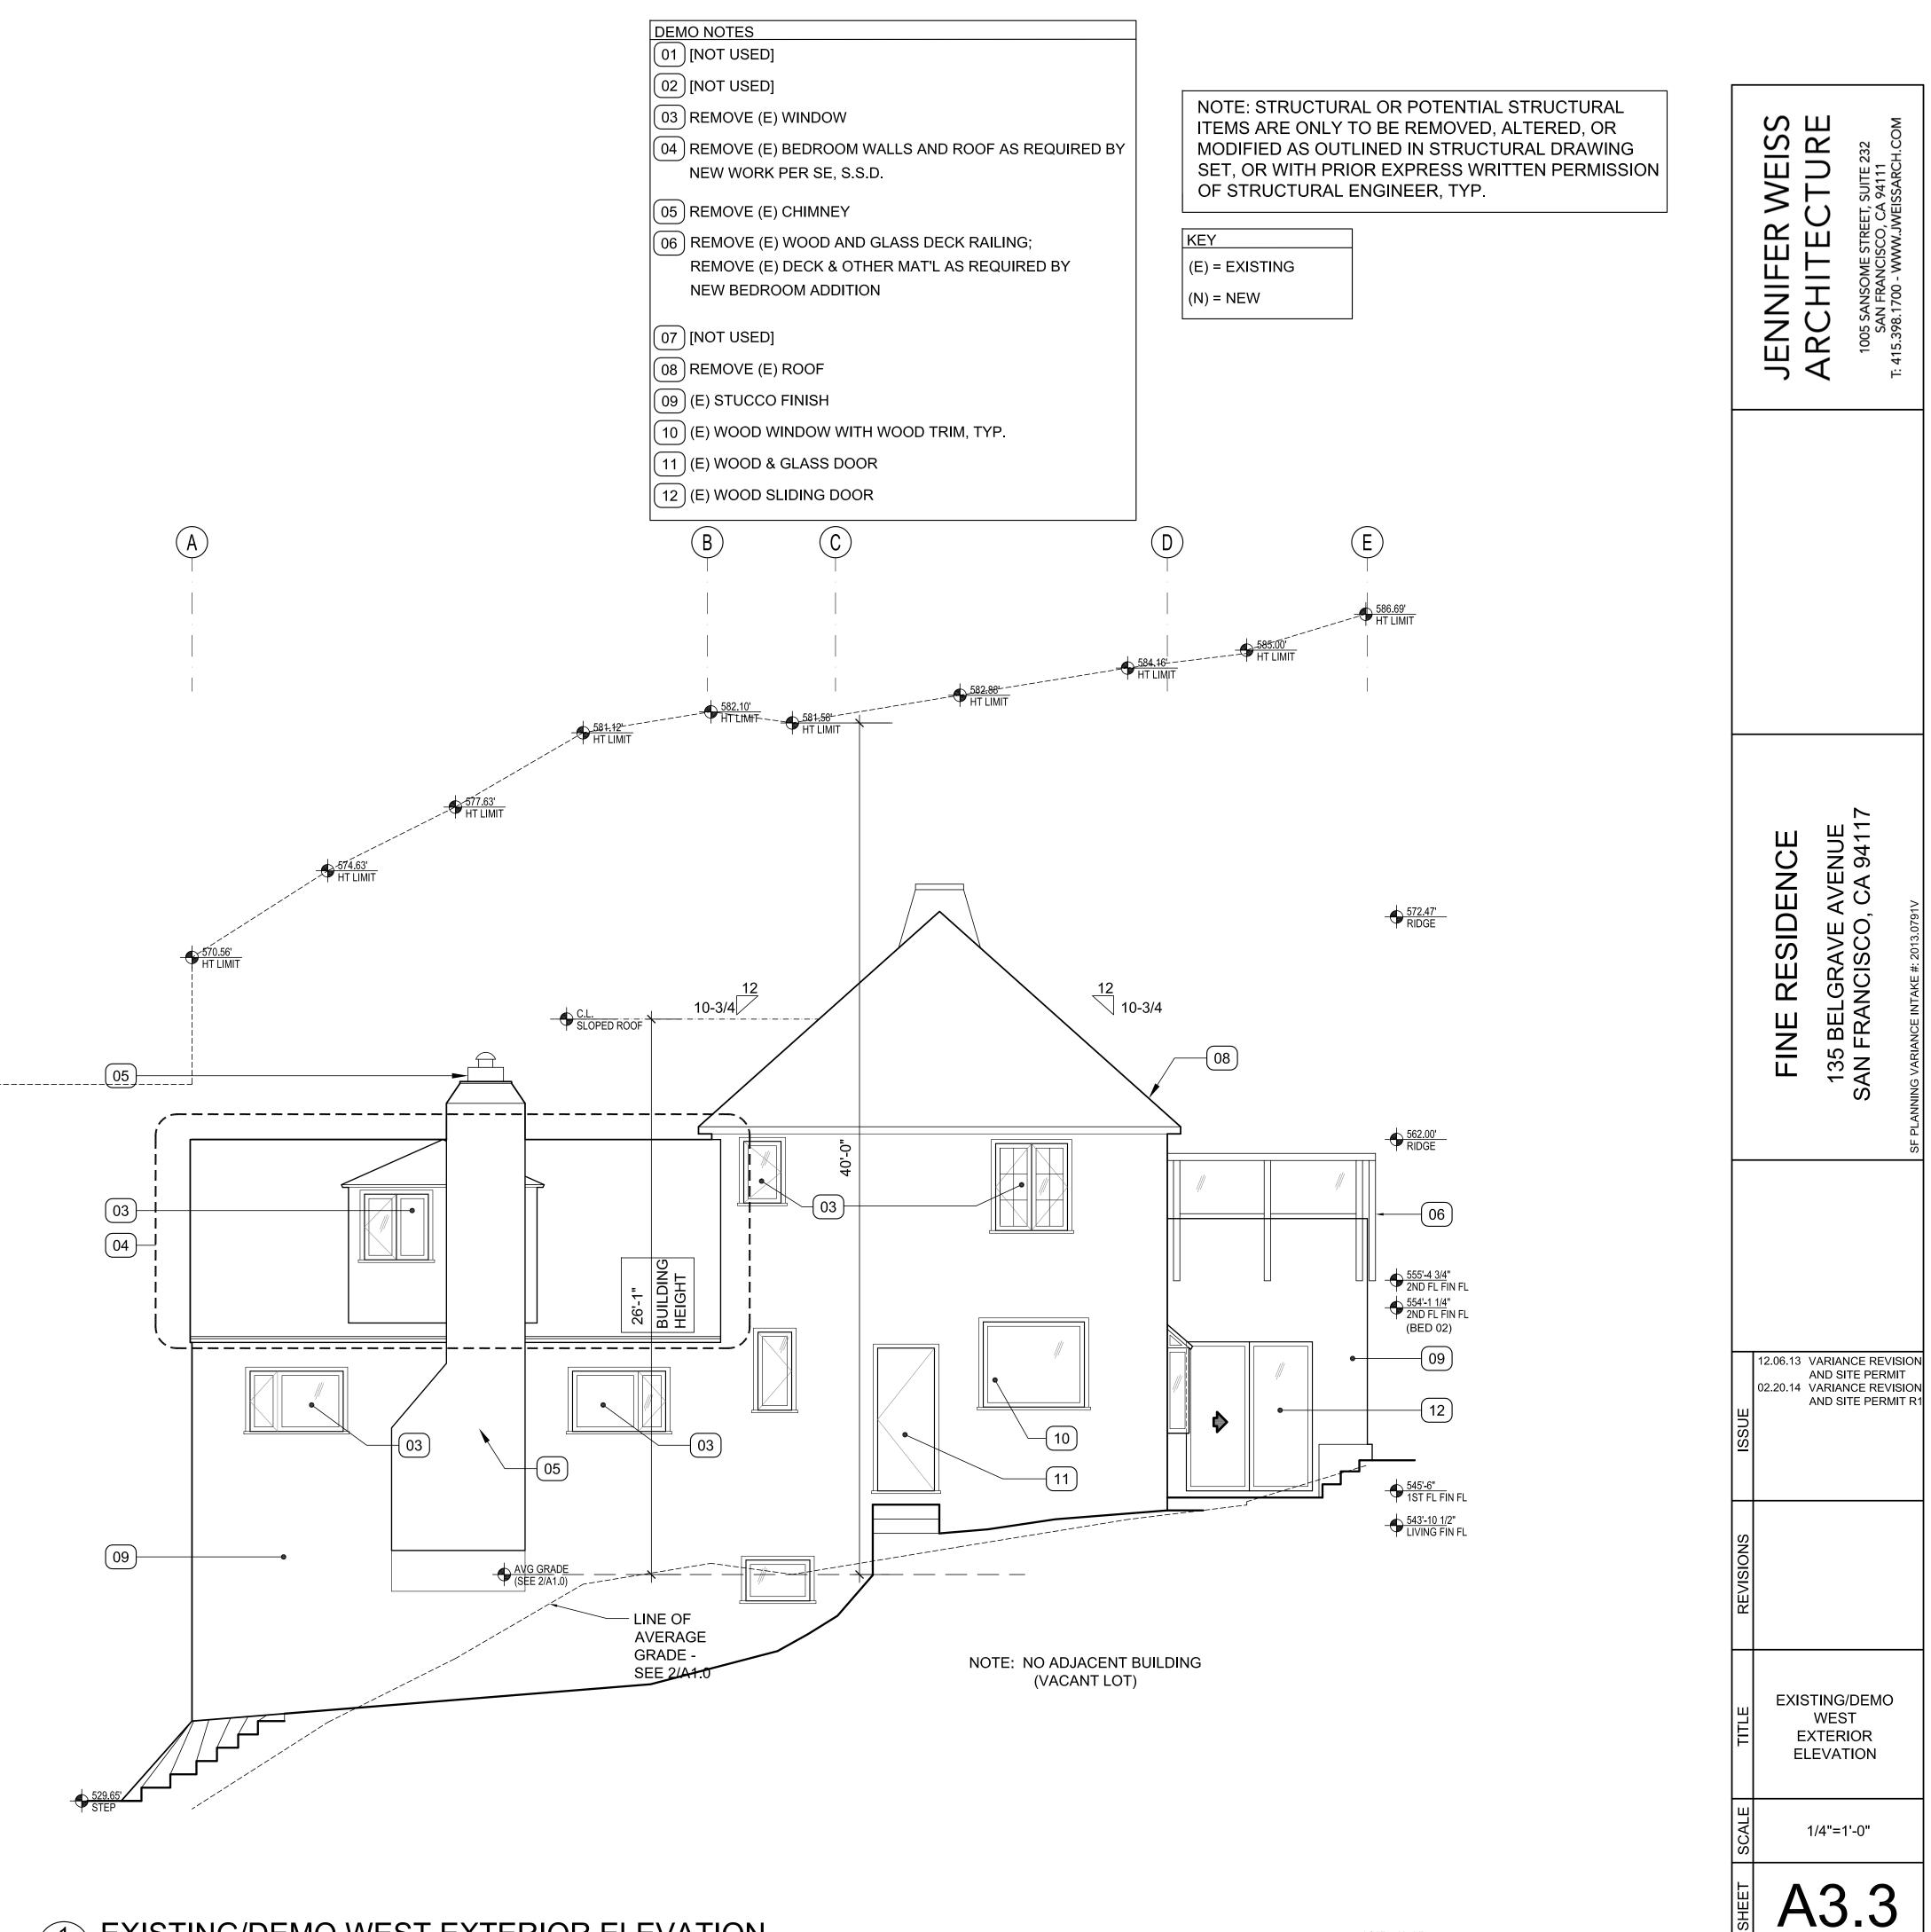

1/4"=1'-0") 2



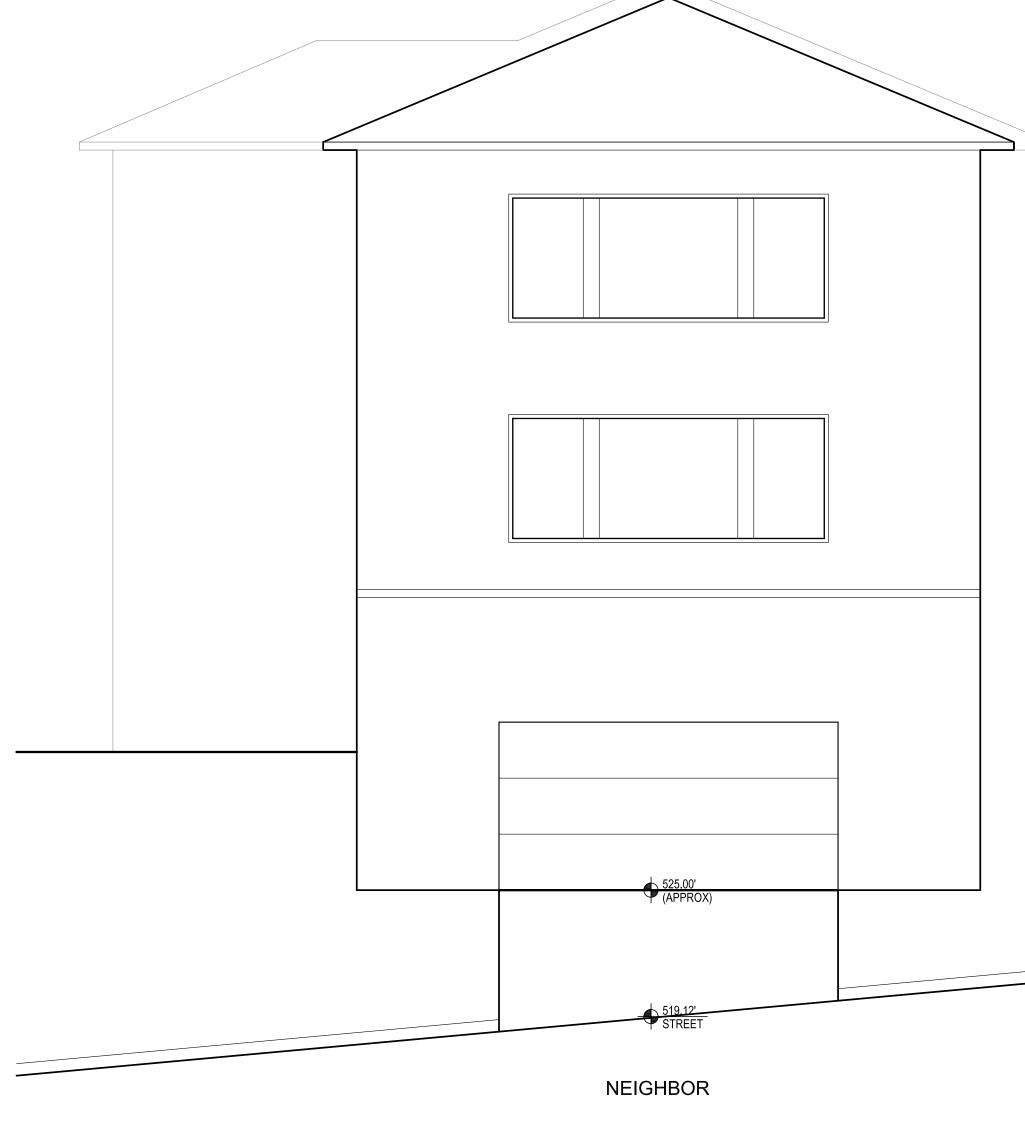

(15) (N) WINDOW WITH CONCEALED METAL FRAME

(14) (N) BAY PROJECTION

(13) (E) WOOD DOOR

08 [NOT USED]

KEYNOTES

(12) (N) GREENHOUSE WINDOW SIMILAR TO EXISTING AT FIRST FL.

(11) (N) PAINTED METAL RAILING AT REVISED ENTRY

(09) (N) STAINED HOROZONTAL WOOD SLAT SIDING

10 [NOT USED]

06 (N) STAINED HORIZONTAL WOOD SLAT GARAGE DOOR 07 [NOT USED]

05 (N) EXTERIOR PLASTER TO MATCH EXISTING


(04) (N) WOOD WINDOW TO MATCH EXISTING


01 LINE OF (E) CHIMNEY TO BE REMOVED

(02) (E) SLOPED ROOF TO BE REMOVED

03 HATCHED AREA INDICATES AREA OF NEW ADDITION WITHIN SIDE SETBACK - REQUIRES VARIANCE

KEY (E) = EXISTING (N) = NEW

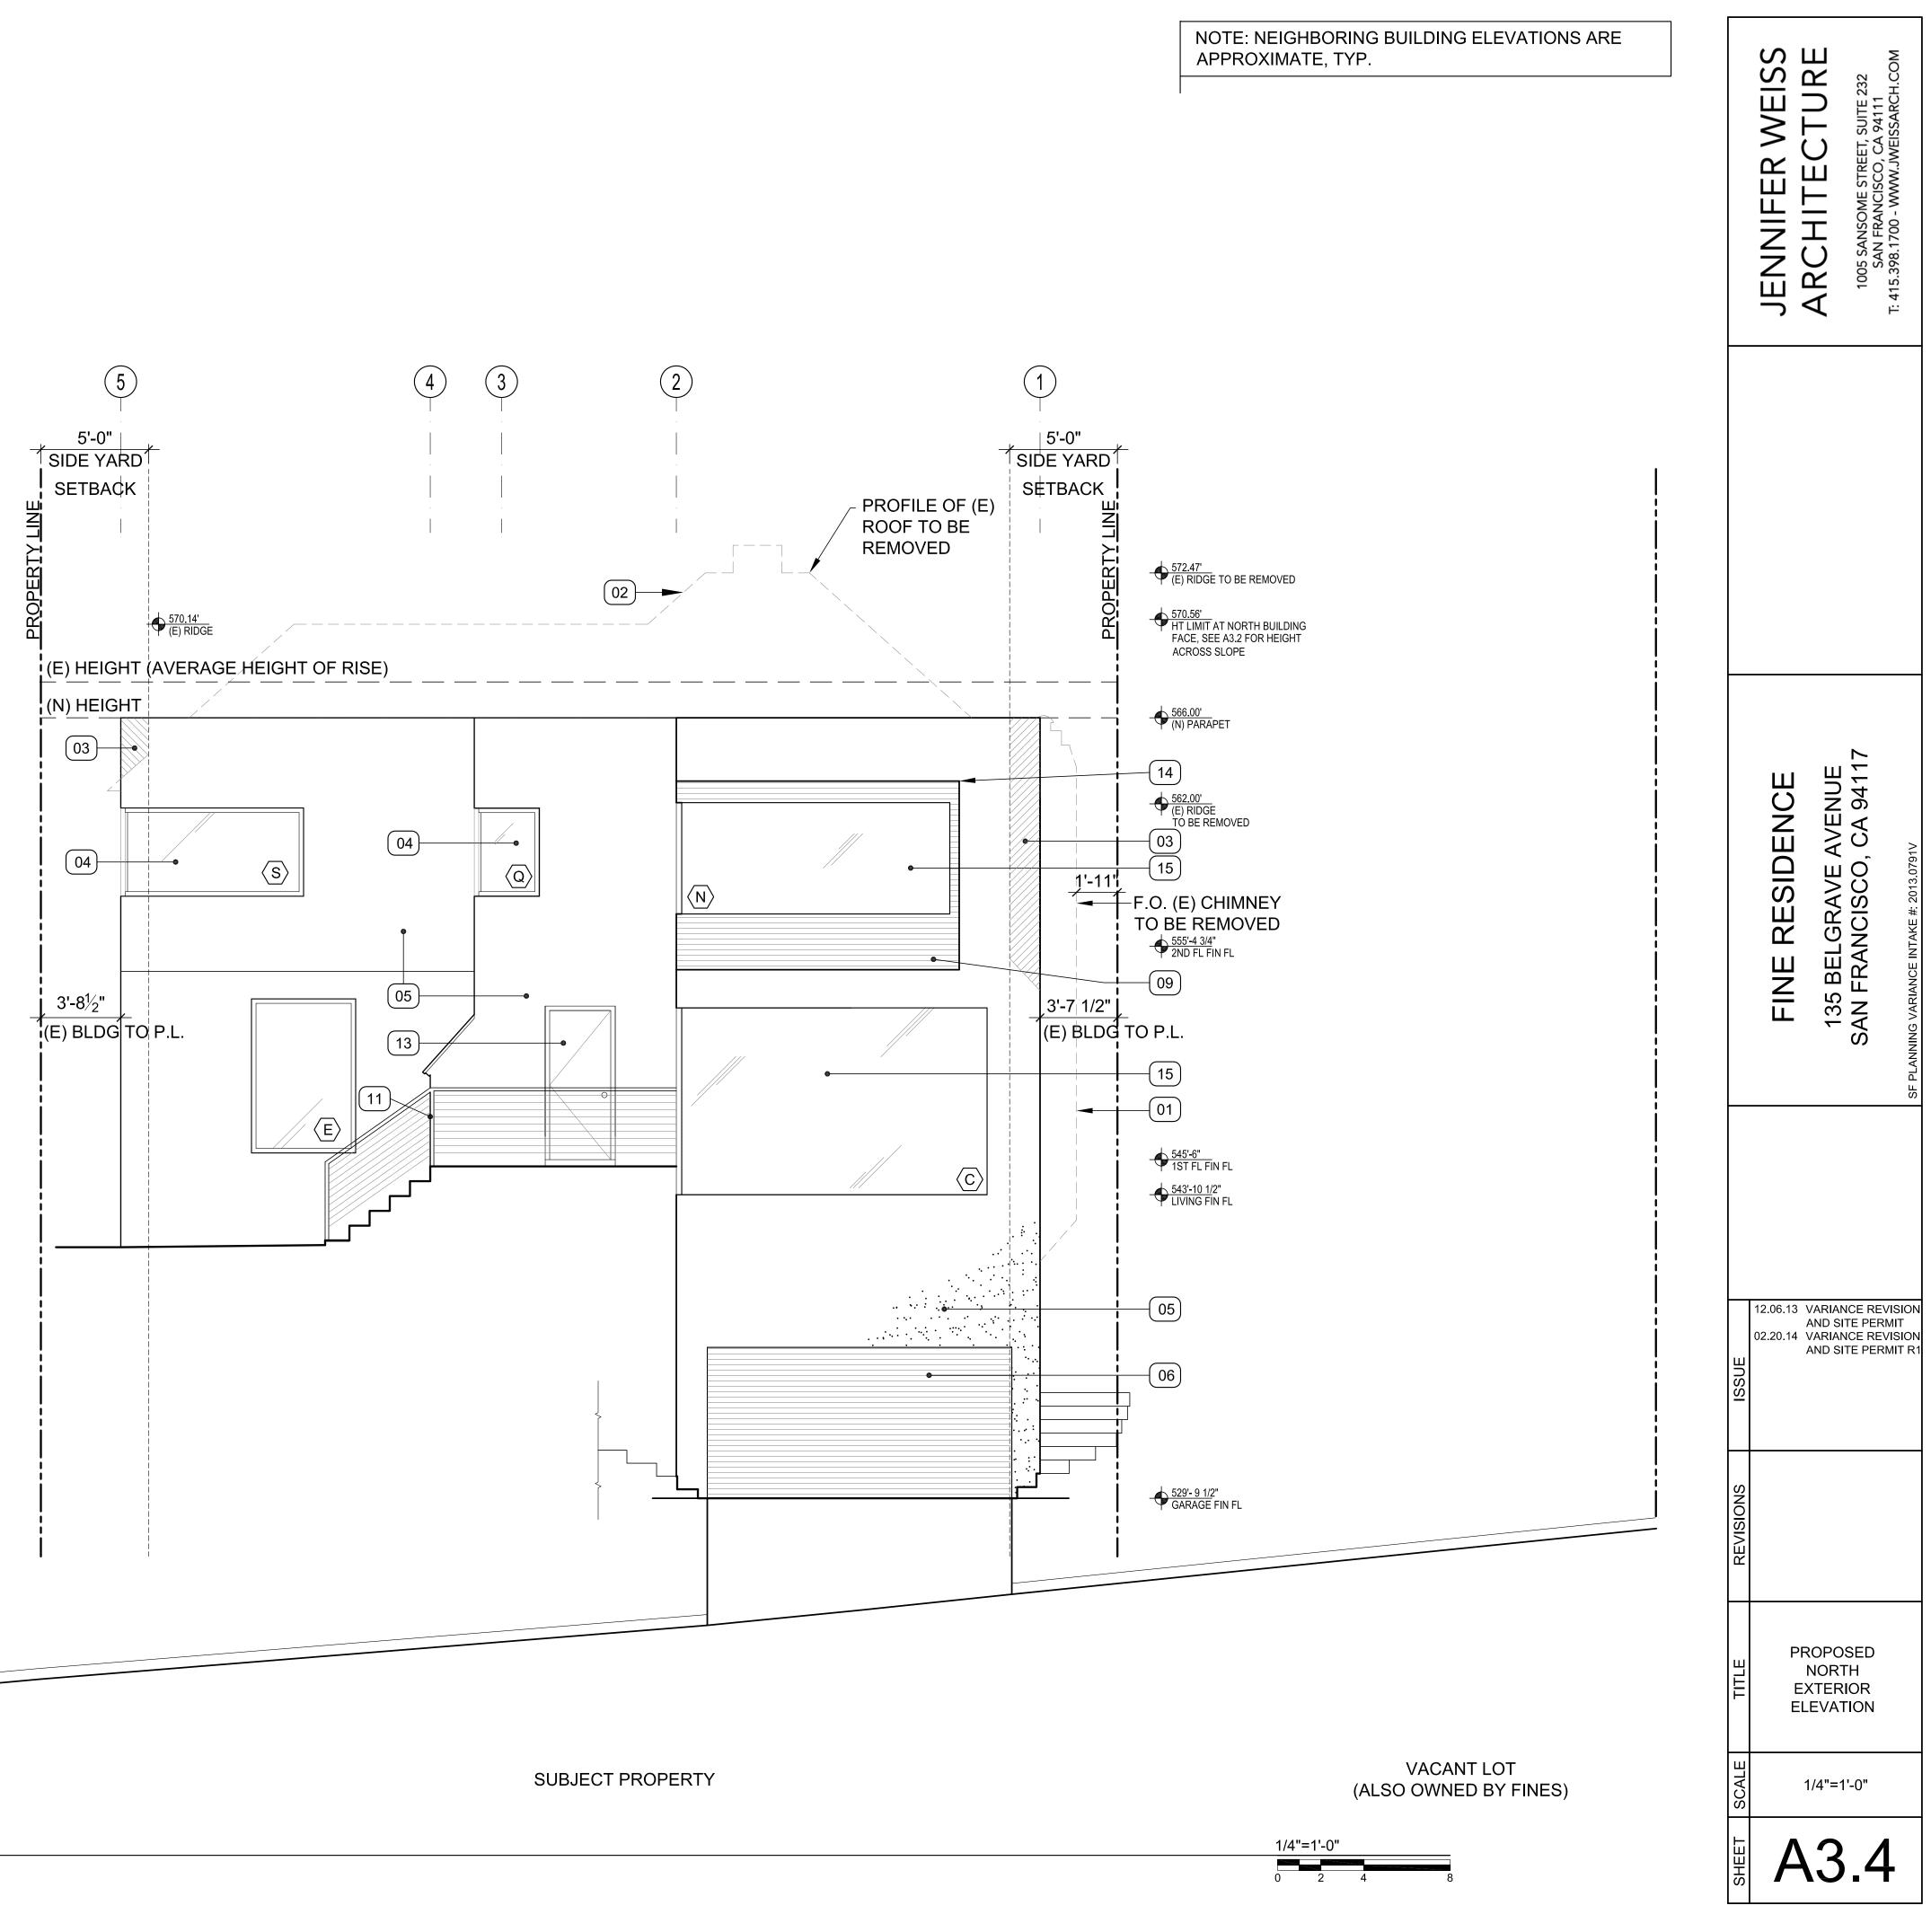

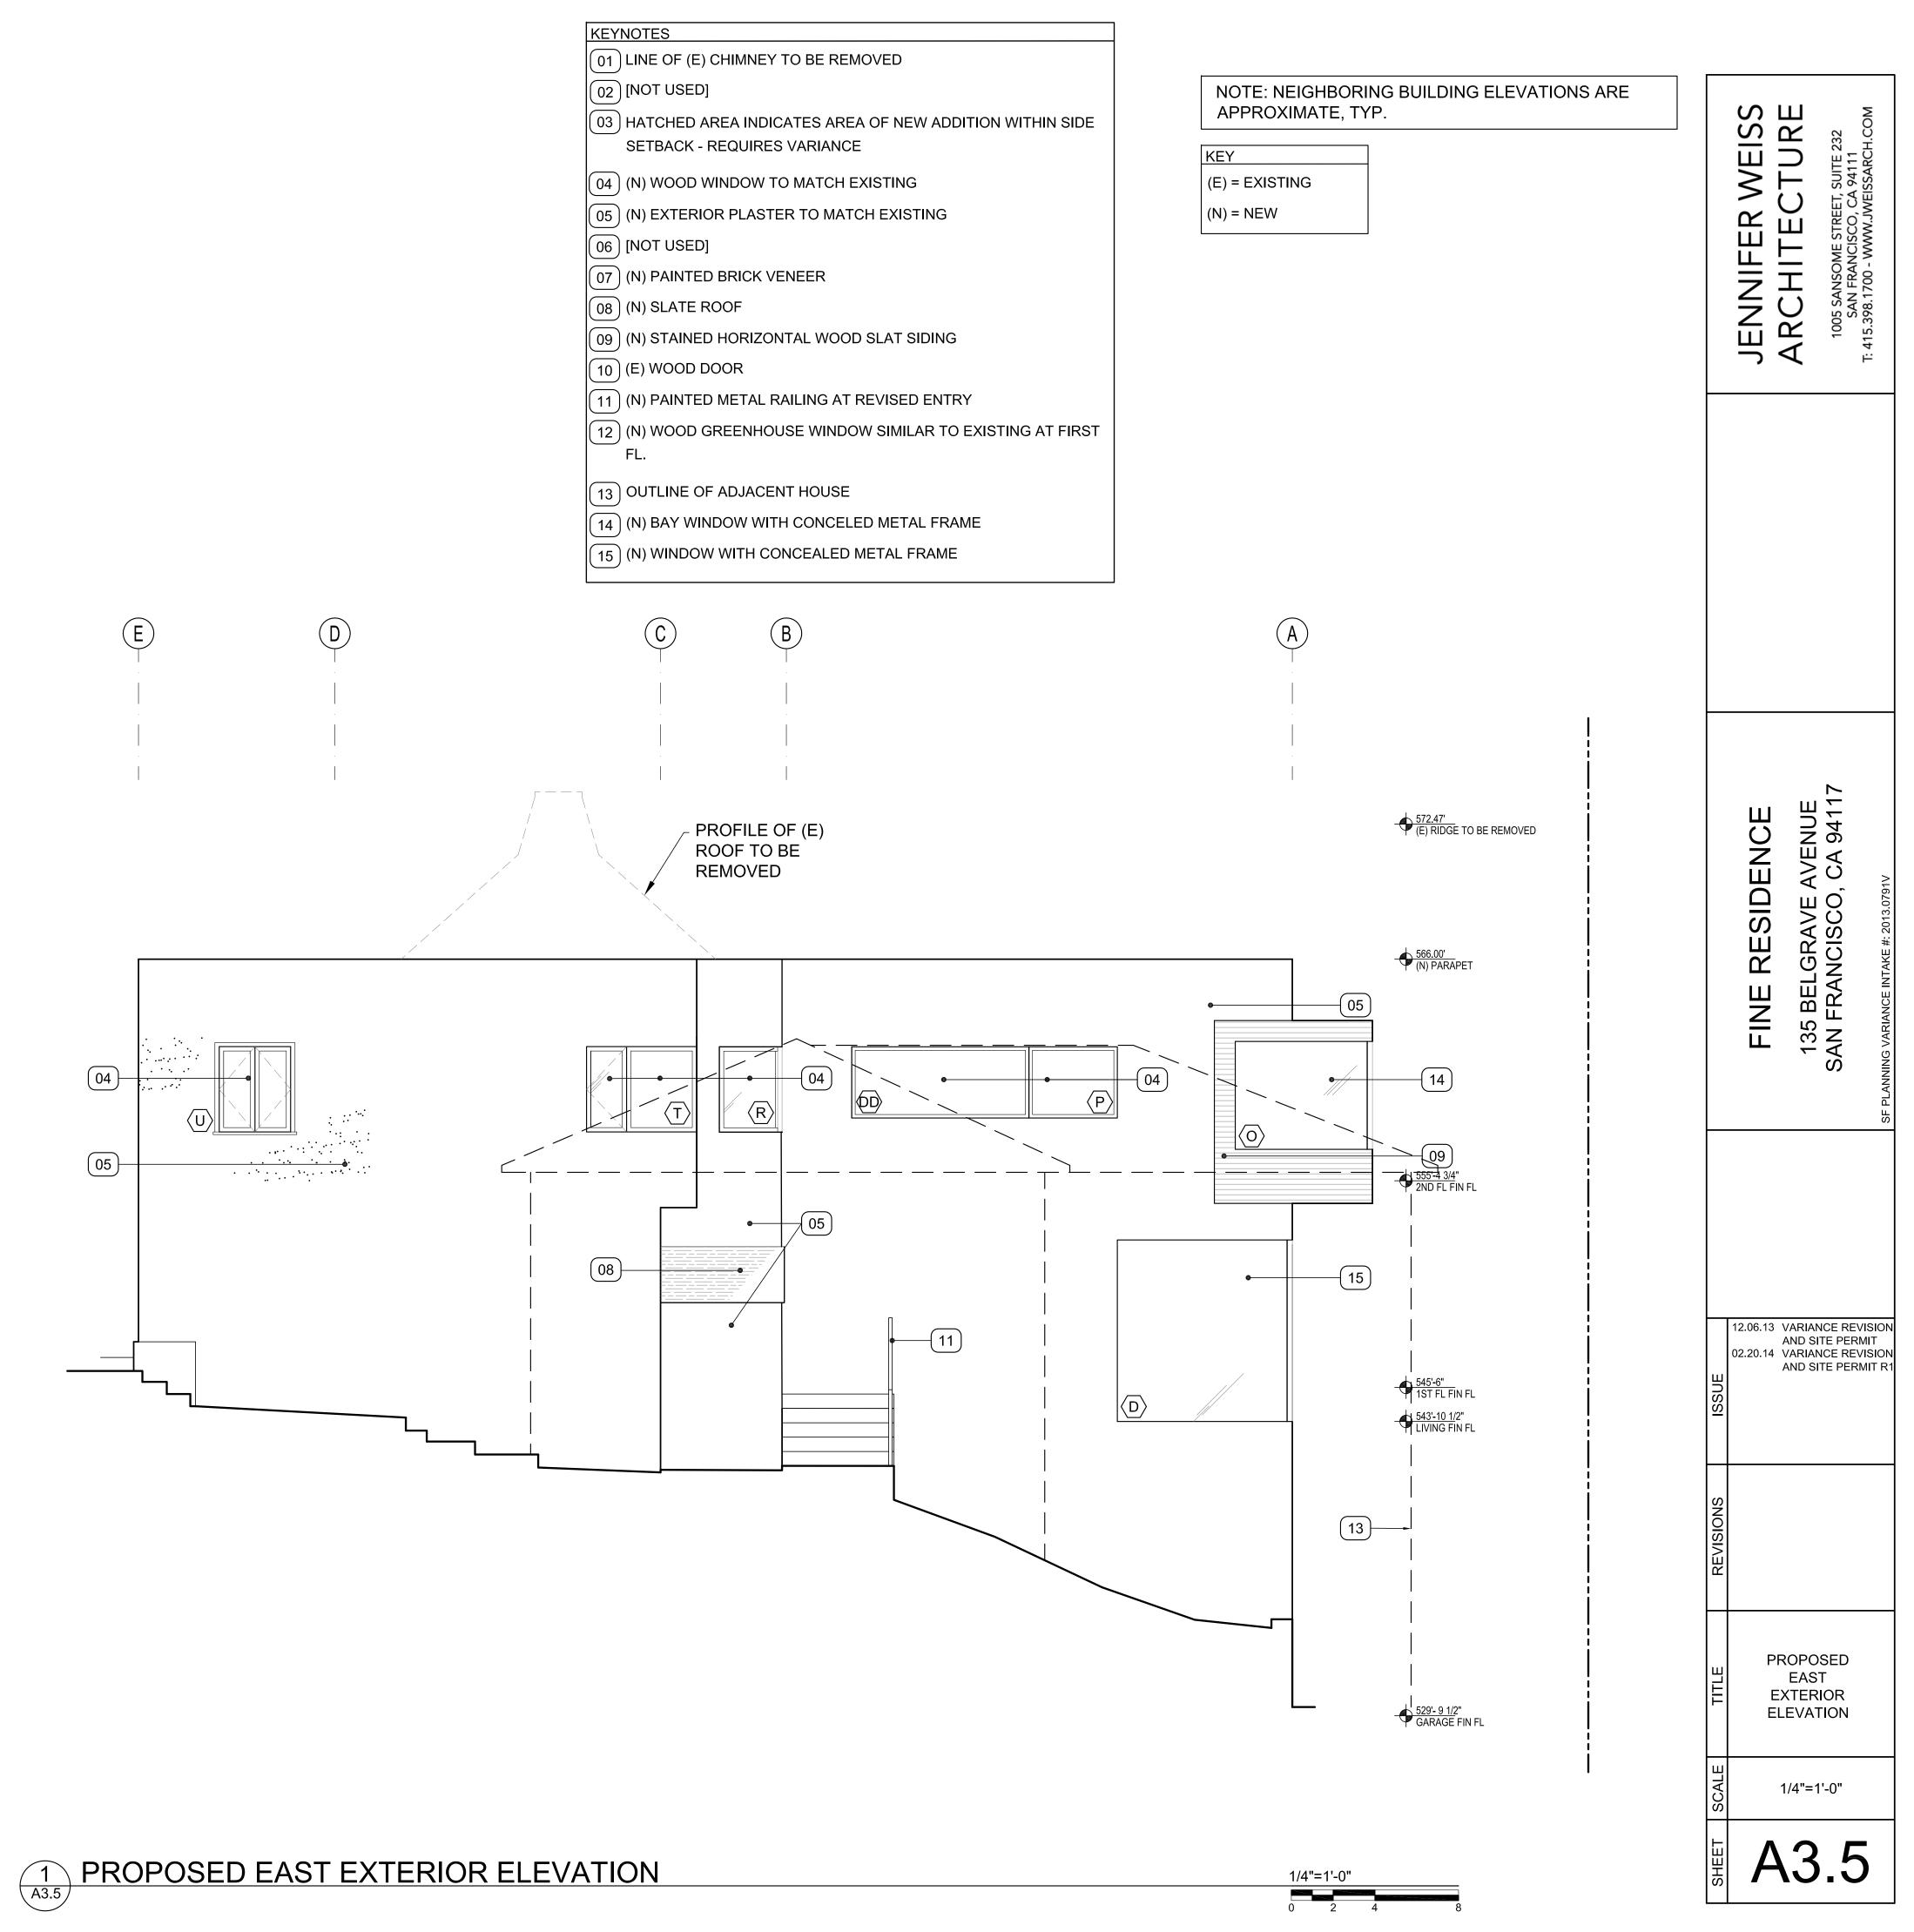



VACANT LOT

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(1)

D

KEYNOTES

01 LINE OF (E) CHIMNEY TO BE REMOVED

02 [NOT USED]

(03) HATCHED AREA INDICATES AREA OF NEW ADDITION WITHIN SIDE SETBACK - REQUIRES VARIANCE


(04) (N) WOOD WINDOW TO MATCH EXISTING

- (05) (N) EXTERIOR PLASTER TO MATCH EXISTING
- 06 [NOT USED]
- (07) (N) PAINTED BRICK VENEER
- 08 (N) SLATE ROOF
- (09) (N) STAINED HORIZONTAL WOOD SLAT SIDING
- (10) (E) WOOD DOOR
- (11) (N) PAINTED METAL RAILING AT REVISED ENTRY

(12) (N) WOOD GREENHOUSE WINDOW SIMILAR TO EXISTING AT FIRST FL.

(13) OUTLINE OF ADJACENT HOUSE

- (14) (N) BAY WINDOW WITH CONCELED METAL FRAME
- (15) (N) WINDOW WITH CONCEALED METAL FRAME

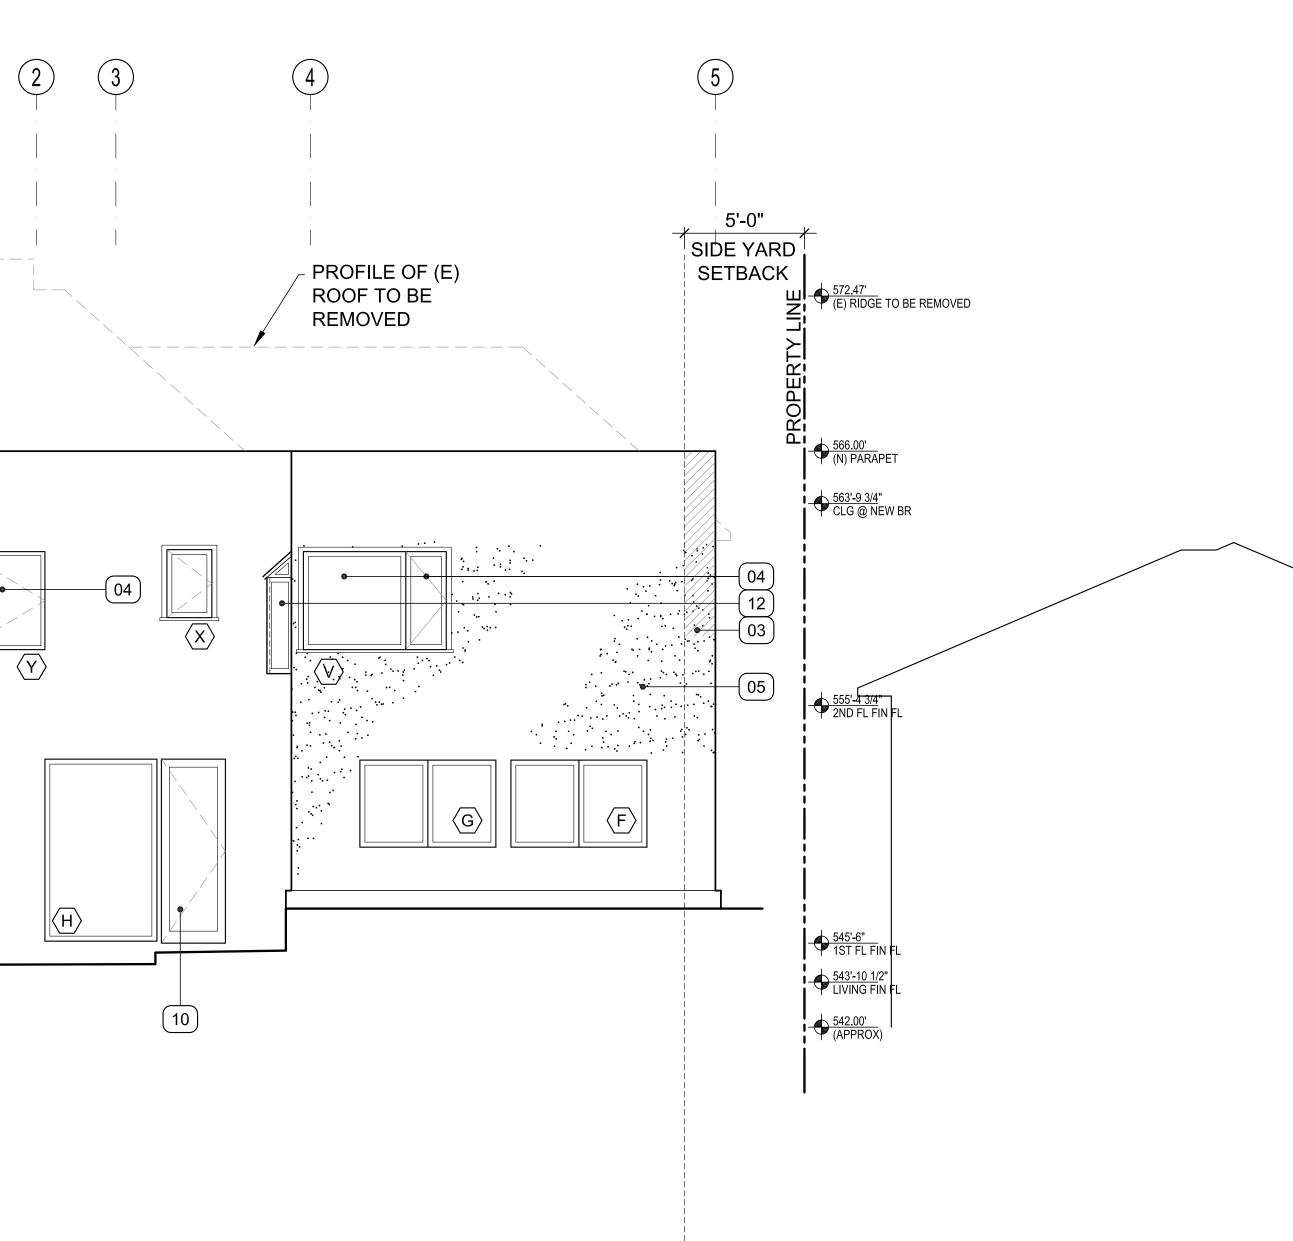

NOTE: NEIGHBORING BUILDING ELEVATIONS ARE APPROXIMATE, TYP. (E) = EXISTING (N) = NEW	JENNIFER WEISS ARCHITECTURE 1005 SANSOME STREET, SUITE 232 SAN FRANCISCO, CA 94111 T: 415.398.1700 - WWW.JWEISSARCH.COM
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	REVISIONS
	PROPOSED SOUTH EXTERIOR ELEVATION
	B 1/4"=1'-0"
1/4"=1'-0" 0 2 4 8	A3.6



KEYNOTES

01 LINE OF (E) CHIMNEY TO BE REMOVED

02 [NOT USED]

03 [NOT USED]

(04) (N) WOOD WINDOW TO MATCH EXISTING

(05) (N) EXTERIOR PLASTER TO MATCH EXISTING

(06) (E) WOOD & GLASS DOOR

(07) (E) WOOD SLIDING DOOR

08 [NOT USED]

(09) LINE OF (E) ROOF TO BE REMOVED


10 [NOT USED]

(11) (N) STAINED HORIZONTAL WOOD SIDING

(12) (N) WOOD GREENHOUSE WINDOW SIMILAR TO EXISTING AT FIRST FL.


13 [NOT USED]

(14) (N) BAY PROJECTION

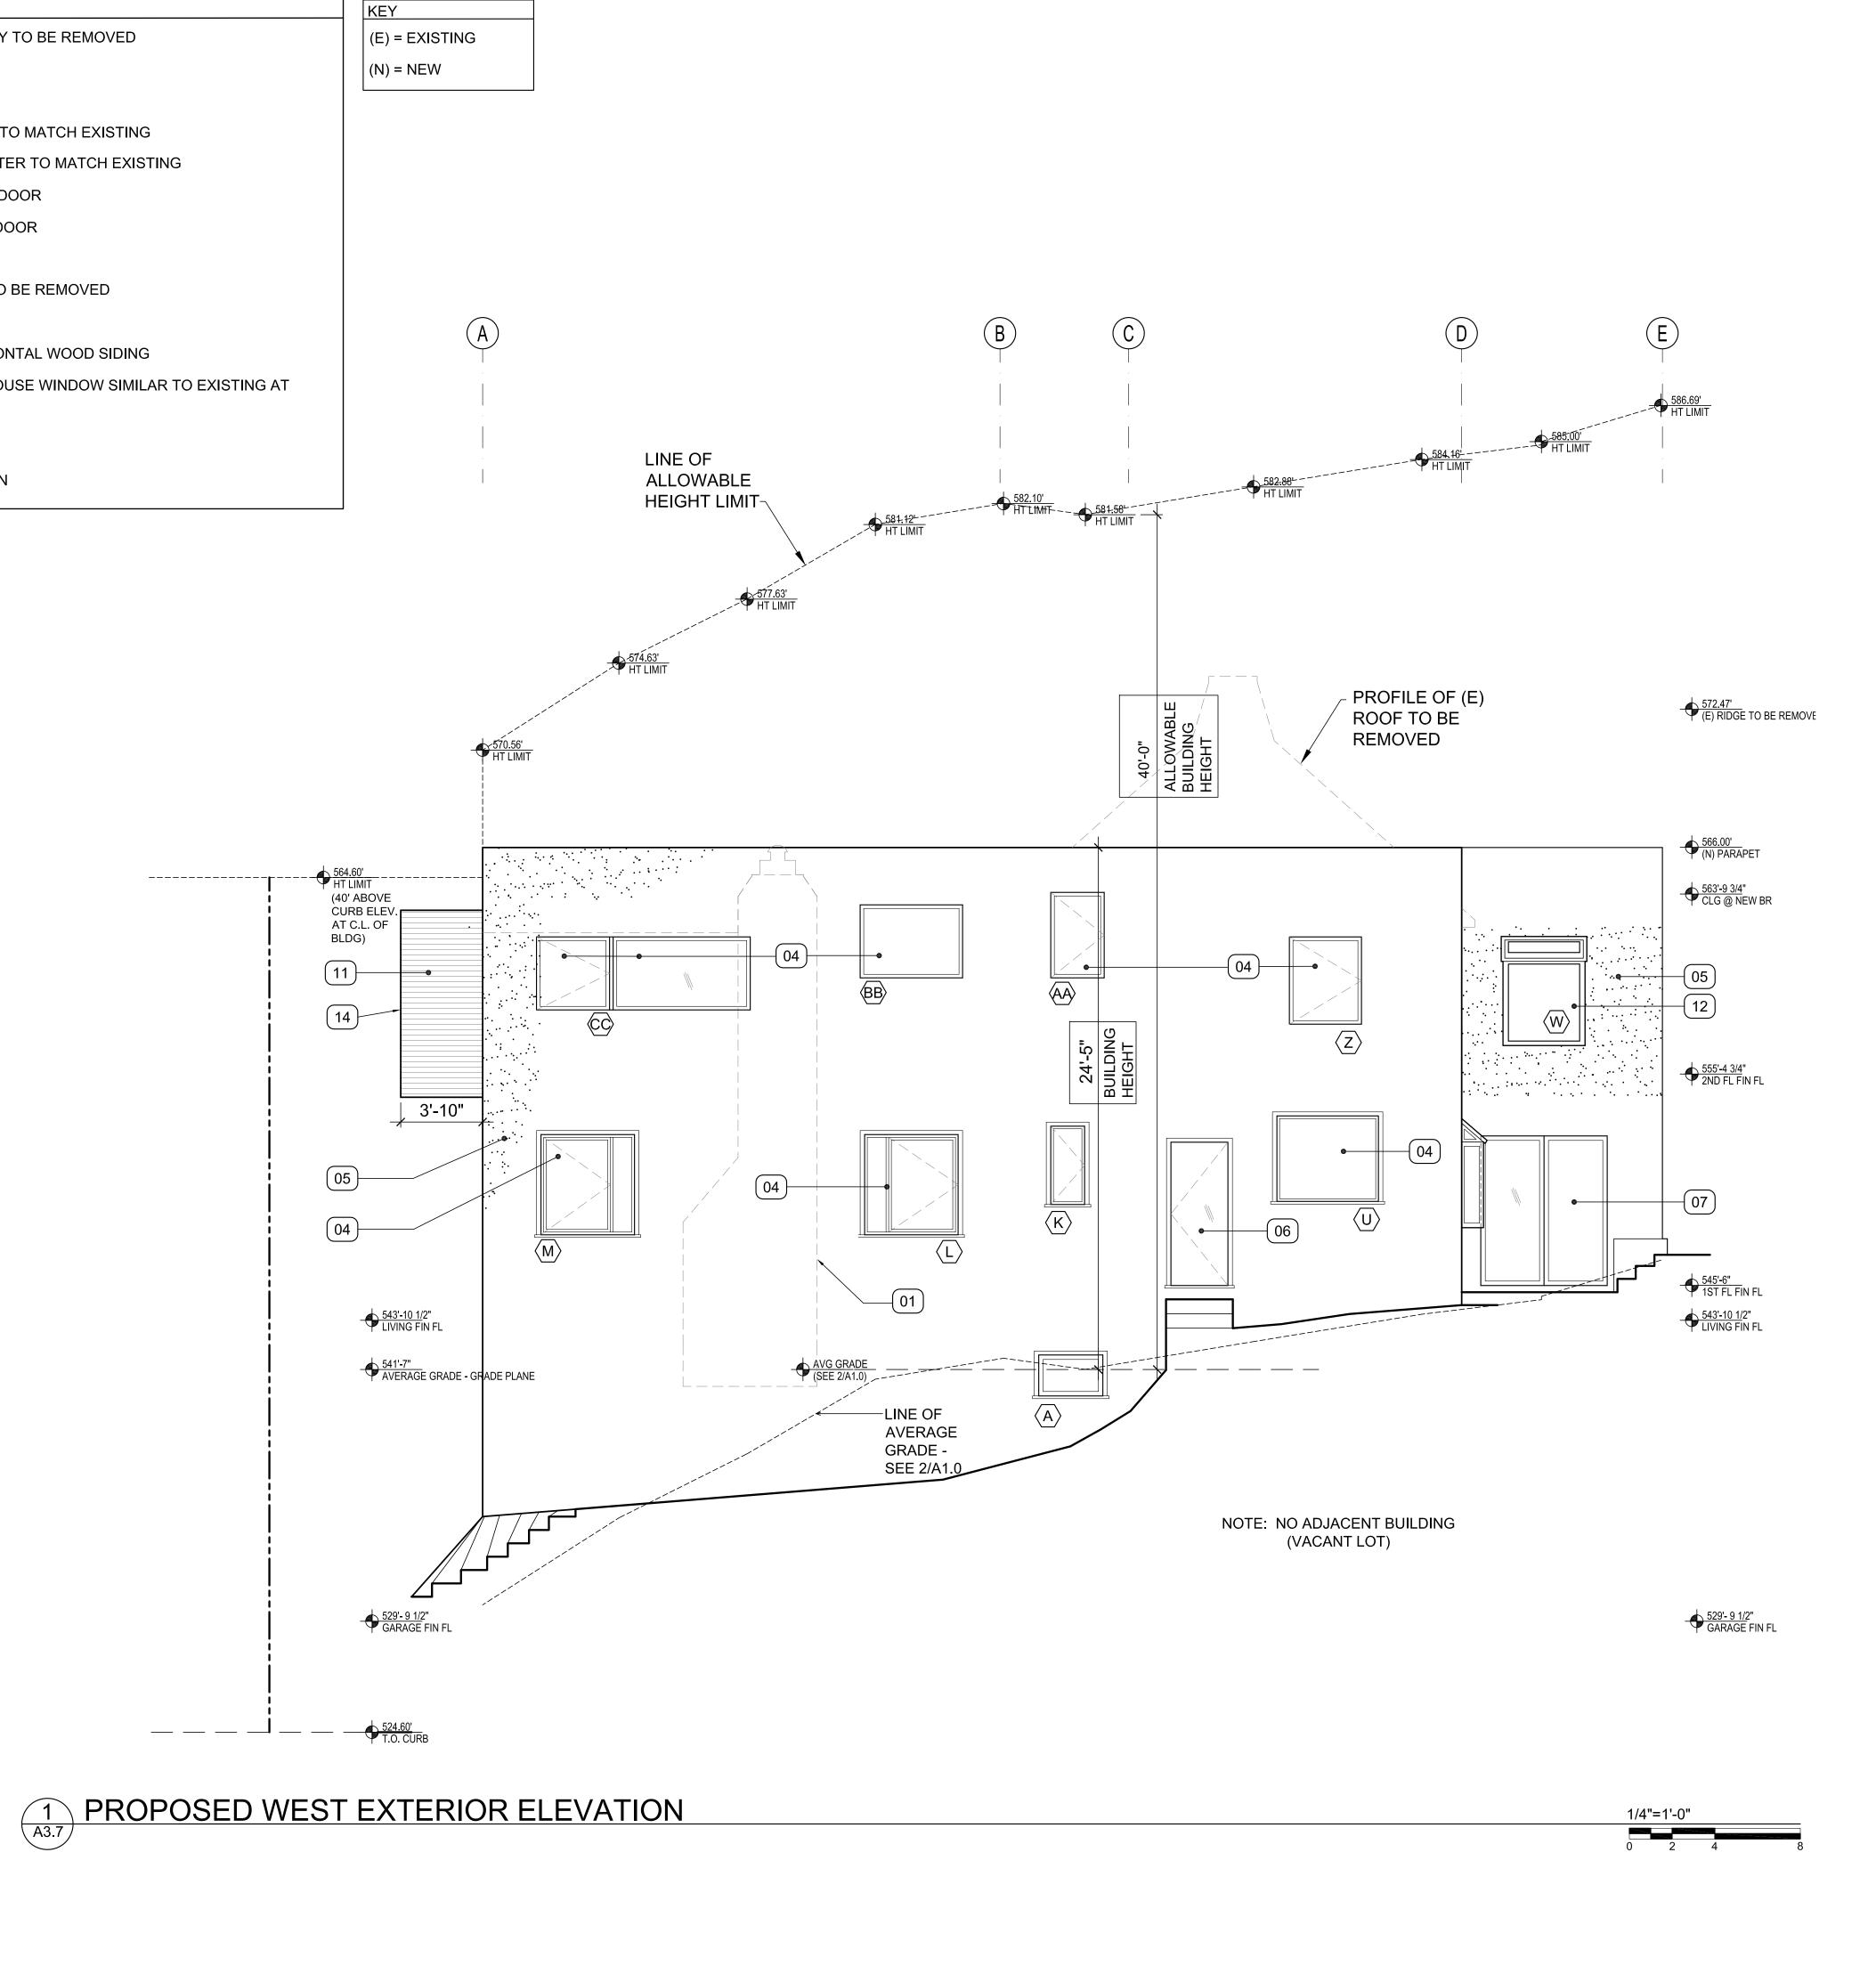


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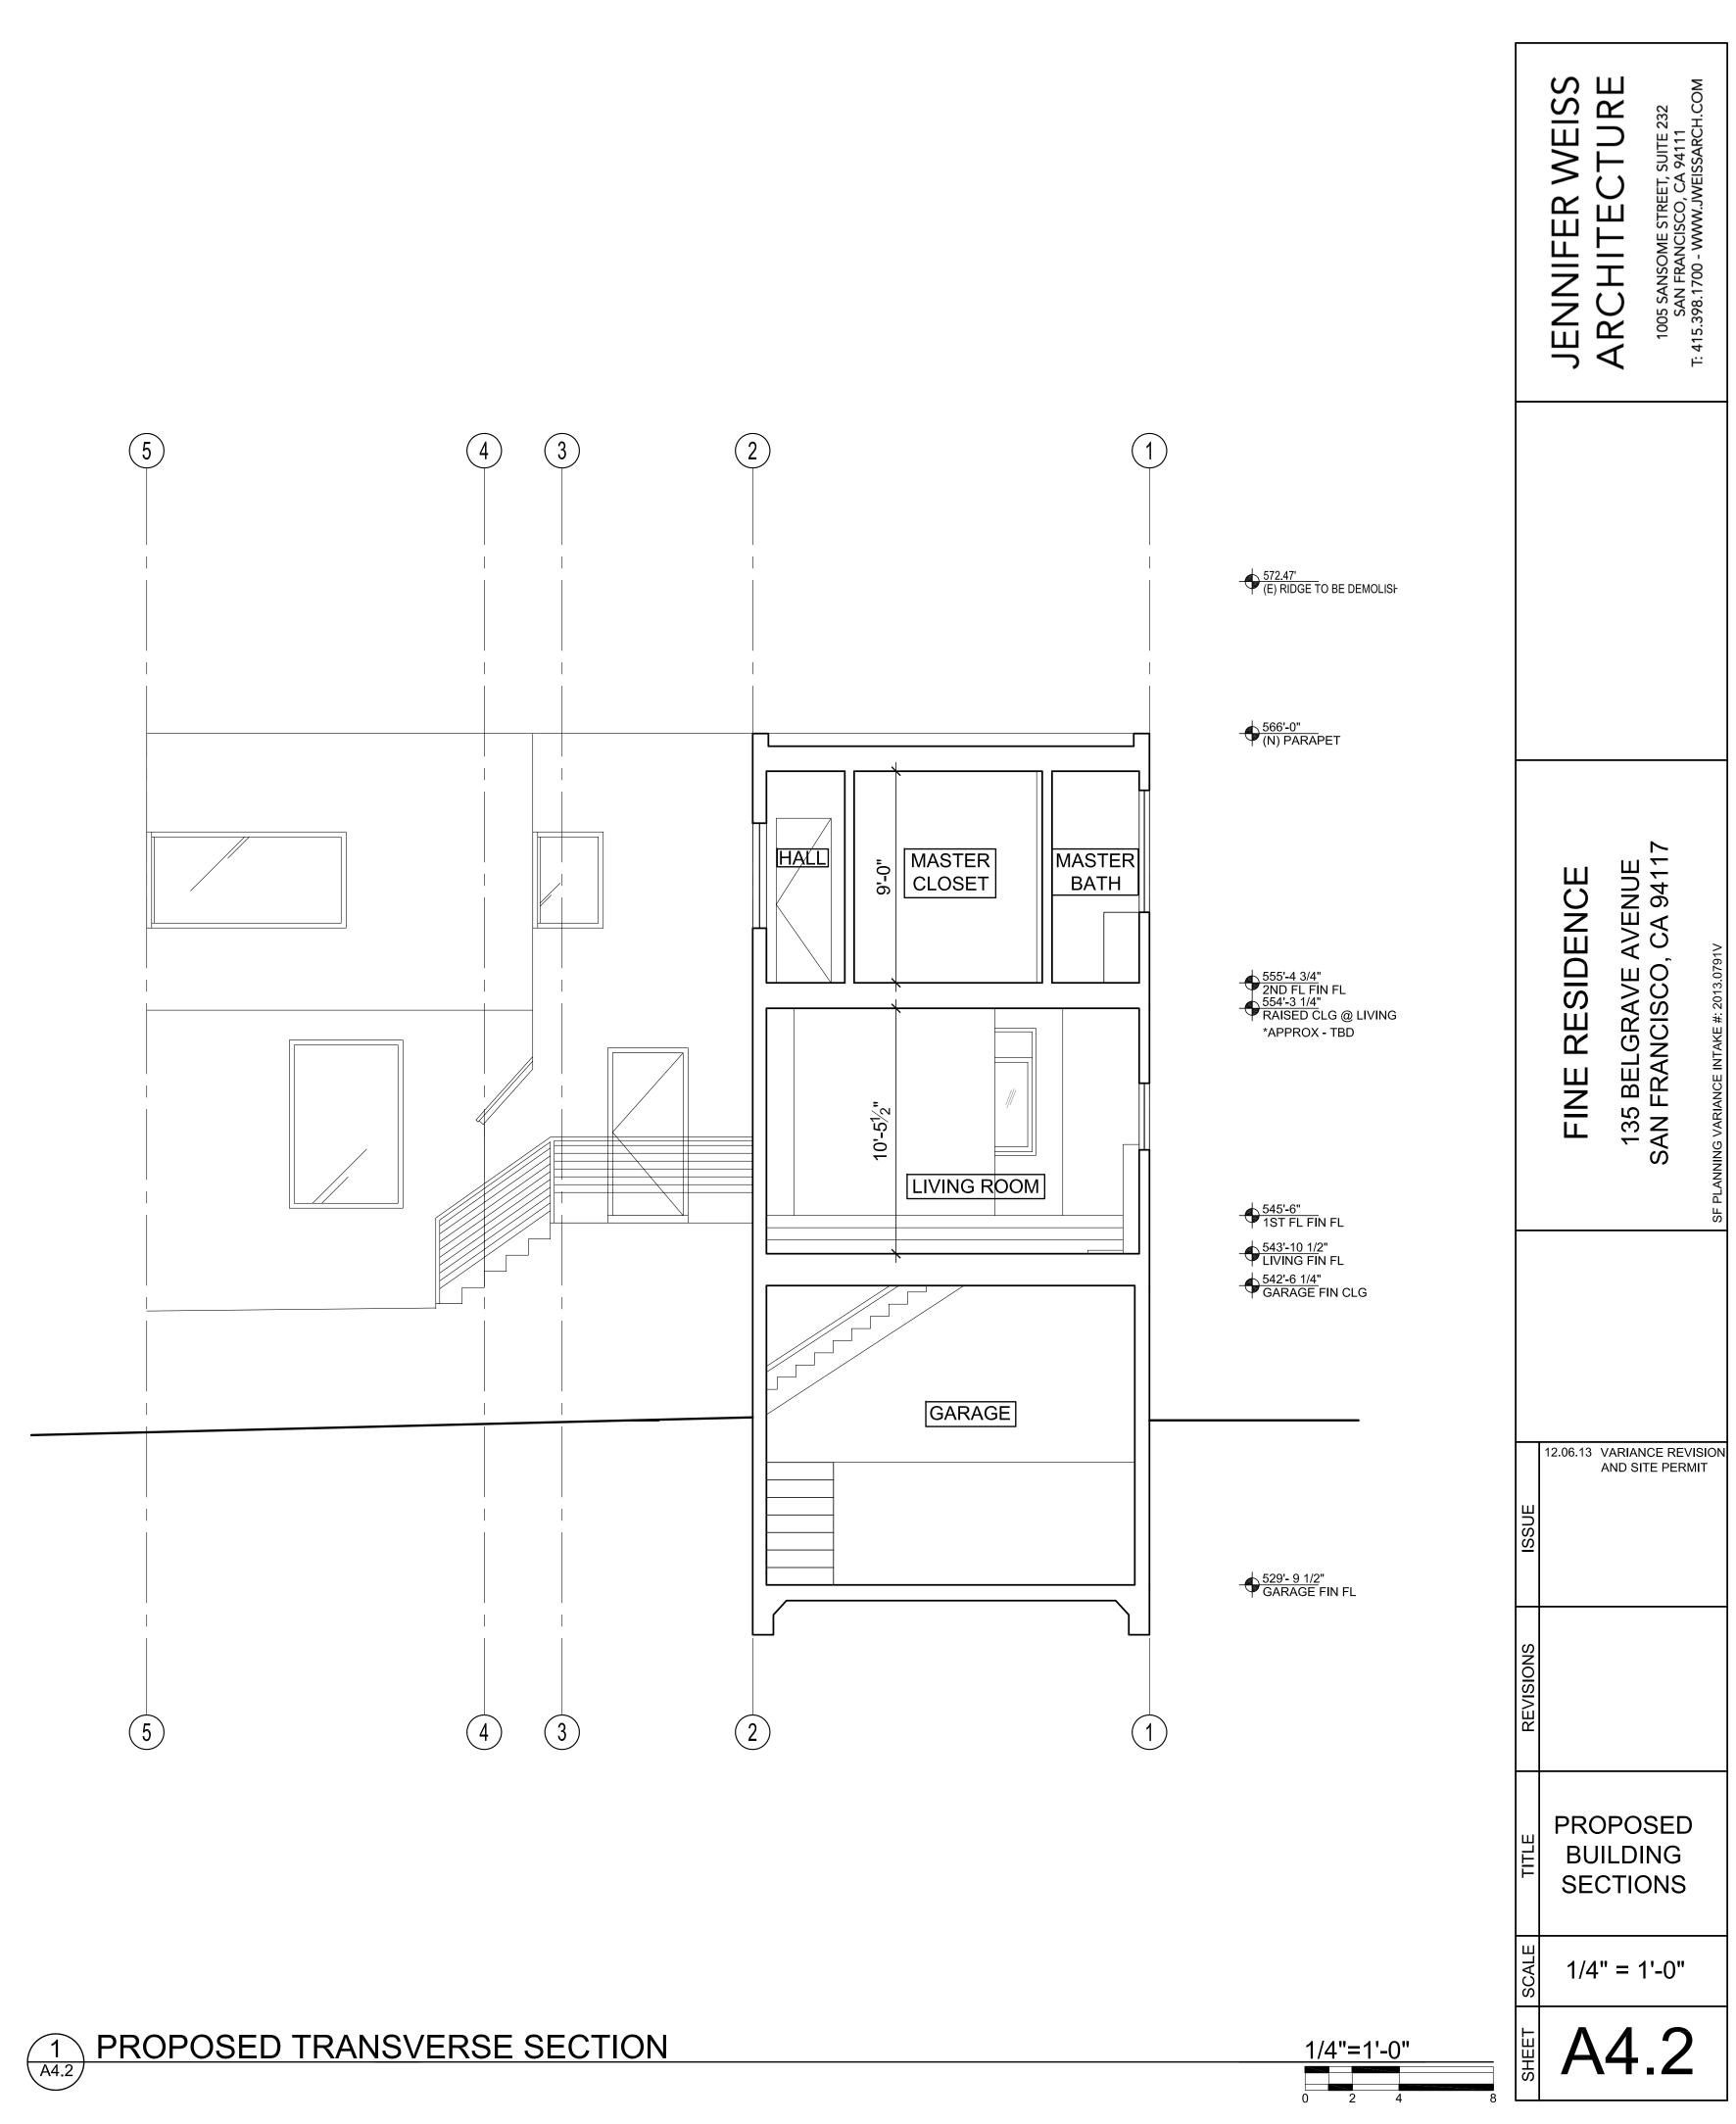





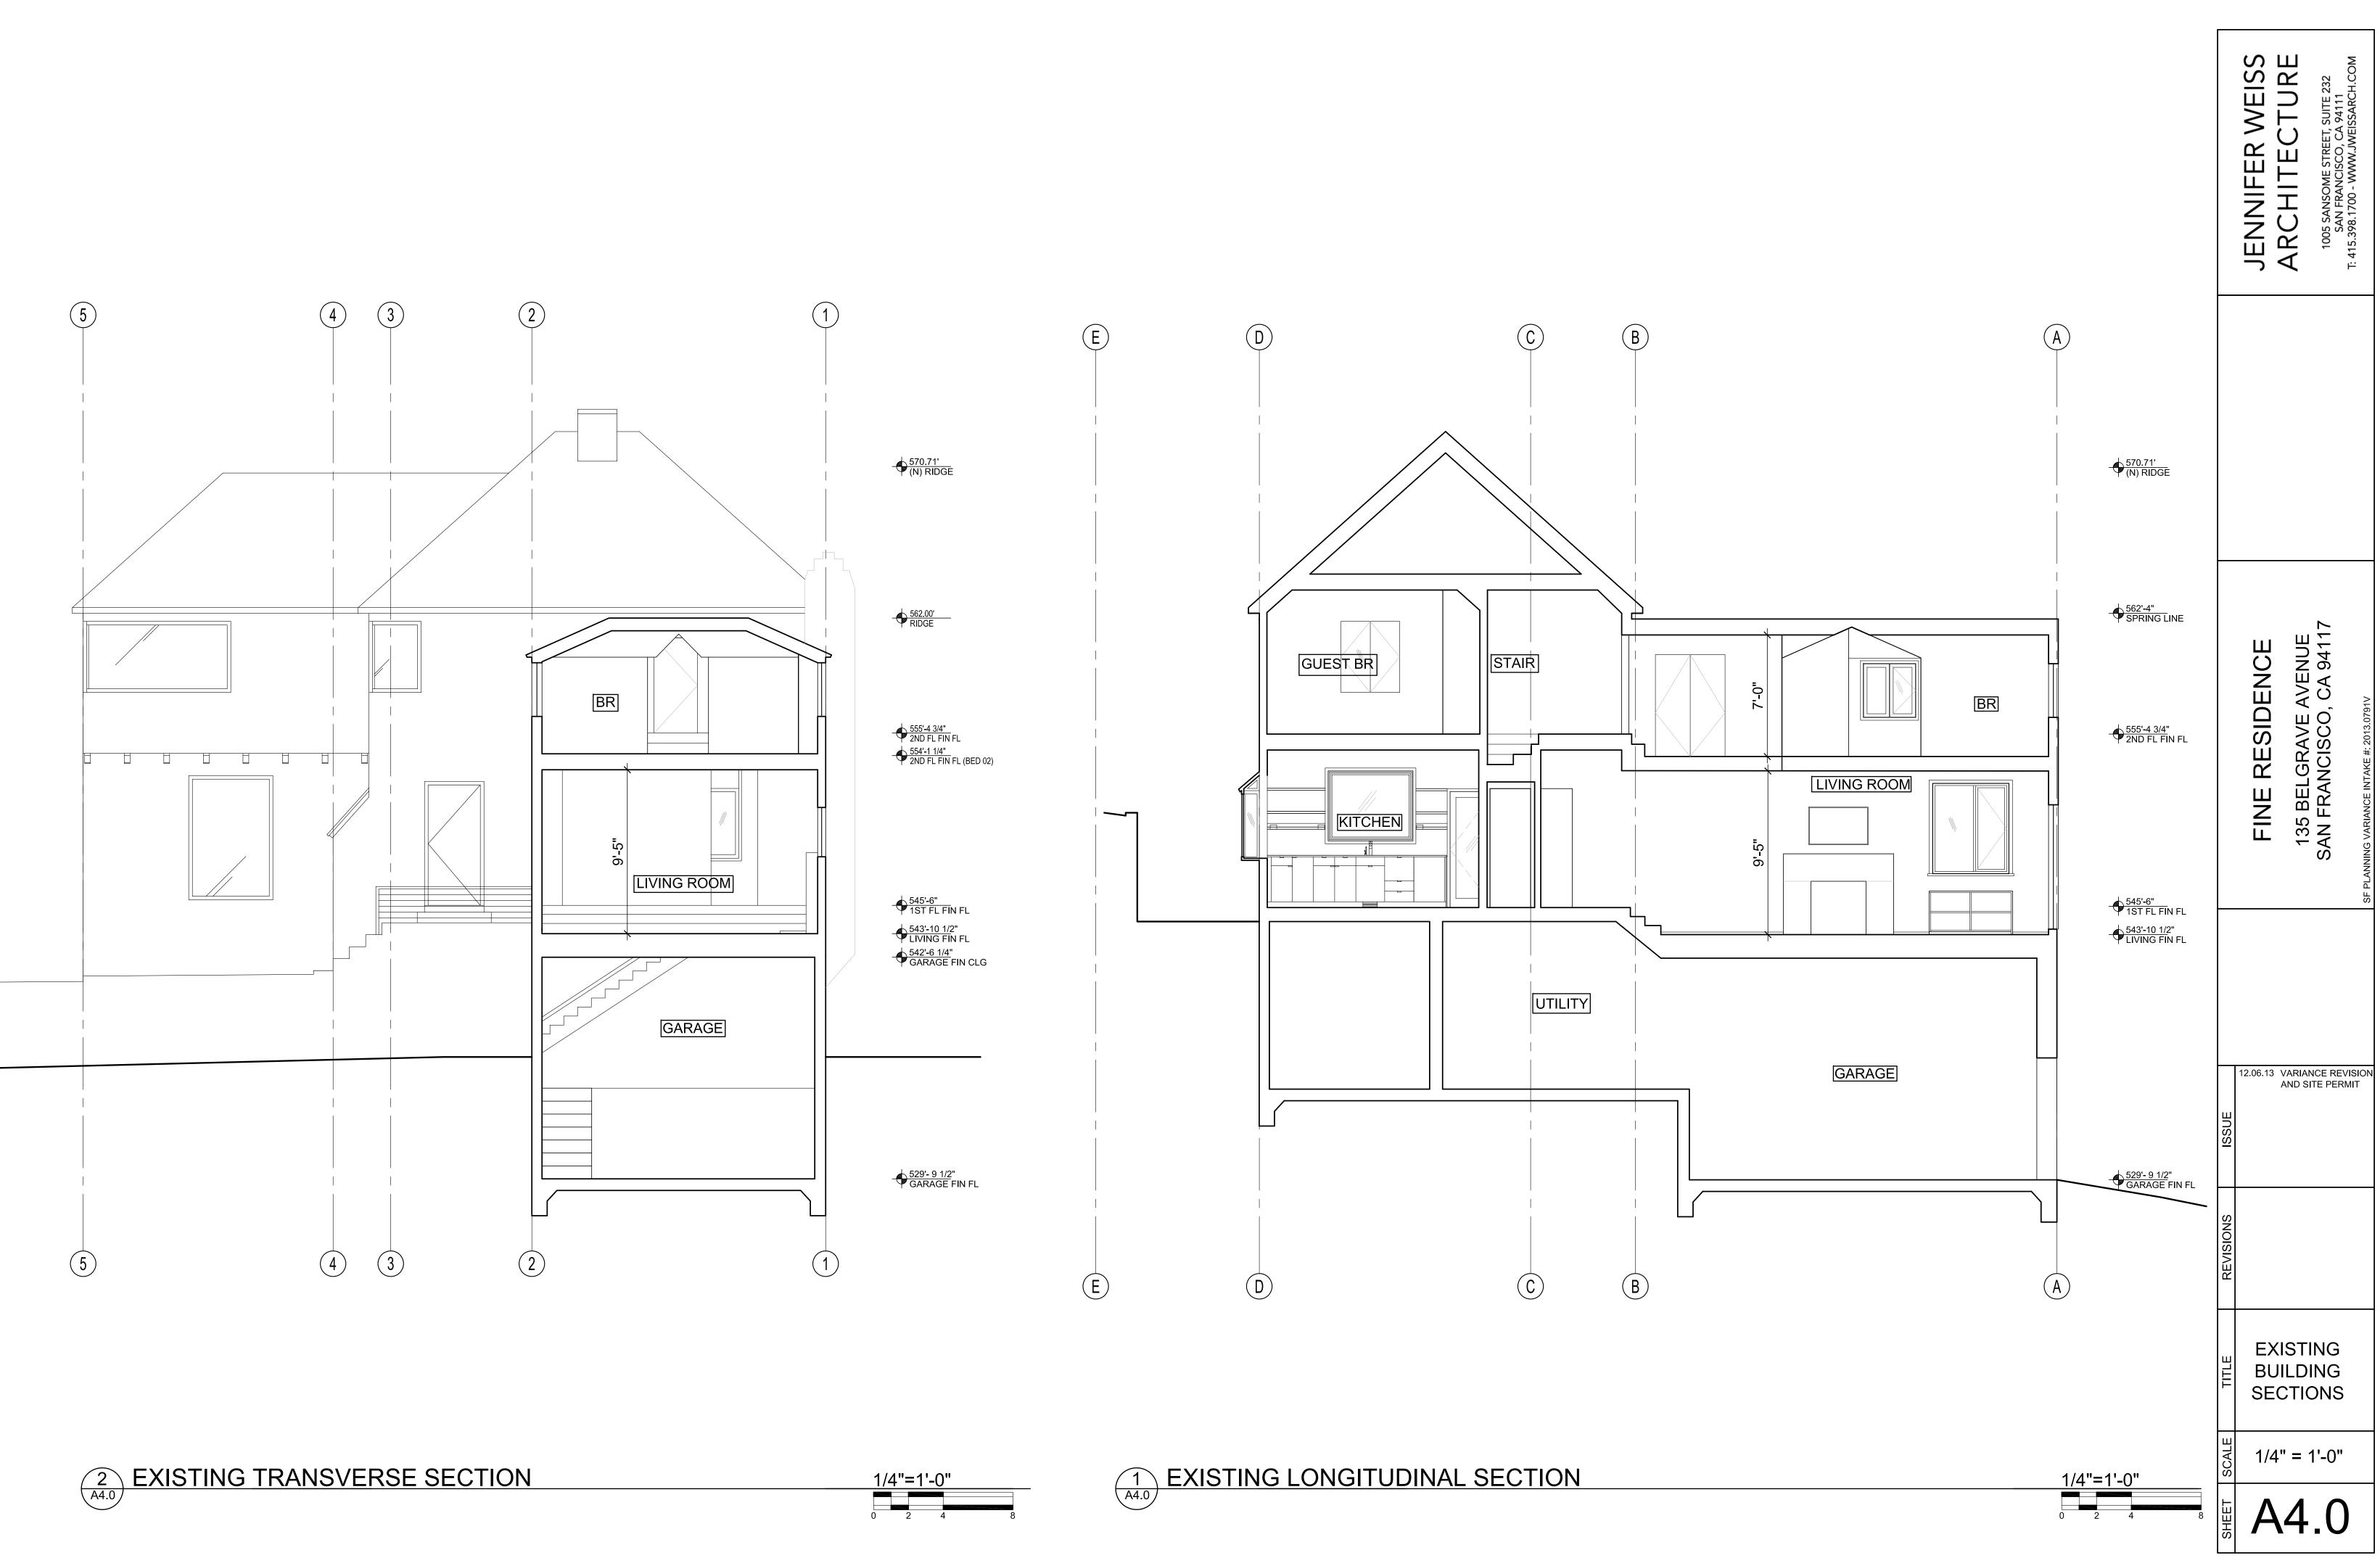



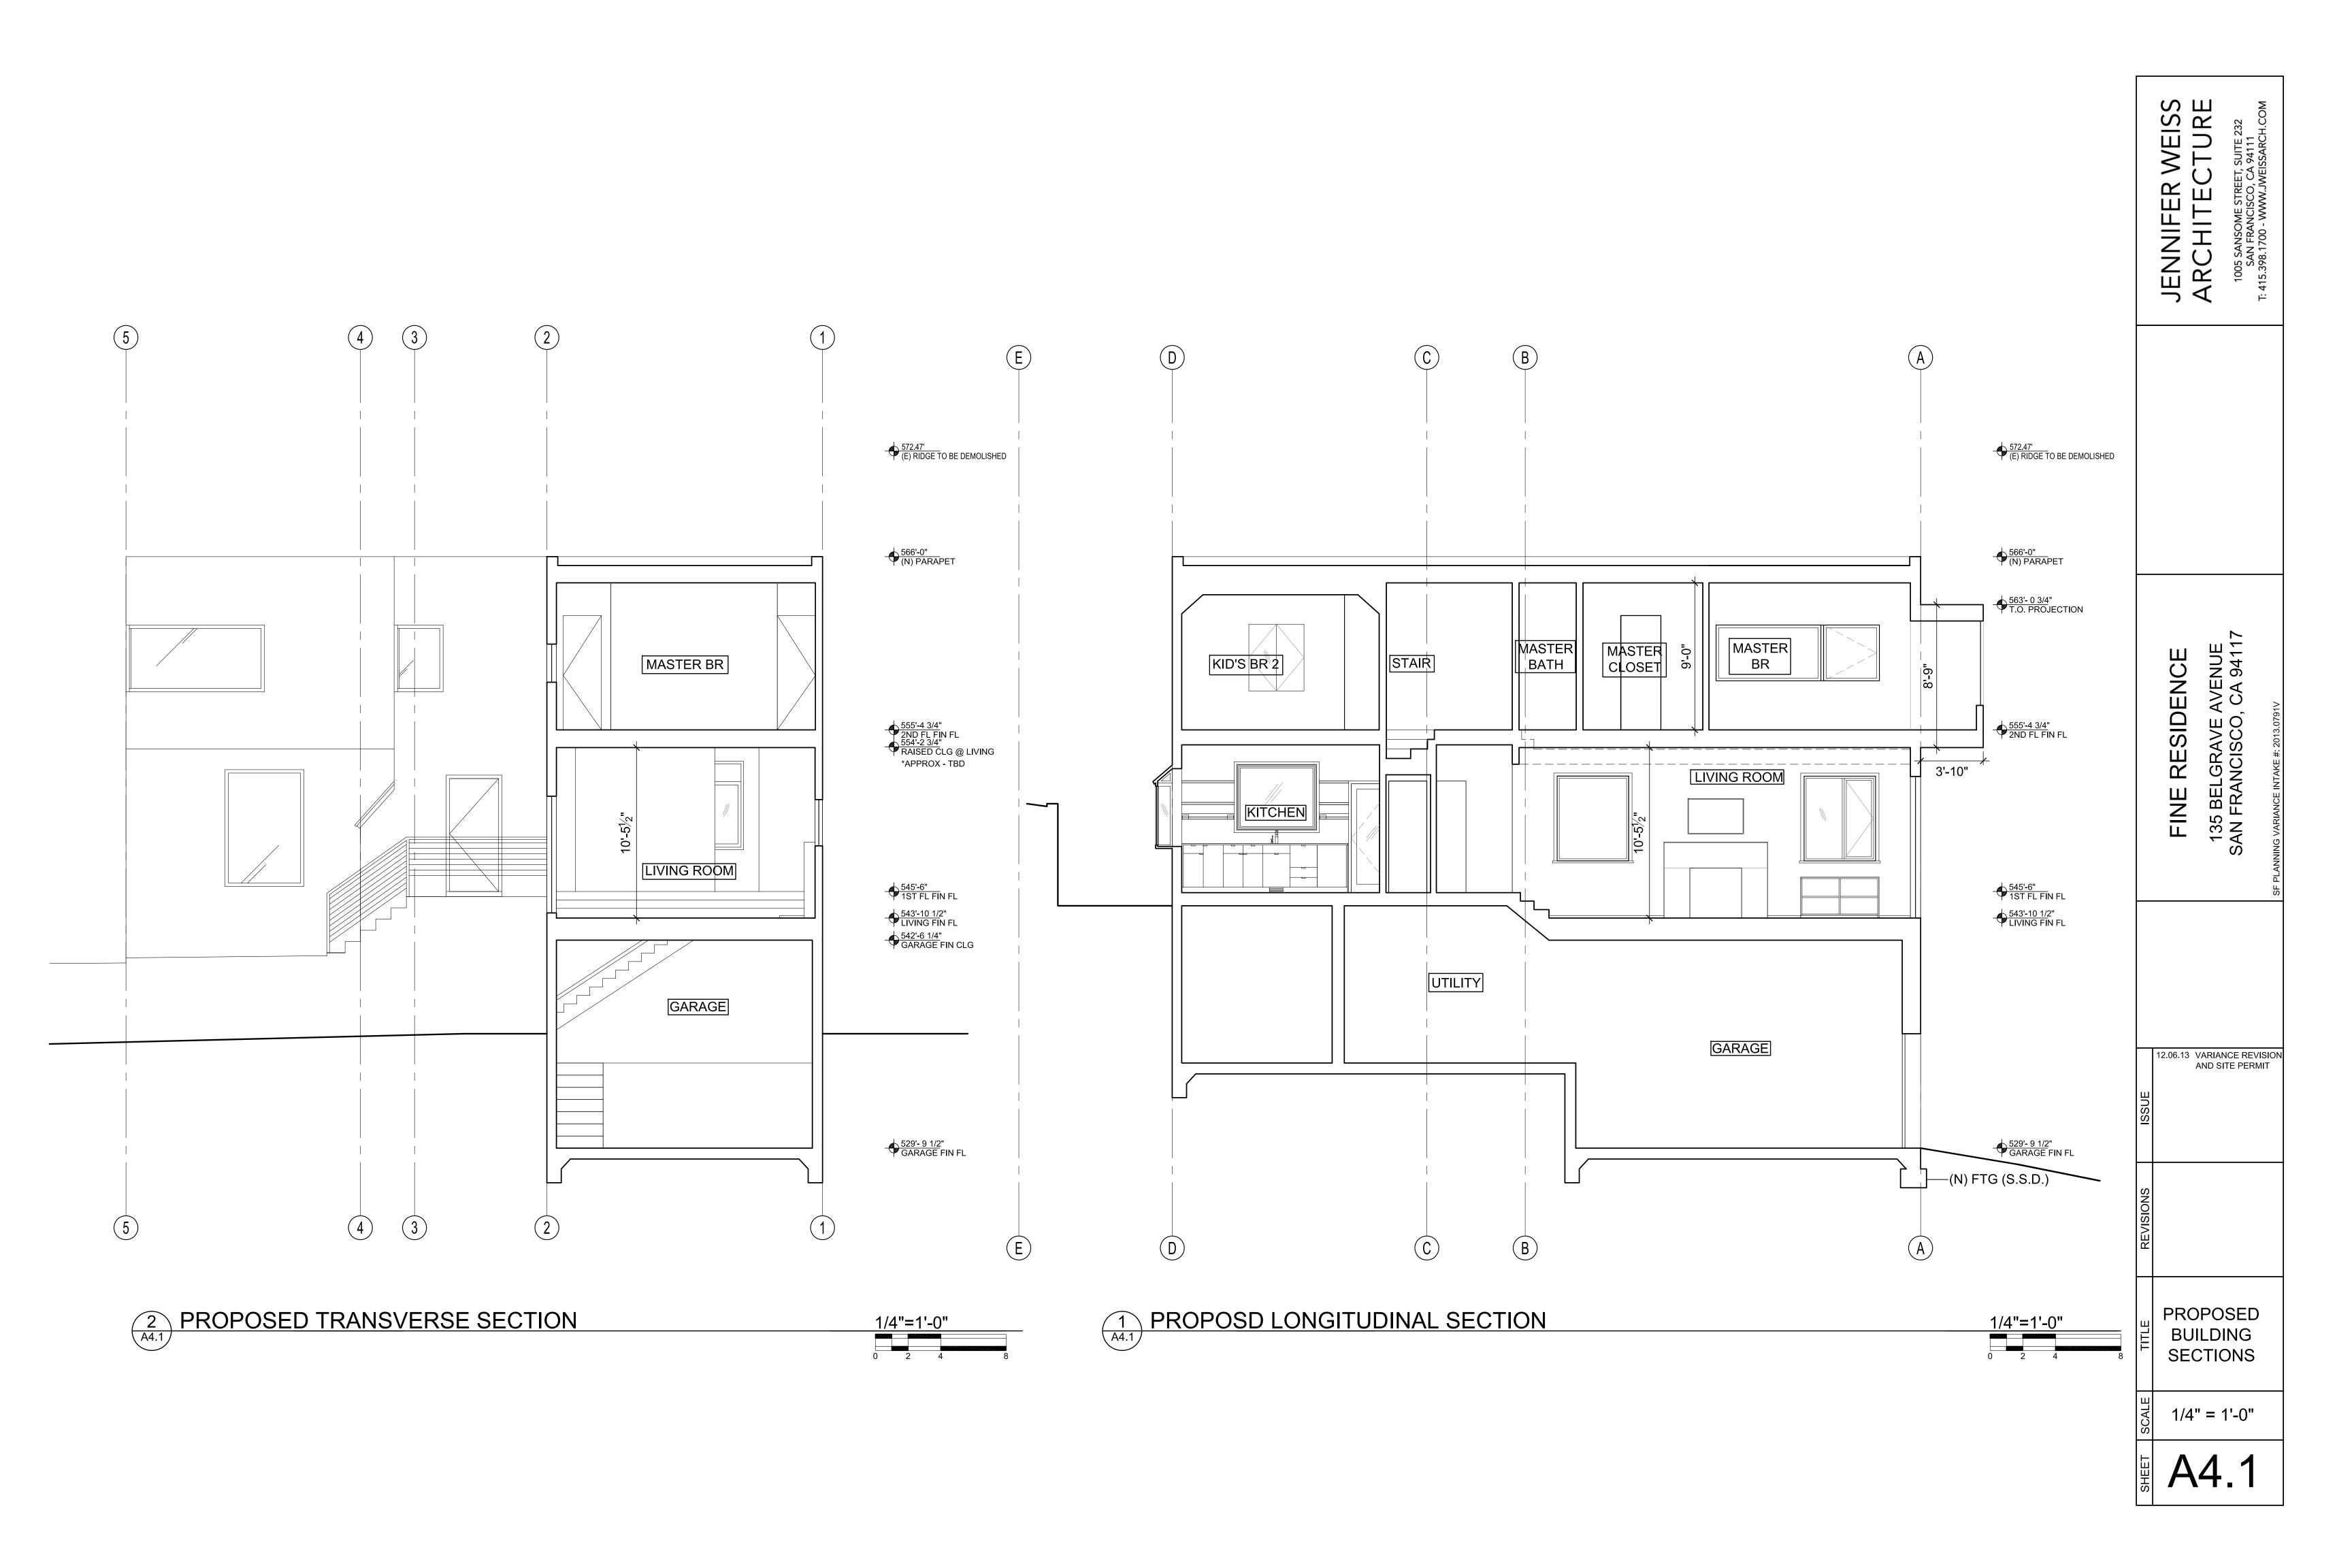



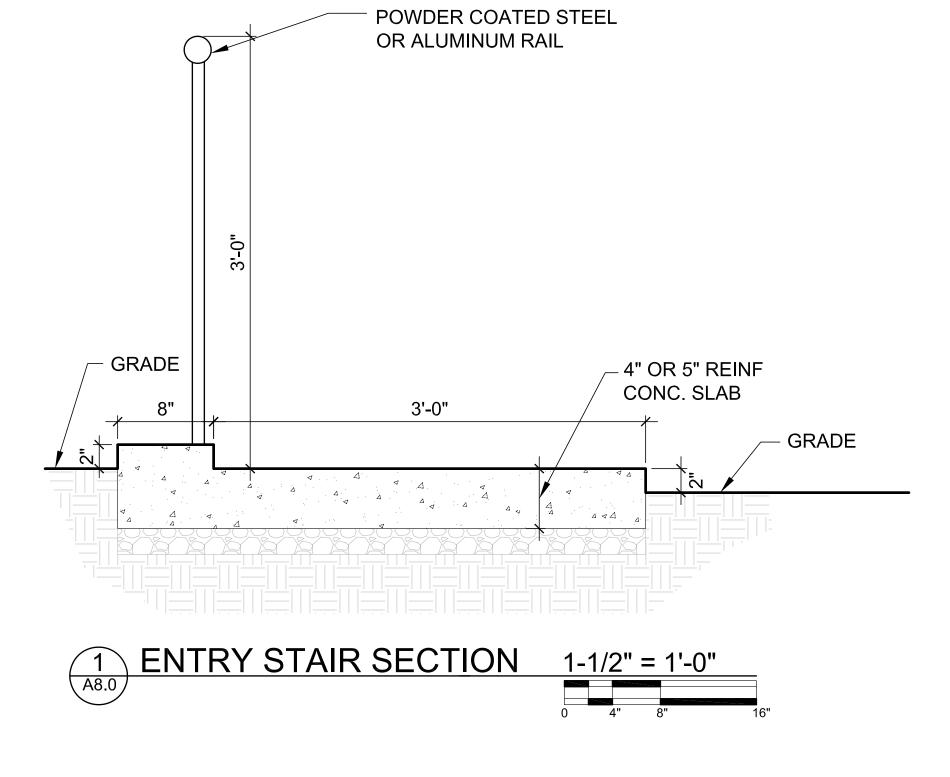

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	FINE RESIDENCE	135 BELGRAVE AVENUE	SAN FRANCISCO, CA 94117	SF PLANNING VARIANCE INTAKE #: 2013.0791V
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WINDOW SCHEDULE

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NO.	LOCATION	SIZE (WxH)	TYPE*	WDOW HEAD (A.F.F.)	OPERATION	GLASS TYPE	SILL DETAIL	HEAD DETAIL	JAMB DETAIL	REMARKS
A	GARAGE	3'-0" x 1'-11"	EX	7'-3" (E)	F					
В	NOT USED									
С	LIVING ROOM	14'-5" x 8'-8"	A	8'-8"	F	T, LOW-E				CORNER WDW W/ UNIT D - BUTT GLAZED @ CORNER
D	LIVING ROOM	8'-4 1/2" x 8'-8"	A	8'-8"	F	T, LOW-E				CORNER WDW W/ UNIT C - BUTT GLAZED @ CORNER
E	DINING ROOM	4'-10" x 7'-2"	EX	7'-6" (E)						
F	STUDY	5'-8" x 3'-8"	EX	7'-7" (E)						
G	STUDY	5'-8" x 3'-8"	EX	7'-7" (E)						
н	KITCHEN	4'-8" x 7'-7"	EX	7'-8" (E)						
I	KITCHEN	3'-10" x 5'-1"	EX	7'-9" (E)						
J	KITCHEN	4'-9" x 4'-0"	EX	7'-11" (E)						
К	POWDER ROOM	1'-7" x 3'-8"	EX	6'-5" (E)						
L	LIVING ROOM	4'-4 ¹ / ₂ " x 4'-8 ¹ / ₂ "	B	8'-8"	F/C	LOW-E				
М	LIVING ROOM	4'-4 ¹ / ₂ " x 4'-8 ¹ / ₂ "	B	8'-8"	F/C	LOW-E				
N	MASTER BEDROOM	12'-8 1/2" x 5'-2"	A	6'-8"	F	LOW-E				CORNER WDW W/ UNIT O - BUTT GLAZED SPLICED & CORNER
0	MASTER BEDROOM	6'-7" x 5'-2"	A	6'-8"	F	LOW-E				CORNER WDW W/ UNIT N - BUTT GLAZED @ CORNER
Р	MASTER BEDROOM	4'-2 ¹ / ₂ " x 3'-5"	A	6'-5"	С	LOW-E				
Q	PLAY AREA	3'-0" x 4'-1"	A	6'-5"	F	LOW-E				CORNER WDW W/ UNIT R - BUTT GLAZED @ CORNER
R	PLAY AREA	3'-0" x 4'-1"	A	6'-5"	F	LOW-E				CORNER WDW W/ UNIT Q - BUTT GLAZED @ CORNER
S	GABRIEL'S BEDROOM	8'-6" x 4'-1"	B	6'-5"	F	LOW-E				CORNER WDW W/ UNIT T
Т	GABRIEL'S BEDROOM	5'-3" x 4'-1"	B	6'-5"	F/C	LOW-E				CORNER WDW W/ UNIT S ; 1'-11" WIDE OPERABLE SASH
U	GUEST BEDROOM	3'-5" x 4'-1"	B	6'-5"	С	LOW-E				
V	GUEST BEDROOM	5'-11" x 4'-1"	B	6'-5"	F/C	LOW-E				1'-11" WIDE OPERABLE SASH
W	GUEST BEDROOM	3'-10" x 4'-1"	<u>(C)</u>	7'-9"	G	LOW-E				
X	BATHROOM	1'-11" x 2'-10"	EX	6'-5" (E)						
Y	CHARLOTTE'S B.R.	3'-5" x 4'-1"	A	6'-5" (E)						
Z	CHARLOTTE'S B.R.	3'-5" x 4'-1"	A	6'-5" (E)						
AA	HALLWAY	2'-6" x 4'-0"	A	8'-6"	С	LOW-E				
BB	MASTER BATHROOM	4'-9 ¹ / ₂ " x 3'-5"	A	7'-11"	F	LOW-E				
СС	MASTER BEDROOM	10'-0" x 3'-5"	A	6'-5"	F/C	LOW-E				
DD	MASTER BEDROOM	8'-6" x 3'-5"	A	6'-5"	F	LOW-E				

* WINDOW TYPES:

(A) = NEW METAL WINDOW W/ CONCEALED FRAME

(B) = NEW WOOD WINDOW TO MATCH EXISTING (NOTE REVISED HEIGHT AT WINDOW "M")

 \bigcirc = NEW GREENHOUSE WINDOW TO MATCH EXISTING

EX = EXISTING WOOD WINDOW TO REMAIN

DEL = EXISTING WOOD WINDOW TO BE REMOVED

LEGEND:

C - CASEMENT F - FIXED A - AWNING S - SLIDING D - DOUBLE HUNG G- GREENHOUSE T - TEMPERED SAFETY GLASS GENERAL NOTES

1. ALL (N) WINDOWS AND DOORS TO HAVE A U-FACTOR IN ACCORDANCE WITH THE CBC' ALL (N) GLAZING TO BE DOUBLE GLAZED INSULATED GLASS UNITS (IGU) UNLESS OTHERWISE NOTED

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