MEMO

Disclaimer for Review of Plans

The San Francisco Planning Code requires that the plans of certain proposed projects be provided to members of the public prior to the City's approval action on the project. Accordingly, any images of plans featured on this website are provided for the primary purpose of facilitating public input prior to the City's action. The City and County of San Francisco does not own the copyright to these images. Please be aware that the unauthorized reproduction, distribution, or alteration of these images may result in a violation of Federal Copyright Law (17 U.S.C.A. Sections 101 et seq.) and that any party who seeks to reproduce or alter these images does so at his or her own risk.

Additionally, plans provided on this website are limited to site plans, elevations and/or section details (floor plans and structural details may not be included). These are DRAFT PLANS being provided for public review PRIOR to the City's approval action on the project. Final plans may differ from those that are currently available for review.

1650 Mission St. Suite 400 San Francisco, CA 94103-2479

Reception: 415.558.6378

Fax: 415.558.6409

Planning Information: 415.558.6377 NOTICE OF PUBLIC HEARING

Hearing Date: Wednesday, December 04, 2013

Time: 9:30 AM

Location: City Hall, 1 Dr. Carlton B. Goodlett Place, Room 408

Case Type: Variance(Rear Yard, Open Space and Exposure)

Hearing Body: Zoning Administrator

PORPERTY INFORMATION		APPLICATION INFORMATION		
Project Address:	5000 Mission St	Case No.:	2013.0555V	
Cross Street(s):	Bertita St and Seneca Ave	Building Permit:	2013.07.30.3164	
Block / Lot No.:	6968/008	Applicant/Agent:	Brett Gladstone	
Zoning District(s):	NC-3 / 40-X	Telephone:	415-995-5065	
Area Plan:	N/A	E-Mail:	bgladstone@hansonbridgett.com	

PROJECT DESCRIPTION

The proposal includes legalizing two dwelling units that currently exist on the second story of a two-story mixed use building. Legalization of the units requires variances for rear yard and open space for both units and exposure for the rear unit. No off-street parking is currently provided on site, and none is proposed; therefore, an administrative parking waiver is also being sought.

PER SECTION 134 OF THE PLANNING CODE, the property is required to maintain a rear yard of approximately to 22 feet, 8 inches to 21 feet, 10 inches. The existing building extends approximately 11 to 14 feet into the required rear yard; therefore, the proposal to legalize the existing dwelling units on the upper floor will require a variance from the rear yard requirements.

PER SECTION 135(d) OF THE PLANNING CODE, the subject property is required to maintain 80 square feet of private open space per unit or 1.33 square feet for each one square foot of private usable open space if the open space common. The two units have a requirement of 212.8 square feet of common open space, which is satisfied in the rear yard, however the units do not have independent access to the rear yard. As such, the legalization of the dwelling units requires a variance from the open space requirement of the Planning Code

PER SECTION 140 OF THE PLANNING CODE, the subject property is required to have windows of each unit face directly on an open area. Since the rear yard of the subject property is not code compliant, the rear unit does not meet the exposure requirements. As such, the rear unit requires a variance from the exposure requirement of the Planning Code.

ADDITIONAL INFORMATION

FOR MORE INFORMATION, PLEASE CONTACT PLANNING DEPARTMENT STAFF:

Planner: Jessica Look Telephone: 415.575.6812 Mail: jessica.look@sfgov.org

ARCHITECTURAL PLANS: The site plan and elevations of the proposed project are available on the Planning Department's website at: http://sf-planning.org/ftp/files/notice/2013.0555V.pdf

中文詢問請電:558.6378

Para información en Español llamar al: 558.6378

GENERAL INFORMATION ABOUT PROCEDURES

VARIANCE HEARING INFORMATION

Under Planning Code Section 306.3, you, as a property owner or resident within 300 feet of this proposed project or interested party on record with the Planning Department, are being notified of this Variance Hearing. You are not obligated to take any action. For more information regarding the proposed work, or to express concerns about the project, please contact the Applicant/Agent or Planner listed on this notice as soon as possible. Additionally, you may wish to discuss the project with your neighbors and neighborhood association or improvement club, as they may already be aware of the project.

Persons who are unable to attend the public hearing may submit written comments regarding this application to the Zoning Administrator, Planning Department, 1650 Mission Street, Suite 400, San Francisco, CA 94103, by 5:00pm the day prior to the hearing. These comments will be made a part of the official public record, and will be brought to the attention of the person or persons conducting the public meeting or hearing

BUILDING PERMIT APPLICATION INFORMATION

Under Planning Code Section 311/312, the Building Permit Application for this proposal is also subject to a 30-day notification to occupants and owners within 150-feet of the subject property. **The mailing of such notification will be perfromed separately.**

BOARD OF APPEALS

An appeal of the approval (or denial) of a **variance application** by the Zoning Administrator may be made to the **Board of Appeals within 10 days** after the **Variance Decision Letter** is issued by the Zoning Administrator.

An appeal of the approval (or denial) of a **building permit application** by the Planning Department may be made to the **Board of Appeals within 15 days** after the **building permit** is issued (or denied) by the Director of the Department of Building Inspection.

Appeals must be submitted in person at the **Board's office at 1650 Mission Street, 3rd Floor, Room 304**. For further information about appeals to the Board of Appeals, including current fees, **contact the Board of Appeals** at **(415) 575-6880**.

ABOUT THIS NOTICE

The Planning Department is currently reviewing its processes and procedures for public notification as part of the Universal Planning Notification (UPN) Project. The format of this Public Hearing notice was developed through the UPN Project and is currently being utilized in a limited trial-run for notification of Variance Hearings.

If you have any comments or questions related to the UPN Project or the format of this notice, please visit our website at http://upn.sfplanning.org for more information.

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	GENERAL NOTES		SCOPE	OF WORK		DF.	RAWING INDEX	PROJECT NAME	
1. ALL WORK SHALL BE PERFORMED IN COMPLETE COMPLIANCE WITH ALL APPLICABLE CODES, LAWS, ORDINANCES AND REGULATIONS OF ALL AUTHORITIES HAVING JURISDICTION OVER THE WORK. ALL CONTRACTORS SHALL HOLD HARMLESS THE ARCHITECT/ENGINEER AND THE OWNER FROM ALL DAMAGES AND/OR PENALTY ARISING OUT OF VIOLATION THEREOF. 2. ALL ATTACHMENTS, CONNECTIONS OR FASTENING OF ANY NATURE ARE TO BE PROPERLY AND PERMANENTLY SECURED IN CONFORMANCE WITH THE BEST PRACTICE OF THE BUILDING INDUSTRY. DRAWINGS SHOWS ONLY SPECIAL REQUIREMENTS TO ASSIST THE CONTRACTOR AND DO NOT ILLUSTRATE EVERY DETAIL.		CONVERSION OF AN EXISTING COMMERCIAL SPACE TO TWO RESIDENTIAL UNITS OVER AN EXISTING COMMERCIAL UNIT (ALL WORK TO BE PERFORMED WITHIN EXISTING BOUNDARY OF THE BUILDING.)		A-0.1 COVER SHEET A-1.1 SITE PLANS, & NOTES A-2.1 EXISTING FLOOR PLANS		5000 Mission Stre SAN FRANCISCO,			
THE CONTRACTOR SHALL BE RESPONSIBL FORE BEGINNING WORK. ANY AND ALL DISTRIBUTION OF THE ARCHIT THE WORK. THE CONTRACTOR SHALL BE RESPONSIBL	LE FOR VERIFYING ALL CONDITIONS DIMENSIONS, AND MEASUREMENTS IN THE FIELD ISCREPANCIES, UNUSUAL CIRCUMSTANCES, ERRORS OMISSIONS AND/OR CONFLICTS TECT/ENGINEER'S AND THE OWNER ATTENTION IMMEDIATELY BEFORE PROCEEDING LE FOR COORDINATION BETWEEN ARCHITECTURAL, STRUCTURAL, FIRE PROTECTION,					A-3.2 BUI A-4.1 BUI	ILDING ELEVATIONS (FRONT & REAR) ILDING ELEVATIONS (LEFT & RIGHT) ILDING SECTIONS, & DETAILS EEN BUILDING CHECKLIST		
DERING AND INSTALLATION OF ANY WORF PICTED IN DRAWINGS OR NOT) WITH THE S JNLESS OTHERWISE NOTED, ALL ANGLES	SHALL BE RIGHT ANGLES, ALL LINES WHICH APPEAR PARALLEL SHALL BE PARALLEL,							consulti	n _y
ES TRUE LEVEL, PLUMB AND SQUARE. CONTRACTOR SHALL BE RESPONSIBLE FO PROVEMENTS TO REMAIN SHALL BE PROTI	SHALL BE CENTERED. CONTRACTOR SHALL BE RESPONSIBLE FOR MAINTAINING ALL OR ALL SHORING AND PROTECTION DURING CONSTRUCTION. ALL EXISTING FECTED. ALL MATERIALS DELIVERED TO THE SITE SHALL BE PROPERLY STORED AND BER SHALL BE PROTECTED FROM MOISTURE AND STORED ABOVE GROUND.							Corporati	an .
DETAILED AND/OR LARGER SCALE DRAWINGURED DIMENSIONS SHALL TAKE PRECEDENTALL WORK SHALL BE DONE UNDER PERMIT	NGS SHALL TAKE PRECEDENCE OVER GENERAL AND SMALLER SCALE DRAWINGS. ENCE OVER SCALED DIMENSIONS. ALL SCALED DIMENSIONS SHALL BE VERIFIED. T. PLANS AND CALCULATIONS, IF REQUIRED, SHALL BE SUBMITTED TO AND APPROVED								SULTING CORPOR 1256 HOWARD ST N FRANCISCO CA
	OR SHALL BE RESPONSIBLE FOR OBTAINING ALL REQUIRED PERMITS. RE PROTECTION, PLUMBING AND COMMUNICATIONS ARE DESIGN BUILD ITEMS.		ABBF	REVIATION			PROJECT DATA		TEL: (415) 92: FAX: (415) 92:
CHITECTURAL DRAWINGS SHOW DESIGN I NER AND ARCHITECT PRIOR TO INSTALLA	INTENT, CONTRACTOR TO CONFIRM ALL SYSTEM REQUIREMENTS WITH BUILDING ATION. CONTRACTOR/SUBCONTRACTOR SHALL SUBMIT PLANS FOR THEIR RESPECTIVE			, , , , , , , , , , , , , , , , , , ,		LOT AREA:	2,221 ± S.F.	WEBSITE:W SHEET TITLE	WW. SIACÒNŚUL
ORK TO THE BUILDING DEPARTMENT AS RE ECK AND PERMIT FEES. THE CONTRACTOR SHALL BE RESPONSIB	EQUIRED FOR PLAN CHECK AND PERMIT ISSUANCE, INCLUDING PAYING FOR ALL PLAN BLE FOR APPLYING AND OBTAINING ALL REQUIRED INSPECTIONS TO CONFORM WITH	# & @ ABV	POUND OR NUMBER AND AT ABOVE	H.C. HI HM HP	HANDICAPPED HIGH HOLLOW METAL HIGH POINT	(E) NUMBER OF UNITS:	1 COMMERCIAL UNIT, &		
CAL BUILDING AND FIRE CODES. DO NOT SCALE DRAWINGS. WRITTEN DIM	MENSIONS GOVERN	ACT AD AFF	ACOUSTIC CEILING TILE AREA DRAIN ABOVE FINISHED FLOOR	HR HVAC	HOUR HEATING, VENTILATING, AND AIR CONDITIONING	(N) NUMBER OF UNITS:	1 RESIDENTIAL UNIT 1 COMMERCIAL UNIT, &		
DETAILS SHOWN ARE TYPICAL, SIMILAR D		ALUM APPROX	ALUMINUM APPROXIMATE	IRGWB	IMPACT RESISTANT GYPSUM WALLBOARD	(14) INDER OF CIVITO.	2 RESIDENTIAL UNITS	Cove	er Shee
VERIFY CLEARANCES FOR VENTS, CHASE ANY ITEM OF WORK.	ES, SOFFITS, FIXTURES BEFORE ANY CONSTRUCTION, ORDERING OF , OR INSTALLATION	ANOD ASPH BD	ANODIZED ASPHALT BOARD	ILO INSUL INT	IN LIEU OF INSULATED INTERIOR	NUMBER OF STORIES:	2 (NO CHANGE)		
UNLESS OTHERWISE NOTED, THE CONTR	RACTOR SHALL PROVIDE SOLID BLOCKING AND BACKING AS REQ'D FOR ALL NAILING OF COORDINATE AND PROVIDE ALL FRAMING, BACKING AND BRACING AS NECESSARY FOR	BLDG BLKG BOT	BUILDING BLOCKING BOTTOM	LO MAX MECH	LOW MAXIMUM MECHANICAL	CONSTRUCTION TYPE:	V-B		
TALLATION OF EQUIPMENT INDICATED ON	N THE DRAWINGS, PROVIDE BACKING PLATES AT ALL BATH ACCESSORIES, HANDRAILS, IXTURES AND ANY OTHER ITEMS ATTACHED TO WALLS.	BSMT BST	BASEMENT BOTTOM OF STAIRS	MECH MEMBR MIN	MEMBRANE MINIMUM	OCCUPANCY GROUP:	M & R-3 (NO CHANGE)		
· · · · · · · · · · · · · · · · · · ·	D MATERIALS PER MANUFACTURER'S RECOMMENDATIONS AND CODE REQUIREMENTS. NT ASSOCIATED WITH PLUMBING, ELECTRICAL, MECHANICAL SYSTEMS SHALL BE LISTED	BYND CIP CHNI	BEYOND CAST IN PLACE CHANNEL	MO MTL (N)	MASONRY OPENING METAL NEW	BLOCK & LOT:	6968-008		
A NATIONALLY RECOGNIZED AND APPROV	VED AGENCY.	CJ CLG	CONTROL JOINT CEILING	NIC NO	NOT IN CONTRACT NUMBER	ZONING:	NC-3		
THERMAL AND SOUND INSULATING INSU	LATION SHALL COMPLY WITH CBC SEC. 719. COMPLY WITH CBC CHAPTER 8.	CLO CLR CNTR	CLOSET CLEAR COUNTER	NOM N.T.S. O.C.	NOMINAL NOT TO SCALE ON CENTER	APPLICABLE CODES:	2010 CALIFORNIA CODES EDITIONS W/ SAN FRANCISCO AMENDMENTS		
ALL NEW SMOKE DETECTORS TO E HARD		CMU COL COMPR	CONCRETE MASONRY UNIT COLUMN COMPRESSIBLE	OFF OH	OFFICE OPPOSITE HAND OUNCE	GROSS FLOOR AREA:			
		CONC CONT	CONCRETE CONTINUOUS	PCC P.L.	PRE-CAST CONCRETE PROPERTY LINE	(E) FIRST FLOOR AREA:	1,938 ± S.F. (NO CHANGE)		
		CORR CPT CT	CORRIDOR CARPET CERAMIC TILE	PLUMB PLYD PT	PLUMBING PLYWOOD PRESSURE TREATED	(E) SECOND FLOOR AREA:	1,902 ± S.F. (NO CHANGE)		
	ILDING ENVELOPE IS NOT UNDER THE SCOPE OF THIS PERMIT OOFING EXPERT TO PROVIDE WATERPROOFING DETAILS	CTYD	CENTER COURTYARD	PNT PVC	PAINT/PAINTED POLYVINYL CHLORIDE	(E) TOTAL BLDG. GROSS AREA:	3,840 ± S.F. (NO CHANGE)	and are not to be pro	e property of SIA CONS
		DBL DEMO DET	DOUBLE DEMOLISH DETAIL	квк RCP RD	RUBBER REFLECTED CEILING PLAN ROOF DRAIN	HABITABLE FLOOR AREA: (E) COMMEDIAL SDACE AREA (FIRST F	TID): 1760 . C.E. (NO OLIANOE)	without the expresse CONSULTING ENG ISSUES / REVIS	d written consent of SIA INEERS.
		D.F. DIA	DRINKING FOUNTAIN DIAMETER DIMENSIONS	RDWD REQD RM	REDWOOD REQUIRED ROOM	(E) COMMERCIAL SPACE AREA (FIRST F (E) UNIT 1 FLOOR AREA (SECOND FLR.)		NO. DATE	DESCRIPTION
	BERTITA	DIIVIS DN DR	DOWN DOOR	S.F. SIM	SQUARE FOOT SIMILIAR	(E) UNIT 2 FLOOR AREA (SECOND FLR.)	· · ·		
/07.20 //07.20 24 23 25 25 25	25 25 25 25 25 36 39 27.50 27.50 30.6 25 25 25 25 25 36 39 27.50 27.50 30.6 27.50 27.50 30.6 27.50 27.50 30.6 27.50 27.50 30.6 27.50 30.6	EA EL ELEC ELEV EQ	DRAWING EXISTING EACH ELEVATION ELECTRICAL ELEVATOR/ELEVATION EQUAL	SPEC SPK SSTL STC STD STL	SPECIFIED OR SPECIFICATION SPRINKLER STAINLESS STEEL SOUND TRANSMISSION COEFFICIENT STANDARD STEEL				
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25 25 25 25 25 25 2005	96.97 96.97 98.75 98	FIXT FLR FLUOR	FIXTURE FLOOR FLUORESCENT	TLT TO TOC	TOILET TOP OF TOP OF CONCRETE				
62to(5.67 95.23	3 867.85 867.85 867.85 867.85 867.85 867.85	FM FND FO	FILLED METAL FOUNDATION FACE OF	TOS TP T/D	TOP OF STEEL TOILET PAPER DISPENSER TELEPHONE/DATA			CHECKED	R.K.
74 567.85 867.85 867.85 867.85 867.8	SUBJECT PARCEL	F.O.F. FURR GA	FACE OF FININSH FURRING GAUGE	TST TYP U.N.O.	TOP OF STAIRS TYPICAL UNLESS NOTED OTHERWISE			DATE	10/03/2012
361.96	WIDO	GALV G.B. GND	GALVANIZED GRAB BAR GROUND	U/S V.I.F. VP	UNDERSIDE VERIFY IN FIELD VISION PANEL			REVISED DATE	10/21/2013
		GRP GWB	GROUP GYPSUM WALL BOARD	W/ WD	WITH WOOD			JOB NO.	12-1542
	ASSESSOR'S MAP	GYP	GYPSUM	W.H.	WATER HEATER			SHEET NO.	A-0.1

(E) REAR YARD _____15'-0" ± _____ (E) LIGHT WELL ONE-STORY 5006 MISSION ST. 5000 MISSION ST. <u>4998 MISSION ST.</u> (E) TWO-STORY (E) TWO-STORY (E) ONE-STORY LOT 009 BLCOK & LOT 6968 / 008 LOT 007 (N) MIN. 24" BOX---STREE TREE (E) RAMP TO REMAIN Existing Site Plan **BLOCK & LOT: 6968-008** PROPERTY LINE: _-----**OUTLINE OF SUBJECT BUILDING:** OUTLINE OF NEIGHBORS BUILDING:

DOOR / WINDOW NOTES:

1. ALL ESCAPE OR RESCUE DOORS & WINDOWS FROM SLEEPING ROOMS SHALL COMPLY WITH SEC. 1029:

- NET CLEAR HEIGHT: 24" MIN.

- NET CLEAR WIDTH: 20" MIN.

- NET OPENING: 5.7 SQ. FT. MIN. - FINISHED SILL HEIGHT: 44" MAX. ABOVE THE FINISHED FLOOR

2. VERIFY IN FIELD FOR EXACT DOORS & WINDOWS SIZE PRIOR TO PURCHASE 3. VERIFY ALL ROUGH OPENINGS DIMENSIONS IN FIELD PRIOR TO INSTALLATION OF WIDOWS

4. U-FACTOR OF GLAZING SHALL BE 0.55, UNLESS SPECIFIED ON PLANS OR ENERGY COMPLIANCE REPORT.

5. NFRC LABELS ON NEW DOOR / WINDOWS SHALL NOT BE REMOVED UNTIL AFTER FINAL INSPECTION

6. COORDINATE INSTALLATION OF ALL FLASHINGS AND WINDOWS WITH INSTALLATION INSTRUCTIONS OF WINDOW MANUFACTURER. OBTAIN APPROVAL OF INSTALLATION METHODOLOGY FROM WINDOW MANUFACTURER PRIOR TO COMMENCING INSTALLATION. 4. UTILIZE PRIMERS AND / OR ADHESIVES COMPATIBLE WITH ALL MATERIALS AND AS

RECOMMENDED BY MANUFACTURER OF SELF-ADHERED MEMBRANE TO ACHIEVE TENACIOUS BOND OF MEMBRANE TO ALL SUBSTRATES. 5. UTILIZE SEALANTS COMPATIBLE WITH ALL MATERIALS AND AS RECOMMENDED BY WINDOW

AND SELF-ADHERED MEMBRANE MANUFACTURERS.

BEDROOM NOTES:

RESCUE WINDOW: EMERGENCY EGRESS WINDOWS SHALL HAVE A MIN. CLEAR OPENING AREA OF 5.7 SQ. FT., MIN. CLEAR WIDTH OF 20"; MIN. CLEAR HEIGHT OF 24"; AND MAX. HEIGHT FROM FINISHED FLOOR TO BOTTOM OF OPENING OF 44"

BATHROOM NOTES:

EXHAUST FANS ARE CAPABLE OF PROVIDING FIVE AIR CHANGES PER HOUR. **EXHAUST VENTS** W/ BACK DRAFT DAMPER SHALL TERMINATE MIN. 3 FEET FROM ANY PROPERTY LINE & BUILDING OPENINGS.

BRANCH CIRCUITS: A 20A CIRCUIT IS REUIRED TO SERVE THE REQUIRED BATHROOM OUTLETS. THIS CIRCUIT CANNOT SUPPLY ANY OTHER RECEP. LIGHTS, FANS, ETC.

NOTES:

1. SMOKE DETECTORS SHALL BE IN ALL BEDROOMS AND AREAS LEADING TO THEM.

2. ENVIRONMENTAL AIR DUCT EXHAUST W/ BACK DRAFT DAMPER SHALL TERMINATE 3 FEET MIN. FROM PROPERTY LINE & BUILDING OPENING.

3. VENTING SYSTEMS SHALL TERMINATE NOT LESS THAN 4 FEET BELOW OR 4 FEET HORIZONTALLY FROM, AND NOT LESS THAN ONE FOOT ABOVE A DOOR, AN OPENABLE WINDOW OR A GRAVITY AIR INLET INTO A BUILDING. VENTING SYSTEMS SHALL TERMINATE AT LEAST 3 FEET ABOVE AN OUTSIDE - OR MAKE UP - AIR INLET LOCATED WITHIN 10 FEET AND AT LEAST 4 FEET FROM A PROPERTY LING, EXCEPT A PUBLIC WAY.

ELECTRICAL NOTES:

SEPARATION.

ELECTRICAL SUBPANEL(S) ON FLOOR PLAN(S). PANELS SHALL NOT BE LOCATED IN THE VICINITY OF EASILY IGNITABLE MATERIAL(S) SUCH AS CLOTHES CLOSETS. PANELS IN FIREWALL SHALL BE RELOCATED OR PROPERLY PROTECTED TO MAINTAIN FIREWALL

GFCI PROTECTED OUTLETS AT THE FOLLOWING LOCATIONS.

(A) GARAGE (B) UNFINISHED BASEMENT, CRAWL AND STORAGE SPACES.

(C) WITHIN 6' OF SINK OR BASIN

(D) EXTERIOR (WATERPROOF)

RECEPTABLE OUTLETS AT THE FOLLOWING LOCATIONS. (A) 12' O.C. MAX, AND WITHIN 6' OF THE END OF WALLS.

(B) ANY WALL SPACE 2 OR MORE FEET WIDE.

(C) AT EACH KITCHEN AND DINING AREA COUNTER SPACE WIDER THAN 12'. SO THAT NO POINT IN ANY HALLWAY 10 FEET OR MORE IN LENGTH.

LIGHT FIXTURE IN TUB OR SHOWER ENCLOSURES AND EXTERIOR LIGHT FIXTURES SHALL BE LABELED "SUITABLE FOR DAMP LOCATIONS"

APPLIANCES FASTENED IN PLACE, SUCH AS DISHWASHERS, GARBAGE DISPOSALS, TRASH COMPACTORS, MICROWAVE OVENS, ETC., SHALL BE SUPPLIED BY A SEPARATE BRANCH CIRCUIT RATED FOR THE APPLIANCE OR LOAD SERVED.

RECEPTACLES FOR FIXED APPLIANCES SHALL BE ACCESSIBLE, NOT BEHIND APPLIANCE.

A CIRCUIT SUITABLE FOR THE LOAD WITH A MINIMUM OF 30 AMPERES IS REQUIRED FOR AN ELECTRIC CLOTHES DRYER.

LIGHT FIXTURES IN TUB OR SHOWER ENCLOSURES SHALL BE LABELED "SUITABLE FOR DAMP LOCATION(S)."

ENERGY NOTES:

PERMANENETLY INSTALLED LUMINAIRES IN KITCHENS SHALL BE HIGH EFFICACY LUMINAIRES. UP TO 50% OF WATTAGE, AS DETERMINED IN SECTION 130(C), OF PERMANENTLY INSTALLED LUMINAIRES IN KITCHENS MAY BE IN LUMINAIRES THAT ARE NOT HIGH EFFICACY LUMINAIRES, PROVIDED THAT THESE LUMINAIRES ARE CONTROLLED BY SWITCHES SEPERATE FROM THOSE CONTROLLING THE HIGH EFFICACY LUMINAIRES.

EACH ROOM CONTAINING A WATER CLOSET SHALL HAVE AT LEAST ONE LUMINAIRE WITH LAMPS WITH AN EFFICACY OF NOT LESS THAN 40 LUMENS PER WATT FOR 15 WATT OR SMALLER, 50 LUMENS PER WATT FOR 16 WATT-40WATT, & 60 LUMENS PER WATT FOR 40 WATT OR HIGHER. IF THERE IS MORE THAN ONE LUMINAIRE IN THE ROOM, THE HEIGHT EFFICACY LUMINAIRE SHALL BE SWITCHED AT AN ENTRANCE TO THE ROOM.

LIGHTING FIXTURES RECESSED INTO INSULATED CEILINGS MUST BE APPROVED FOR ZERO-CLEARANCE INSULATION COVER (I.C.) BY UNDERWRITERS LABORATORIES OR OTHER APPROVED LABORATORIES.

FIREPLACES, DECORATIVE GAS APPLIANCES AND GAS LOGS: INSTALLATION OF FACTORY-BUILT AND

MASONRY FIREPLACES SHALL INCLUDE: (A) CLOSABLE METAL OR GLASS DOORS.

(B) COMBUSTION AIR INTAKE (6 SQ. IN. MINIMUM) TO DRAW AIR FROM OUTSIDE OF THE BUILDING DIRECTLY INTO FIRE BOX. THE COMBUSTION AIR INTAKE MUST BE EQUIPPED WITH A READILY ACCESSIBLE. OPERABLE AND LIGHT-FITTING DAMPER OR COMBUSTION AIR CONTROL DEVICE. EXCEPTION: AN OUTSIDE COMBUSTION AIR INTAKE IS NOT REQUIRED IF THE FIREPLACE IS INSTALLED OVER CONCRETE SLAB FLOORING AND THE FIREPLACE IS NOT LOCATED ON AN EXTERIOR WALL. (C)A FLUE DAMPER WITH AN READILY ACCESSIBLE CONTROL..

EXCEPTION: WHEN A GAS LOG, LOG LIGHTER, OR DECORATIVE GAS APPLIANCE IS INSTALLED IN A FIREPLACE, THE FLUE DAMPER SHALL BE BLOCKED OPEN IF REQUIRED BY THE MANUFACTURER'S INSTALLATION INSTRUCTIONS OR THE STATE MECHANICAL CODE.

PLUMBING AND MECHANICAL NOTES:

AIR DUCTS SHALL BE NO.26 GA. GALVANIZED SHEET METAL OR A FIRE DAMPER PROVIDED WHEN THE DUCTS PENETRATE THE OCCUPANCY SEPARATION BETWEEN THE GARAGE AND THE HOUSE.

SMOOTH METAL DUCT FOR DRYER EXHAUST EXTENDING TO OUTSIDE.

NON-REMOVABLE BACKFLOW PREVENTION DEVICES ON ALL EXTERIOR HOSE BIBS.

SIZE OF WATER CLOSETS. MAXIMUM ALLOWABLE 1.6 GALLONS PER FLUSH.

SHOWER & TUB/SHOWERS SHALL BE PROVIDED WITH PRESSURE BALANCE OR THERMOSTATIC MIXING VALVE CONTROLS. HANDLE POSITION STOPS SHALL BE PROVIDED ON SUCH VALVES AND SHALL BE ADJUSTED PER MANUFACTURER'S INSTRUCTIONS TO DELIVER A MAXIMUM MIXED WATER SETTING OF 120 DEGREES F. THE WATER HEATER THERMOSTAT SHALL NOT BE CONSIDERED A SUITABLE CONTROL FOR MEETING THIS PROVISION, U.P.C. 4107.

DOORS & PANELS OF SHOWERS AND BATHTUBS ENCLOSURES AND ADJACENT WALL OPENINGS WITHIN 60" ABOVE A STANDING SURFACE AND DRAIN INLET SHALL BE FULLY TEMPERED. LAMINATED SAFETY GLASS OR APPROVED PLASTIC.

TEMPERED GLASS SHALL BE AFFIXED WITH A PERMANENT LABEL.

SANITATION NOTES:

SHOWER STALL FINISH SHALL BE CERAMIC TILE EXTENDING 70 INCHES ABOVE THE DRAIN INLET

MOISTURE RESISTANT UNDERLAYMENT (e.g. WATER RESISTANT GYP. BD.) TO A HEIGHT OF 70 INCHES ABOVE THE DRAIN INLET U.B.C. 8067.1.3.

5000 Mission Street SAN FRANCISCO, CA

PROJECT NAME



SIA CONSULTING CORPORATION 1256 HOWARD STREET SAN FRANCISCO CA 94103 TEL: (415) 922.0200 FAX: (415) 922.0203 WEBSITE: WWW. SIACONSULT.COM

SHEET TITLE

Site Plan, & Notes

These documents are property of SIA CONSULTING and are not to be produced changed or copied without the expressed written consent of SIA CONSULTING ENGINEERS.

DESCRIPTION

ISSUES / REVISIONS

NO. DATE


A.M. DRAWN CHECKED R.K.

DATE 10/03/2012 **REVISED DATE** 10/21/2013

JOB NO.


SHEET NO.

12-1542

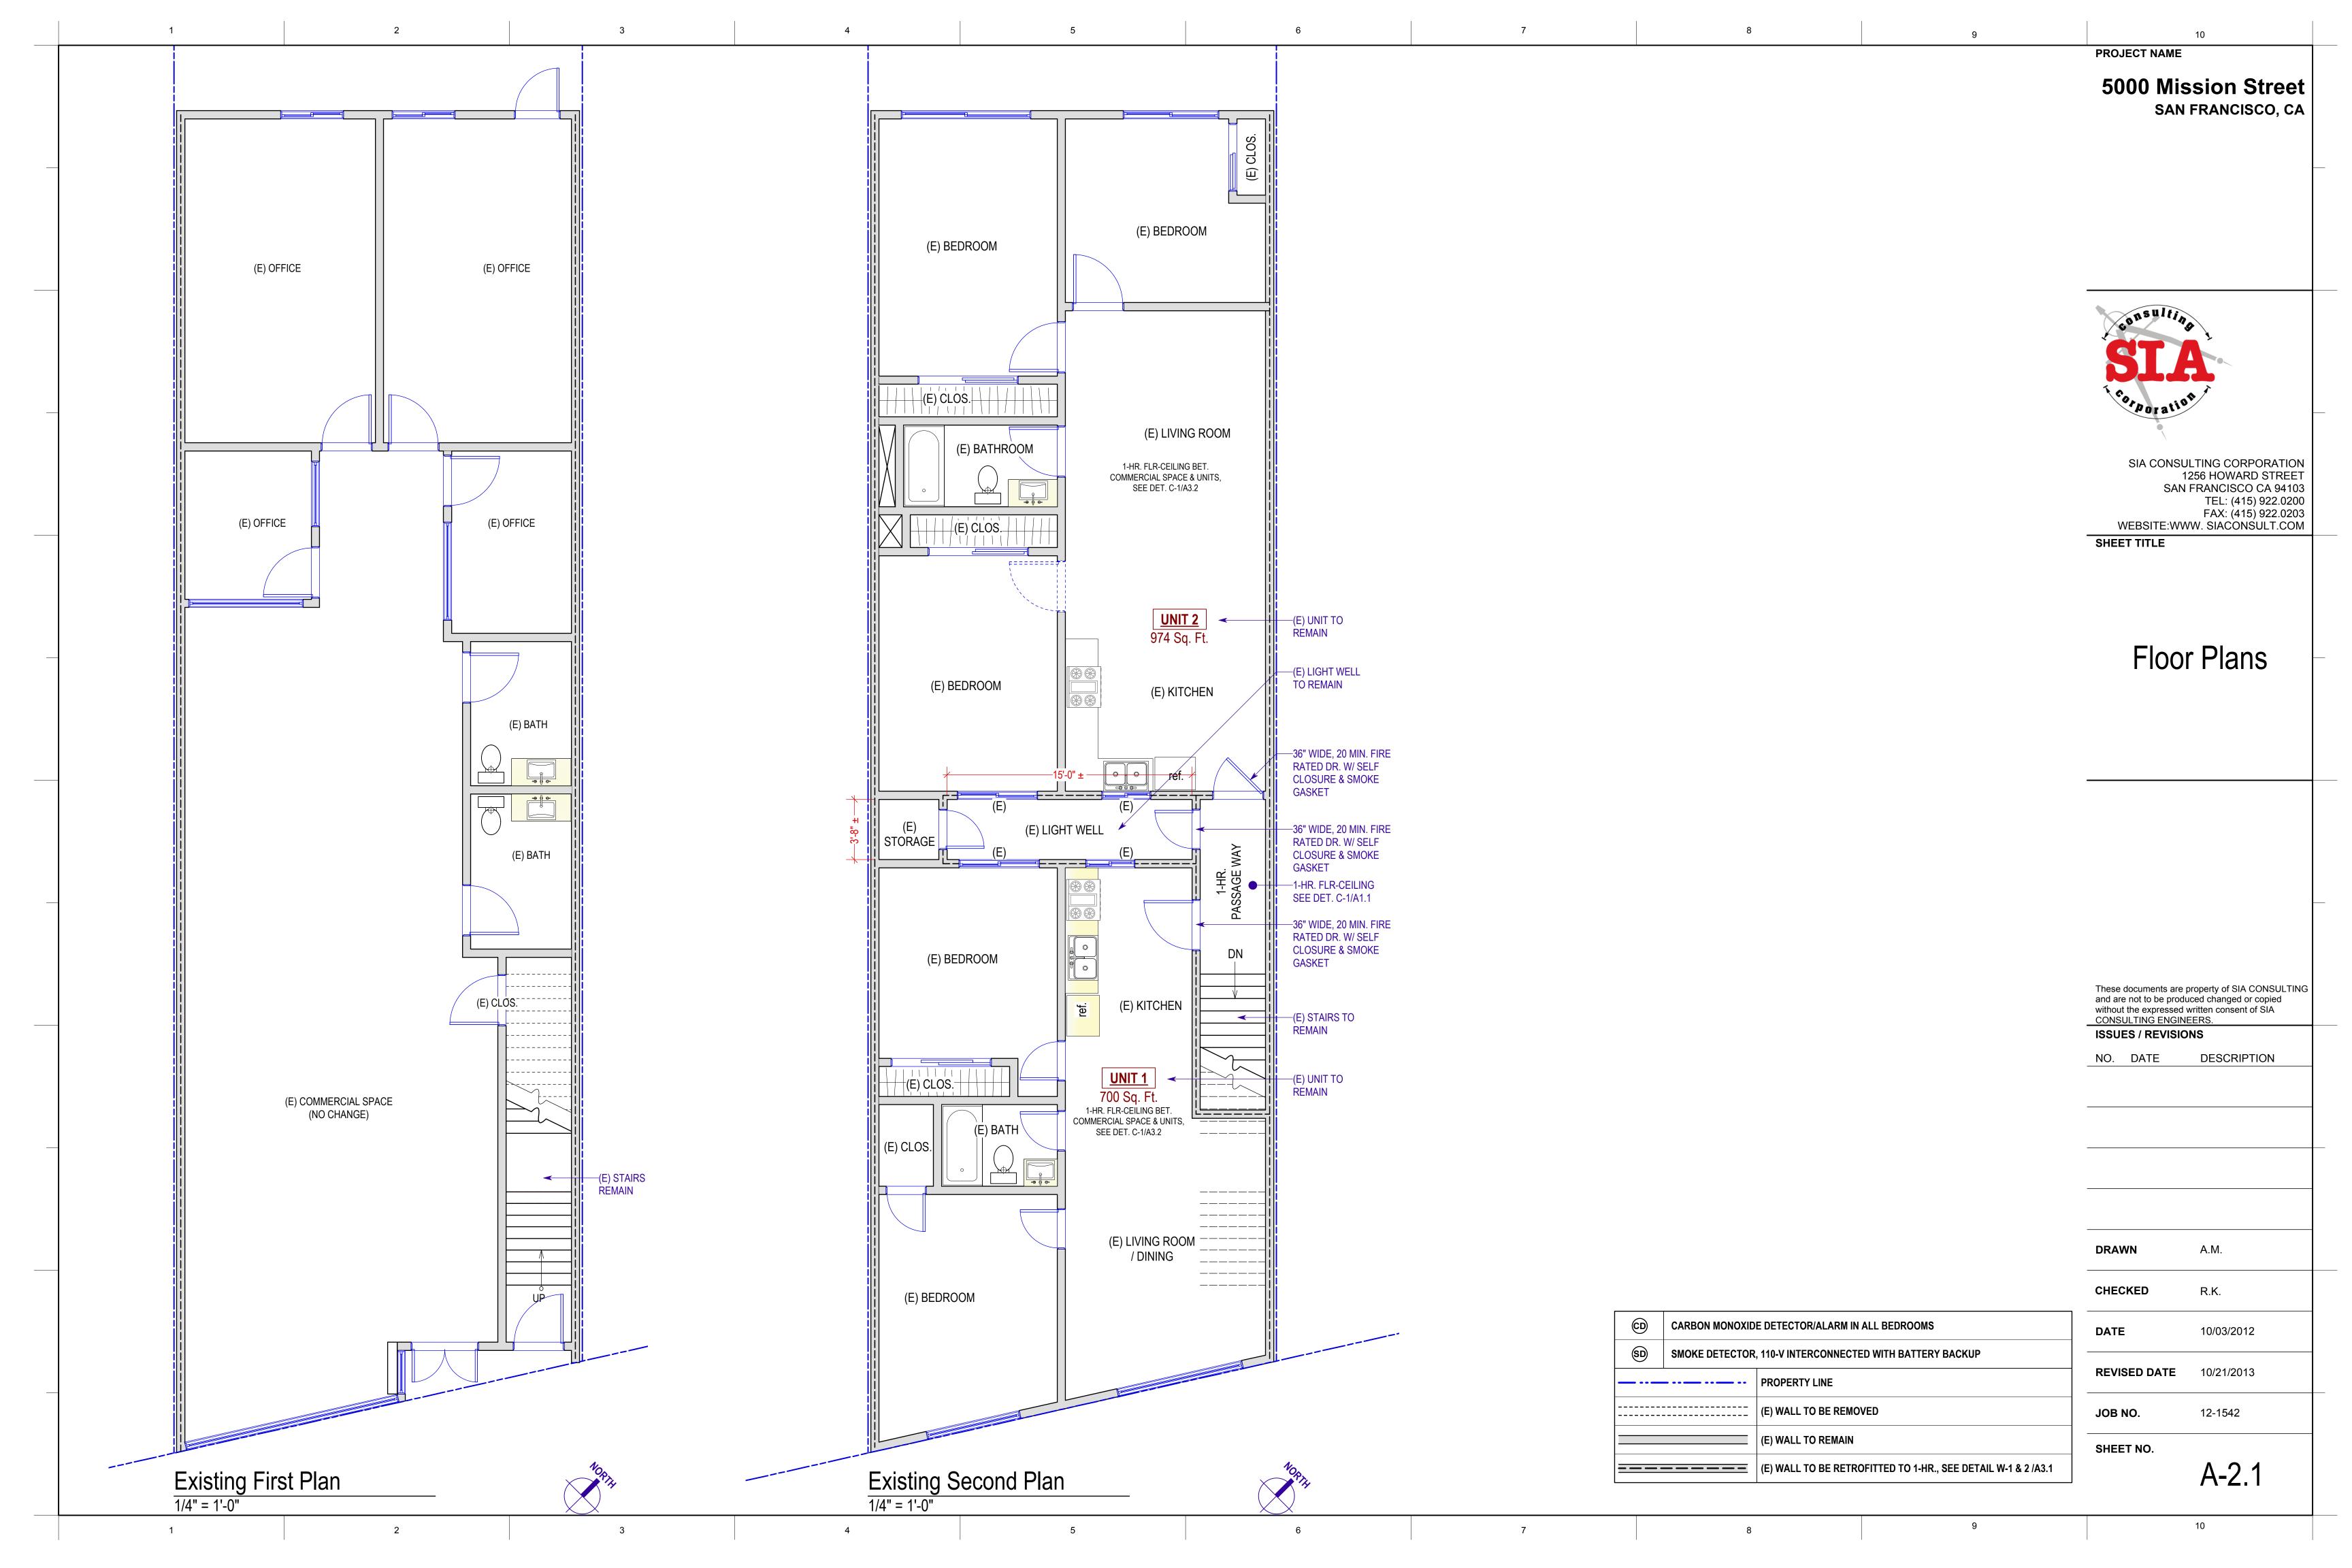



	PROJECT NAME
	5000 Mission Street SAN FRANCISCO, CA
	SAN FRANCISCO, CA
	consulting
PROFILE OF 5006 MISSION ST.	
	Poration
	SIA CONSULTING CORPORATION 1256 HOWARD STREET SAN FRANCISCO CA 94103 TEL: (415) 922.0200 FAX: (415) 922.0203 WEBSITE:WWW. SIACONSULT.COM
	FAX: (415) 922.0200 FAX: (415) 922.0203 WEBSITE:WWW. SIACONSULT.COM SHEET TITLE
	Building Flevations
Existing Left Elevation (no change) 1/4" = 1'-0"	Building Elevations (Left & Right)
1/4 - 1-0	
PROFILE OF 4998 MISSION ST.	
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	DRAWN A.M. CHECKED R.K. DATE 10/03/2012
	DRAWN A.M.
	DRAWN A.M.

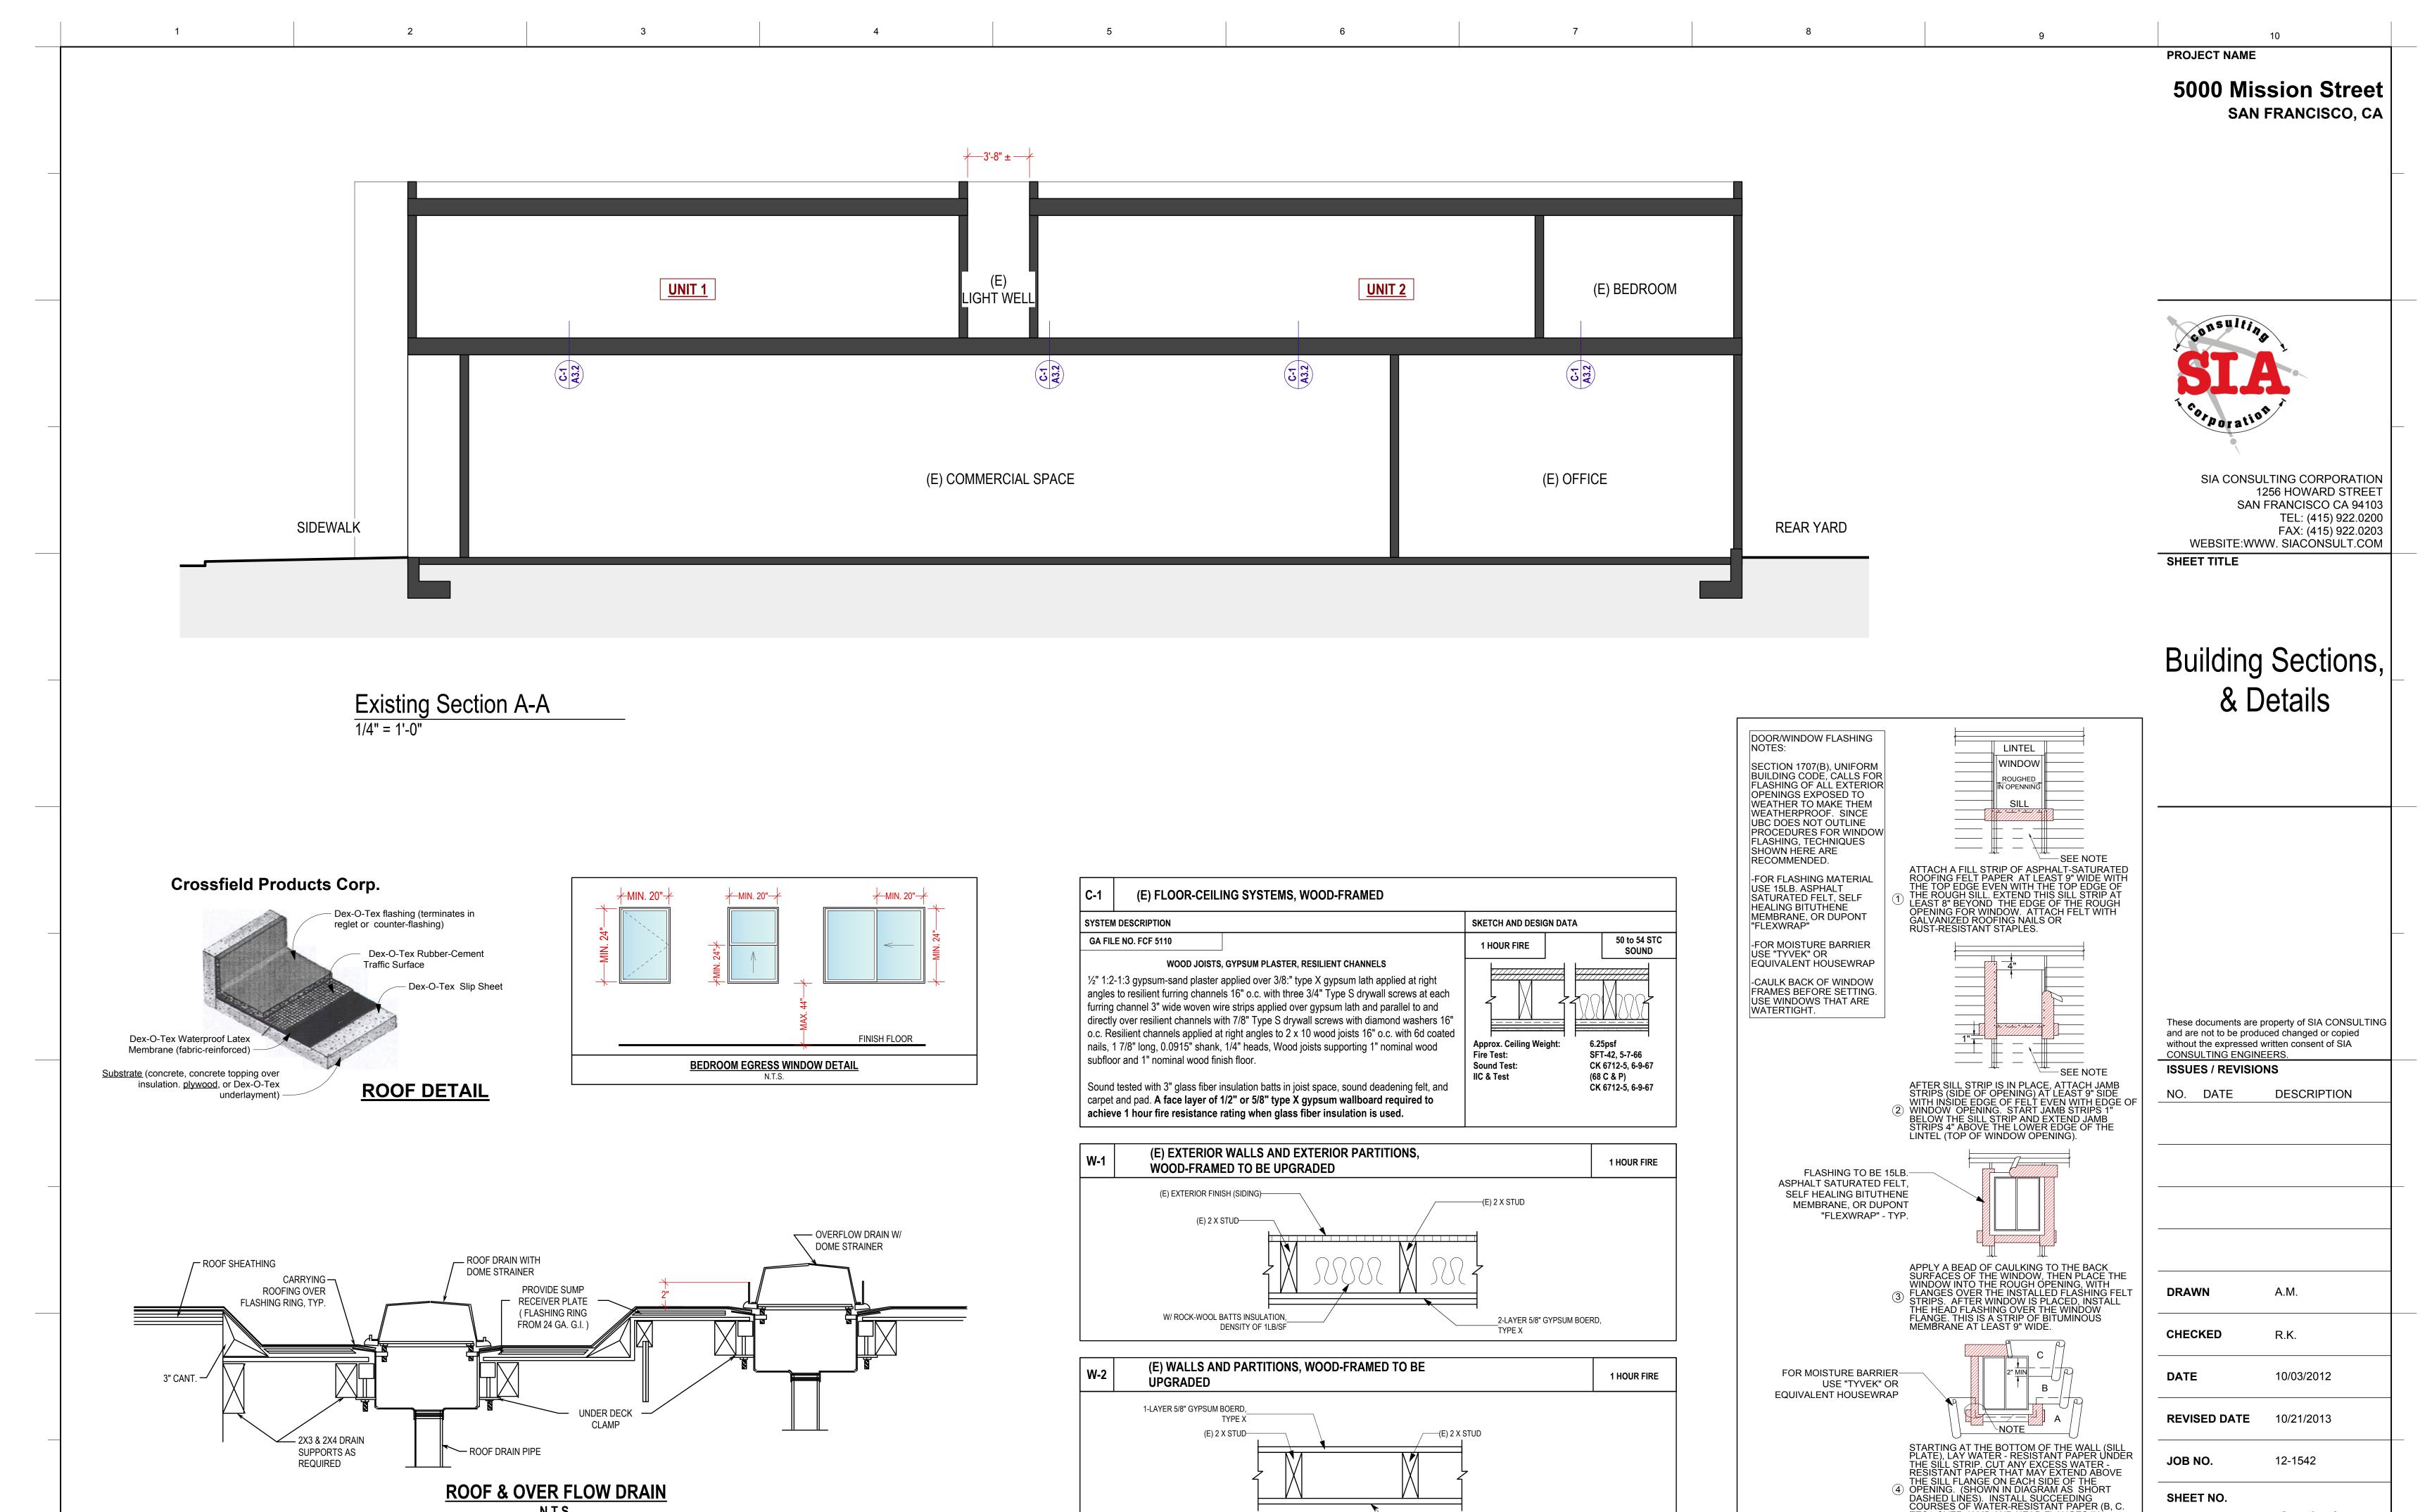

~1-LAYER 5/8" GYPSUM BOERD,

TYPE X

ETC.) OVER JAMB AND HEAD FLANGES IN SHINGLE-BOARD FASHION.

10

DOOR/WINDOW WATER PROOFING /

INSTALLATION DETAILS

Green Building: Site Permit Checklist

BASIC INFORMATION:

These facts, plus the primary occupancy, determine which requirements apply. For details, see AB 093 Attachment A Table 1.

	Project Name	Block/Lot	Address
	5000 Mission St.	6611 / 019	5000 Mission St.
l	Gross Building Area	Primary Occupancy	Design Professional/Applicant: Sign & Date
	4,000 sf +/-	NC-3	Sia Tahbazof
	# of Dwelling Units	Height to highest occupied floor	Number of occupied floors
	2	23'-0" +/-	2

Instructions:

As part of application for site permit, this form acknowledges the specific green building requirements that apply to a project under San Francisco Building Code Chapter 13C, California Title 24 Part 11, and related local codes. Attachment C3, C4, or C5 will be due with the applicable addendum. To use the form:

(a) Provide basic information about the project in the box at left. This info determines which green building requirements apply.

AND

(b) Indicate in one of the columns below which type of project is proposed. If applicable, fill in the blank lines below to identify the number of points the project must meet or exceed. A LEED or GreenPoint checklist is not required to be submitted with the site permit application, but such tools are strongly recommended to be used.

Solid circles in the column indicate mandatory measures required by state and local codes. For projects applying LEED or GreenPoint Rated, prerequisites of those systems are mandatory. This form is a summary; see San Francisco Building Code Chapter 13C for details.

ALL PROJECTS, AS APPLICAB	LE
Construction activity stormwater pollution prevention and site runoff controls - Provide a construction site Stormwater Pollution Prevention Plan and implement SFPUC Best Management Practices.	•
Stormwater Control Plan: Projects disturbing ≥ 5,000 square feet must implement a Stormwater Control Plan meeting SFPU€ Stormwater Design Guidelines	•
Water Efficient Irrigation - Projects that include ≥ 1,000 square feet of new or modified landscape must comply with the SFPUC Water Efficient Irrigation Ordinance.	•
Construction Waste Management – Divert at least 65% of construction and demolition debris by complying with the San Francisco Construction & Demolition Debris Ordinance)	•

GREENPOINT RATED PROJECTS Proposing a GreenPoint Rated Project (Indicate at right by checking the box.) Base number of required Greenpoints: Adjustment for retention / demolition of historic features / building: Final number of required points (base number +/adjustment) GreenPoint Rated (i.e. meets all prerequisites) Energy Efficiency: Demonstrate a 15% energy use reduction compared to 2008 California Energy Code, Title 24, Part 6. Meet all California Green Building Standards Code requirements (CalGreen measures for residential projects have been integrated into the GreenPoint Rated system.)

Notes

1) New residential projects of 75' or greater must use the "New Residential High-Rise" column. New residential projects with >3 occupied floors and less than 75 feet to the highest occupied floor may choose to apply the LEED for Homes Mid-Rise rating system; if so, you must use the "New Residential Mid-Rise" column.

2) LEED for Homes Mid-Rise projects must meet the "Silver" standard, including all prerequisites. The number of points required to achieve Silver depends on unit size. See LEED for Homes Mid-Rise Rating System to confirm the base number of points required.

3) Requirements for additions or alterations apply to applications received on or after July 1, 2012.

LEED PROJECTS						
	New Large Commercial	Kesinential	New Residential High-Rise ¹	Commerical Interior	Commercial Alteration	
Type of Project Proposed (Indicate at right)		Х				
Overall Requirements:	<u> </u>				L	
LEED certification level (includes prerequisites):	SILVER	SILVER	SILVER	SILVER	SILVER	SILVER
Base number of required points:	50	2	50	50	50	50
Adjustment for retention / demolition of historic features / building:				n/a		
Final number of required points (base number +/- adjustment)				50		
Specific Requirements: (n/r indicates a measure is no	ot required)					
Construction Waste Management – 75% Diversion LEED MR 2, 2 points	•	•	•	•	Meet C&D ordinance only	0
15% Energy Reduction Compared to Title-24 2008 (or ASHRAE 90.1-2007) LEED EA 1, 3 points	•	•	•	•	LE. prerequi	
Renewable Energy or Enhanced Energy Efficiency Effective 1/1/2012: Generate renewable energy on-site ≥1% of total annual energy cost (LEED EAc2), OR Demonstrate an additional 10% energy use reduction (total of 25% compared to Title 24 Part 6 2008), OR Purchase Green-E certified renewable energy credits for 35% of total electricity use (LEED EAc6).		n/r	n/r	n/r	n/r	n/r
Enhanced Commissioning of Building Energy Systems LEED EA 3	•		Meet	LEED prerequis	iites	
Water Use - 30% Reduction LEED WE 3, 2 points	•	n/r	•	Meet	LEED prerequis	sites
Enhanced Refrigerant Management LEED EA 4	•	n/r	n/r	n/r	n/r	n/r
Indoor Air Quality Management Plan LEED IEQ 3.1	•	n/r	n/r	n/r	n/r	n/r
Low-Emitting Materials LEED IEQ 4.1, 4.2, 4.3, and 4.4	•	n/r	•	•	•	•
Recycling by Occupants: Provide space for storage, collection, and loading of compost, recycling, and trash. Exceeds requirements of LEED MR prerequisite 1. See Administrative Bulletin 088 for details.	•	•	•	•	•	•
Bicycle parking: Provide short-term and long-term bicycle parking for 5% of total motorized parking capacity each, or meet San Francisco Planning Code Sec 155, whichever is greater, or meet LEED credit SSc4.2. (13C.5.106.4)	•	n/r See San Franci	sco Planning	6	n/r	n/r
Designated parking: Mark 8% of total parking stalls for low-emitting, fuel efficient, and carpool/van pool vehicles. (13C.5.106.5)	•	Code	155	•	n/r	n/r
Water Meters: Provide submeters for spaces projected to consume more than 1,000 gal/day, or more than 100 gal/day if in building over 50,000 sq. ft. (13C.5.303.1)	•	n/r	n/r	n/r	n/r	n/r
Air Filtration: Provide at least MERV-8 filters in regularly occupied spaces of mechanically ventilated buildings (or LEED credit IEQ 5). (13C.5.504.5.3)	•	n/r	n/r	•	n/r	n/r
Air Filtration: Provide MERV-13 filters in residential buildings in air-quality hot-spots (or LEED credit IEQ 5). (SF Health Code Article 38 and SF Building Code 1203.5)	n/r	•	•	n/r	n/r	n/r
Acoustical Control: wall and roof-ceilings STC 50, exterior windows STC 30, party walls and floor-ceilings STC 40. (13C.5.507.4)	•	See CBC	1207	•	n/r	n/r

Requirements below only apply when the measure is applicable to the project. Code references below are applicable to New Non-Residential buildings. Corresponding requirements for additions and alterations can be found in Title 24 Part 11, Division 5.7. Requirements for additions or alterations apply to applications received July 1, 2012 or after. ³	Other New Non- Residential	Addition >2,000 sq ft OR Alteration >\$500,000 ³	
Type of Project Proposed (Check box if applicable)			
Recycling by Occupants: Provide space for storage, collection, and loading of recycling, compost and trash. (13C.5.410.1, et al) - See Administrative Bulletin 088 for details.	•	•	
Energy Efficiency: Demonstrate a 15% energy use reduction compared to 2008 California Energy Code, Title 24, Part 6. (13C.5.201.1.1)	•	n/r	
Bicycle parking: Provide short-term and long-term bicycle parking for 5% of total motorized parking capacity each, or meet San Francisco Planning Code Sec 155, whichever is greater (or LEED credit SSc4.2). (13C.5.106.4)	•	•	
Fuel efficient vehicle and carpool parking: Provide stall marking for low-emitting, fuel efficient, and carpool/van pool vehicles; approximately 8% of total spaces. (13C.5.106.5)	•	•	
Water Meters: Provide submeters for spaces projected to consume >1,000 gal/day, or >100 gal/day if in buildings over 50,000 sq. ft.	•	•	
Indoor Water Efficiency: Reduce overall use of potable water within the building by 20% for showerheads, lavatories, kitchen faucets, wash fountains, water closets, and urinals. (13C.5.303.2)	•	•	
Commissioning: For new buildings greater than 10,000 square feet, commissioning shall be included in the design and construction of the project to verify that the building systems and components meet the owner's project requirements. (13C.5.410.2) OR for buildings less than 10,000 square feet, testing and adjusting of systems is required.	•	(Testing & Balancing)	
Protect duct openings and mechanical equipment during construction (13C.5.504.3)	•	•	
Adhesives, sealants, and caulks: Comply with VOC limits in SCAQMD Rule 1168 VOC limits and California Code of Regulations Title 17 for aerosol adhesives. (13C.5.504.4.1)	•	•	
Paints and coatings: Comply with VOC limits in the Air Resources Board Architectural Coatings Suggested Control Measure and California Code of Regulations Title 17 for aerosol paints. (13C.5.504.4.3)	•	•	
Carpet: All carpet must meet one of the following: 1. Carpet and Rug Institute Green Label Plus Program 2. California Department of Public Health Standard Practice for the testing of VOCs (Specification 01350) 3. NSF/ANSI 140 at the Gold level 4. Scientific Certifications Systems Sustainable Choice AND Carpet cushion must meet CRI Green Label, AND Carpet adhesive must not exceed 50 g/L VOC content. (13C.5.504.4.4)		•	
Composite wood: Meet CARB Air Toxics Control Measure for Composite Wood (13C,5,504,4.5)	•	•	
Resilient flooring systems: For 50% of floor area receiving resilient flooring, install esilient flooring complying with the VOC-emission limits defined in the 2009 Collaborative or High Performance Schools (CHPS) criteria or certified under the Resilient Floor Covering Institute (RFCI) FloorScore program. (13C.5.504.4.6)	•	•	
Environmental Tobacco Smoke: Prohibit smoking within 25 feet of building entries, outdoor air intakes, and operable windows. (13C.5.504.7)	•	•	
Air Filtration: Provide at least MERV-8 filters in regularly occupied spaces of nechanically ventilated buildings. (13C.5.504.5.3)	[14] (14) (14) (14)	Limited exceptions. See CA T24 Part 11 Section 5.714.6	
Acoustical Control: Wall and roof-ceilings STC 50, exterior windows STC 30, party valls and floor-ceilings STC 40. (13C.5.507.4)	•	See CAT24 Part 11 Section 5.714.7	
CFCs and Halons: Do not install equipment that contains CFCs or Halons. (13C.5.508.1)	•	•	
dditional Requirements for New A, B, I, OR M Occupancy Projects 5,0	000 - 25,000 S	quare Feet	
construction Waste Management – Divert 75% of construction and demolition ebris (i.e. 10% more than required by the San Francisco Construction & Demolition Debris rdinance)	•	Meet C&D ordinance only	
Renewable Energy or Enhanced Energy Efficiency ffective January 1, 2012: Generate renewable energy on-site equal to ≥1% of total annual energy cost (LEED EAc2), OR emonstrate an additional 10% energy use reduction (total of 25% compared to Title 24 art 6 2008), OR urchase Green-E certified renewable energy credits for 35% of total electricity use EED EAc6).	•	n/r	

PROJECT NAME

5000 Mission StreetSAN FRANCISCO, CA



SIA CONSULTING CORPORATION 1256 HOWARD STREET SAN FRANCISCO CA 94103 TEL: (415) 922.0200 FAX: (415) 922.0203

SHEET TITLE

Green Building Checklist

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ISSUES / REVISIONS

NO. DATE DESCRIPTION

DRAWN A.M.

CHECKED R.K.

DATE 10/03/2012

REVISED DATE 10/21/2013

JOB NO.
SHEET NO.

GP-0.1

12-1542