MEMO

Disclaimer for Review of Plans

The San Francisco Planning Code requires that the plans of certain proposed projects be provided to members of the public prior to the City's approval action on the project. Accordingly, any images of plans featured on this website are provided for the primary purpose of facilitating public input prior to the City's action. The City and County of San Francisco does not own the copyright to these images. Please be aware that the unauthorized reproduction, distribution, or alteration of these images may result in a violation of Federal Copyright Law (17 U.S.C.A. Sections 101 et seq.) and that any party who seeks to reproduce or alter these images does so at his or her own risk.

Additionally, plans provided on this website are limited to site plans, elevations and/or section details (floor plans and structural details may not be included). These are DRAFT PLANS being provided for public review PRIOR to the City's approval action on the project. Final plans may differ from those that are currently available for review.

1650 Mission St. Suite 400 San Francisco, CA 94103-2479

Reception: 415.558.6378

Fax: 415.558.6409

Planning Information: 415.558.6377 NOTICE OF PUBLIC HEARING

Hearing Date: Wednesday, September 26, 2012

Time: **9:30 AM**

Location: City Hall, 1 Dr. Carlton B. Goodlett Place, Room 408

Case Type: Variance(Rear Yard)
Hearing Body: Zoning Administrator

PORPERTY INFORMATION		APPLICATION INFORMATION		
Project Address:	85 Manchester St	Case No.:	2012.0749V	
Cross Street(s):	Stoneman	Building Permit:	2012.06.25.3340	
Block / Lot No.:	5523/029	Applicant/Agent:	Lorin Hill	
Zoning District(s):	RH-2 / 40-X	Telephone:	510 654-2552	
Area Plan:	N/A	E-Mail:	Ihill@hillarch.com	

PROJECT DESCRIPTION

85 MANCHESTER ST, Lot 029 in Assesor's Block 5523 in a RH-2(Residential- House, Two Family) Zoning District and a 40-X Height and Bulk District. The proposal is to construct a new two-level rear deck and stairs. The rear deck and stairs would be 12 feet deep and 15 feet wide, leaving a 5 foot side setback on each side.

PER SECTION 242(e)(2) OF THE PLANNING CODE the subject property is required to maintain a rear yard that is 45% of the depth of the lot - in this case approximately 36 feet. The proposed rear deck and stairs would encroach into the rear yard by approximately 12 feet, leaving a rear yard of 24 feet.

ADDITIONAL INFORMATION

FOR MORE INFORMATION, PLEASE CONTACT PLANNING DEPARTMENT STAFF:

Planner: Erika Jackson Telephone: 415-558-6363 Mail: erika.jackson@sfgov.org

ARCHITECTURAL PLANS: The site plan and elevations of the proposed project are available on the Planning Department's website at: http://sf-planning.org/ftp/files/notice/2012.0749V.pdf

中文詢問請電:558.6378

Para información en Español llamar al: 558.6378

GENERAL INFORMATION ABOUT PROCEDURES

VARIANCE HEARING INFORMATION

Under Planning Code Section 306.3, you, as a property owner or resident within 300 feet of this proposed project or interested party on record with the Planning Department, are being notified of this Variance Hearing. You are not obligated to take any action. For more information regarding the proposed work, or to express concerns about the project, please contact the Applicant/Agent or Planner listed on this notice as soon as possible. Additionally, you may wish to discuss the project with your neighbors and neighborhood association or improvement club, as they may already be aware of the project.

Persons who are unable to attend the public hearing may submit written comments regarding this application to the Zoning Administrator, Planning Department, 1650 Mission Street, Suite 400, San Francisco, CA 94103, by 5:00pm the day prior to the hearing. These comments will be made a part of the official public record, and will be brought to the attention of the person or persons conducting the public meeting or hearing

BUILDING PERMIT APPLICATION INFORMATION

Under Planning Code Section 311/312, the Building Permit Application for this proposal is also subject to a 30-day notification to occupants and owners within 150-feet of the subject property. **The mailing of such notification will be perfromed separately.**

BOARD OF APPEALS

An appeal of the approval (or denial) of a **variance application** by the Zoning Administrator may be made to the **Board of Appeals within 10 days** after the **Variance Decision Letter** is issued by the Zoning Administrator.

An appeal of the approval (or denial) of a **building permit application** by the Planning Department may be made to the **Board of Appeals within 15 days** after the **building permit** is issued (or denied) by the Director of the Department of Building Inspection.

Appeals must be submitted in person at the **Board's office at 1650 Mission Street, 3rd Floor, Room 304**. For further information about appeals to the Board of Appeals, including current fees, **contact the Board of Appeals** at **(415) 575-6880**.

ABOUT THIS NOTICE

The Planning Department is currently reviewing its processes and procedures for public notification as part of the Universal Planning Notification (UPN) Project. The format of this Public Hearing notice was developed through the UPN Project and is currently being utilized in a limited trial-run for notification of Variance Hearings.

If you have any comments or questions related to the UPN Project or the format of this notice, please visit our website at http://upn.sfplanning.org for more information.


中文詢問請電:558.6378


Para información en Español llamar al: 558.6378

RESIDENCE

REAR YARD DECK ADDITION

85 MANCHESTER STREET, SAN FRANCISCO, CA

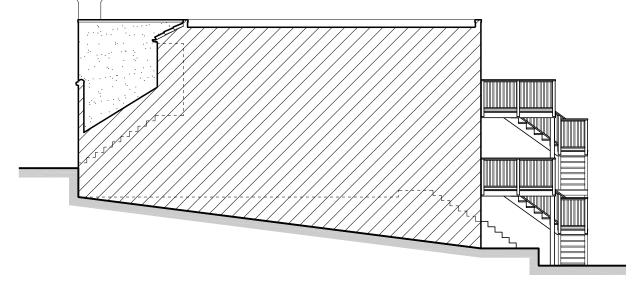

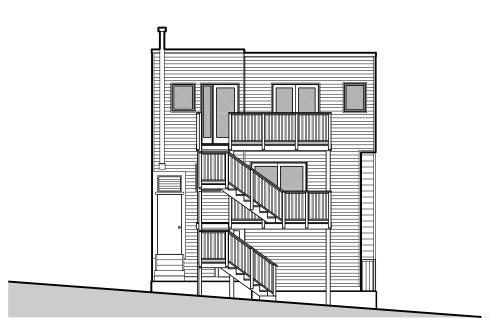

EXISTING

ONE (1)

1,376 SF

TWO (2)

20 ft. at sidewalk

44' - 9"

PROPOSED

ONE (1)

1, 376 SF

TWO (2)

20 FEET

PERMITTED

TWO (2)

3,300 SF

THREE (3)

40 FEET

44' - 0"

PROJECT DIRECTORY

Miriam Rotkin-Ellman and Hallie Chertok 85 Manchester Street San Francisco, CA 94110

H: 415.970.1093

T.B.D.

6573 Shattuck Avenue Oakland, CA 94609 O: 510 . 654 . 2552 F: 510 . 654 . 2555

T.B.D

Lorin Hill, Architect

Contractor: Structural Engineer:

ABREVIATIONS

A/C ALUM (AL) APPROX ARCH	ANGLE AT) ACOUSTICAL AIR CONDITIONING ALUMINUM APPROXIMATE ARCHITECTURAL	FOC FOG FOW FOS FS FT FTG FURR	FACE OF CONCRETE FACE OF GIRT FACE OF WALL FACE OF STUDS FULL SIZE FOOT OR FEET FOOTING FURRING	SCHED SECT SHT SIM SPEC SQ SS SSD	SCHEDULE SECTION SHEET SIMILAR SPECIFICATION SQUARE SERVICE SINK SEE STRUCTURA
BD, (BRD) BLDG BLK BLKG BM BOTT (BOT)	CENTER LINE	GALV GL GI GSM GYP BD	GALVANIZED GLASS GALVANIZED IRON GALVANIZED SHEET METAL GYPSUM WALLBOARD	SST STD STL STOR STRUCT SUSP	DWGS. STAINLESS STEE STANDARD STEEL STORAGE STRUCTURAL SUSPENDED
CEM C.T. CLG CLKG CLO CLR COL	CEMENT CERAMIC TILE CEILING CAULKING CLOSET CLEAR COLUMN	HCP HM HDWD JAN JT	HANDICAP HOLLOW METAL HARDWOOD JANITOR JOINT	T.B.D. T & B T & G TEL THK TOC	TO BE DETERMING TOP AND BOTTO TONGUE AND GREEPHONE THICK
CONC CONN CONSTR CONT	CONCRETE CONNECTION CONSTRUCTION CONTINUOUS	KD KP	KNOCKDOWN KICKPLATE	TOS TYP TR	TOP OF STEEL TYPICAL TREAD
CORR CTSK CJ	CORRIDOR COUNTERSUNK CONTROL JOINT	LAM LAV LIQ	LAMINATE LAVATORY LIQUID	UON	UNLESS OTHERW
DBL DET DIA DIAG	DOUBLE DETAIL DIAMETER DIAGONAL	MACH MAINT MATL MAX MECH	MACHINE MAINTENANCE MATERIAL MAXIMUM MECHANICAL	VERT W.P.	VERTICAL WATERPROOF

MEMBRANE

METAL

MFR (MFGMANUFACTURER

NO OR # NUMBER

MINIMUM

MOUNTED

MISCELLANEOUS

MASONRY OPENING

NOT IN CONTRACT

NOT TO SCALE

ON CENTER

OFFICE

OPENING

OPPOSITE

PRECAST

PRECAST

RADIUS

REFERENCE

REINFORCED

RECESSED

REQUIRED

ROUGH OPENING

RAIN WATER LEADER

ROOM

MEMB

MET

MIN

NTS

OFF

OPNG

(P.C.)

RAD

REQ'D

RM

PL, P PLATE

PLYWD PLYWOOD

PTN PARTITION

OPP

GENERAL NOTES

- 1. ALL WORK SHALL COMPLY WITH THE REQUIREMENTS OF:
- 2010 SAN FRANCISCO CODE AMENDMENTS - 2010 CALIFORNIA BUILDING CODE
- 2010 CALIFORNIA ENERGY CODE 2010 CALIFORNIA PLUMBING CODE - 2010 CALIFORNIA MECHANICAL CODE
- REGARDLESS OF WHAT IS SHOWN OR NOT ON THESE DRAWINGS. ALL WORK SHALL COMPLY WITH THE FOLLOWING CALIFORNIA ADMINISTRATIVE CODES:
- TITLE 24 BUILDING STANDARDS
- CAL/OSHA CONSTRUCTION SAFETY ORDERS
- 2. THE CONTRACTOR SHALL COMPLY WITH ANY OTHER APPLICABLE STATE OR LOCAL ORDINANCES.
- IN THE EVENT OF ANY CONFLICT THE MORE STRINGENT PROVISIONS SHALL APPLY.
- 3. ANY DISCREPANCIES BETWEEN THE CONSTRUCTION DOCUMENTS AND ACTUAL SITE CONDITIONS SHALL BE BROUGHT TO THE ATTENTION OF THE ARCHITECT IN WRITING FOR CLARIFICATION PRIOR TO PROCEEDING WITH THE WORK. DO NOT PROCEED ON ASSUMPTIONS.
- 4. THESE DRAWINGS MAY NOT BE TO SCALE AND ARE FOR ILLUSTRATION PURPOSES ONLY. THE CONTRACTOR SHALL VERIFY ALL DIMENSIONS AND EXISTING CONDITIONS IN THE FIELD. EACH SUBCONTRACTOR SHALL MAKE MEASUREMENTS PERTAINING TO HIS/HER RESPECTIVE WORK AND SHALL BE RESPONSIBLE FOR THE ACCURACY.
- 5. DETAILS TAKE PRECEDENCE OVER SMALLER SCALE DRAWINGS. WRITTEN DIMENSIONS TAKE PRECEDENCE OVER GRAPHIC SCALE SHOWN ON THE DRAWINGS. DO NOT SCALE THE DRAWINGS. ALL DIMENSIONS ARE TO FACE OF FINISH UNLESS OTHERWISE NOTED.
- 6. THE CONTRACTOR SHALL VERIFY THE ROUGH-IN DIMENSIONS FOR DOORS, WINDOWS, FIXTURES AND EQUIPMENT FROM THE MFR'S. INSTALLATION DATA PRIOR TO STARTING LAYOUT IN AREAS WHERE SUCH ITEMS OCCUR. ALL MANUFACTURED ITEMS SHALL BE INSTALLED PER MANUFACTURER'S RECOMMENDATIONS. CONTRACTOR SHALL NOTIFY THE ARCHITECT OF ANY CONFLICTS BETWEEN DRAWINGS AND MANUFACTURER'S RECOMMENDATIONS PRIOR TO
- 7. ALL BUILDING SYSTEMS AND ASSEMBLIES SHALL BE COMPLETE AND OPERATIVE THOUGH NOT FULLY DESCRIBED IN THESE DOCUMENTS. ALL CONSTRUCTION SHALL BE WATERTIGHT.
- 8. THE CONTRACTOR SHALL BE RESPONSIBLE FOR COORDINATING THE VARIOUS BUILDING TRADES AND FOR COORDINATING BETWEEN THE VARIOUS CONSTRUCTION DOCUMENTS AS NECESSARY IN SETTING OUT ALL BUILDING LINES AND DETAILS.
- SUBTRADE PERMITS AND BE RESPONSIBLE FOR SCHEDULING INSPECTIONS.
- 10. THE CONTRACTOR SHALL REMOVE FROM THE SITE ALL TRASH, WASTE, RUBBISH AND DEBRIS RESULTING FROM THE WORK AT REGULAR INTERVALS DURING THE COURSE OF THE WORK. ALL SUCH WASTE SHALL BE LEGALLY DISPOSED OF OFF-SITE. PATCH DAMAGED FINISHES AS
- 11. SECURITY OF THE WORK SITE SHALL BE THE RESPONSIBILITY OF THE CONTRACTOR DURING THE WORK DAY. THE WORK SITE SHALL BE SECURED AGAINST ENTRY DURING NON-WORK HOURS.
- 12. THE CONTRACTOR SHALL PROVIDE ALL TEMPORARY FACILITIES AS REQUIRED TO PROPERLY AND SAFELY EXECUTE THE WORK. SUCH FACILITIES SHALL INCLUDE BUT ARE NOT NECESSARILY LIMITED TO, SHORING, BRACING, SCAFFOLDING, BARRIERS AND TEMPORARY UTILITIES. THE CONTRACTOR SHALL MAINTAIN ONE EXISTING TOILET OPERABLE THROUGHOUT THE COURSE OF
- 13. ALL WORK SHALL BE INSTALLED PLUMB, LEVEL, AND TRUE.
- 14. UNLESS OTHERWISE NOTED ALL CONNECTIONS AND FASTENERS SHALL BE CONCEALED. THE USE OF EXPOSED FASTENERS SHALL BE APPROVED BY THE DESIGNER. ALL EXTERIOR FASTENERS SHALL BE STAINLESS STEEL OR HOT DIP GALVANIZED.
- 15. ANY OPENINGS LEFT IN FLOORS OR CEILINGS SHALL BE PROTECTED FOR THE SAFETY OF THOSE WORKING ON SITE AND OTHERS.
- 16. ALL DIMENSIONS ARE TO FACE OF FINISH UNLESS OTHERWISE NOTED.
- 17. ANY WORK INTERFACING WITH CITY PROPERTY OR CITY SERVICES SHALL BE PERFORMED PER CITY STANDARDS.
- 18. SUBMIT SHOP DRAWINGS AND MANUFACTURER'S DATA FOR APPROVAL BY ARCHITECT FOR: CASEWORK, COUNTERS, APPLIANCES, LIGHTING FIXTURES, PLUMBING FIXTURES.

PROJECT DATA

PROJECT DESCRIPTION:

AN EXISTING TWO STORY SINGLE FAMILY DWELLING GETS A REAR YARD DECK AND

PROJECT ADDRESS:	85 MANCHESTER STREET SAN FRANCISCO, CA 94110		
ASSESSOR'S PARCEL NUMBER	BLOCK 5523 LOT 029		
ZONING	RH-2		
HEIGHT & BULK DISTRICT	40-X		
RONT SETBACK	N/A		

45% OF LOT DEPTH OR AVERAGE REAR YARD SETBACK BETWEEN ADJACENT BUILDINGS OCCUPANCY GROUP

DWELLING TYPE OF CONSTRUCTION

TWO (2), EXISTING (NO CHANGE) 2,000 SF, EXISTING (NO CHANGE)

BUILDING HEIGHT **BUILDING DEPTH**

NUMBER OF

FOOTAGE

DWELLING UNITS

BUILDING SQUARE


NUMBER OF STORIES


DRAWING LIST

ARCHITECTURAL

- COVER SHEET, PROJECT DATA & MAPS
- EXISTING AND PROPOSED SITE PLANS
- EXISTING AND PROPOSED FIRST FLOOR PLANS
- EXISTING AND PROPOSED SECOND FLOOR PLANS
- BUILDING ELEVATIONS
- BUILDING ELEVATIONS

PARCEL MAP

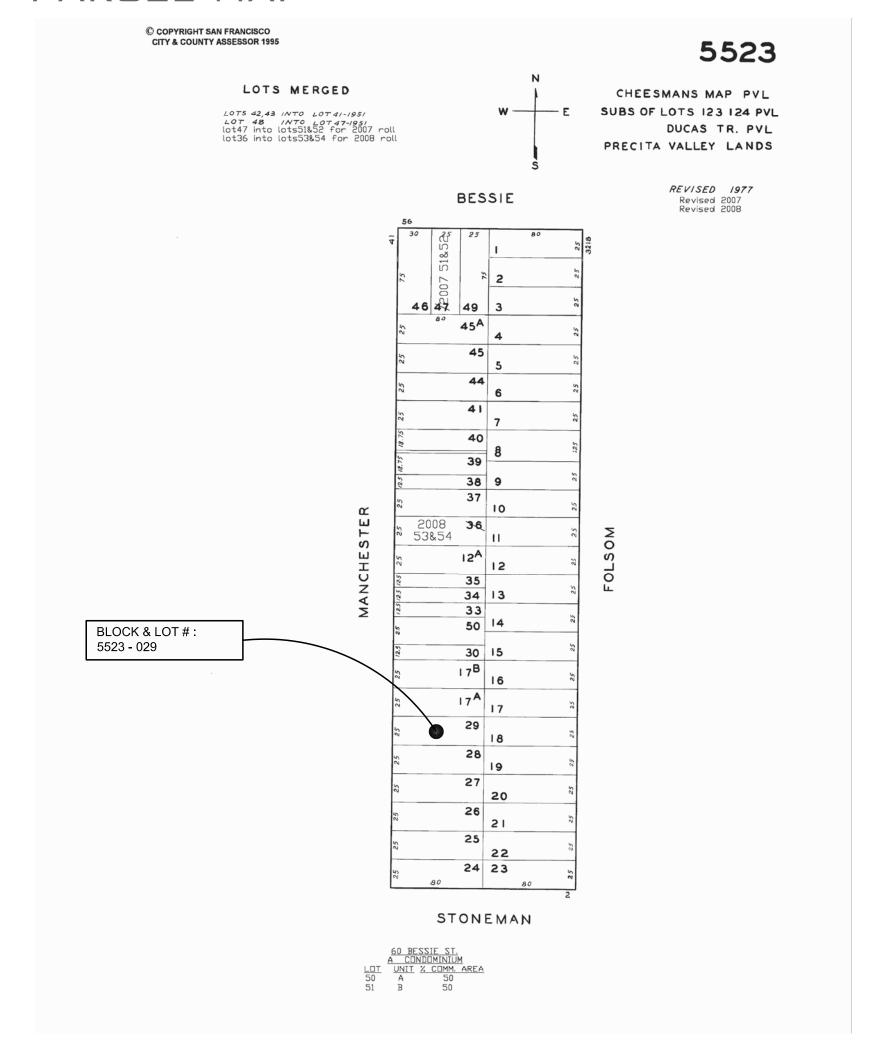

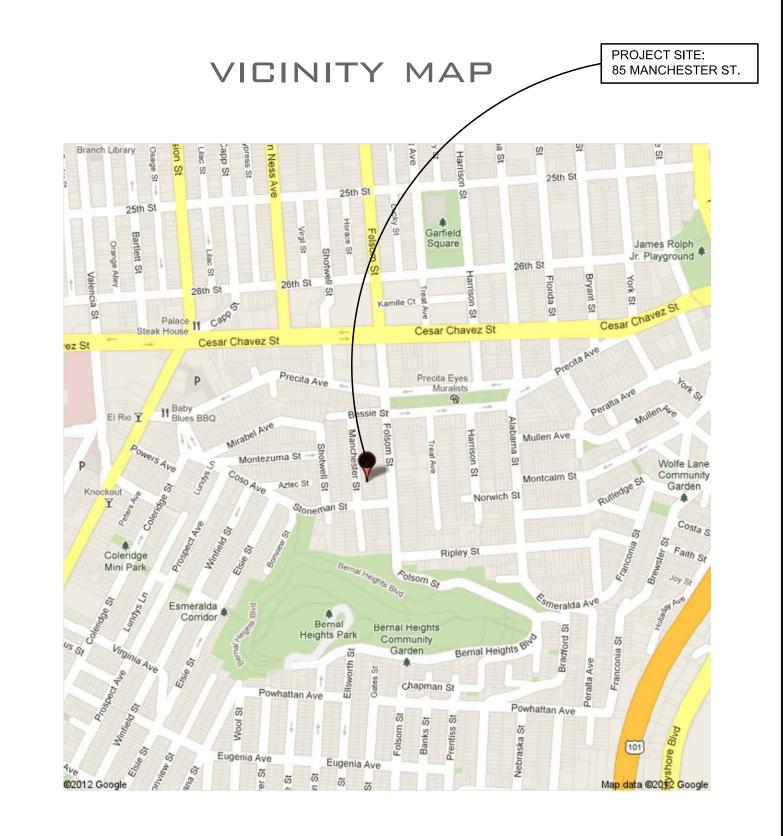

SYMBOLS

DIMENSION

DISPENSER

DOWNSPOL

DRAWING

ELEVATION

ELECTRICAL

EQUIPMENT

EXPANSION

EXTERIOR EACH WAY

COOLER

HEATER

EQUIPMENT

FLOOR DRAIN

FOUNDATION

FIXED GLASS

CABINET

FINISH

FLOOR

FLASHING

FIRE EXTINGUISHER

ELECTRIC WATER

ELECTRIC WATER

EXISTING

EQUAL

ENCLOSURE

DOOR OPENING

DOWN

DOOR

EACH

EJ (EXP JT)EXPANSION JOINT

ELEC


ENCL

EQPT

EXIST


EQUIP

FLASH

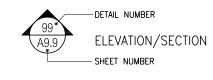


SEE WINDOW SCHEDULE

SEE DOOR SCHEDULE

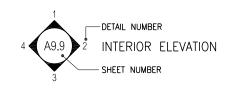

WALL CONSTRUCTION SEE WALL TYPES

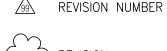



REFERENCE GRID

ALIGN FINISH FACES



ELEVATION/CONTROL POINT

HILL 짓 C-23266

Print Date: 05 . 14 . 2012 SECTION 311 -**NEIGHBORHOOD**

NOTIFICATION 06 . 14 . 2012 APPLICATION FOR VARIANCE


06 . 20 . 2012 Site Permit -Section 311


drawing title: Cover Sheet


Project Data


ASQ

06 . 20 . 2012 scale: as noted

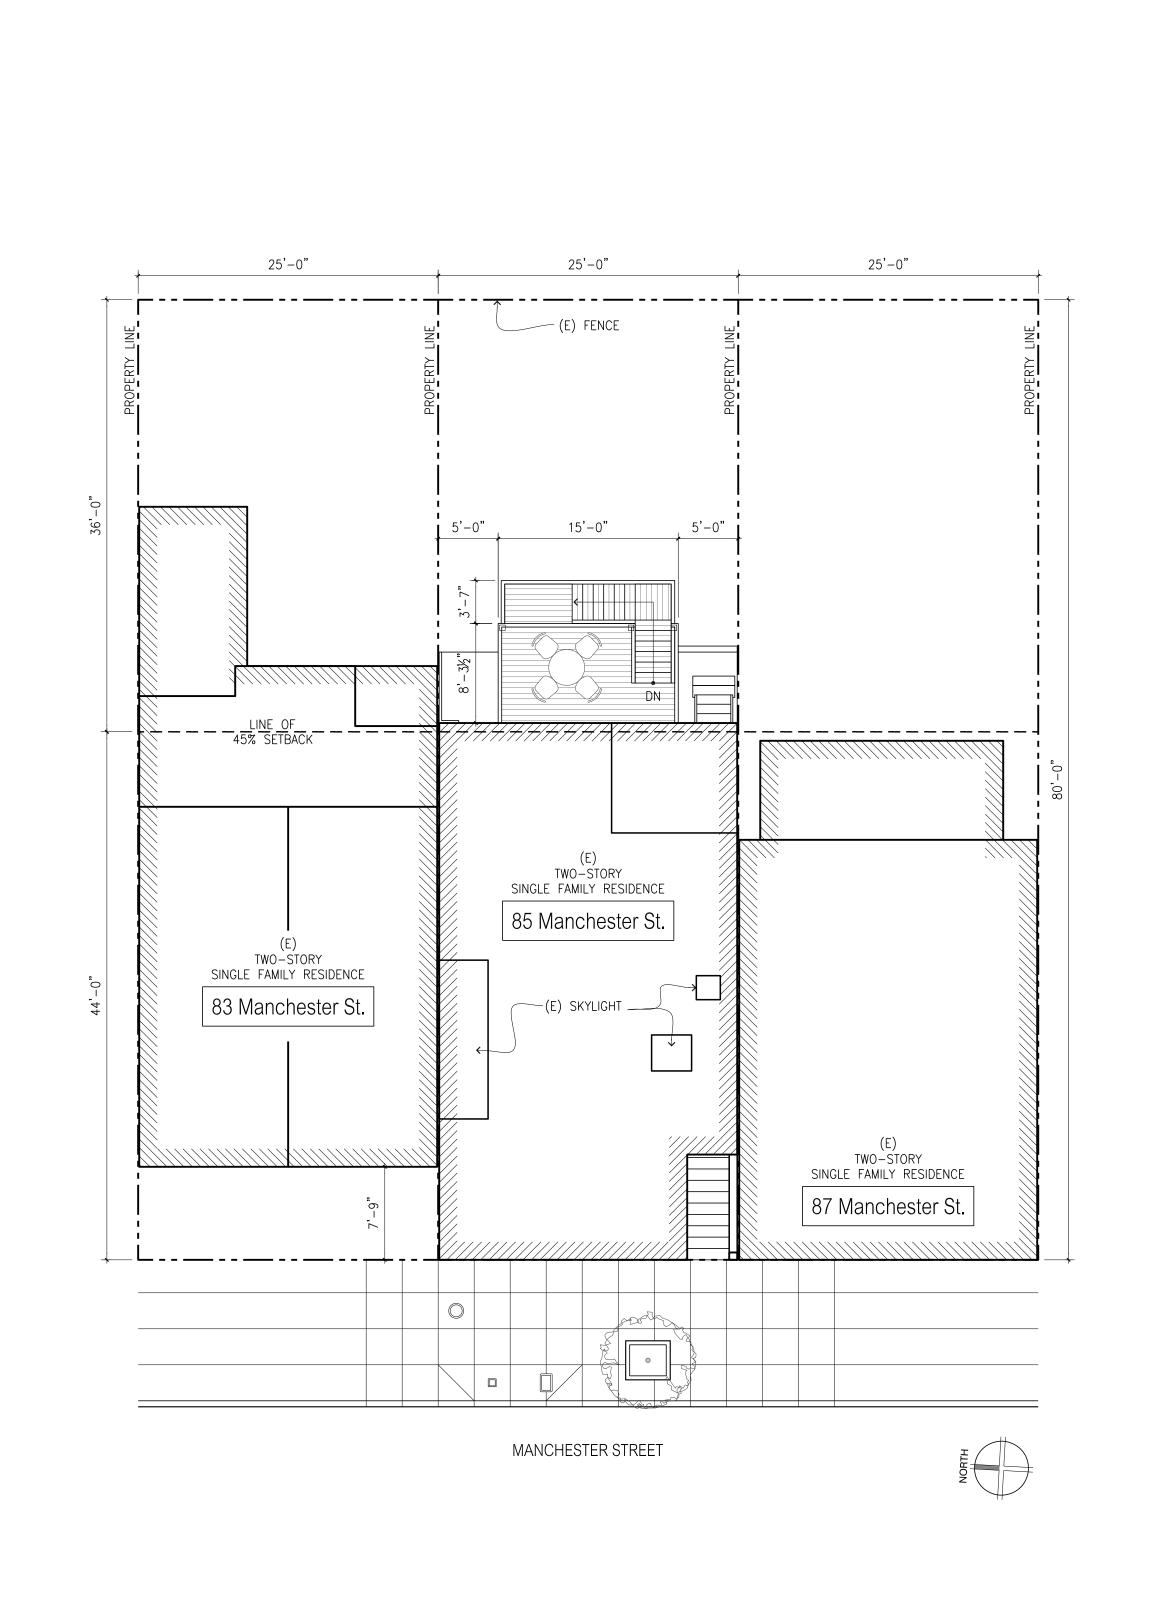

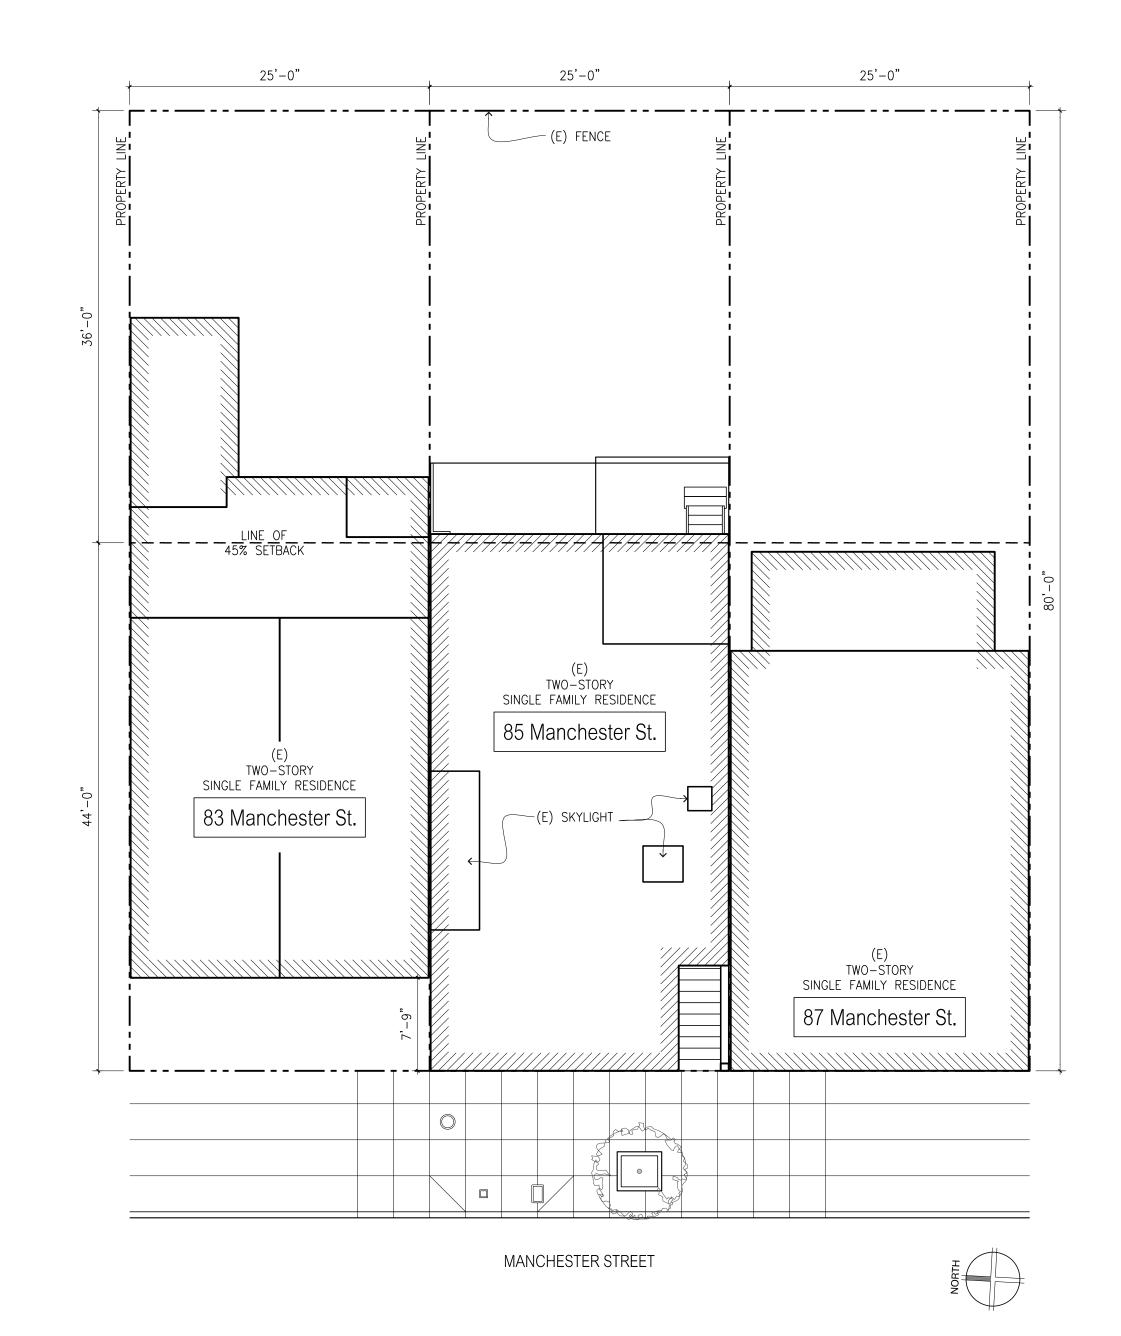

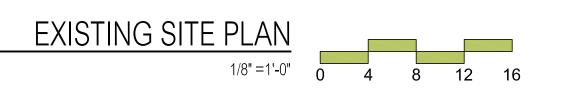

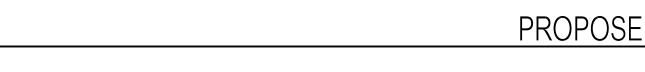



project no.: 1117

Print Date: 05 . 14 . 2012 SECTION 311 -NEIGHBORHOOD NOTIFICATION

06 . 14 . 2012 APPLICATION FOR VARIANCE

drawing title: **Existing And** Proposed Site Plans

ASQ

scale:

05 . 14 . 2012

As Noted



III@hillarch.com il. 510.654.2552 ix. 510.654.2555

N-ELLMAN-CHERT
YARD DECK ADDITIO

Date:

05 . 14 . 2012
SECTION 311 NEIGHBORHOOD
NOTIFICATION

06 . 14 . 2012
APPLICATION FOR
VARIANCE

Building
Elevations


by:

ASQ
date:

05 . 14 . 2012
scale:

1/4"=1'-0"

A4.1 project no.: 1117

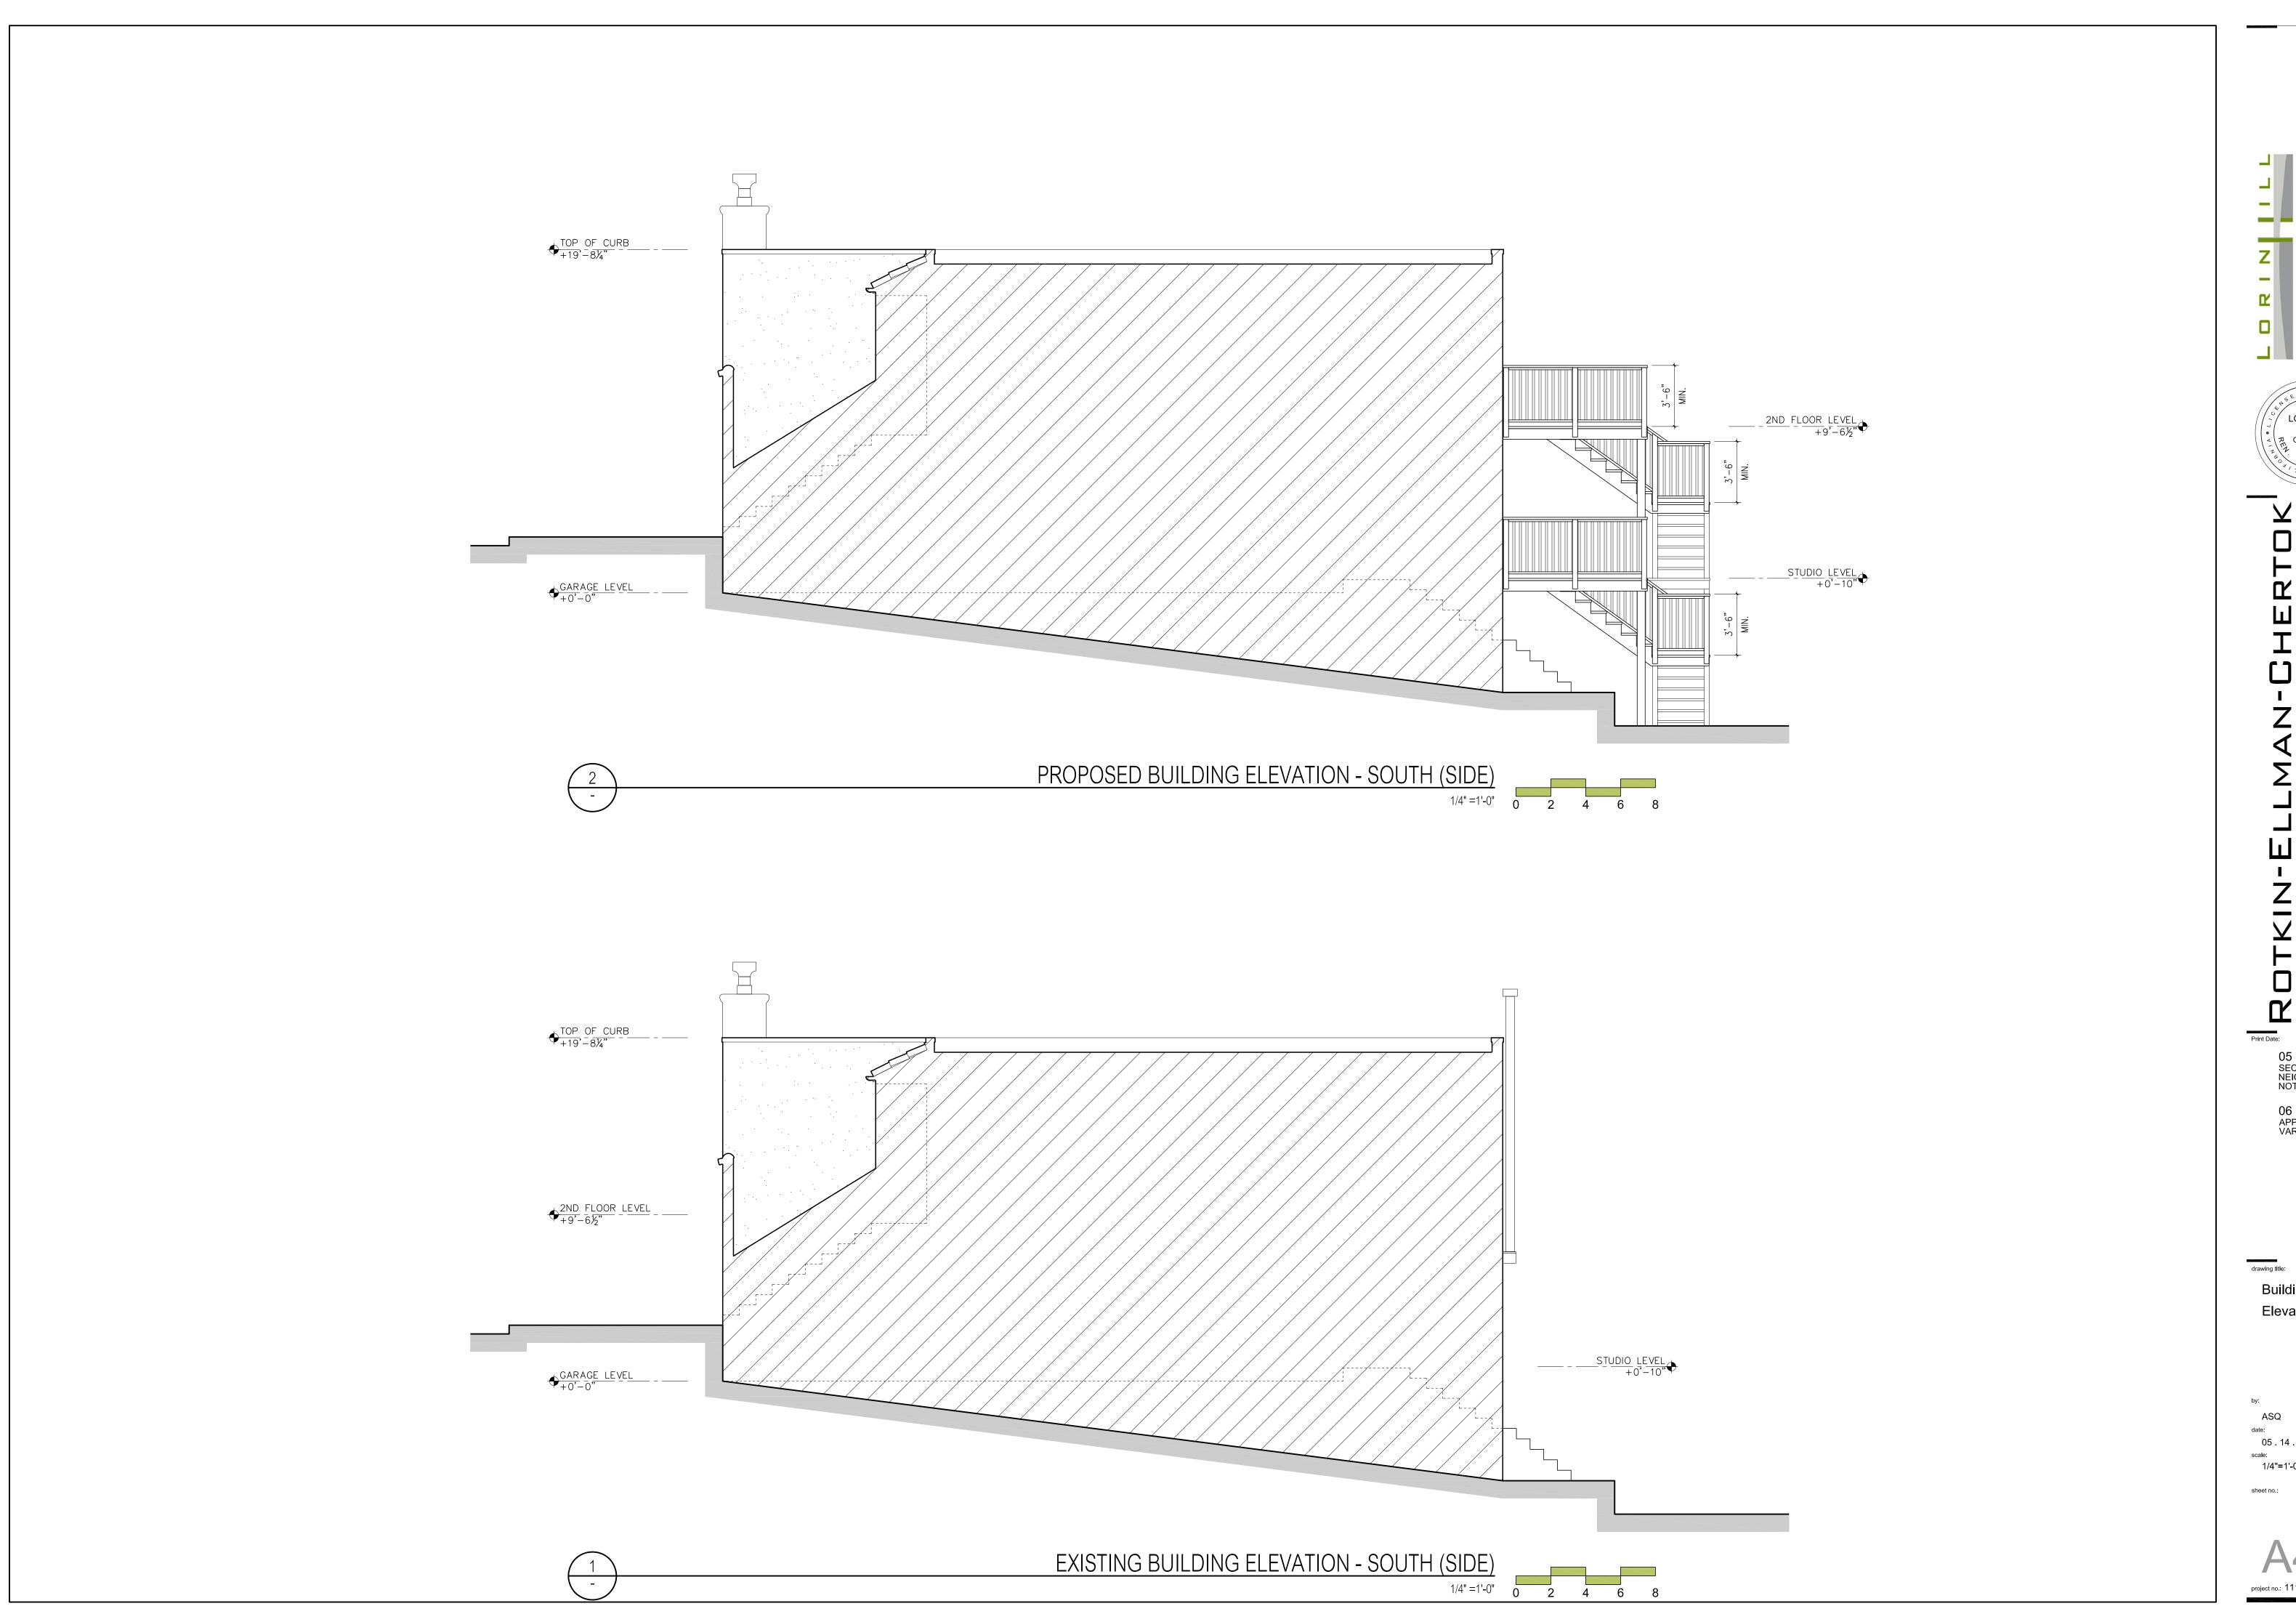

05.14.2012 SECTION 311 -NEIGHBORHOOD NOTIFICATION 06 . 14 . 2012 APPLICATION FOR VARIANCE

Building Elevations

05 . 14 . 2012 1/4"=1'-0"