### MEMO

## **Disclaimer for Review of Plans**

The San Francisco Planning Code requires that the plans of certain proposed projects be provided to members of the public prior to the City's approval action on the project. Accordingly, any images of plans featured on this website are provided for the primary purpose of facilitating public input prior to the City's action. The City and County of San Francisco does not own the copyright to these images. Please be aware that the unauthorized reproduction, distribution, or alteration of these images may result in a violation of Federal Copyright Law (17 U.S.C.A. Sections 101 et seq.) and that any party who seeks to reproduce or alter these images does so at his or her own risk.

Additionally, plans provided on this website are limited to site plans, elevations and/or section details (floor plans and structural details may not be included). These are DRAFT PLANS being provided for public review PRIOR to the City's approval action on the project. Final plans may differ from those that are currently available for review.

1650 Mission St. Suite 400 San Francisco, CA 94103-2479

Reception: 415.558.6378

Fax: 415.558.6409

Planning Information: 415.558.6377 NOTICE OF PUBLIC HEARING

Hearing Date: Wednesday, January 23, 2013

Time: 9:30 AM

Location: City Hall, 1 Dr. Carlton B. Goodlett Place, Room 408

Case Type: Variance(Rear Yard and Noncomplying Structure)

Hearing Body: Zoning Administrator

PORPERTY INFORMATION		APPLICATION INFORMATION	
Project Address:	380A Capp St	Case No.:	2012.0369V
Cross Street(s):	18th And 19th Streets	Building Permit:	2012.10.12.1914
Block / Lot No.:	3590/050	Applicant/Agent:	Joram Altman
Zoning District(s):	RTO-Mission / 40-X	Telephone:	415-282-2626
Area Plan:	Mission	E-Mail:	joram@jsaarchitect.com

### PROJECT DESCRIPTION

The proposal includes relocation and rehabilitation of a one-story cottage located within the required rear yard behind a four-story, two-family dwelling. The proposal will move the one-story cottage approximately 7 feet 8 inches towards the rear lot line.

**PER SECTION 134 OF THE PLANNING CODE**, the subject property is required to maintain a rear yard of 47 feet based upon the average of the two adjacent properties. Currently, the existing one-story cottage is located entirely within the required rear yard and is approximately 18 feet from the rear building wall of the four-story dwelling. The new proposal would rehabilitate and move the one-story cottage towards the rear lot line, increasing the distance between the two buildings on the lot to 30 feet 9 inches. The proposed location of the cottage remains in the required rear yard; therefore, a rear yard variance is required.

**PER SECTION 188 OF THE PLANNING CODE**, noncomplying structures are not permitted to be altered, except in conformity with the Planning Code. The existing building is considered a legal noncomplying structure because it is located within the required rear yard. The proposal would relocate a noncomplying structure within the required rear yard; therefore, a variance is required.

### ADDITIONAL INFORMATION

FOR MORE INFORMATION, PLEASE CONTACT PLANNING DEPARTMENT STAFF:

Planner: Richard Sucre Telephone: 415-575-9108 Mail: Richard.Sucre@sfgov.org

**ARCHITECTURAL PLANS:** The site plan and elevations of the proposed project are available on the Planning Department's website at: <a href="http://sf-planning.org/ftp/files/notice/2012.0369V.pdf">http://sf-planning.org/ftp/files/notice/2012.0369V.pdf</a>

中文詢問請電:558.6378

Para información en Español llamar al: 558.6378

## **GENERAL INFORMATION ABOUT PROCEDURES**

#### VARIANCE HEARING INFORMATION

Under Planning Code Section 306.3, you, as a property owner or resident within 300 feet of this proposed project or interested party on record with the Planning Department, are being notified of this Variance Hearing. You are not obligated to take any action. For more information regarding the proposed work, or to express concerns about the project, please contact the Applicant/Agent or Planner listed on this notice as soon as possible. Additionally, you may wish to discuss the project with your neighbors and neighborhood association or improvement club, as they may already be aware of the project.

Persons who are unable to attend the public hearing may submit written comments regarding this application to the Zoning Administrator, Planning Department, 1650 Mission Street, Suite 400, San Francisco, CA 94103, by 5:00pm the day prior to the hearing. These comments will be made a part of the official public record, and will be brought to the attention of the person or persons conducting the public meeting or hearing

#### **BUILDING PERMIT APPLICATION INFORMATION**

Under Planning Code Section 311/312, the Building Permit Application for this proposal is also subject to a 30-day notification to occupants and owners within 150-feet of the subject property. On December 24, 2012, the Department issued the required Section 311 notification for this project (expires January 23, 2013).

#### **BOARD OF APPEALS**

An appeal of the approval (or denial) of a **variance application** by the Zoning Administrator may be made to the **Board of Appeals within 10 days** after the **Variance Decision Letter** is issued by the Zoning Administrator.

An appeal of the approval (or denial) of a **building permit application** by the Planning Department may be made to the **Board of Appeals within 15 days** after the **building permit** is issued (or denied) by the Director of the Department of Building Inspection.

Appeals must be submitted in person at the **Board's office at 1650 Mission Street, 3rd Floor, Room 304**. For further information about appeals to the Board of Appeals, including current fees, **contact the Board of Appeals** at **(415) 575-6880**.

#### **ABOUT THIS NOTICE**

The Planning Department is currently reviewing its processes and procedures for public notification as part of the Universal Planning Notification (UPN) Project. The format of this Public Hearing notice was developed through the UPN Project and is currently being utilized in a limited trial-run for notification of Variance Hearings.

If you have any comments or questions related to the UPN Project or the format of this notice, please visit our website at <a href="http://upn.sfplanning.org">http://upn.sfplanning.org</a> for more information.

中文詢問請電:558.6378

Para información en Español llamar al: 558.6378



48'-1" × .50 = 24'-1/2" SUM OF FRONT & REAR FACADE TO BE REMOVED: 18'-5 1/2" SUM OF ALL EXTERIOR WALLS IN LINEAL FEET: 122'. SUM OF ALL EXTERIOR WALLS TO BE REMOVED IN LINEAL FEET: 34' |8'-5||/2" < 24'-|/2" <u>AND</u> 34' < 79.3' (C) TOTAL AREA OF HORIZONTAL ENVELOPE ELEMENTS: 762sf  $762sf \times .50 = 38lsf$ 

DEMOLITION CALCULATIONS (PLANNING CODE SEC. 317)

(B) SUM OF FRONT & REAR FACADE IN LINEAL FEET: 48'-I"


TOTAL AREA OF HORIZONTAL ENVELOPE ELEMENTS TO BE REMOVED: 246sf < 38lsf

TOTAL AREA OF VERTICAL ENVELOPE ELEMENTS: 1,383sf  $\mid$ 383sf  $\times$  .50 = 691.5sf

TOTAL AREA OF VERTICAL ENVELOPE ELEMENTS TO BE REMOVED:

333sf < 691.5sf

SF AREA TABLE						
380A CAPP ST REAR BUILDING						
	EXISTING USES	EXISTING USES TO BE RETAINED	NET NEW CONSTRUCTION	PROJECT TOTALS		
CONDITIONED SPACE	762	762	0	762		
PORCH	56	0	0	0		
SUB-TOTALS GSF	818	762	0	762		

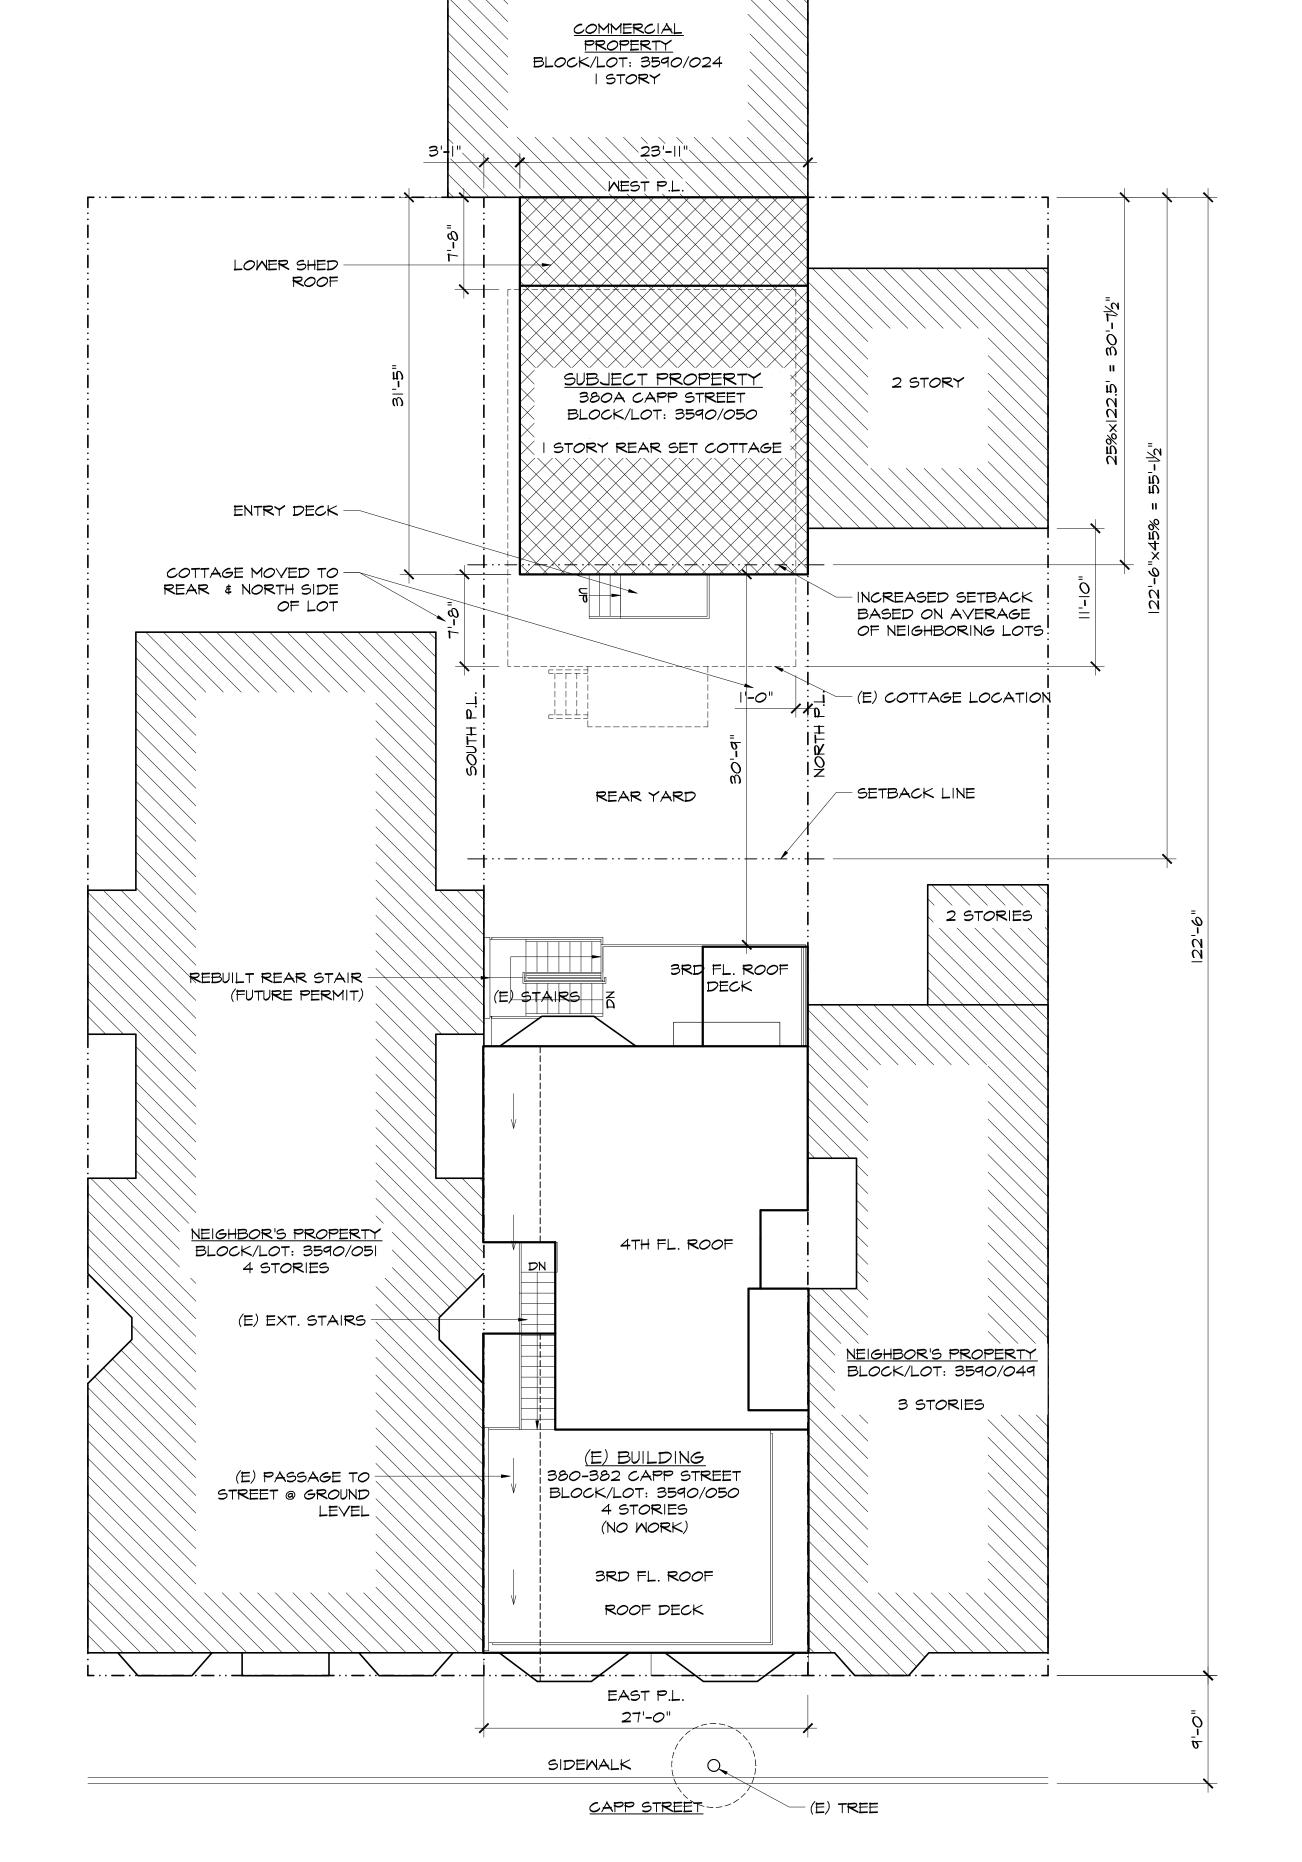

SUBJECT PROPERTY



# LOCATION MAP

# SHEET INDEX

# ARCHITECTURAL:

AO.I SITE PLAN & PROJECT DATA EXISTING / DEMO PLANS & EXISTING SECTIONS

A2.1 REMODELED PLANS \$ REMODELED SECTION A3.1 EXISTING ELEVATIONS

A6.I ENERGY ANALYSIS

A6.2 ENERGY ANALYSIS

A3.2 REMODELED ELEVATIONS A5.I ELECTRICAL/MECHANICAL PLAN, WINDOW/DOOR SCHEDULE, DETAILS

SI GENERAL NOTES & TYPICAL DETAILS

S2 FOUNDATION & FIRST FLOOR FRAMING PLAN \$ ROOF FRAMING PLAN S3 STRUCTURAL DETAILS

PROJECT SCOPE OF WORK

MOVE COTTAGE TO REAR NORTH-WEST CORNER OF LOT. UPGRADE STRUCTURE AND FOUNDATION. REMODEL KITCHEN, BATH, LIVING ROOM AND BEDROOM. UPGRADE ELECTRICAL, PLUMBING AND MECHANICAL. NEW WINDOWS ON EAST AND SOUTH ELEVATIONS. NEW SKYLIGHTS. NEW FRONT ENTRY STAIR AND DECK. NEW ROOF WITH DORMER OVER ENTRY.

# PROJECT INFORMATION

APPLICABLE CODES: 2010 CALIFORNIA CBC W/SAN FRANCISCO AMENDMENTS, CPC, CMC, CEC AND SFBC


OCCUPANCY GROUP: R-2

CONSTRUCTION TYPE: V-B

STORIES:


(E) | STORIES

SITE PLAN SCALE: 1/8" = 1'-0"

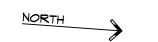

JORAM S. ALTMAN ARCHITECT 819 Alvarado Street San Francisco CA 94114 415. 282. 2626 tel

joram@jsaarchitect.com

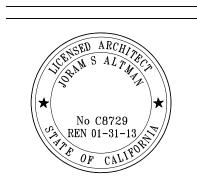

REMODE 380A AL

590/050

က

ISSUED FOR: 11/23/11 Schematic Design 11/30/11 Cottage Options 12/14/11 For northern neighbor 1/4/12 Pricing 1/18/12 Dormer Added 2/2/12 G.C. 2/8/12 Revised Dormer 3/6/12 For Energy Analysis 3/22/12 Historical Intake

3/28/12 Historical Intake 10/11/12 Permit 10/18/12 Variance

\11/19/12 NOPDR Response

SHEET TITLE

Site Plan & Project Details


JOB #: 21119 DATE: 11/23/11 DRAWN BY: GS

SCALE: AS NOTED



REMODEL

CA 380A Capp Street, San Francisco, APN: 3590/050 COTTAGE ENDORF ALT

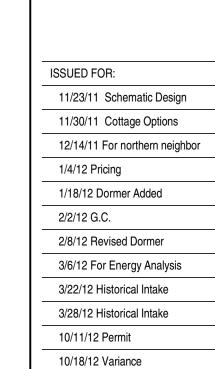

SHEET TITLE

Existing Elevations


11/19/12 NOPDR Response

JOB #: 21119 DATE: 11/23/11

DRAWN BY: GS SCALE: AS NOTED

— NORTH NEIGHBOR'S REAR SET 2 STORY COTTAGE RML -FENCE -TOP PLATE FINISH FLOOR - P.L. WALL OF WEST COMMERCIAL NEIGHBOR'S BLDG. — (E) GRADE


EXISTING SOUTH ELEVATION SCALE: 1/4" = 1'-0"

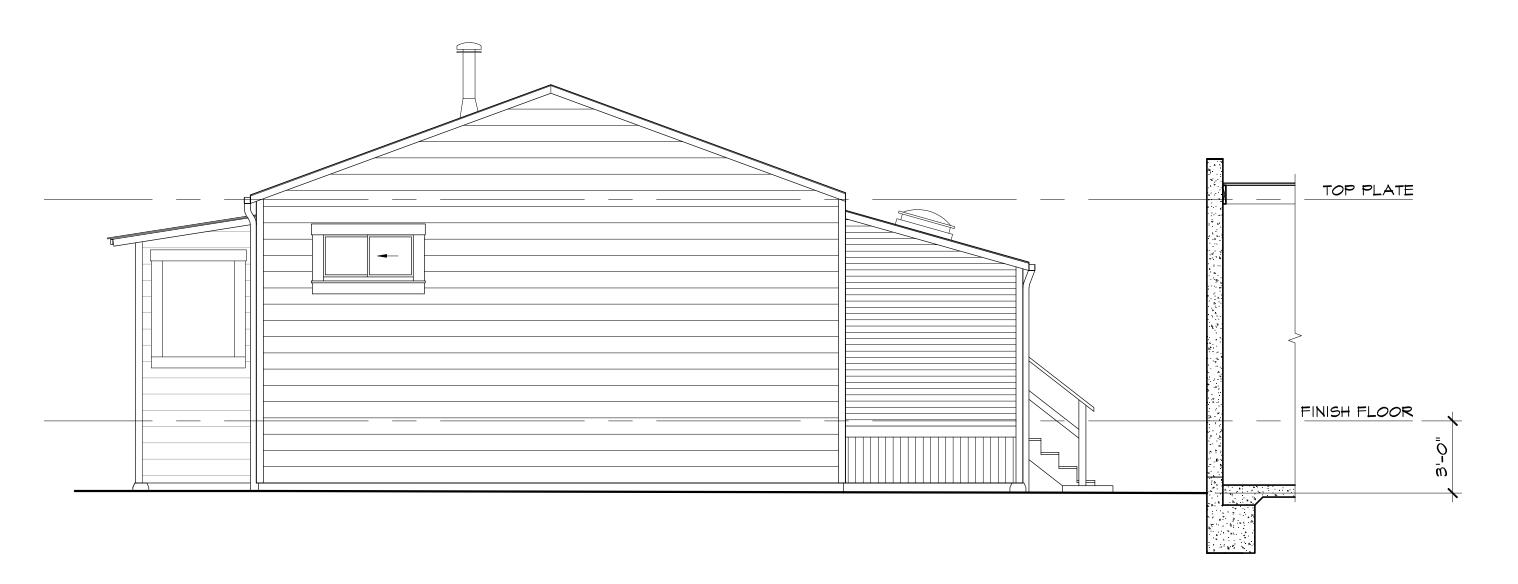

EXISTING NORTH ELEVATION SCALE: 1/4" = 1'-0"



EXISTING EAST ELEVATION SCALE: 1/4" = 1'-0"

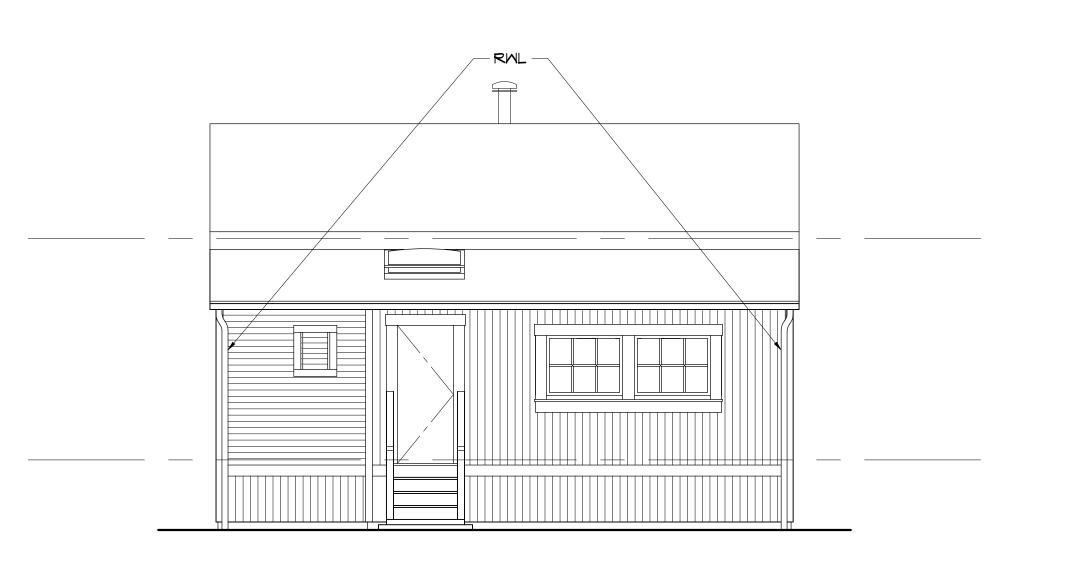

EXISTING WEST ELEVATION SCALE: 1/4" = 1'-0"

JORAM S. ALTMAN

AL

11/19/12 NOPDR Response

3/22/12 Historical Intake

SCALE: AS NOTED

32

NORTH NEIGHBOR'S REAR SET 2 STORY COTTAGE FLATTEN ROOF -TOP PLATE SIDE ELEVATION 15.4sf \_TOTAL AREA: 453sf\_ (N) SIDING TO MATCH (E)-FINISH FLOOR -(N) SCUPPER & RML - FOUNDATION VENTS (E) GRADE -36"MxI8"H ACCESS DOOR M/ FOUNDATION VENT P.L. WALL OF WEST COMMERCIAL — NEIGHBOR'S BLDG.


REMODELED SOUTH ELEVATION

SCALE: 1/4" = 1'-0"


UNPROTECTED WINDOW OPENINGS, CBC TABLE 705.8.d

TOTAL WINDOW AREA: 41.3sf TOTAL WALL AREA: 453sf 41.3 / 453 = 9.1%


9.1% < 25%

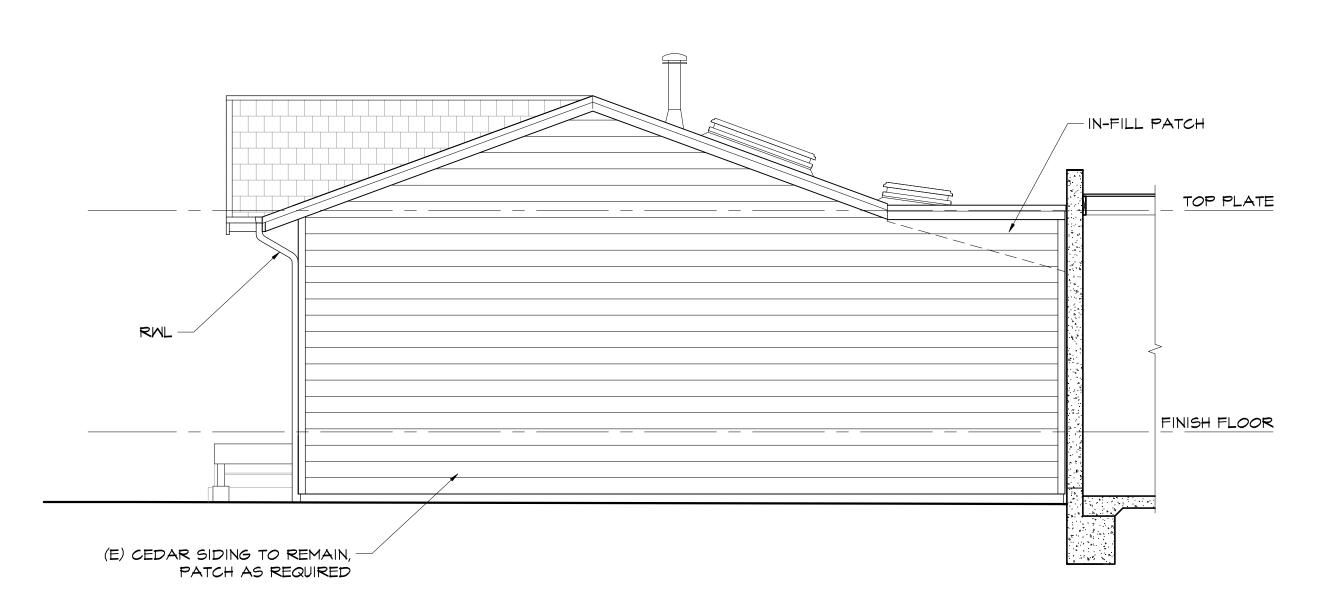

REMODELED NORTH ELEVATION (P.L. WALL)
SCALE: 1/4" = 1'-0"

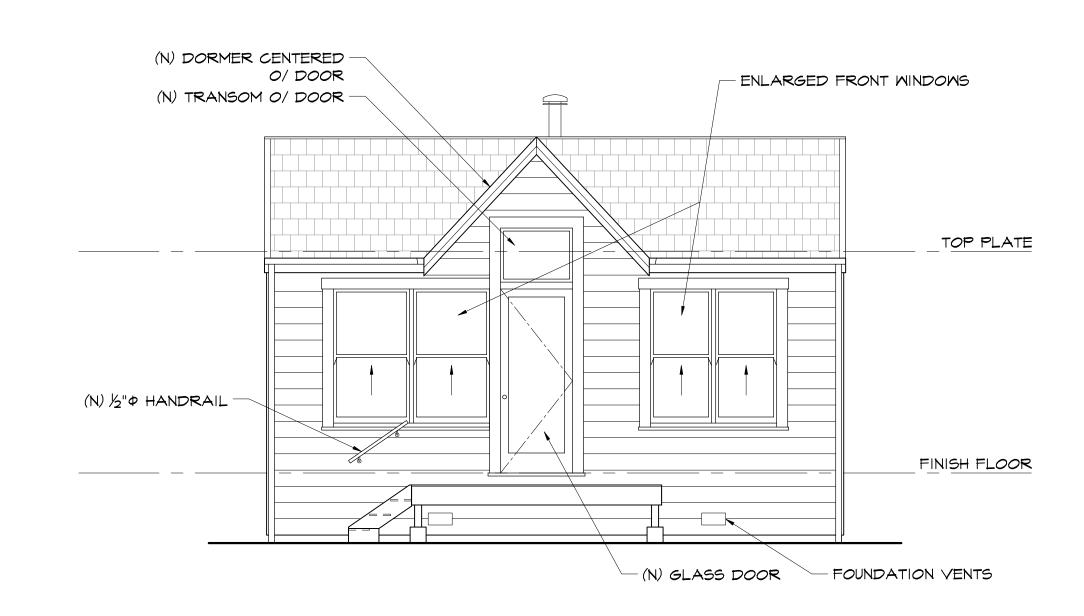

REMODELED EAST ELEVATION
SCALE: 1/4" = 1'-0"

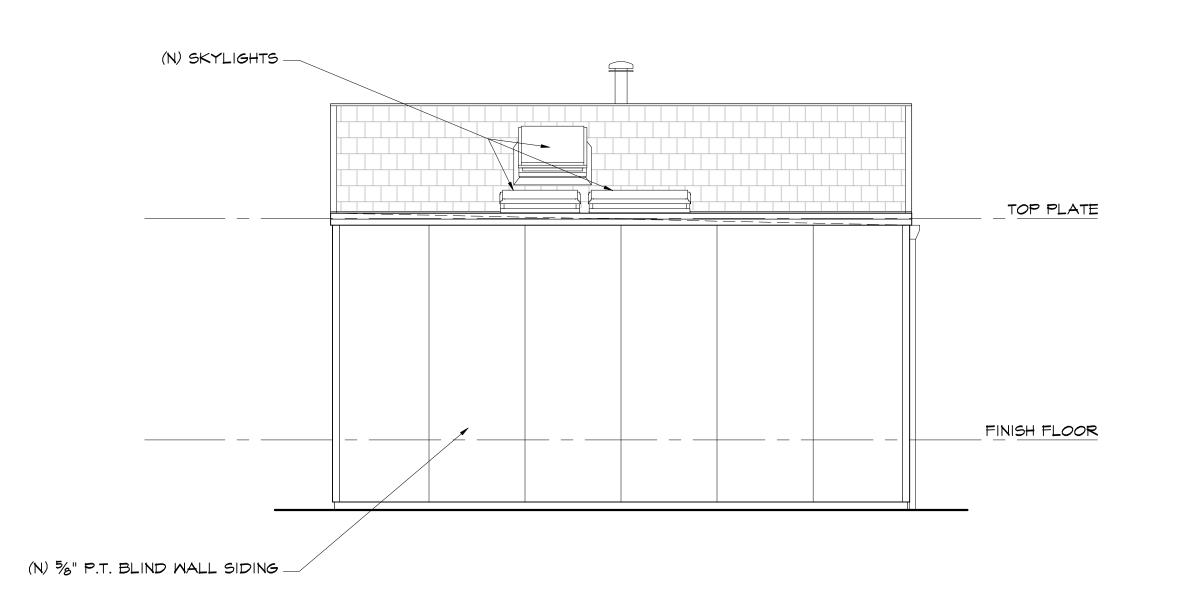

REMODELED WEST ELEVATION (P.L. WALL)
SCALE: 1/4" = 1'-0"