

DRAWING SYMBOLS

	CONFERENCE ROOM	ROOM NAME
	101	ROOM NUMBER
	3 E 1 C	ROOM IDENTIFICATION #1
		CEILING FINISH
		WALL FINISH
		BASE
		FLOOR FINISH
	CONFERENCE ROOM	ROOM NAME
	101	ROOM NUMBER
	A	WORK POINT
		CONTROL POINT OR DATUM POINT
	#/X#.#	SECTION DRAWING#/PLOT SHEET#
		DETAIL
		DETAIL IDENTIFICATION
		SHEET NUMBER
	D	INTERIOR ELEVATION(S)
	06A	ELEVATION IDENTIFICATION
	06A	ROOM NUMBER, DOOR LETTER (##X)
		WINDOW IDENTIFICATION
	26	EQUIPMENT IDENTIFICATION (SEE EQUIPMENT SCHEDULE)
	5	REVISION BUBBLE & IDENTIFICATION
	W1	FINISH SYMBOL
	1	NUMBERED KEYNOTE
		EXISTING PARTITION (TO BE REMOVED)
		EXISTING PARTITION (TO REMAIN)
		NEW PARTITION
		DASHED LINE INDICATES SOUND INSULATION OR RATED CONSTRUCTION, AS NOTED
		LIMIT OF WORK FOR THIS CONTRACT
		PROPERTY LINE
	20	NEW CONTOURS OR ELEVATION
	15	EXISTING CONTOURS OR ELEVATION
	30	NEW FINISH GRADE
		WORK OR COLUMN LINE
		ACOUSTIC TILE OR BOARD
		BRICK
		CARPET
		CONCRETE
		EARTH
		GLASS
		GYPSUM BOARD
		GRAVEL/ROCK FILL
		INSULATION
		METAL ALUMINUM
		METAL LATH
		MORTAR / PLASTER / SAND
		PLYWOOD
		STONE/MARBLE
		WOOD: FINISH
		WOOD: FRAMING THROUGH MEMBER W/ SIZE
		WOOD: INTERRUPTED, BLOCKING OR SHIM

ABBREVIATIONS

&	And	MACH	Machine
∠	Angle	ME	Machine Bolt
⊙	At	MAX	Maximum
⊘	Diameter/Round	MET	Metal
⊥	Perpendicular	MFR	Manufacturer
#	Pound or Number	MH	Manhole
AB	Anchor Bolt	MIN	Minimum
AC	Asphaltic Concrete	MIR	Mirror
ACOUS	Acoustical	MISC	Miscellaneous
AD	Area Drain	MLDG	Molding
ADJ	Adjustable/Adjacent	MO	Masonry Opening
AFF	Above Finished Floor	MTD	Mounted Mullion
AGGR	Aggregate	N	North
AL	Aluminum	(N)	New
APPROX	Approximate	NIC	Not In Contract
ARCH	Architect(ural)	NO/#	Number
ASPH	Asphalt	NOM	Nominal
BD	Board	NTS	Not to Scale
BITUM	Bituminous	OA	Overall
BLDG	Building	OBS	Obscure
BLK	Block	OC	On Center
BLKG	Blocking	OD	Outside Diameter
BM	Beam/Bench Mark	OFCl	Owner Furnished
BOT	Bottom	OP	Contractor Installed
BS	Both Sides	OFF	Office
BW	Both Ways	OPNG	Opening
		OPP	Opposite
		ORD	Overflow Roof Drain
		OZ	Ounce
CAB	Cabinet	PBD	Particle Board
CB	Catch Basin	P.C.	P.C. Chord
CEM	Cement	PERF	Perforated
CER	Ceramic	PRCST	Precast
CJ	Cast Iron	PL	Plate
CLG	Ceiling	PLAM	Plastic Laminated
CLK	Caulk	PLAS	Plaster
CLO	Closet/Close	PLYWD	Plywood
CLR	Clear	POL	Polished
CMU	Concrete Masonry Unit	PR	Pair
CO	Cased/Concrete Opening	PT	Point
COL	Column	PTD	Painted
CONC	Concrete	PTN	Partition
CONN	Connection	QT	Quarry Tile
CONSTR	Construction	R	Riser
CONT	Continuous	RAD	Radius
CORR	Corridor	RBR	Rubber
CTSK	Countersunk	RD	Roof Drain
CNTR	Counter	RE	Refer to
CRT	Cathod Ray Tube	REF	Reference
CER	Ceramic	REFR	Refrigerator
CT	Ceramic Tile	RGTR	Register
CTR	Center	REIN	Reinforced
		REQD	Required
DBL	Double	RESIL	Resilient
DEPT	Department	REV	Revision
DF	Drinking Fountain	RH	Round Head
DOUG FIR	Douglas Fir	RM	Room
DET	Detail	RO	Rough Opening
DI	Diameter	RWD	Redwood
DIM	Dimension	RWL	Rain Water Leader
DISP	Dispenser	S	South
DN	Down	SC	Solid Core
DO	Door Opening	SCHED	Schedule
DR	Door	SEC	Secretary
DWR	Drawer	SECT	Section
DS	Downspout	SAD	See Arch Drawings
DSP	Dry Standpipe	SSD	See Struct Drawings
DWG	Drawing	SH	Shelf
E	East	SHR	Shower
EA	Each	SHT	Sheet
ES	Each Side	SIG	Signal
EJ	Expansion Joint	SIM	Similar
EL	Elevation	SHTHG	Sheathing
ELEV	Elevator	SPEC	Specification
EMER	Emergency	SQ	Square
ENCL	Enclosure	SST	Stainless Steel
EP	Electrical Panelboard	SSK	Service Sink
EQU	Equal	STA	Station
EQUIP	Equipment	STD	Standard
EW	Electric Water Cooler	STL	Steel
EXH	Exhaust	STOR	Storage
EXIST/(E)	Existing	STRUC	Structural
EXP	Expansion	SUSP	Suspended
EXPO	Exposed	SYMM	Symmetrical
EXT	Exterior		
FA	Fire Alarm	T	Tread
FB	Flat Bar	TOC	Top Of Curb
FD	Floor Drain	TEL	Telephone
FDN	Foundation	TER	Terrazzo
FE	Fire Extinguisher	TEXT	Texture(d)
FEC	Fire Extinguisher Cabinet	T&G	Tongue And Grooved
FH	Flat Head	T&B	Top And Bottom
FHC	Fire Hose Cabinet	THERMO	Thermos
FIN	Finish	THK	Thick
FLUR	Floor	TOP	Top Of Pavement
FOC	Face Of Concrete	TOS	Top Of Slab
FOF	Face Of Finish	TV	Television
FOM	Face Of Masonry	TOW	Top Of Wall
FOS	Face Of Studs	TYP	Typical
FS	Full Size	UNF	Unfinished
FT	Foot/Feet	UON	Unless Otherwise Noted
FTG	Footing	UR	Urinal
FURR	Furring		
FUT	Future		
GA	Gauge	VCT	Vinyl Composition Tile
GALV	Galvanized	VB	Vapor Barrier
GSM	Galvanized Sheet Metal	VERT	Vertical
GB	Grab Bar	VEST	Vestibule
GC	General Contractor	W	West
GL	Glass	W/	With
GLB	Glu-Lam Beam	W/O	Without
GR	Grade	WD	Wood
GYP	Gypsum	WH	Water Heater
		WP	Water Proof
HB	Hose Bib	WRB	Water Resistant Barrier
HC	Hollow Core	WSC	Wainscot
HDWD	Hardwood	WT	Weight
HDWE	Hardware	WWF	Welded Wire Fabric
HM	Hollow Metal		
HORIZ	Horizontal	YD	Yard
HP	High Point		
HR	Hour/Hose Rack		
HT/HGT	Height		
ID	Inside Diameter		
INSUL	Insulation		
INT	Interior		
JAN	Janitor		
JT	Joint		
KIT	Kitchen		
LAB	Laboratory		
LAM	Laminate		
LG	Long		
LP	Low Point		
LSK	Laundry Sink		
LT	Light		
LVR	Louver		

ELECTRICAL & MECHANICAL SYMBOLS

	Duplex Convenience Outlet: Mount 15" A.F.F. U.O.N.
	Duplex Convenience Outlet w/Single Outlet Switched
	Duplex Convenience Outlet w/Ground Fault Interrupter
	Duplex Convenience Outlet: Weather Proof w/ Ground Fault Interrupter
	Duplex Convenience Outlet: Floor Mounted
	Fourplex Outlet
	Duplex Outlet, 220 Volt
	Dedicated Circuit
	Wire Mold Raceway
	Floor Mounted Elec. "Monument" Outlet
	Wall Switch: Mount 48" A.F.F. U.O.N.
	Three-Way Switch
	Switch w/ Dimmer
	Switch w/ Timer
	Television Antenna or Cable Outlet
	Clock Outlet
	Speaker
	Intercom
	Telephone Wall Outlet
	Telephone Floor Outlet
	Data/Communications
	Electrical Panel Board
	Junction Box
	Surface or Pendant Mounted Fixture (Number Refers To Fixture Schedule)
	Recessed Fixture
	Recessed Wall Washer
	Wall Mounted Fixture
	Track Mounted Fixture
	Strip Fixture (Also: symbol)
	Flood Lights w/Motion Detector
	Ceiling Mounted Heat Lamp
	Ceiling Mounted Exhaust Fan Unit
	Ceiling Mounted Combination Unit
	Door Chime: Mount At 48" A.F.F. U.O.N.
	Smoke Detector
	Thermostat
	Timer
	Automatic Sprinkler (U=Up : D=Down)
	Alarm key Pad, Mount At 48" A.F.F. U.O.N.
	Battery Powered Emergency Light
	Exit Sign
	Battery Powered Exit Sign
	Existing Outlet or Fixture
	Relocate Existing Outlet or Fixture
	Electric Door Release, Mount At 48" A.F.F. U.O.N.
	Security System
	Supply Air Diffuser
	Return/Exhaust Air Register
	Forced Air Unit
	Water Heater
	Shower Head
	Hose Bib
	Water Line
	Gas
	Floor Drain
	Roof Drain
	Down Spout
	Vacuum

DRAWING CONVENTIONS & GENERAL NOTES

- DO NOT SCALE DRAWINGS.
- EXTERIOR HORIZONTAL DIMENSIONS ARE SHOWN FROM OUTSIDE FACE OF SHEATHING AND OUTSIDE FACE OF CONCRETE.
- INTERIOR HORIZONTAL DIMENSIONS ARE SHOWN FROM FINISHED FACE OF GYPSUM BOARD (OR TILE SUBSTRATE) TO FINISHED FACE.
- VERTICAL DIMENSIONS ARE SHOWN TO TOP OF CONCRETE SLAB OR FLOOR SHEATHING AND ROOF SHEATHING.
- ALWAYS VERIFY EXISTING DIMENSIONS.
- WORK SHALL BE PERFORMED IN AN ORDERLY AND CAREFUL MANNER WITH DUE CONSIDERATION FOR THE SAFETY AND PROTECTION OF ALL PERSONNEL. EXISTING SURFACES, MATERIALS AND EQUIPMENT. DUST-PROTECTIVE AND OTHER PROTECTIVE DEVICES SHALL BE INSTALLED AND MAINTAINED AS NECESSARY, AND AS REQUIRED BY THE OWNER AND AUTHORITIES.
- LOCATE, IDENTIFY, SHUT OFF, DISCONNECT AND CAP OFF UTILITY SERVICES TO BE DEMOLISHED. NOTIFY UTILITY COMPANY AS REQUIRED.
- MAINTAIN AND PROTECT (E) UTILITIES TO REMAIN IN SERVICE BEFORE PROCEEDING WITH DEMOLITION, PROVIDING BYPASS CONNECTIONS AS APPROPRIATE.
- CONDUCT DEMOLITION OPERATIONS AND REMOVE DEBRIS TO PREVENT INJURY TO PEOPLE AND DAMAGE TO ADJACENT BUILDINGS AND SITE IMPROVEMENTS.
- PROVIDE AND MAINTAIN SHORING, BRACING OR STRUCTURAL SUPPORT TO PRESERVE BUILDING STABILITY AND PREVENT SETTLEMENT OR COLLAPSE.
- PROMPTLY REMOVE DEMOLISHED MATERIALS FROM OWNER'S PROPERTY AND LEGALLY DISPOSE OF THEM. DO NOT BURN DEMOLISHED MATERIALS.
- IT IS THE GC'S RESPONSIBILITY TO LAY OUT FRAMING THAT COORDINATES WITH THE LIGHTING LAYOUT. GC SHALL MODIFY FRAMING AS REQUIRED TO ACCOMMODATE LIGHTING LAYOUT AT NO ADDITIONAL COST TO OWNER.
- CONTRACTOR AND SUBCONTRACTORS SHALL EXAMINE THE SITE AND COMPARE EXISTING CONDITIONS WITH THE DRAWINGS AND SPECIFICATIONS, AND CALL TO THE ATTENTION OF THE ARCHITECT, PRIOR TO PERFORMANCE OF ANY WORK, ANY DISCREPANCIES WHICH MAY AFFECT THE WORK.
- UNLESS OTHERWISE INDICATED, ALL TYPICAL DETAILS SHALL BE USED WHEREVER APPLICABLE.
- TOXIC MATERIALS:
A. CERTIFICATION: MANUFACTURERS AND SUPPLIERS SHALL CERTIFY THAT NO MATERIALS THAT APPEAR ON THE STATE OF CALIFORNIA'S LIST OF TOXIC MATERIALS WILL BE USED WITHOUT PROPER NOTICE AND SAFETY PRECAUTIONS.
B. ASBESTOS AND OTHER TOXIC MATERIALS: INVESTIGATION OF EXISTING, REMOVAL OF, OR DEALING WITH ASBESTOS AND OTHER TOXIC MATERIALS IS NOT INCLUDED IN THE WORK. THE ARCHITECT AND CONSULTANTS SHALL NOT BE RESPONSIBLE FOR THE INVESTIGATION, DETECTION, PRESENCE, ABATEMENT, REPLACEMENT, OR REMOVAL OF PRODUCTS, MATERIALS OR PROCESSES CONTAINING ASBESTOS OR OTHER TOXIC MATERIALS. TOXIC MATERIALS ARE AS DEFINED BY THE ENVIRONMENTAL PROTECTION AGENCY, STATE OF CALIFORNIA, OR OTHER PUBLIC AGENCY.
- FOUNDATION DRAINAGE / MECHANICAL / FIRE SPRINKLER / PLUMBING / ELECTRICAL DESIGN-BUILD: ALL WORK SHOWN ON THE DRAWINGS IS A SCHEMATIC INDICATION ONLY OF THE INTENDED INSTALLATIONS. THE ACTUAL DESIGN AND ENGINEERING AND REQUIRED CONSTRUCTION AND PERMIT DOCUMENTATION SHALL BE PROVIDED AS REQUIRED BY THE GENERAL CONTRACTOR'S QUALIFIED DESIGN-BUILD SUBCONTRACTORS. SUCH DOCUMENTATION SHALL BE SUBMITTED FOR THE ARCHITECT'S REVIEW PRIOR TO COMMENCEMENT OF WORK.

PROJECT STATISTICS

PROJECT ADDRESS:	630 28TH STREET SAN FRANCISCO, CA 94131
LOT NO.:	6605
BLOCK NO.:	004A
OCCUPANCY GROUP:	RH-1

TYPE OF CONSTRUCTION: V-B
CONSTRUCTION SHALL COMPLY WITH:
[2010 CBC, CPC, CMC AND 2010 CEC.]

DRAWING INDEX

A0.1	GENERAL NOTES, DRAWING CONVENTIONS, SYMBOLS
A1.0	SITE PLAN
A1.1	GROUND FLOOR EXISTING AND DEMOLITION PLAN
A1.2	EXISTING FIRST FLOOR PLAN
A2.1	PROPOSED GROUND FLOOR PLAN
A3.1	EXISTING EXTERIOR ELEVATIONS: SOUTH + (PARTIAL) EAST
A3.2	PROPOSED EXTERIOR ELEVATIONS: SOUTH + (PARTIAL) EAST

SCOPE OF WORK

-
-

PROJECT DIRECTORY

OWNER:	Frank Cialone and Mimi Powers 630 28th Street San Francisco, CA 94131 ----- Tel.
ARCHITECT:	Jerry Veverka, AIA VEVERKA ARCHITECTS 2525 18th Street, Suite 310 San Francisco, CA 94103 415.777.3150 Tel.

GENERAL NOTES, DRAWING CONVENTIONS, SYMBOLS


28TH STREET RESIDENCE

630 28TH STREET

SAN FRANCISCO, CA 94131

JOB NUMBER:	1102
DRAWN BY:	JF
CHECKED BY:	JV
SCALE:	AS NOTED
DATE	11.16.11

A0.1

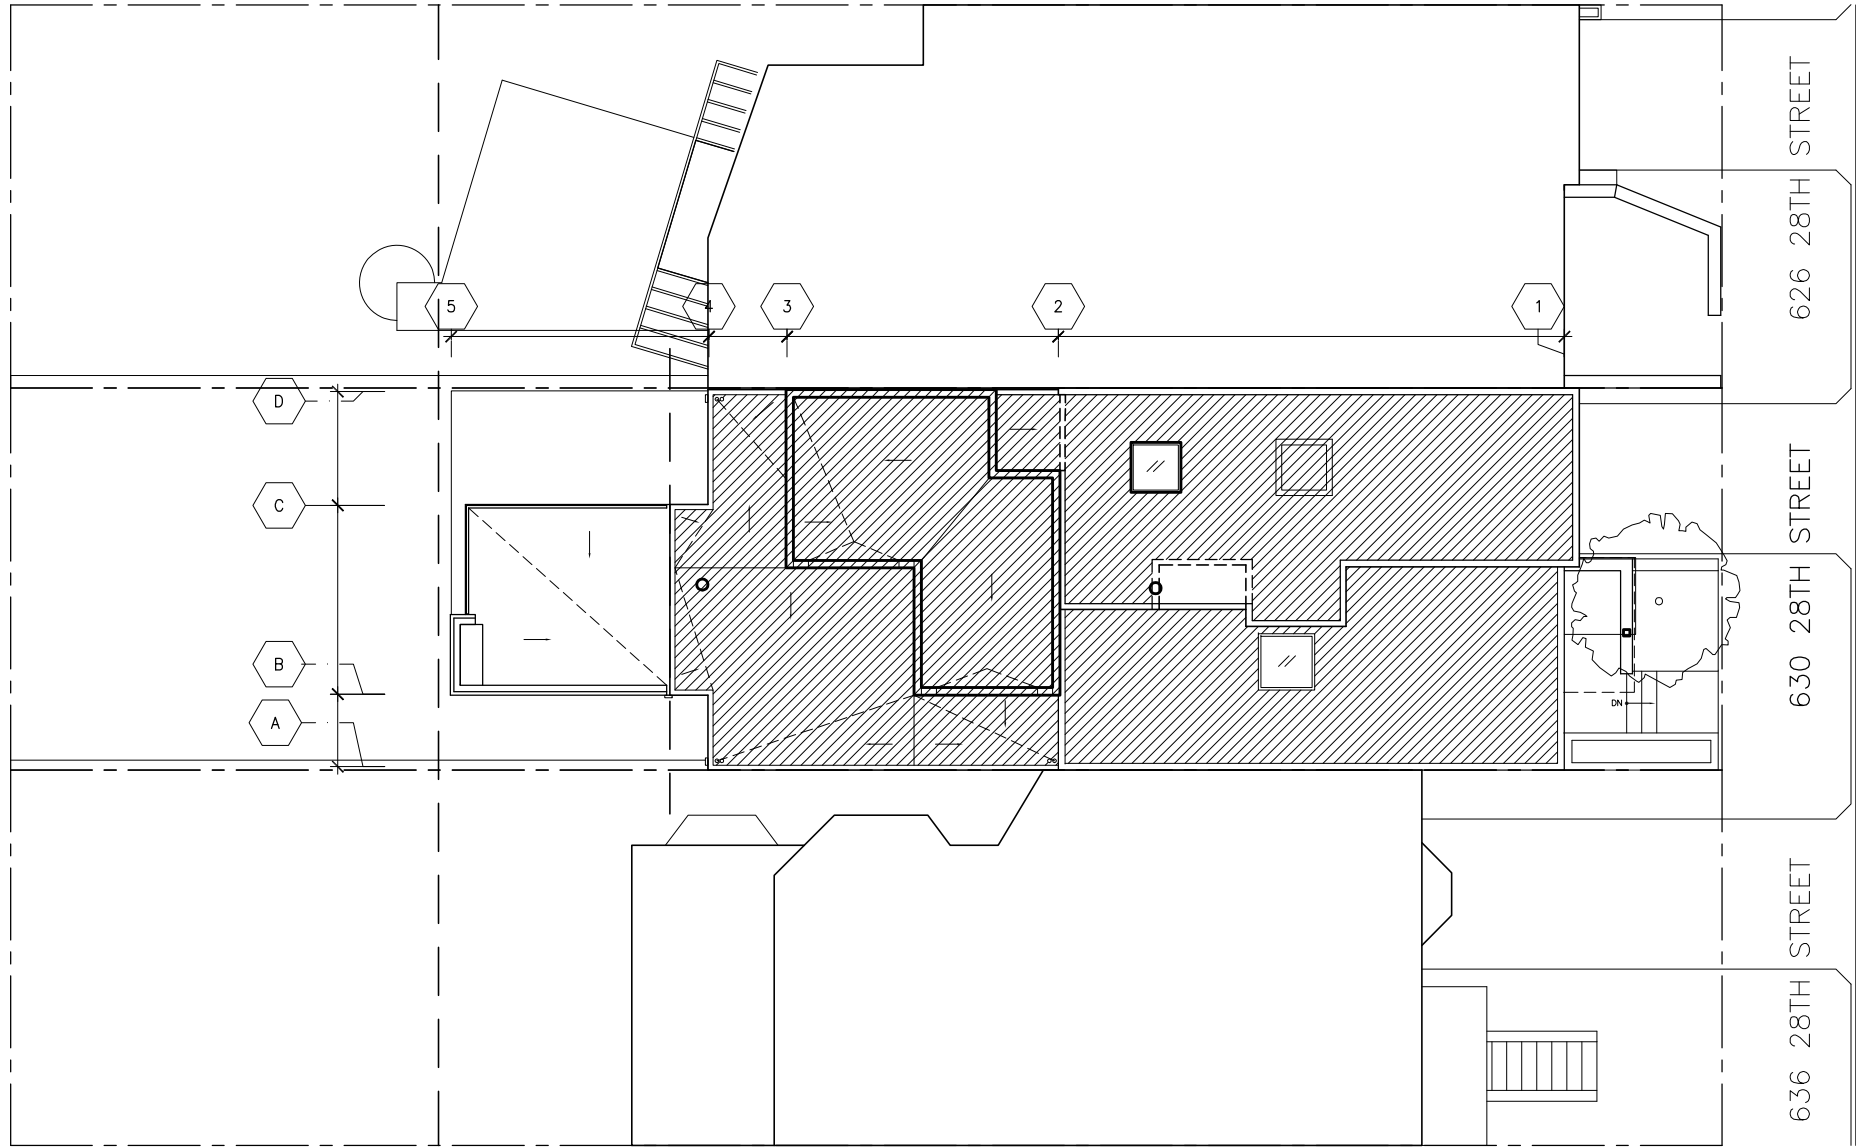

PLOT PLAN
SCALE: 1/8"=1'-0"



SYMBOL LEGEND

	CONCRETE WALL	ROOM NAME ###	ROOM IDENTIFICATION
	(N) WALL/PARTITION		WINDOW IDENTIFICATION
	RATED WALL/PARTITION		DOOR IDENTIFICATION
	INSULATED WALL/PARTITION		OFCI IDENTIFICATION
	(E) WALL/PARTITION TO BE REMOVED		BUILDING SECTION DRAWING#/PLOT SHEET#
	(E) WALL/PARTITION TO REMAIN		PROPOSED GRADE ELEVATION
	TYPICAL FOR INTERIOR WOOD CONSTRUCTION		
	TYPICAL FOR EXTERIOR WOOD CONSTRUCTION		
	TYP. FOR INTERIOR NON-COMBUSTIBLE CONSTRUCTION		
	TYP. FOR EXTERIOR NON-COMBUSTIBLE CONSTRUCTION		

GENERAL NOTES:

- A. DO NOT SCALE DRAWINGS.
- B. FOR (N) CONSTRUCTION: HORIZONTAL DIMENSIONS ARE TAKEN FROM FACE OF EXTERIOR SHEATHING AND FINISH FACE OF INTERIOR PARTITIONS AND WALLS. VERTICAL DIMENSIONS ARE TAKEN TO TOP OF CONCRETE SLAB OR SUBFLOOR (FLOOR SHEATHING) AND ROOF SHEATHING.
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VEVERKA
ARCHITECTS

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Fax (415) 512-7796



PLOT PLAN

28TH STREET RESIDENCE

630 28TH STREET
SAN FRANCISCO, CA 94131



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CHECKED BY: JV
SCALE: 1/8"=1'-0"

DATE 11.16.11

A1.0



EXISTING GROUND FLOOR PLAN
SCALE: 1/4"=1'-0"

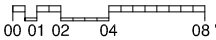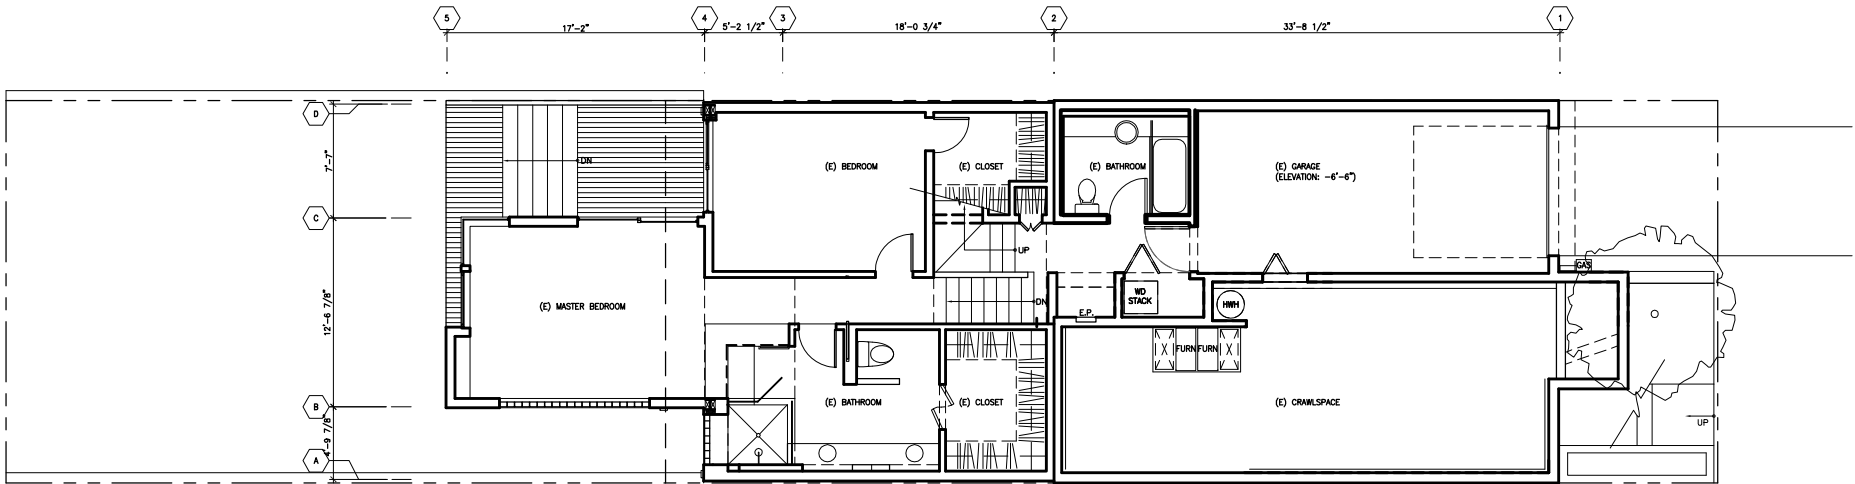

SYMBOL LEGEND

	CONCRETE WALL	ROOM NAME ###	ROOM IDENTIFICATION
	(N) WALL/PARTITION		WINDOW IDENTIFICATION
	RATED WALL/PARTITION		DOOR IDENTIFICATION
	INSULATED WALL/PARTITION		OFCI IDENTIFICATION
	(E) WALL/PARTITION TO BE REMOVED		BUILDING SECTION DRAWING#/PLOT SHEET#
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EXISTING GROUND FLOOR PLAN

28TH STREET RESIDENCE

630 28TH STREET
SAN FRANCISCO, CA 94131

JOB NUMBER: 1102
DRAWN BY: JF
CHECKED BY: JV
SCALE: 1/4"=1'-0"


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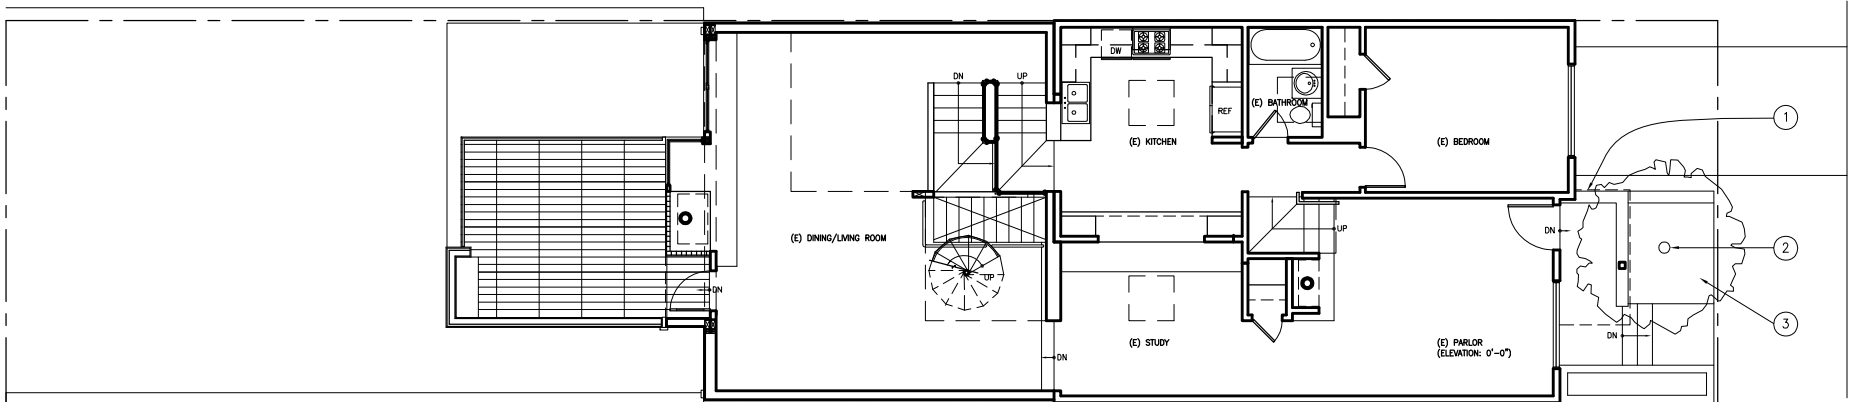


EXISTING AND PROPOSED FIRST FLOOR PLAN (NO CHANGE)

SCALE: 1/4"=1'-0"



1

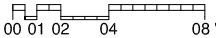

SYMBOL LEGEND

	CONCRETE WALL	ROOM NAME ###	ROOM IDENTIFICATION
	(N) WALL/PARTITION		WINDOW IDENTIFICATION
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DRAWING NOTES:

- ① (E) PORCH, PLANTER AND STAIRS TO REMAIN AS IS POST CONSTRUCTION.
- ② REMOVE (E) TREE AND REPLACE WITH JAPANESE MAPLE TREE.
- ③ GROUND COVER: ASIAN JASMINE.

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(E) AND (P) FIRST FLOOR PLAN (NO CHANGE)

28TH STREET RESIDENCE

630 28TH STREET
SAN FRANCISCO, CA 94131


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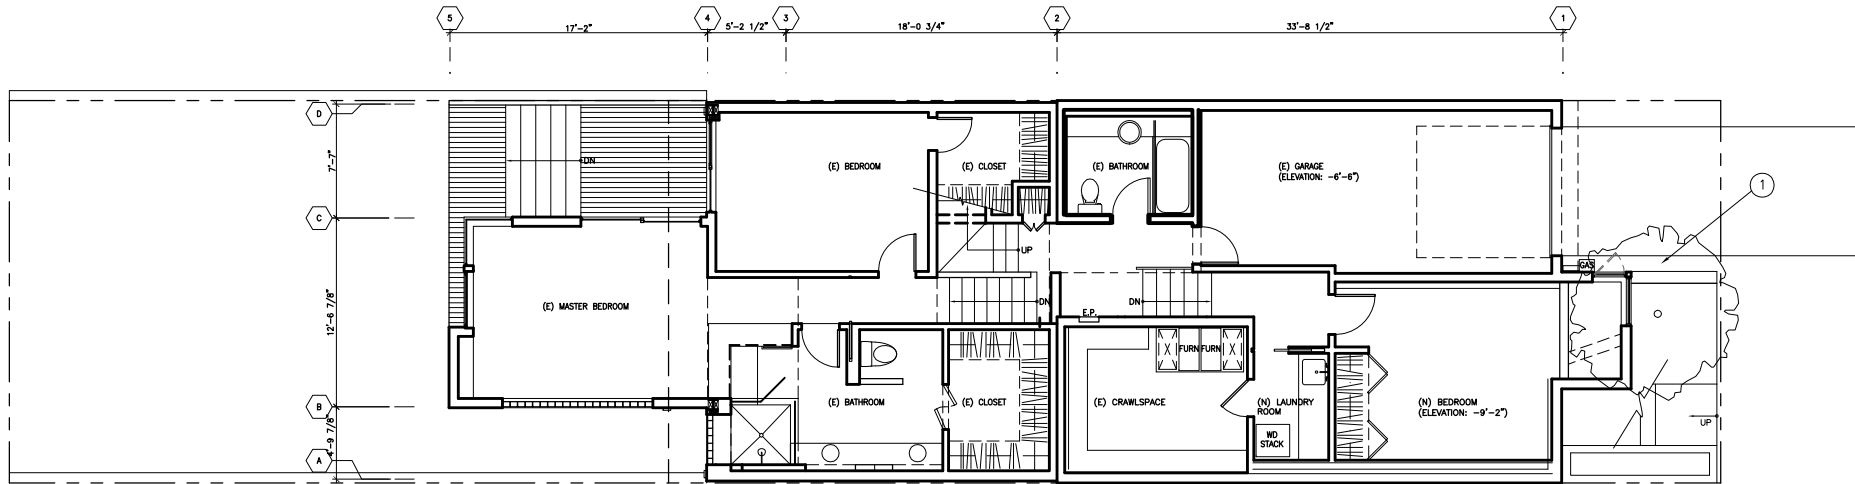
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PROPOSED GROUND FLOOR PLAN
SCALE: 1/8"=1'-0"



1



SYMBOL LEGEND

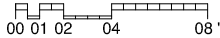	ROOM NAME	ROOM IDENTIFICATION
	CONCRETE WALL	###
	(N) WALL/PARTITION	W##
	RATED WALL/PARTITION	##X
	INSULATED WALL/PARTITION	##_X#
	(E) WALL/PARTITION TO BE REMOVED	#X#.#
	(E) WALL/PARTITION TO REMAIN	####.##
	TYPICAL FOR INTERIOR WOOD CONSTRUCTION	
	TYPICAL FOR EXTERIOR WOOD CONSTRUCTION	
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DRAWING NOTES:

- 1 PROPOSED WINDOWS

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PROPOSED GROUND FLOOR PLAN


28TH STREET RESIDENCE

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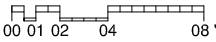
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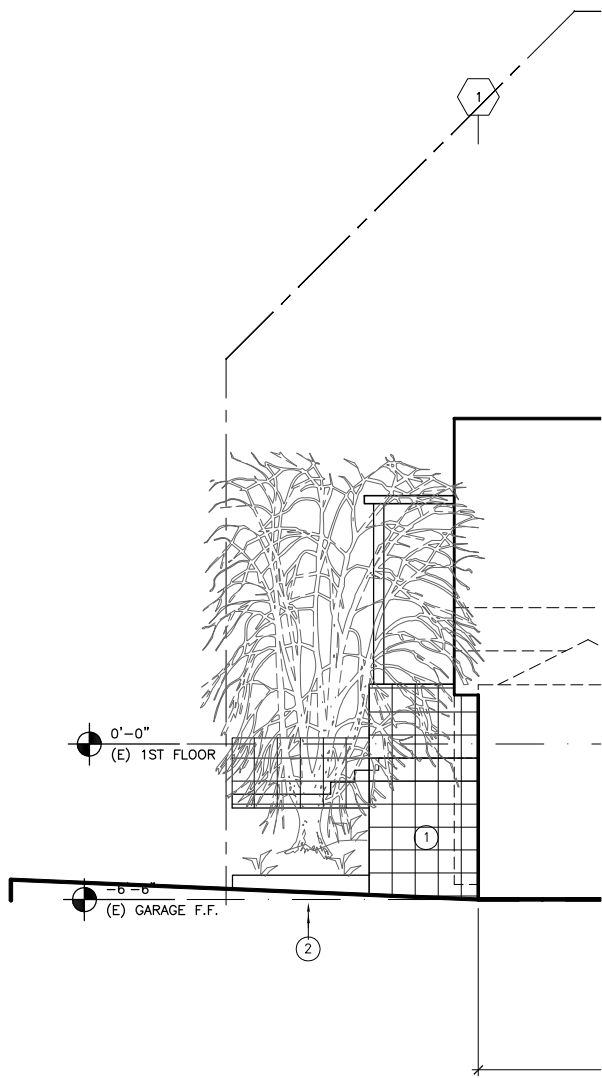
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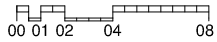
EXISTING SOUTH ELEVATION
SCALE: 1/4"=1'-0"



1

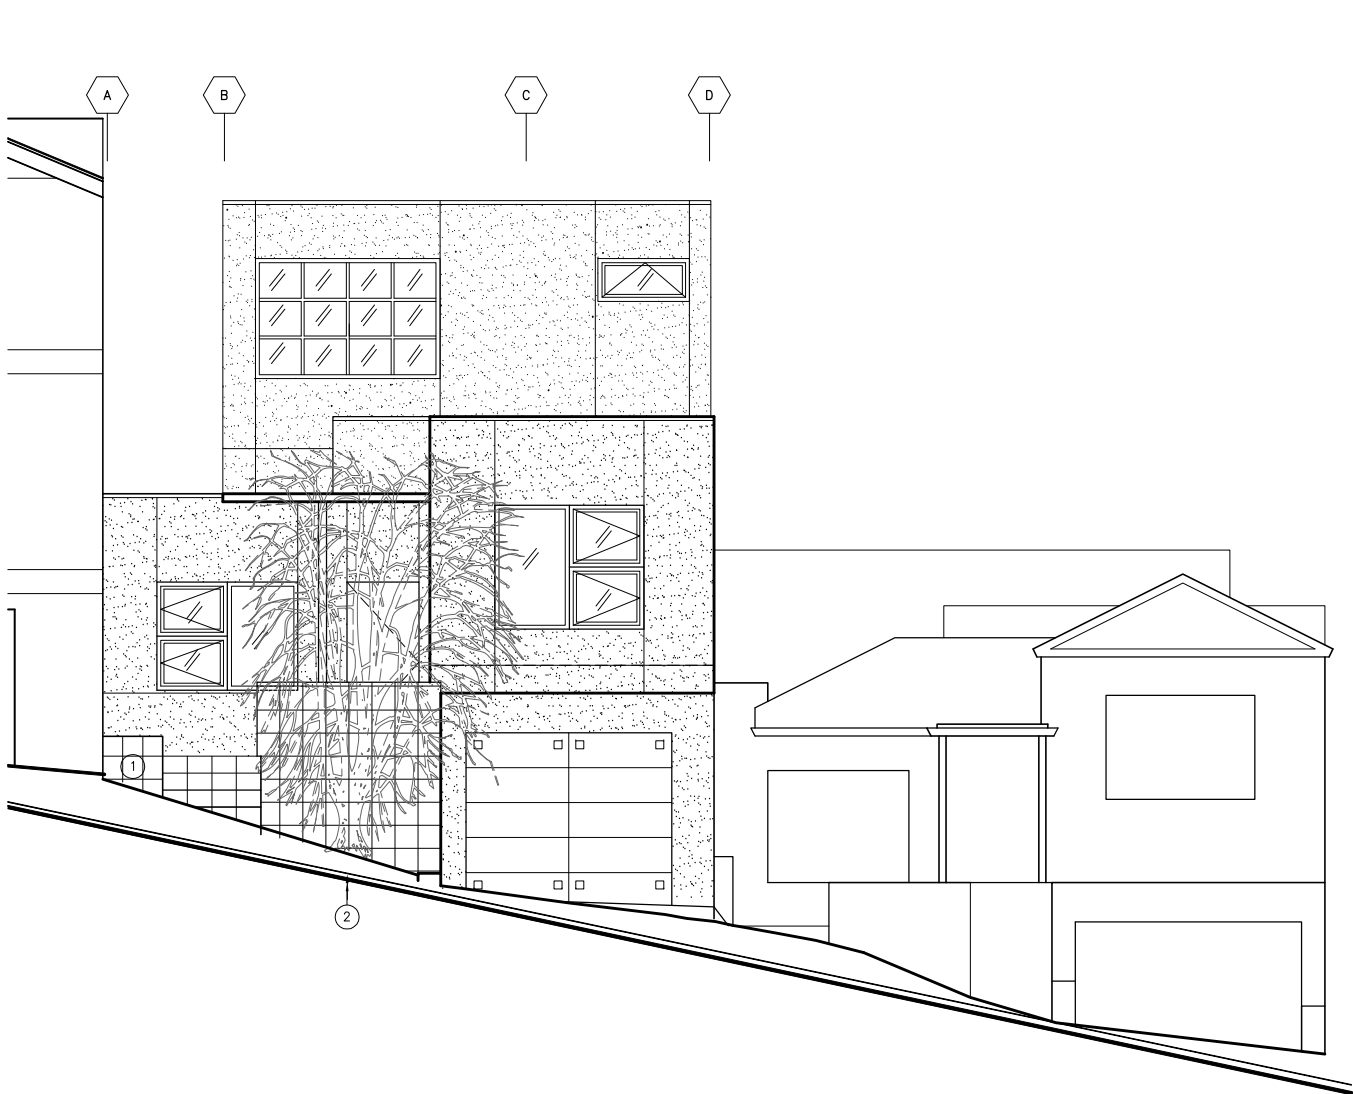

EXISTING (PARTIAL) EAST ELEVATION
SCALE: 1/4"=1'-0"



2

SYMBOL LEGEND			
	LIMIT OF WORK THIS CONTRACT		BUILDING SECTION DRAWING#/PLOT SHEET#
	WORK POINT, CONTROL POINT OR DATUM POINT		DOOR IDENTIFICATION
	WORK OR COLUMN LINE		WINDOW IDENTIFICATION
	REVISION BUBBLE AND TRIANGLE		DETAIL/DRAWING REF. DETAIL # PLOT SHEET #

GENERAL NOTES:

A DO NOT SCALE DRAWINGS.

B FOR (E) CONSTRUCTION:
(E) FLOOR LEVEL DIMENSIONS ARE TO TOP OF FLOOR FINISH.

FOR (N) CONSTRUCTION:
HORIZONTAL DIMENSIONS ARE TAKEN FROM FINISH FACE TO FINISH FACE.
VERTICAL DIMENSIONS ARE TAKEN FROM TOP OF CONCRETE SLAB OR FLOOR SHEATHING TO FINISH FACE OF CEILING.

C PROVIDE BLOCKING IN WALLS FOR ANY WALL-MOUNTED ACCESSORIES AND FIXTURES.

D GC/SUB TO VERIFY LOCATIONS OF ALL FIXTURES ON SITE WITH ARCHITECT.
ALIGN ALL SHOWER AND TUB FIXTURES TO CENTER ON TILES OR GROUT LINES - SEE INTERIOR ELEVATIONS AND NOTIFY ARCHITECT OF ANY CONFLICT.

DRAWING NOTES:

① (E) BLACK SLATE TILE

② REMOVE (E) TREE AND REPLACE WITH JAPANESE MAPLE.

VEVERKA
ARCHITECTS

645 Harrison Street #101
San Francisco, CA 94107
Telephone (415) 777-3150
Fax (415) 512-7796



EXISTING EXTERIOR ELEVATIONS

28TH STREET RESIDENCE


630 28TH STREET

SAN FRANCISCO, CA 94131


JOB NUMBER: 1102
DRAWN BY: JF
CHECKED BY: JV
SCALE: 1/4"=1'-0"

DATE 11.16.11


A3.1

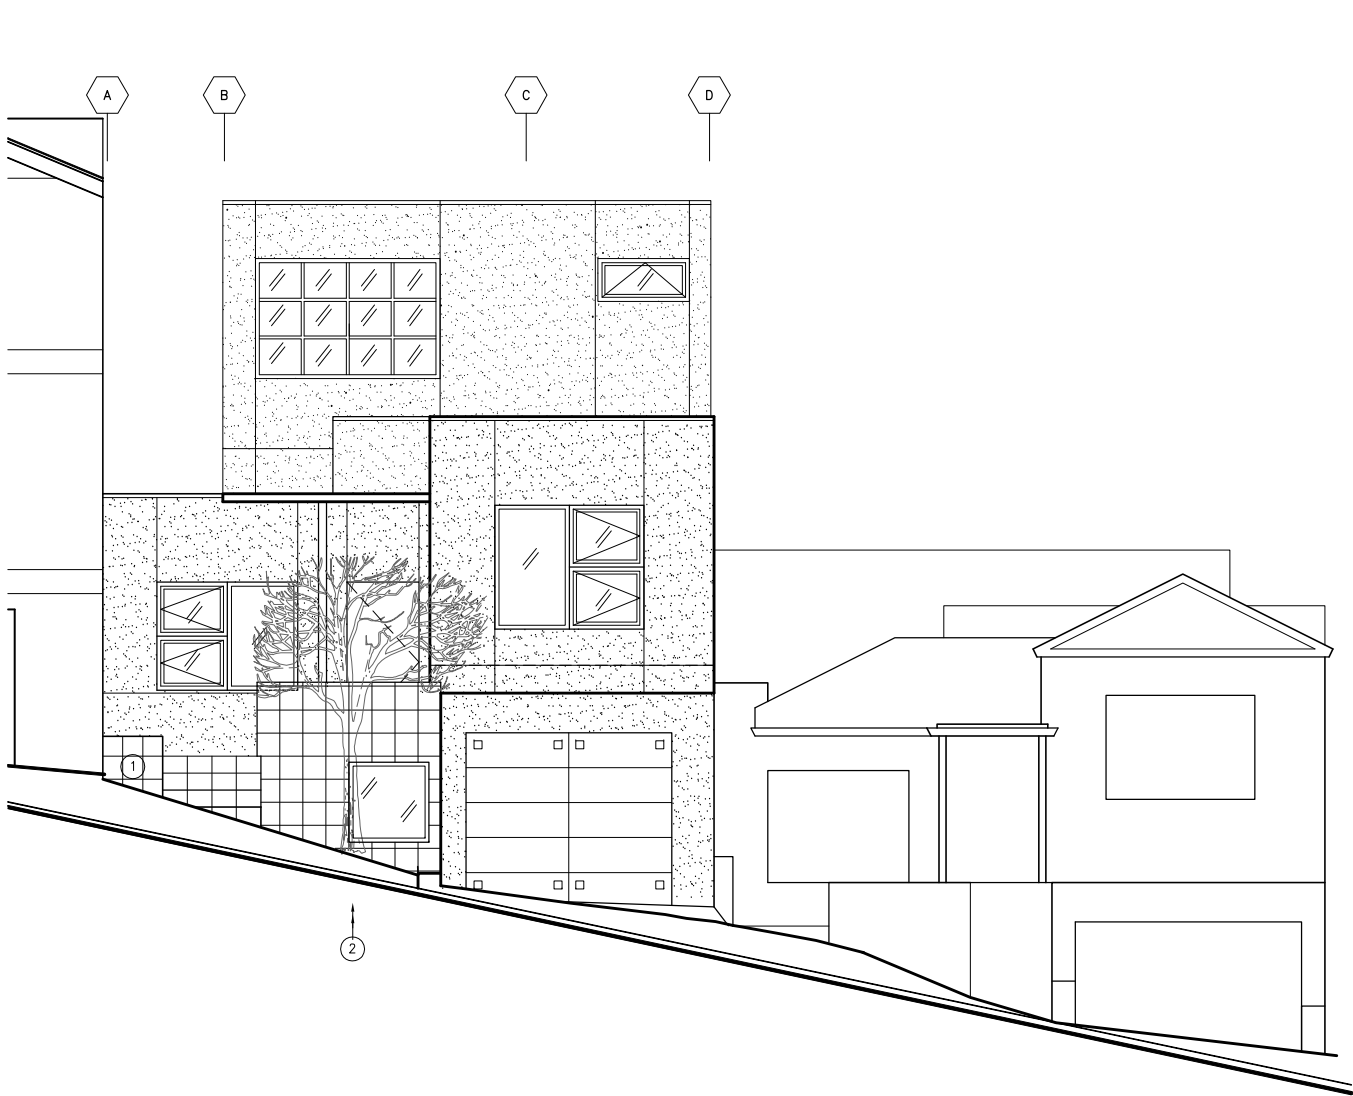


PROPOSED SOUTH ELEVATION
SCALE: 1/4"=1'-0"

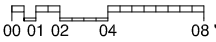

1

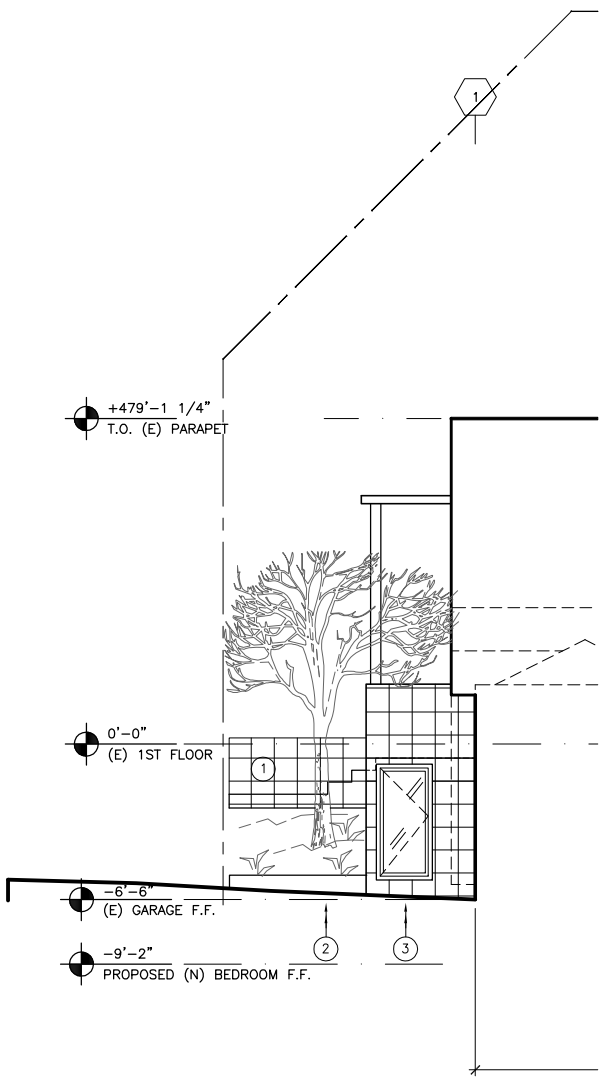

PROPOSED (PARTIAL) EAST ELEVATION
SCALE: 1/4"=1'-0"

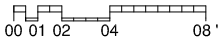

2

SYMBOL LEGEND			
■ ■ ■ ■ ■	LIMIT OF WORK THIS CONTRACT	#/X#.#	BUILDING SECTION DRAWING#/PLOT SHEET#
⊙	WORK POINT, CONTROL POINT OR DATUM POINT	##X	DOOR IDENTIFICATION
X	WORK OR COLUMN LINE	W##	WINDOW IDENTIFICATION
☁ #	REVISION BUBBLE AND TRIANGLE	○	DETAIL/DRAWING REF. DETAIL # PLOT SHEET #

GENERAL NOTES:

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D GC/SUB TO VERIFY LOCATIONS OF ALL FIXTURES ON SITE WITH ARCHITECT. ALIGN ALL SHOWER AND TUB FIXTURES TO CENTER ON TILES OR GROUT LINES - SEE INTERIOR ELEVATIONS AND NOTIFY ARCHITECT OF ANY CONFLICT.

- DRAWING NOTES:
- 1 (E) BLACK SLATE TILE
 - 2 JAPANESE MAPLE TREE
 - 3 PROPOSED WINDOW

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PROPOSED EXTERIOR ELEVATIONS

28TH STREET RESIDENCE
630 28TH STREET
SAN FRANCISCO, CA 94131

JOB NUMBER: 1102
DRAWN BY: JF
CHECKED BY: JV
SCALE: 1/4"=1'-0"
DATE 11.16.11

A3.2