#### MEMO

## **Disclaimer for Review of Plans**

The San Francisco Planning Code requires that the plans of certain proposed projects be provided to members of the public prior to the City's approval action on the project. Accordingly, any images of plans featured on this website are provided for the primary purpose of facilitating public input prior to the City's action. The City and County of San Francisco does not own the copyright to these images. Please be aware that the unauthorized reproduction, distribution, or alteration of these images may result in a violation of Federal Copyright Law (17 U.S.C.A. Sections 101 et seq.) and that any party who seeks to reproduce or alter these images does so at his or her own risk.

Additionally, plans provided on this website are limited to site plans, elevations and/or section details (floor plans and structural details may not be included). These are DRAFT PLANS being provided for public review PRIOR to the City's approval action on the project. Final plans may differ from those that are currently available for review.

1650 Mission St. Suite 400 San Francisco, CA 94103-2479

Reception: 415.558.6378

Fax: 415.558.6409

Planning Information: 415.558.6377 NOTICE OF PUBLIC HEARING

Hearing Date: Wednesday, May 25, 2011

Time: **Beginning at 9:30 AM** 

Location: City Hall, 1 Dr. Carlton B. Goodlett Place, Room 408

Case Type: Variance (Front Setback)
Hearing Body: Zoning Administrator

PROPERTY INFORMATION		APPLICATION INFORMATION	
Project Address: Cross Street(s): Block /Lot No.: Zoning District(s): Area Plan:	237-239 Minerva Street Capitol/Orizaba Avenues 7092/070, 112/113 RH-1 / 40-X	Case No.: Building Permit: Applicant/Agent: Telephone: E-Mail:	2011.0425V 200601242860/200601242864 John Lau (415) 831-7180 dicksongroup@yahoo.com

### PROJECT DESCRIPTION

The proposal is to document the as-built condition of the two single-family dwellings at 237-239 Minerva Street.

**PER SECTION 132 OF THE PLANNING CODE** the subject property is required to maintain a front setback of 15 feet. The subject buildings feature front setbacks of 9 feet; therefore, the project requires a variance from the front setback requirement of the Planning Code.

#### ADDITIONAL INFORMATION

FOR MORE INFORMATION, PLEASE CONTACT PLANNING DEPARTMENT STAFF:

Planner: Tom Wang Telephone: (415) 558-6335 E-Mail: thomas.wang@sfgov.org

**ARCHITECTURAL PLANS:** The site plan and elevations of the proposed project are available on the Planning Department's website at: http://sf-planning.org/ftp/files/notice/2011.0425V.pdf

中文詢問請電:558.6378

Para información en Español llamar al: 558.6378

### GENERAL INFORMATION ABOUT PROCEDURES

#### VARIANCE HEARING INFORMATION

Under Planning Code Section 306.3, you, as a property owner or resident within 300 feet of this proposed project or interested party on record with the Planning Department, are being notified of this Variance Hearing. You are not obligated to take any action. For more information regarding the proposed work, or to express concerns about the project, please contact the Applicant/Agent or Planner listed on this notice as soon as possible. Additionally, you may wish to discuss the project with your neighbors and neighborhood association or improvement club, as they may already be aware of the project.

Persons who are unable to attend the public hearing may submit written comments regarding this application to the Zoning Administrator, Planning Department, 1650 Mission Street, Suite 400, San Francisco, CA 94103, by 5:00pm the day prior to the hearing. These comments will be made a part of the official public record, and will be brought to the attention of the person or persons conducting the public meeting or hearing.

#### **BOARD OF APPEALS**

An appeal of the approval (or denial) of a **variance application** by the Zoning Administrator may be made to the **Board of Appeals within 10 days** after the **Variance Decision Letter** is issued by the Zoning Administrator.

An appeal of the approval (or denial) of a **building permit application** by the Planning Department may be made to the **Board of Appeals within 15 days** after the **building permit** is issued (or denied) by the Director of the Department of Building Inspection.

Appeals must be submitted in person at the **Board's office at 1650 Mission Street**, **3rd Floor**, **Room 304**. For further information about appeals to the Board of Appeals, including current fees, **contact the Board of Appeals** at **(415) 575-6880**.

#### **ABOUT THIS NOTICE**

The Planning Department is currently reviewing its processes and procedures for public notification as part of the Universal Planning Notification (UPN) Project. The format of this Public Hearing notice was developed through the UPN Project and is currently being utilized in a limited trial-run for notification of Variance Hearings.

If you have any comments or questions related to the UPN Project or the format of this notice, please visit our website at <a href="http://upn.sfplanning.org">http://upn.sfplanning.org</a> for more information.

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Verify all dimensions of the lot, easement, and soil conditions including excavation, underpinning, drainage and utility lines at this property, as well as, at adjacent properties. All construction work shall conform to local building code.

The drawings are intended to describe and provide for a finished piece of work. The contractor shall understand that the work herein described shall be completed in every detail although every necessary item involved is not particularly mentioned. The contractor will be held responsible to provide all the materials and labor necessary for the entire completion of the work intended to be described and shall not avail himself maniféstly of any unintentional error or omission should such exists.

Should any error or inconsistency appears or occurs in the drawing, the contractor shall notify the owner and Architect/Engineer for proper adjustment before proceeding with the work, and in no case, shall proceed with the work in uncertainty.

## Work included:

Except as otherwise specifically stated, the contractor shall provide and pay all materials, labor, tools, equipment, and building permits including encroachment and hauling permits.

## Alterations:

If alterations of design or plan are made without the written consent of the Architect/Engineer, the Architect/Engineer shall not be responsible for such alterations made by or agreed upon between owner and contractor.

## Information confidential

All plans, drawings, specifications and/or information furnished herewith are and shall remain the property of the Architect/Engineer & be held confidential and not be used for any purposes other than those for which they have been supplied and prepared. These drawings are not to be copied or duplicated without the Architect's/Engineer's written permission.

## <u>Note 1:</u>

Built-Up roofing (Typical)

- Modified bitumen w/granule app 180 by firestone company or equivalent over fiberglass base over 3/4" CDX plywood sheating.
- Install R-30 insulation with vapor barrier between roof joists.
- Slope roof 1/4" per foot to drain (draining to
- All roof penetrations, such as roof drains, skyline, chimneys, exhaust fans, vent stacks, etc.. shall be properly flashed to assure water tightness.
- Provide roof overflow drainage as per sect. 3207C of UBC. Roofing Material to be Class "B" fire rated roof assembly or better

# NOTE 2:

Concrete Sidewalk(Typical)

Slope finish surface between 1.67% and 2% from top of curb to property line. Provide dummy joints or scored lines as shown. (Must comply with city requirements)

# NOTE 3:

Street tree (Typical 15-gal. London tree) in 4'x4' min. brown brick planter w/2x2 redwood stakes.

# APPLICABLE CODES:

APPLICABLE CODES.
CURRENT SAN FRANCISCO ZONING ORDINATES
CALIFORNIA BUILDING CODE,2007 EDITION
CALIFORNIA MECHANICAL CODE,2007 EDITION
CALIFORNIA PLUMBING CODE,2007 EDITION
CALIFORNIA ELECTRIC CODE,2007 EDITION
THE SAN FRANCISCO HOUSING CODE,2007 EDITION
CALIFORNIA ENERGY CODE,2007 EDITION
CURRENT SAN FRANCISCO AMENDMENTS FOR ALL CODES

# DRAWING INDEX

GENERAL NOTES

EXISTING & PROPOSED SITE & ROOF PLAN

A-2.2: EXISTING FLOOR PLAN & ELEVATIONS

PROPOSED 1ST FLOOR PLAN &

2ND FLOOR PLAN & 3RD FLOOR PLAN PROPOSED FRONT & RIGHT ELEVATIONS

A-4: PROPOSED LEFT & REAR ELEVATION

A - 6: SECTION A-A , B-B PROJECT DATA

JOB ADDRESS: \_\_\_\_\_\_ 237 MINERVA

SAN FRANCISCO, CA

**SYMBOLS** 

SHEET NO.

DETAIL

REVISION NO.

—SHEET NO.

SECTION NO.

BLOCK: \_\_\_\_\_\_\_7092

ZONING: TYPE OF CONSTRUCTION: V-B

OCCUPANCY: — R-3

SCOPE OF WORK

REVISION FOR THE APPROVED PLAN #2006/0124/2860 S1/R1 TO REVISE FRONT SETBACK OF THE BUILDING.

# ELECTRICAL LEGEND:

SYMBOLS	
$\Rightarrow$	Wall Duplex 110V
$\Rightarrow$	Wall Outlet 220V
→ GFCI	Wall Duplex 110V w/ Ground Fault Circult Interrupter
$\bigcirc$	Exhaust Fan
FLUR.	Exhaust Fan W/ Compact Fluorescent Light
	Ceiling Lighting Outlet
- <u>M</u> -	Ceiling Lighting Outlet w/ Motion Sensor
	Ceiling Lighting Outlet w/ Weather Proof
-(M)- WP.	Ceiling Lighting Outlet w/ Weather Proof & Motion Sensor
	Drop Cord / Pendent
-R-	Recess Lighting Outlet
<u> </u>	Wall Lighting Outlet
<u>M</u> -	Wall Lighting Outlet w/ Motion Sensor
	Fluorescent (Wall Mount)
	Fluorescent (Ceiling Mount)
\$	Single Pole Switch
\$ <sub>D</sub>	Single Pole Switch / Dimmer
\$3	Three Way Switch
SD	Smoke Detector

REVISIONS BY


DICKSON
CONSULTING GROUP
5616 Geary Blvd, Suite 201
San Francisco, Ca. 94121

H B LOT: BLOCK:7092, L 237 MINERVA SAN FRANCISC


DATE 04/27/11 SCALE 1/4"=1'-0" DRAWN KEN



OF SHEETS

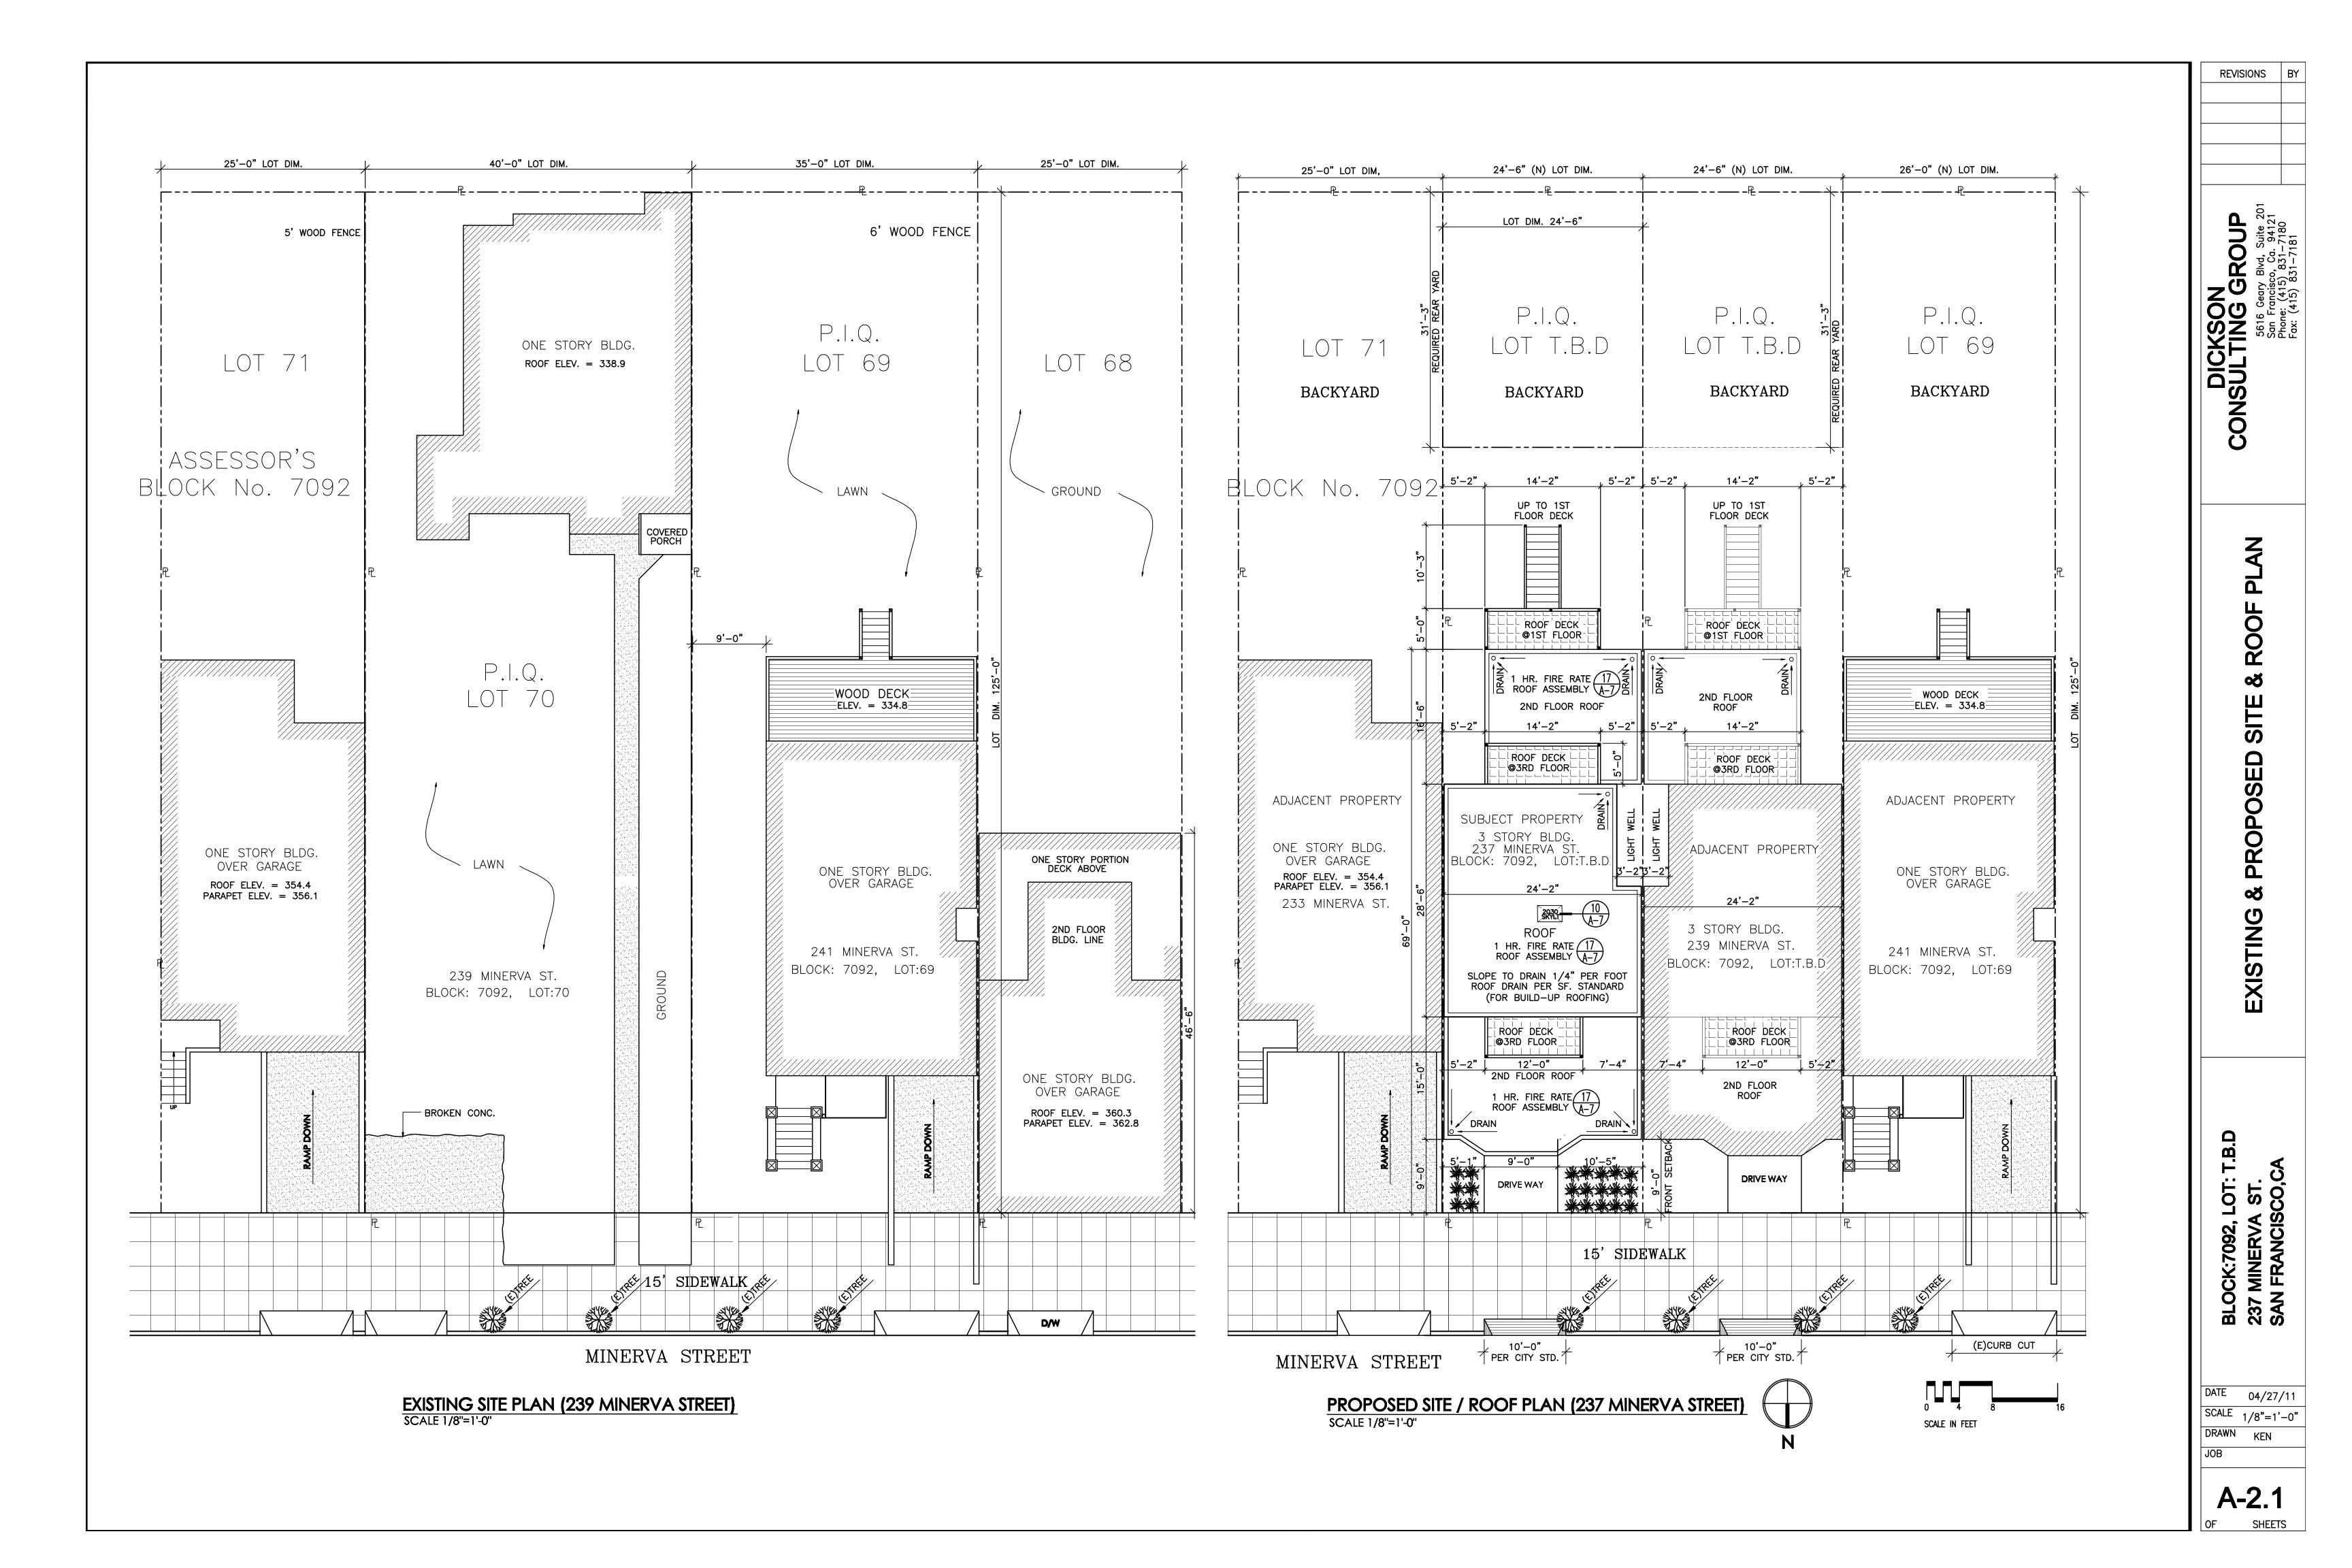

**REVISIONS** 

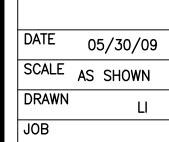


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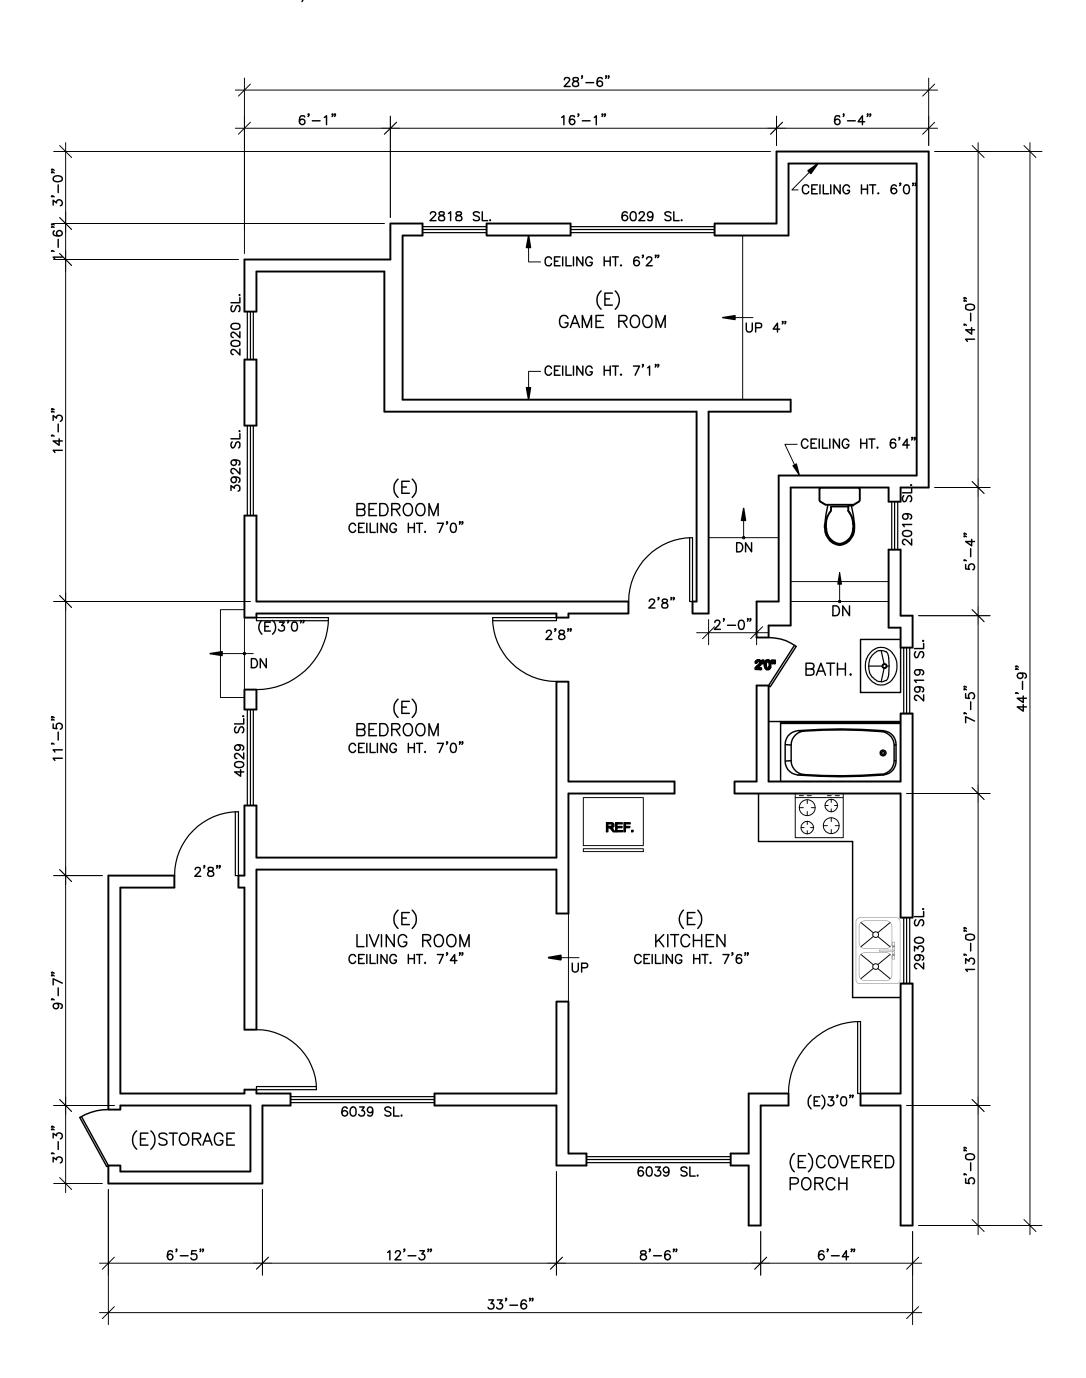
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SCALE IN FEET


OF SHEETS



# EXISTING FRONT ELEVATION (NORTH) SCALE: 1/4"=1'-0"

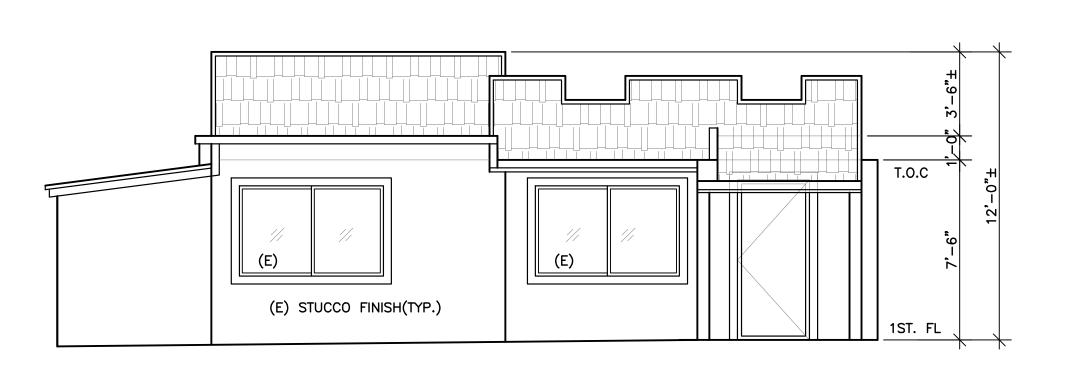


EXISTING FLOOR PLAN (239 MINERVA ST.)
SCALE 1/4"=1'-0"

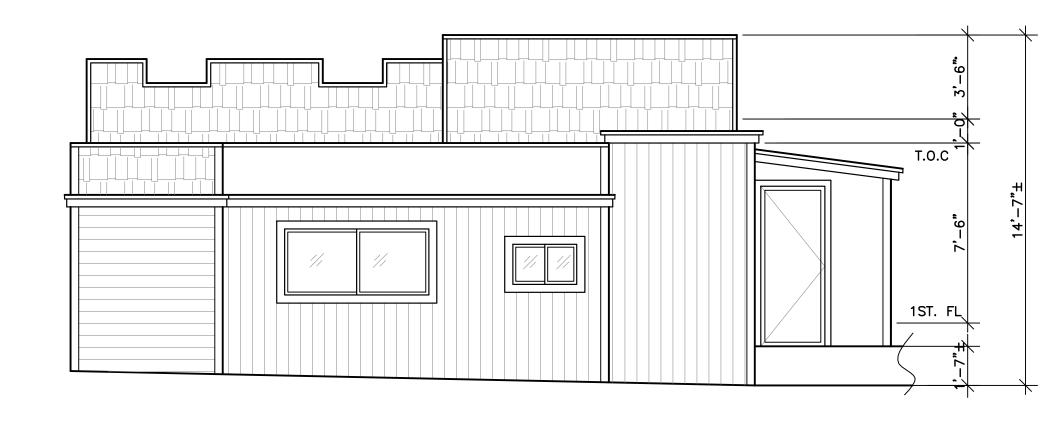


EXISTING REAR ELEVATION (SOUTH)
SCALE: 1/4"=1'-0"





PROPOSED LEFT ELEVATION (EAST)
SCALE:1/4"=1'-0"

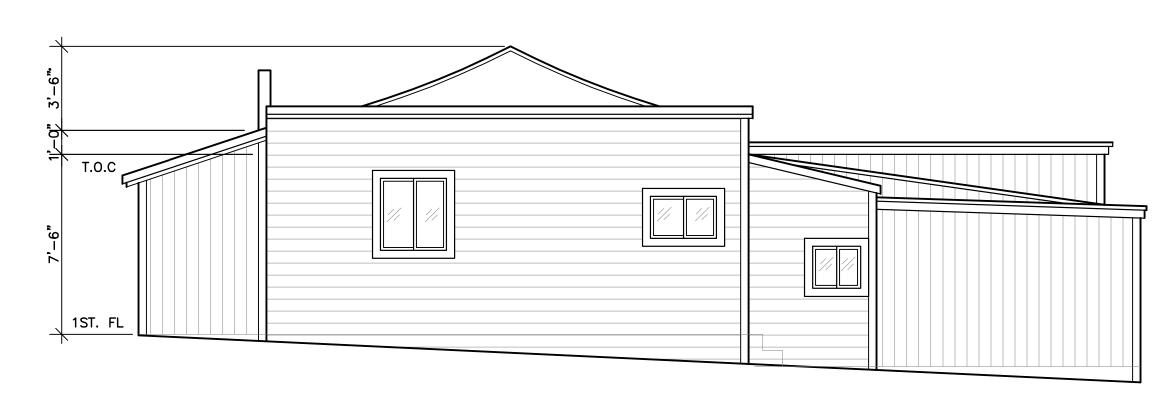

EXISTING RIGHT ELEVATION (WEST)
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CALIFORNIA ELECTRIC CODE, 2007 EDITION
THE SAN FRANCISCO HOUSING CODE, 2007 EDITION
CALIFORNIA ENERGY CODE, 2007 EDITION
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A-2.2: EXISTING FLOOR PLAN & ELEVATIONS

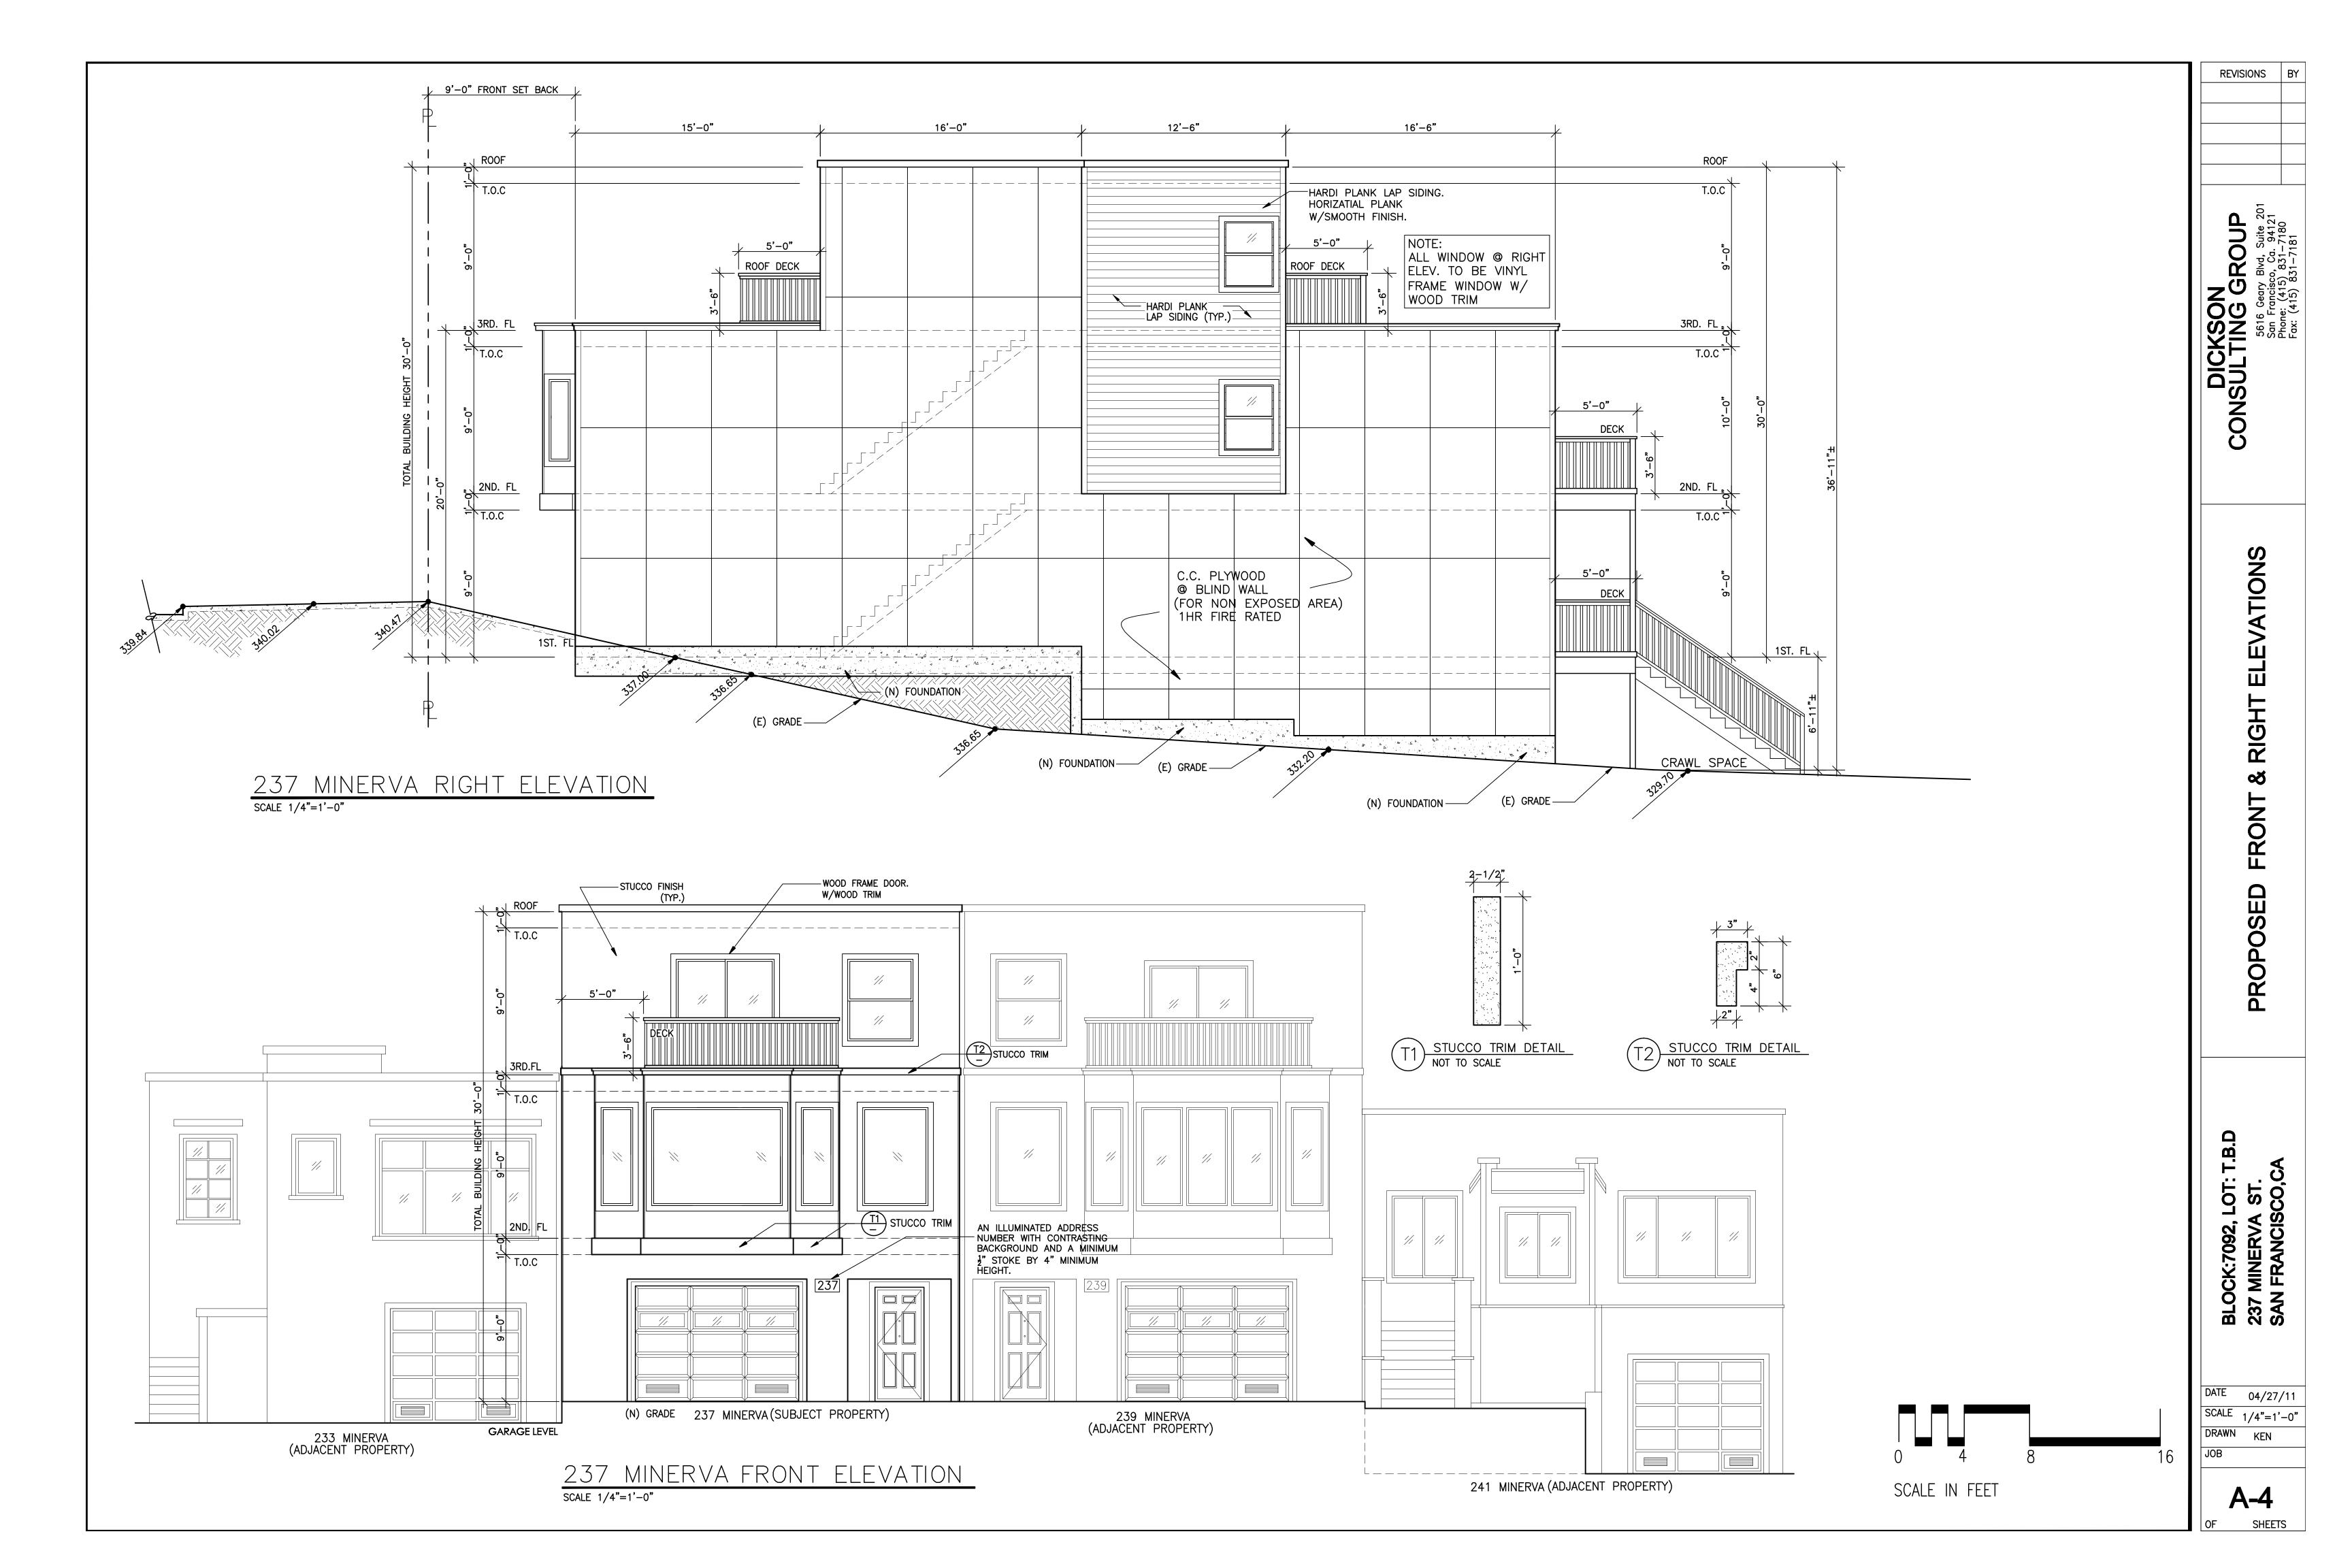PROPOSED 1ST FLOOR PLAN, A - 3:

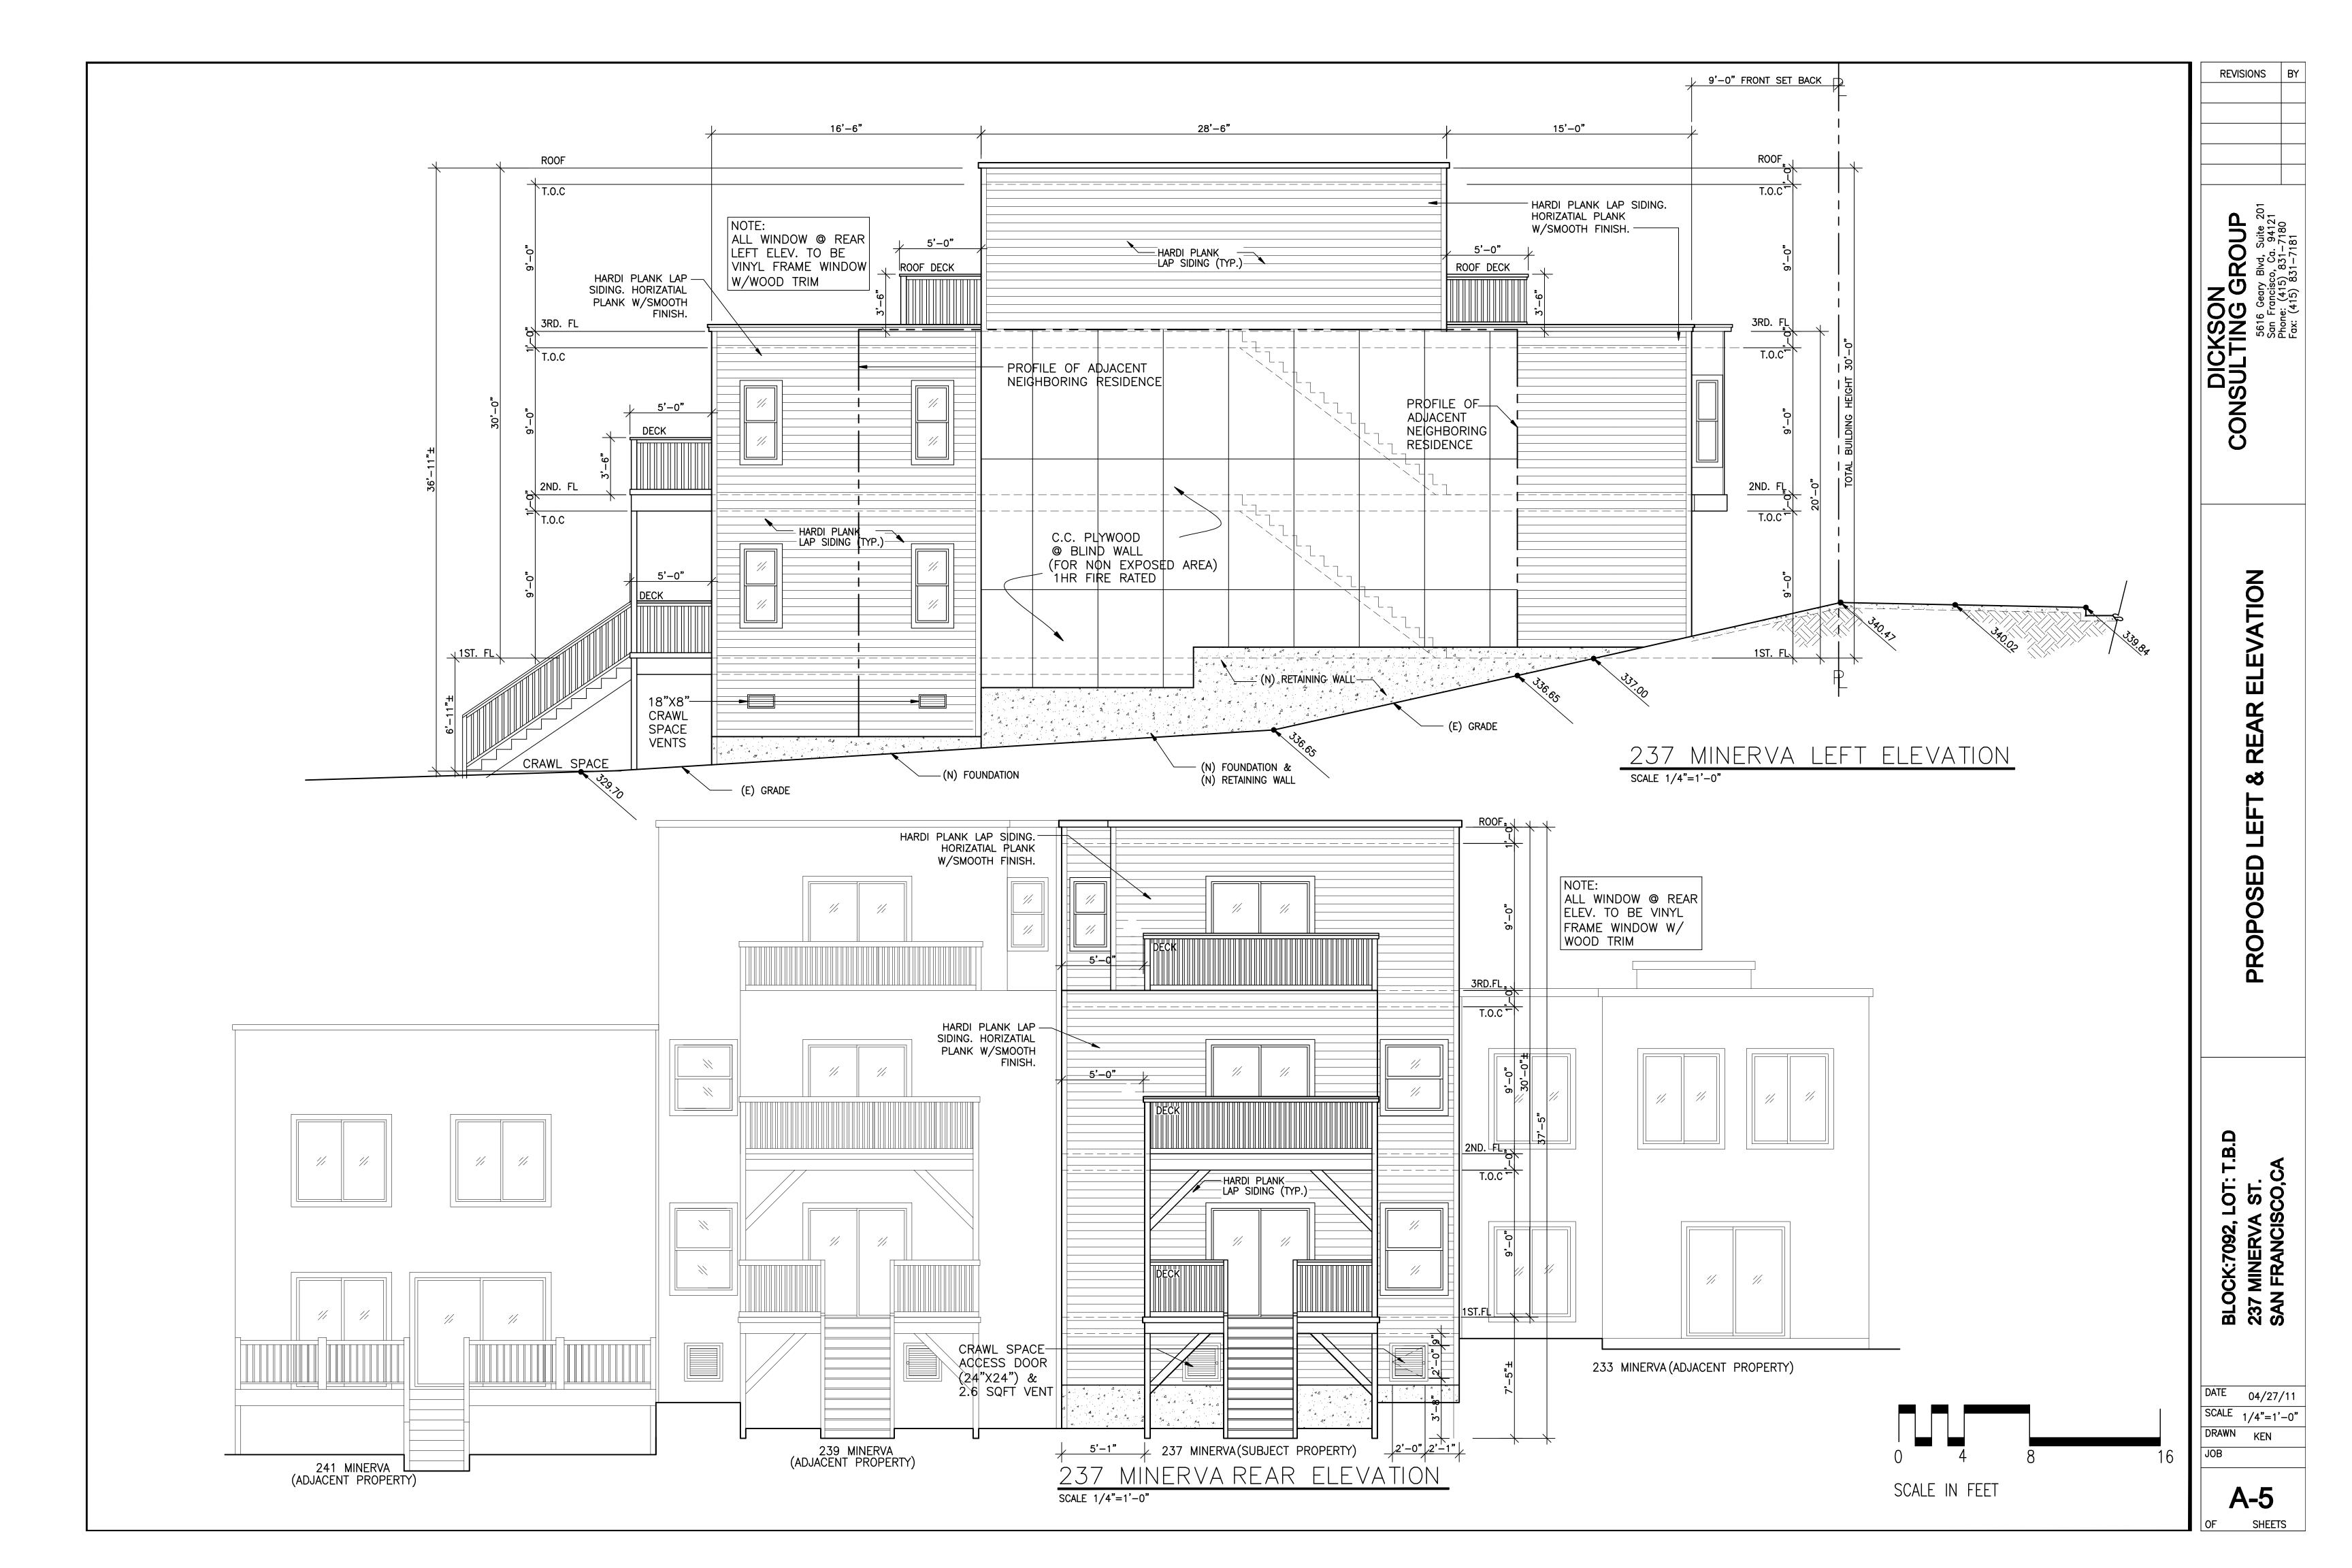**ELECTRICAL LEGEND:** 

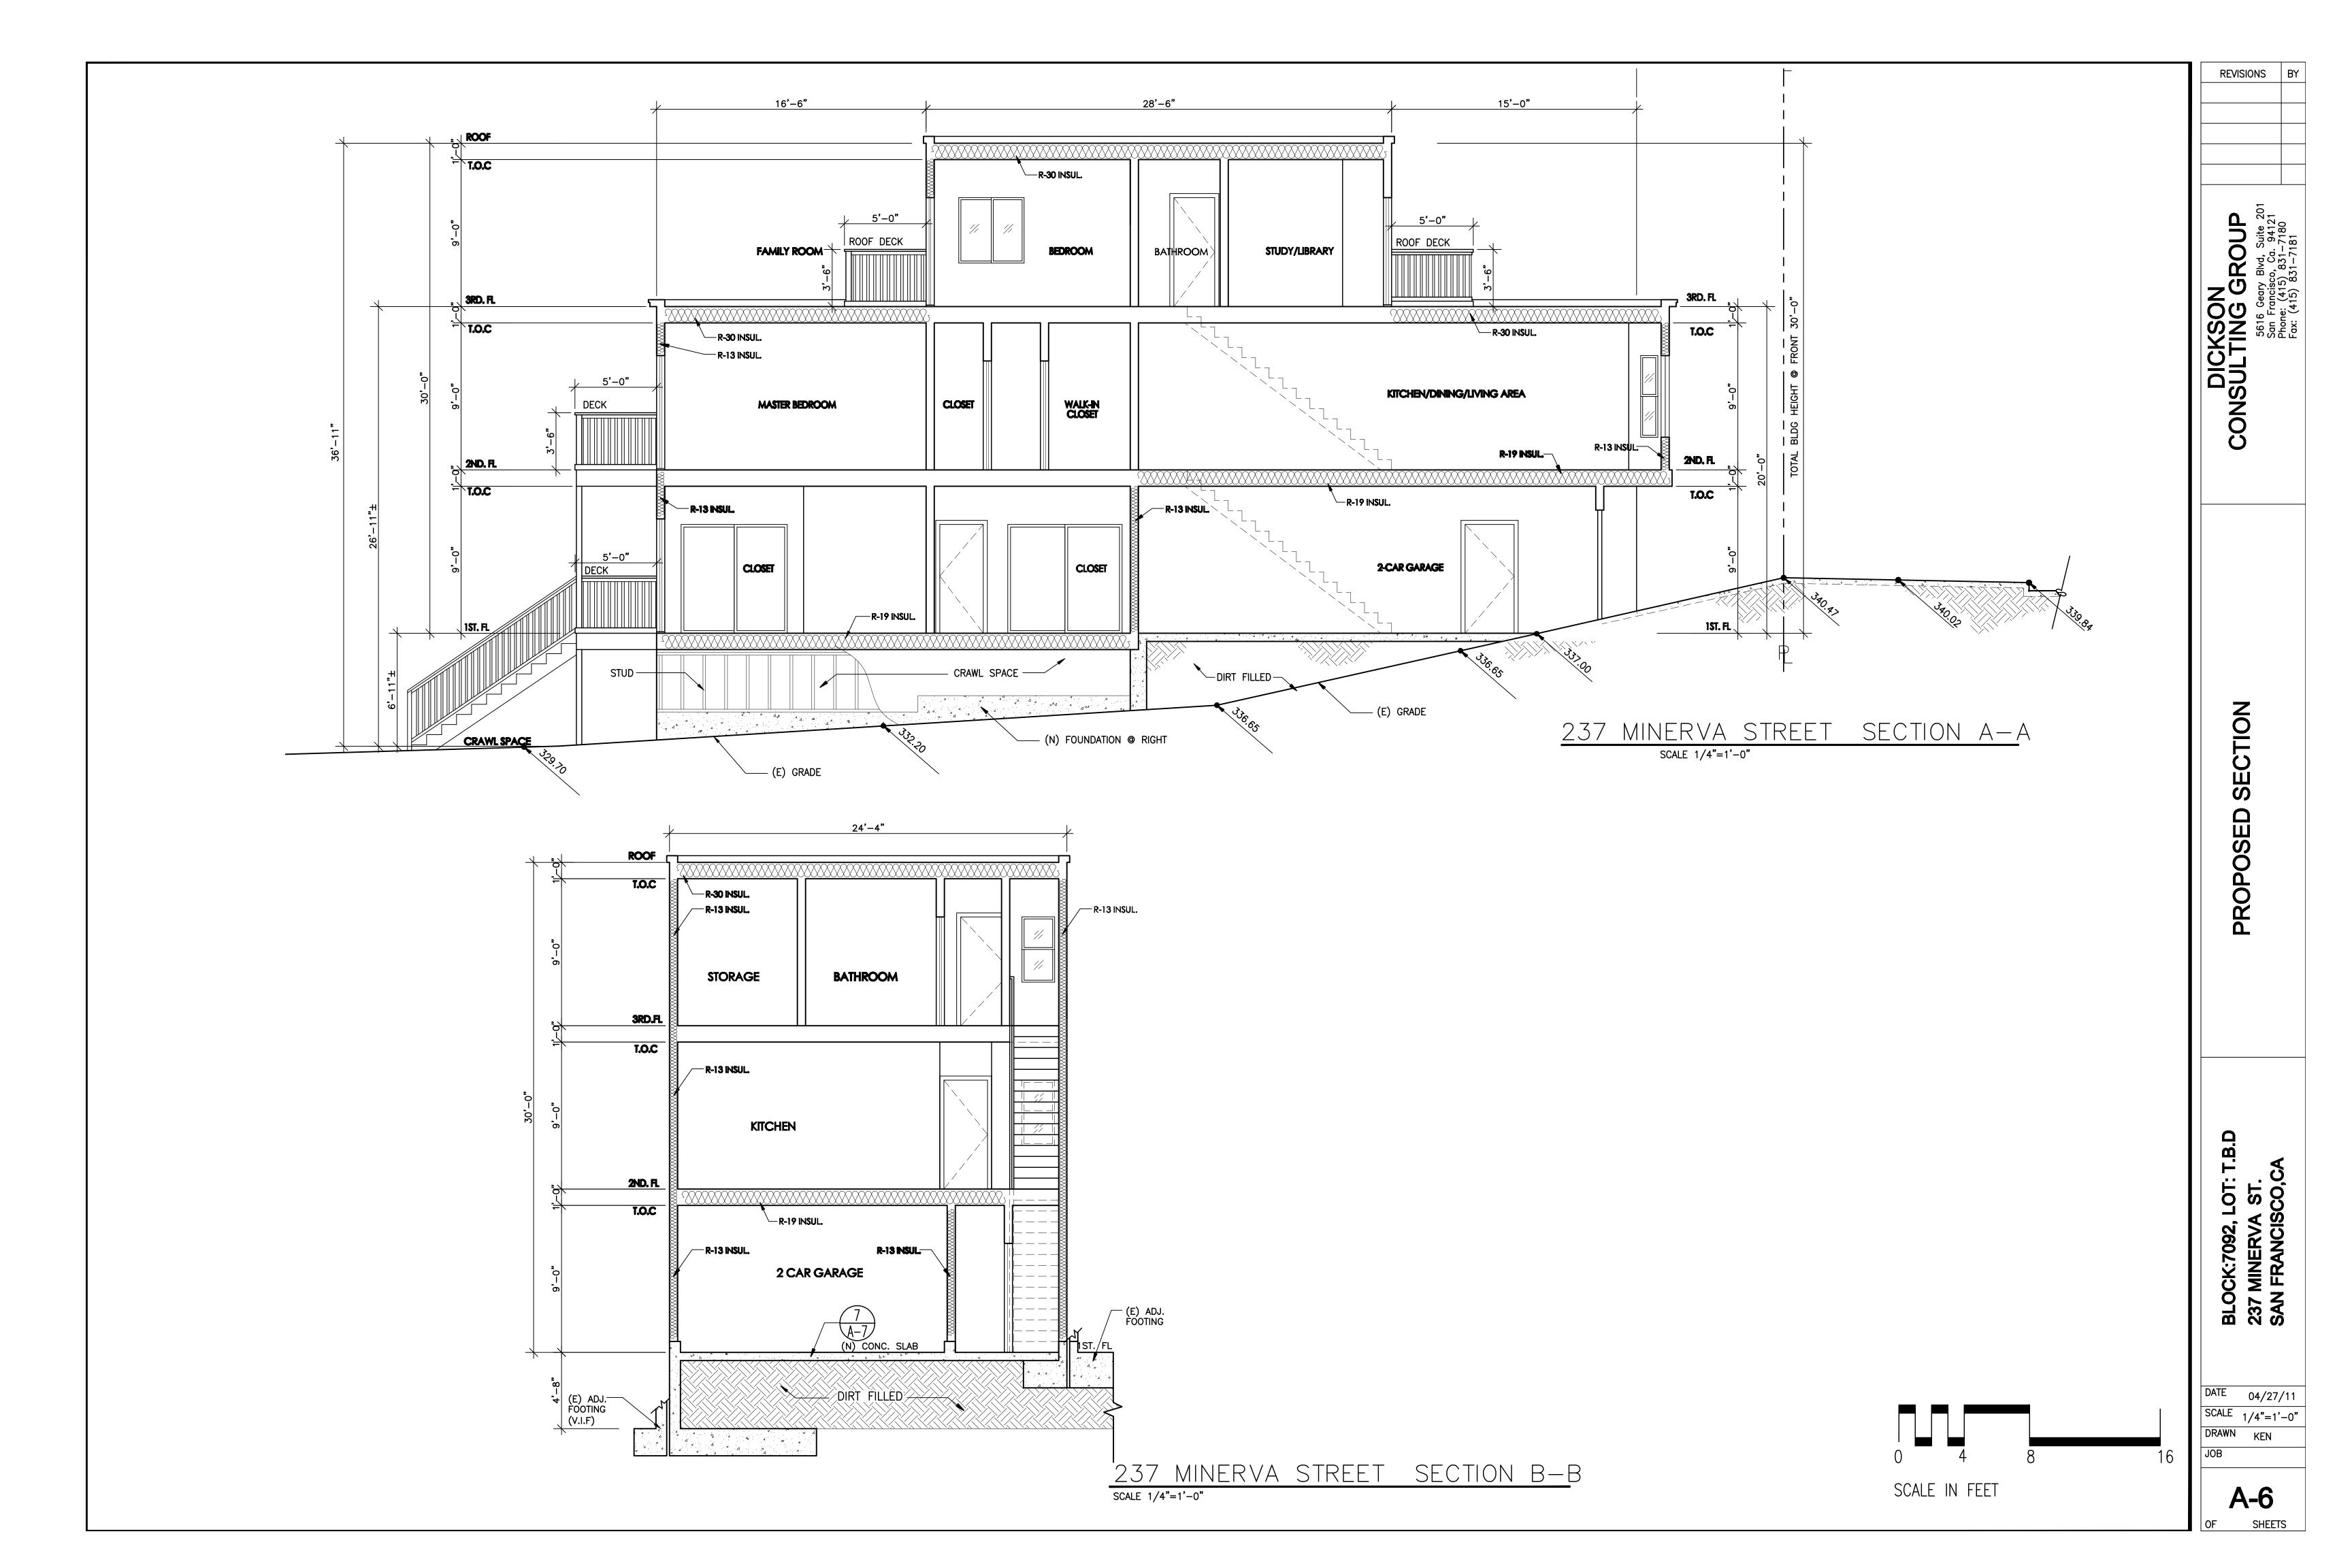Wall Duplex 110V

Wall Outlet 220V

Wall Duplex 110V

Exhaust Fan

**Exhaust Fan** 

w/ Ground Fault Circuit Interrupter

W/ Compact Fluorescent Light

**Ceiling Lighting Outlet** 

Ceiling Lighting Outlet w/ Motion Sensor

**Ceiling Lighting Outlet** 

**Ceiling Lighting Outlet** 

**Drop Cord / Pendent** 

Recess Lighting Outlet

**Wall Lighting Outlet** 

Wall Lighting Outlet

Fluorescent (Wall Mount)

Fluorescent (Ceiling Mount)

Single Pole Switch / Dimmer

w/ Motion Sensor

Single Pole Switch

**Three Way Switch** 

**Smoke Detector** 

w/ Weather Proof & Motion Sensor

w/ Weather Proof

SYMBOLS

 $\Rightarrow$ 

 $\Longrightarrow$ 

**⊕** GFCI

FLUR.

-(M)

-(-)-

-(R)

M

2ND FLOOR PLAN & 3RD FLOOR PLAN PROPOSED FRONT & RIGHT ELEVATIONS A-4:


PROPOSED LEFT & REAR ELEVATION A - 5:

A - 6: SECTION A-A , B-B

# PROJECT DATA JOB ADDRESS: \_\_\_\_\_ -239 MINERVA SAN FRANCISCO,CA BLOCK: **- 7092** ZONING: TYPE OF CONSTRUCTION: V-B OCCUPANCY: — R-3

# SCOPE OF WORK

REVISION FOR THE APPROVED PLAN #2006/0124/2864 S1/R1 TO REVISE FRONT SETBACK OF THE BUILDING.

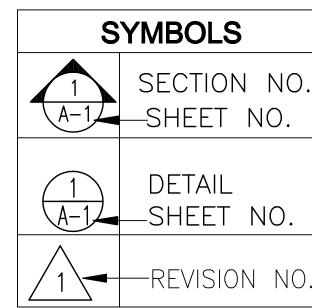

SECTION NO.

REVISIONS

DICKSON VSULTING GROUP 5616 Geary Blvd, Suite 201 San Francisco, Ca. 94121 San Francisco, Ca. 94121 San Francisco, Ca. 94121 San Francisco, Ca. 94121


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BLOCK:7092, LOT: 1 239 MINERVA ST. SAN FRANCISCO,C/

DATE 04/27/11 SCALE AS SHOWN KEN JOB

**A-1** 

SHEETS

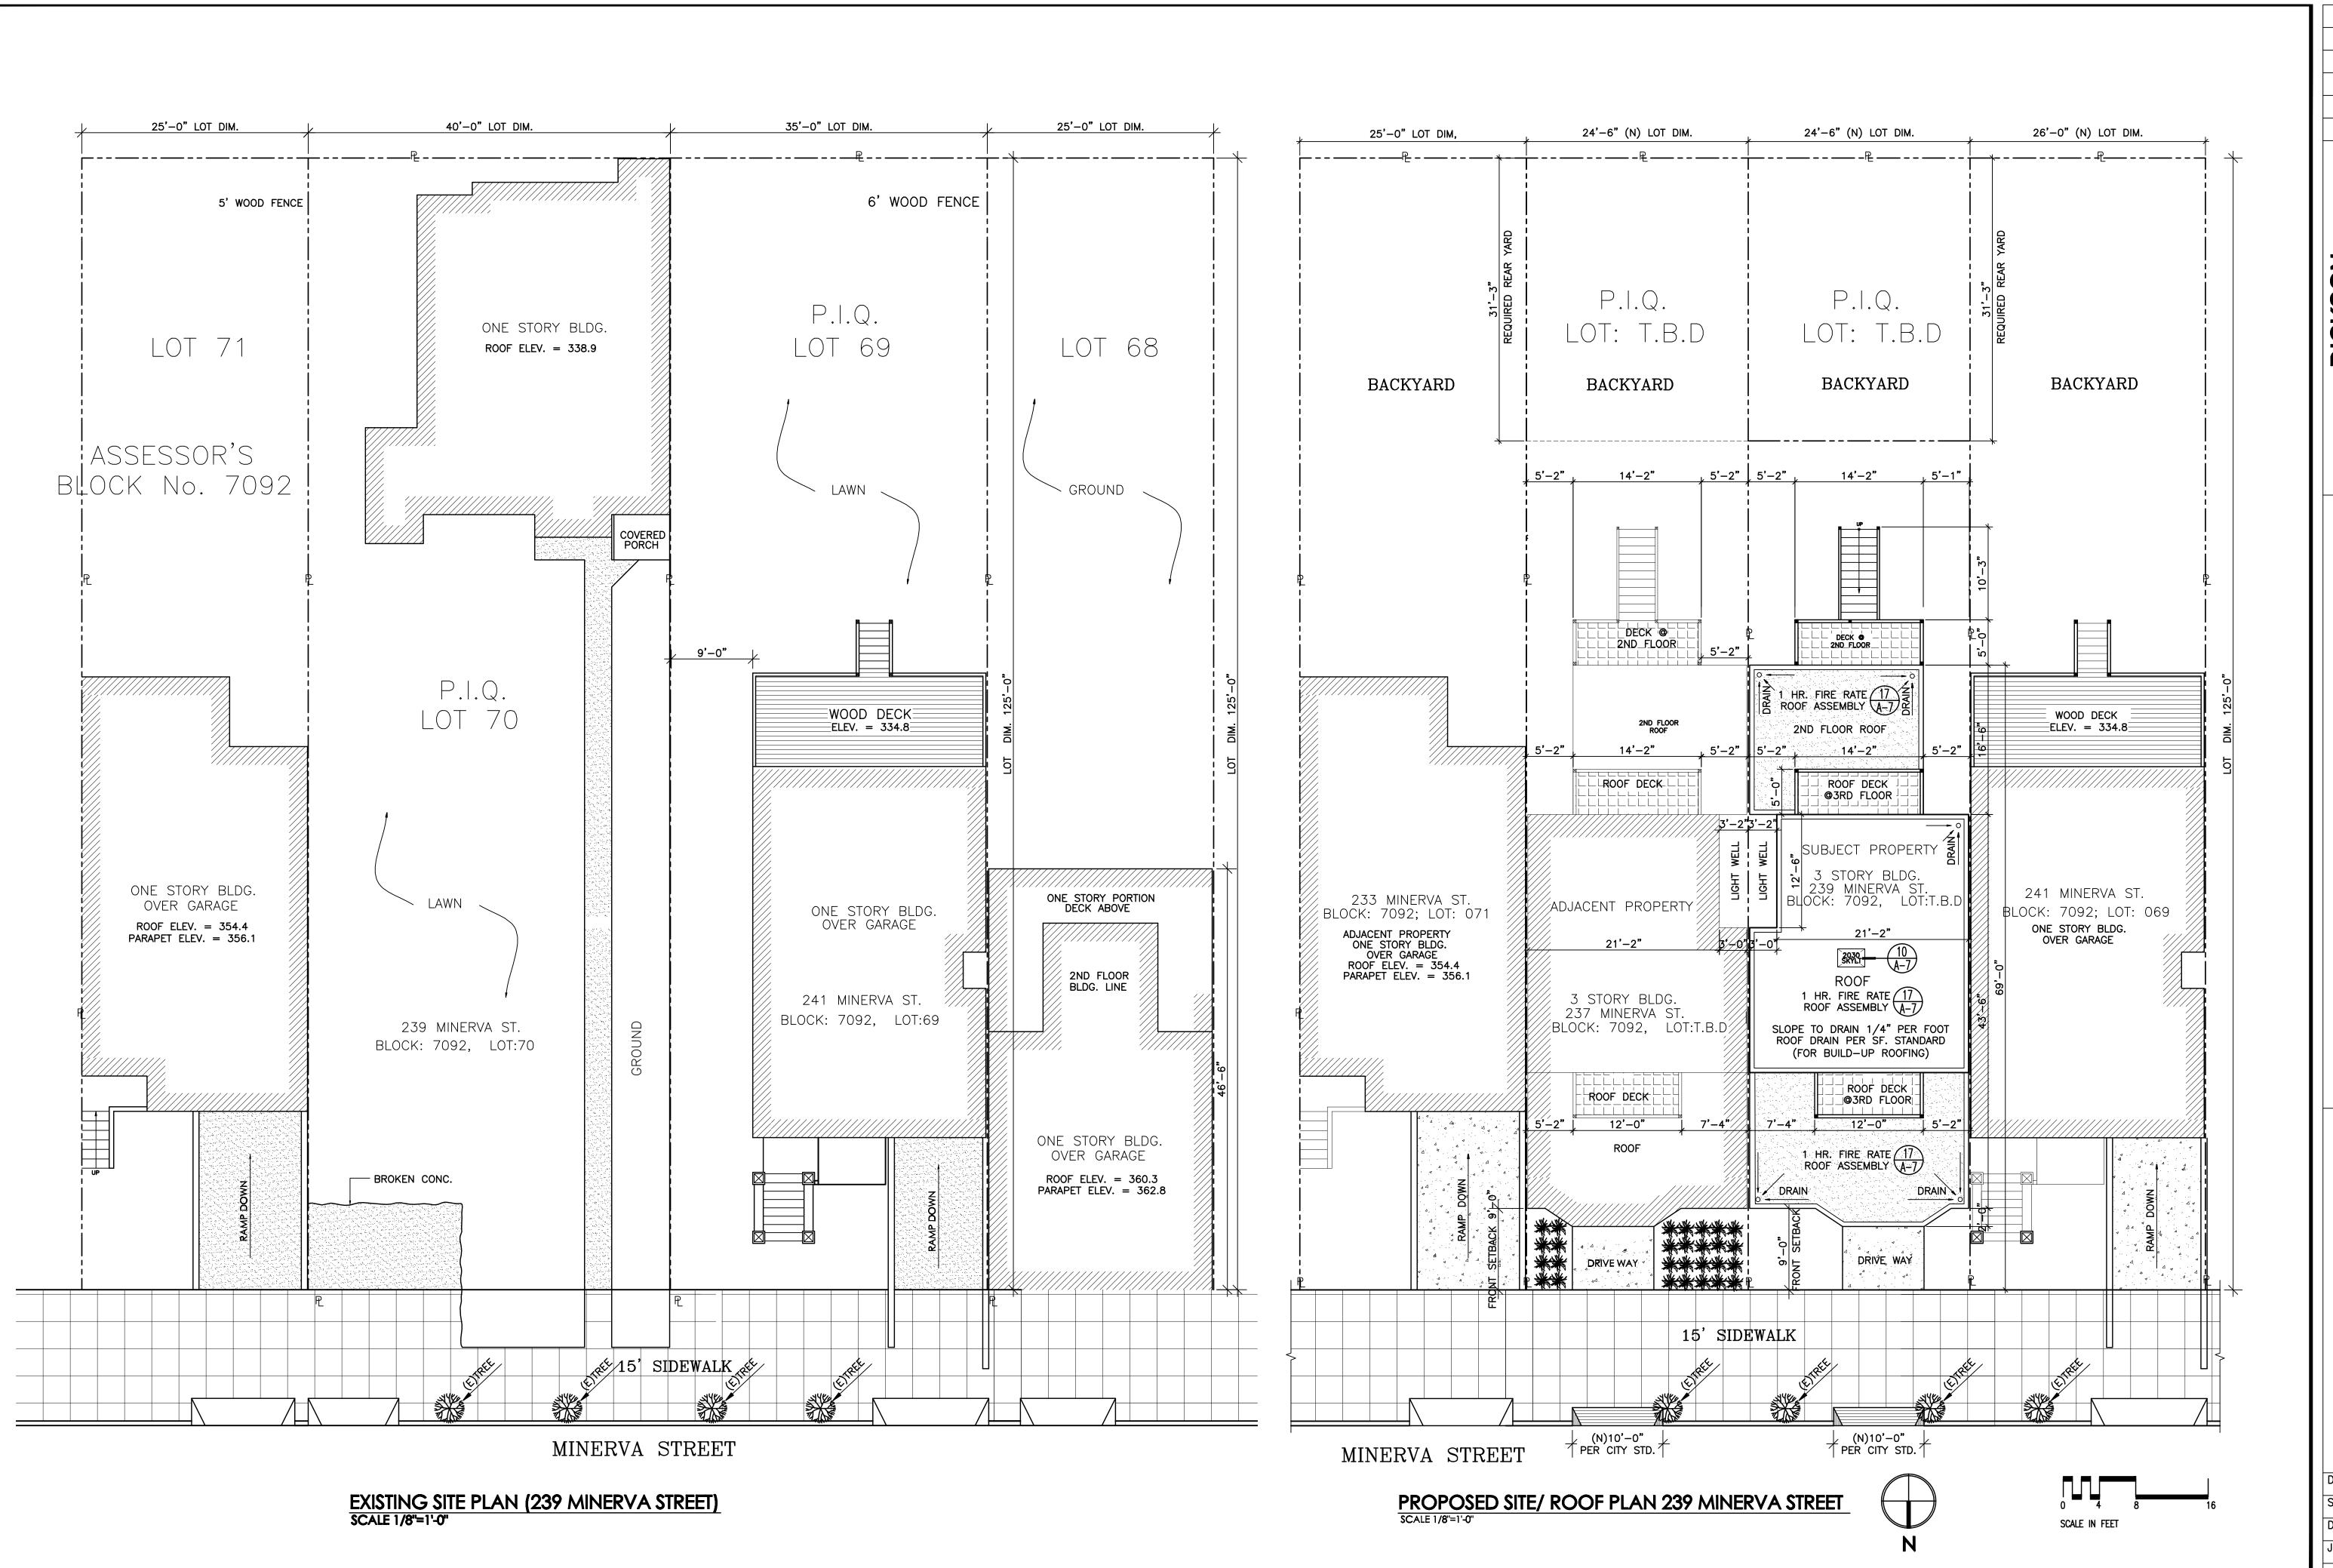

DICKSON CONSULTING GROUP

**REVISIONS** 

ROOF SITE O PROP( **∞ EXISTING** 

BLOCK:7092, LOT: T.B.D 239 MINERVA ST. SAN FRANCISCO,CA


04/27/11 SCALE AS SHOWN DRAWN KEN

A-2.1 SHEETS


**REVISIONS** 

A-2.2


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SCALE IN FEET

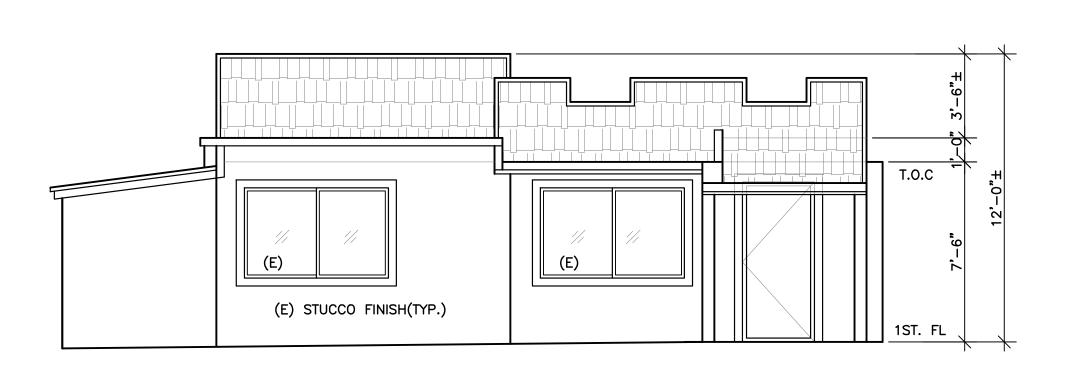

# EXISTING FRONT ELEVATION (NORTH) SCALE:1/4"=1'-0"

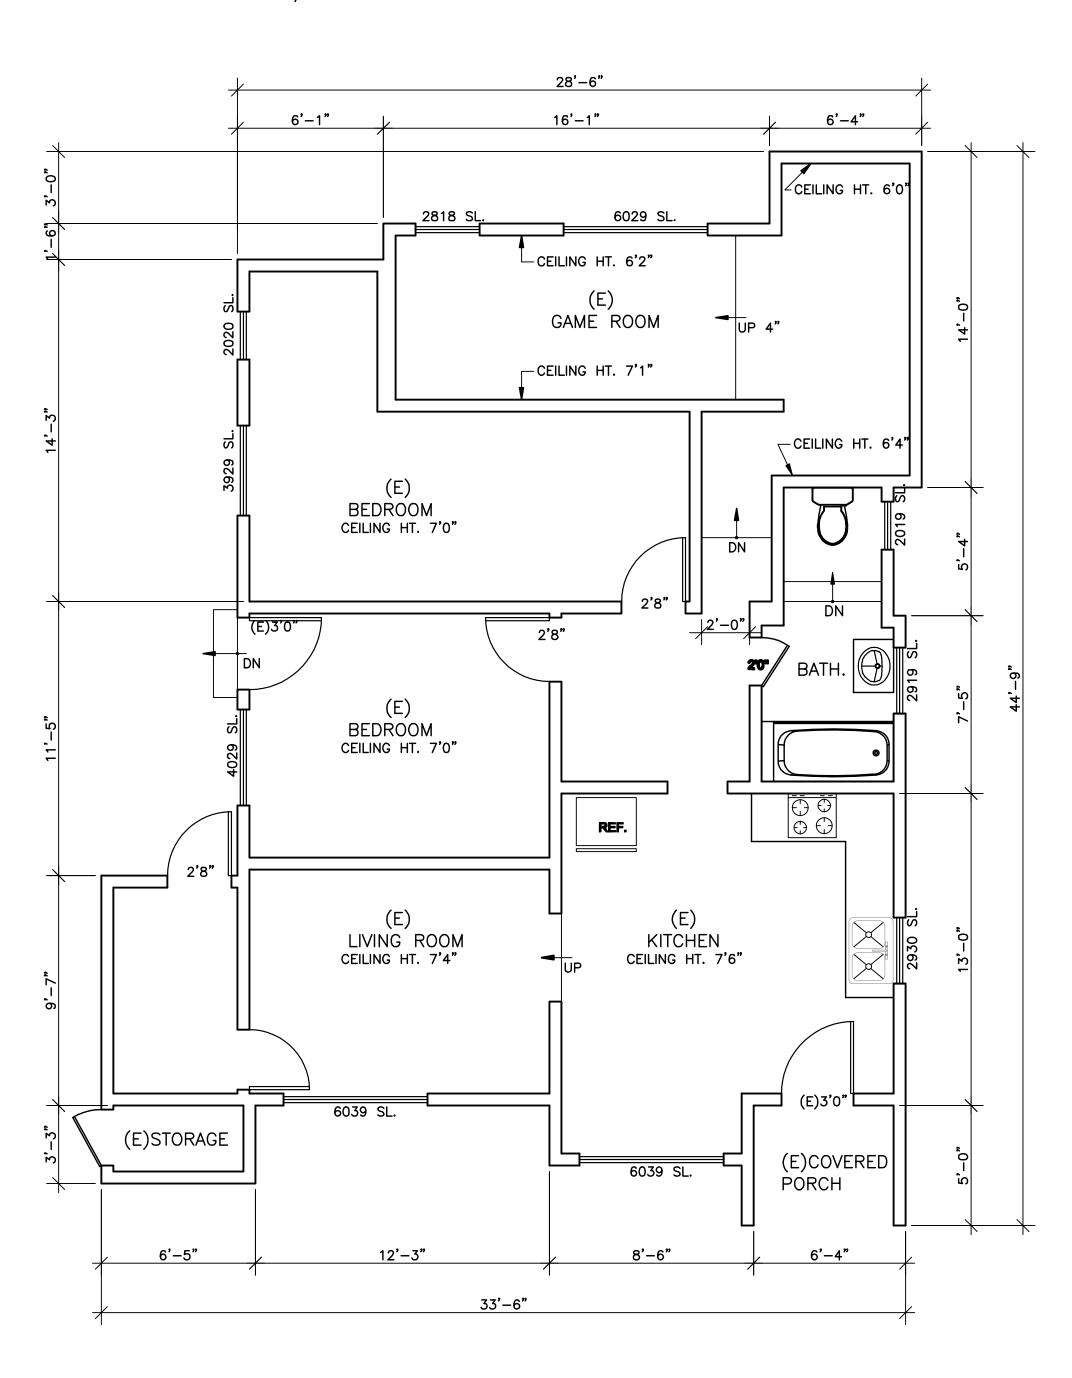

EXISTING FLOOR PLAN (239 MINERVA ST.)
SCALE 1/4"=1'-0"

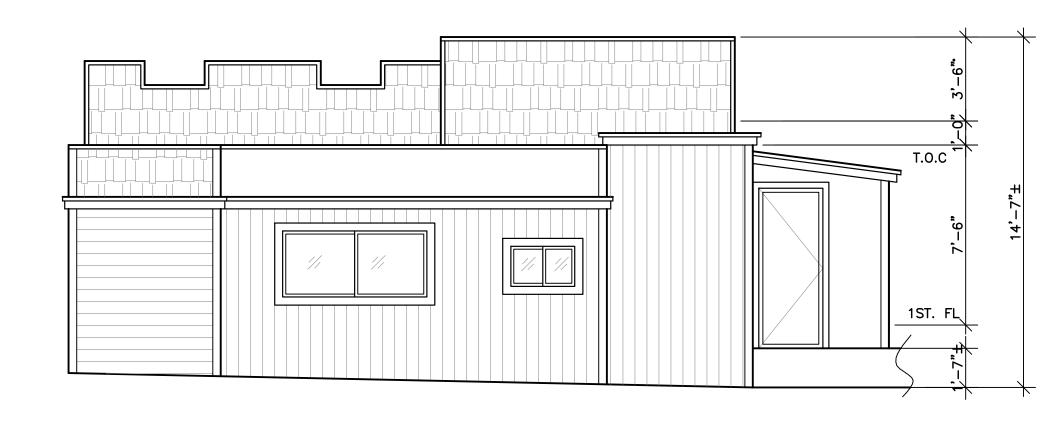

EXISTING REAR ELEVATION (SOUTH)


SCALE: 1/4"=1'-0"



PROPOSED LEFT ELEVATION (EAST)
SCALE:1/4"=1'-0"



EXISTING RIGHT ELEVATION (WEST)
SCALE:1/4"=1'-0"

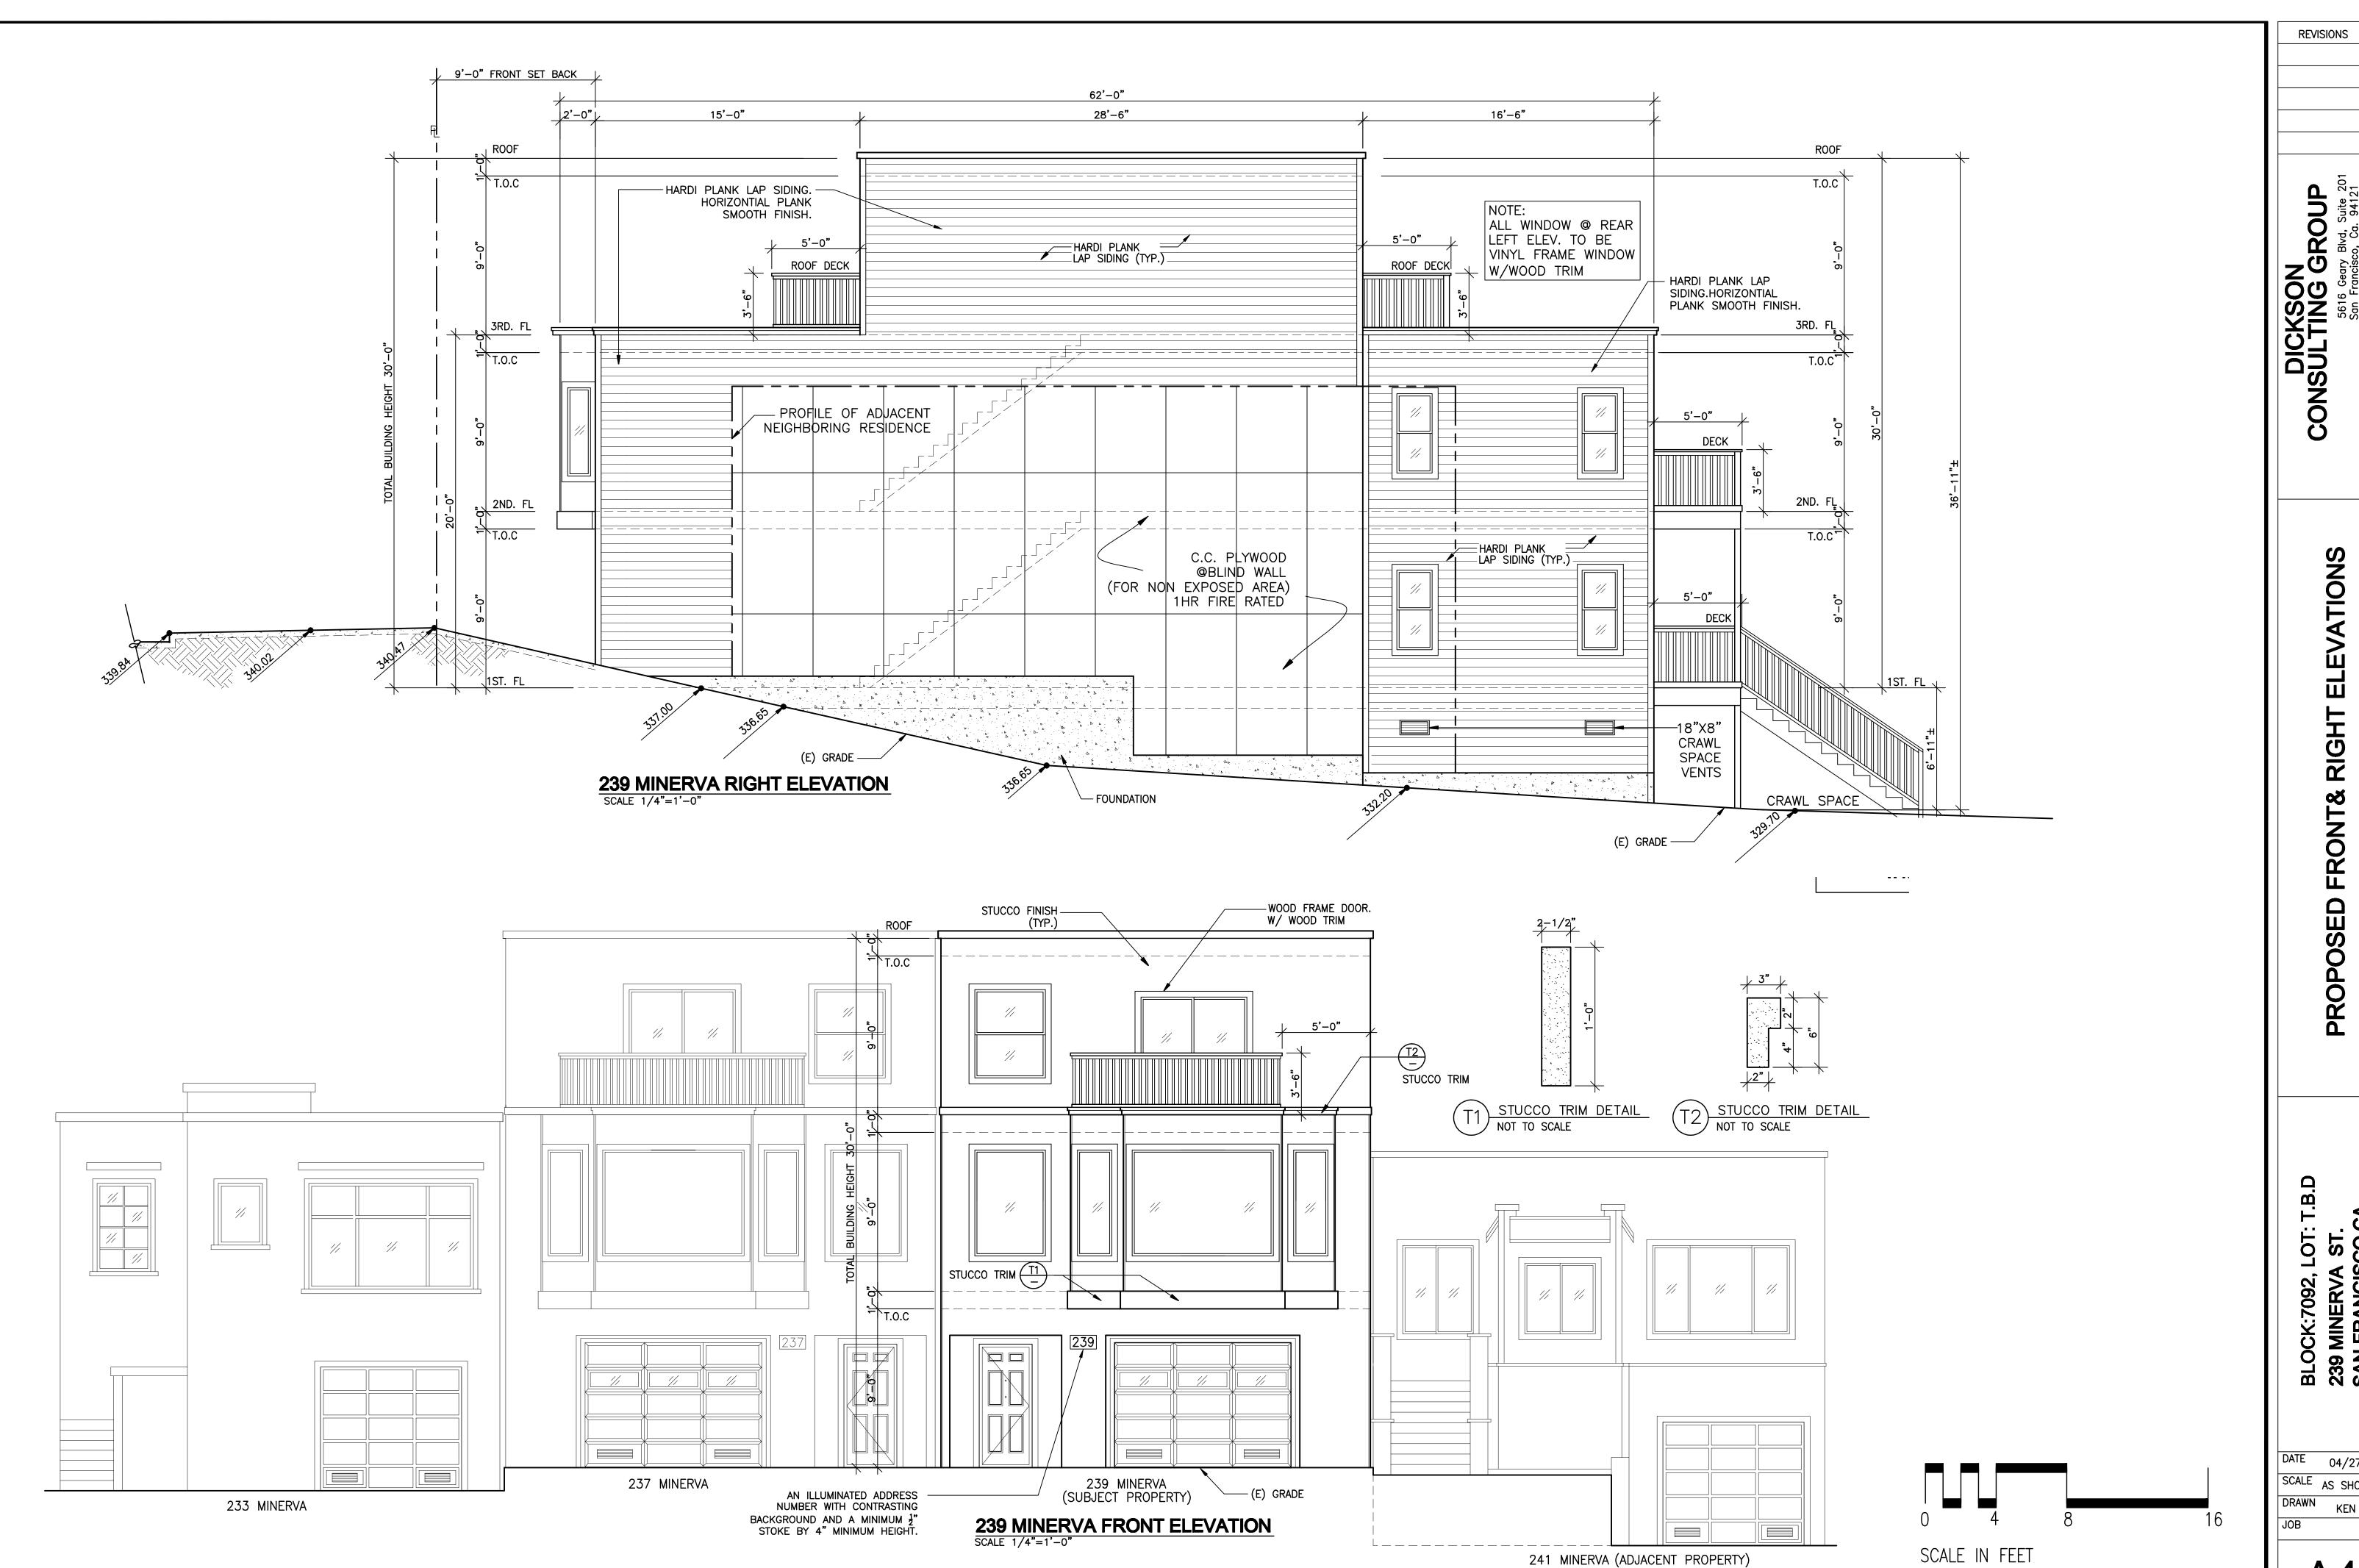


DICKSON
CONSULTING GROUP


5616 Geary Blvd, Suite 201

**ELEVATIONS RIGHT** PROPOSED FRONT

DATE 04/27/11 SCALE AS SHOWN KEN

**A-4** SHEETS

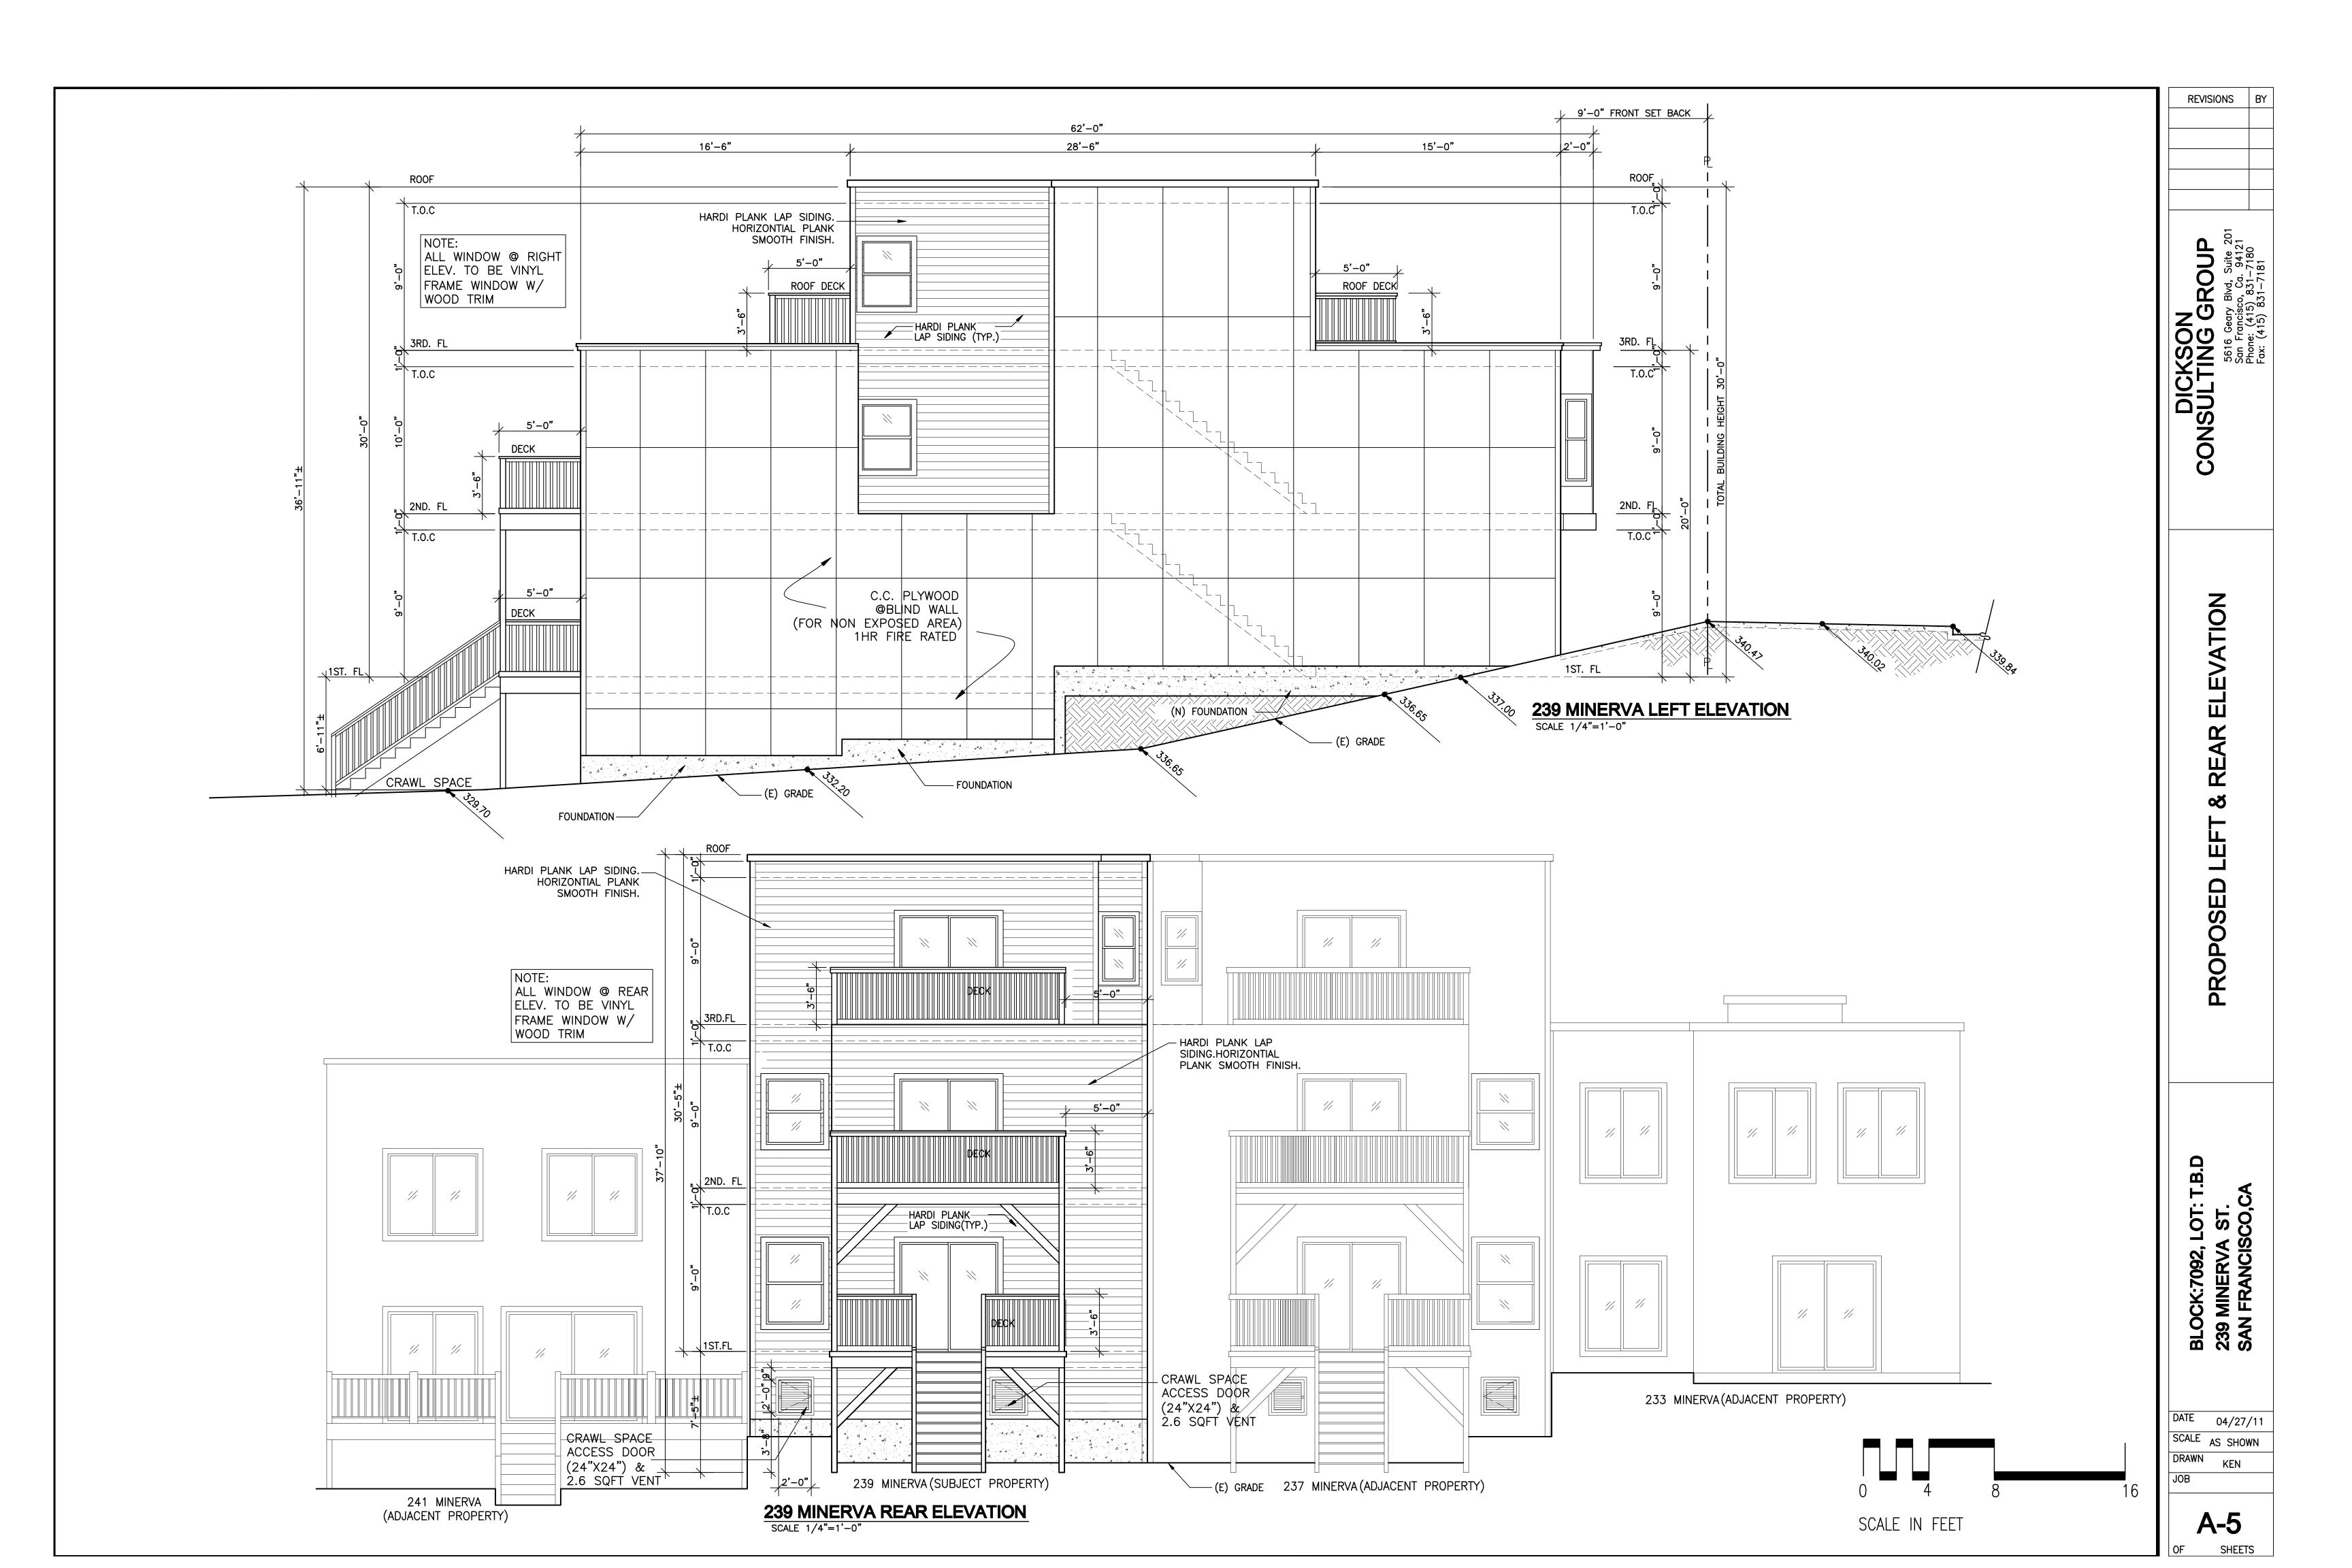

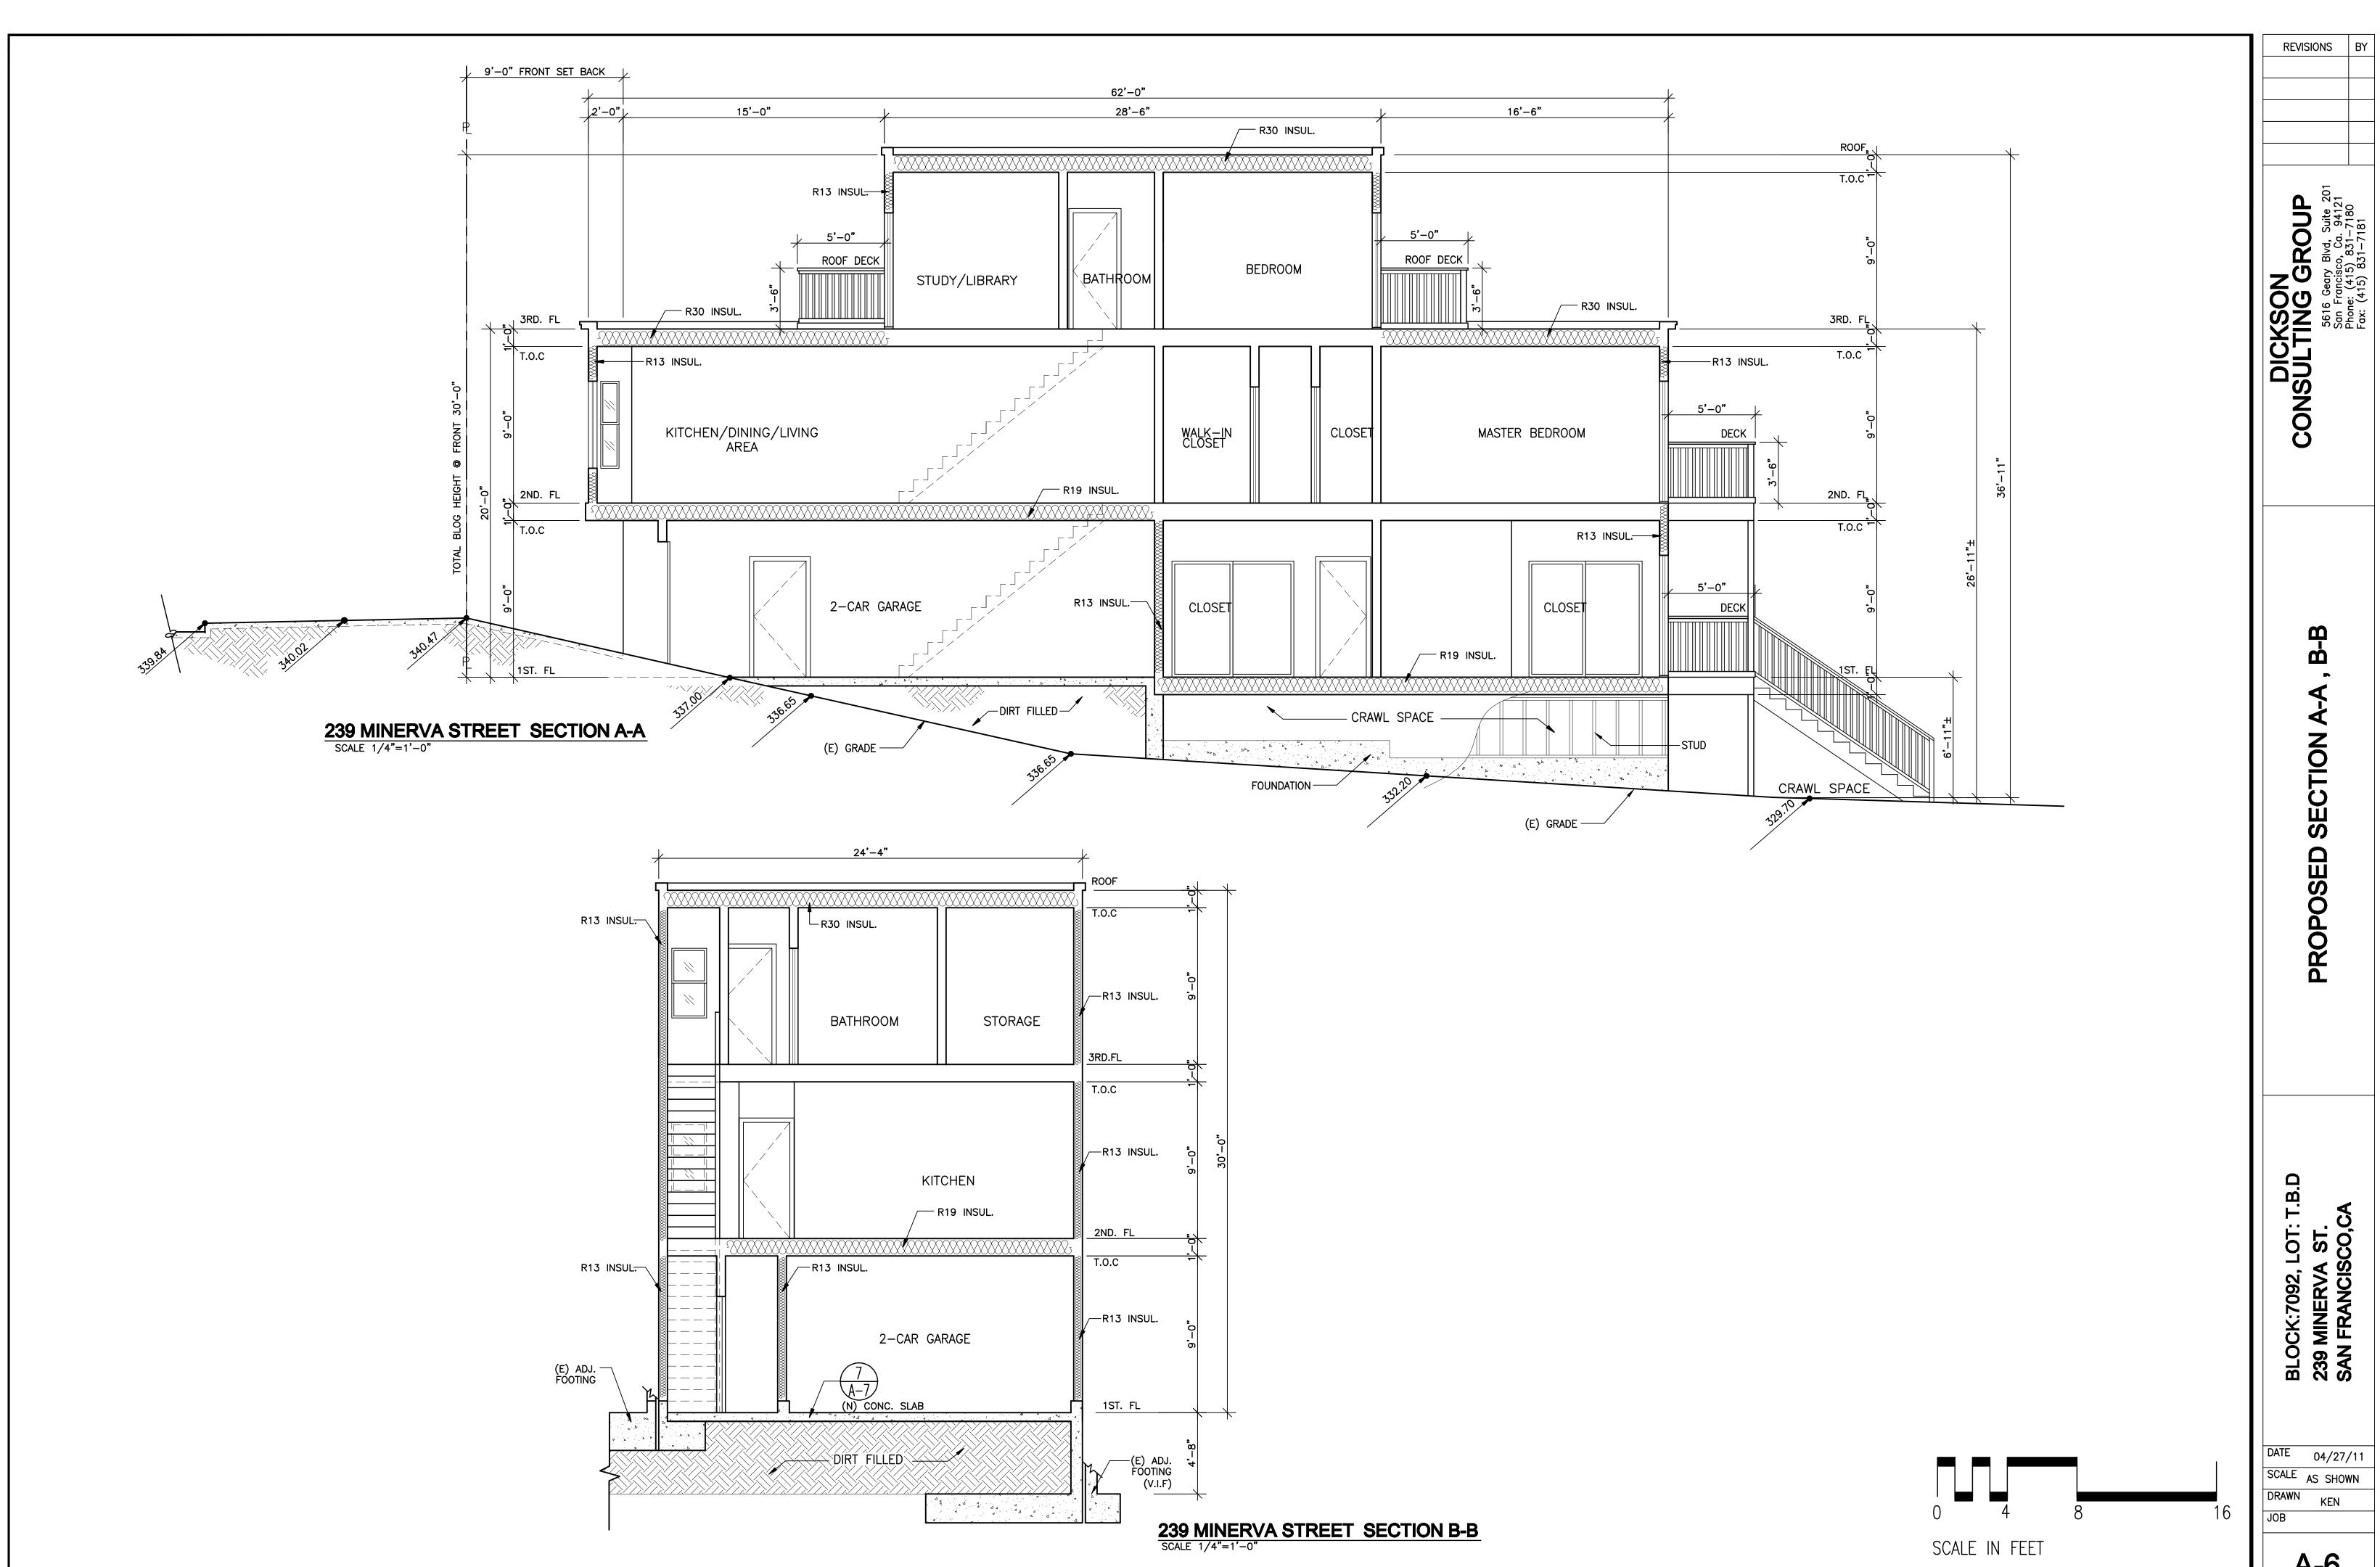

A-6