MEMO

Disclaimer for Review of Plans

The San Francisco Planning Code requires that the plans of certain proposed projects be provided to members of the public prior to the City's approval action on the project. Accordingly, any images of plans featured on this website are provided for the primary purpose of facilitating public input prior to the City's action. The City and County of San Francisco does not own the copyright to these images. Please be aware that the unauthorized reproduction, distribution, or alteration of these images may result in a violation of Federal Copyright Law (17 U.S.C.A. Sections 101 et seq.) and that any party who seeks to reproduce or alter these images does so at his or her own risk.

Additionally, plans provided on this website are limited to site plans, elevations and/or section details (floor plans and structural details may not be included). These are DRAFT PLANS being provided for public review PRIOR to the City's approval action on the project. Final plans may differ from those that are currently available for review.

1650 Mission St. Suite 400 San Francisco, CA 94103-2479

Reception: 415.558.6378

Fax: 415.558.6409

Planning Information: 415.558.6377 1650 Mission Street, Suite 400 • San Francisco, CA 94103 • Fax (415) 558-6409

NOTICE OF PUBLIC HEARING

Hearing Date: Wednesday, May 25, 2011

Time: **Beginning at 9:30 AM**

Location: City Hall, 1 Dr. Carlton B. Goodlett Place, Room 408

Case Type: Variance (Parking)
Hearing Body: Zoning Administrator

PROPERTY INFORMATION		APPLICATION INFORMATION	
Project Address:	352 Richland Avenue	Case No.: Building Permit: Applicant/Agent: Telephone: E-Mail:	2010.1133V
Cross Street(s):	Murray and Andover Sts.		2010.0830.9852
Block /Lot No.:	5744/062		Marc Ojanen
Zoning District(s):	RH-2 / 40-X		(415) 398-3002
Area Plan:	Bernal Heights SUD		mojanen@ocarch.net

PROJECT DESCRIPTION

The proposal is to construct a two-story rear addition on to the existing single-family dwelling. The existing building encroaches into the required rear yard; however, the proposal will not encroach into the rear yard.

PLANNING CODE SECTION 242(e)(4) sets forth parking requirements for the Bernal Heights SUD. Three off-street parking spaces are required for construction with usable floor area between 2,251 to 2,850 square feet. The total usable floor area proposed with the addition would be approximately 2,373 square feet. One space currently exists and no additional parking will be provided; therefore, a Variance is required.

PER PLANNING CODE SECTION 188, a non-complying structure may not intensify or increase in discrepancy at any level. The existing building is a non-complying structure in terms of rear yard and parking. The proposed addition enlarges the existing non-complying building envelope; therefore, a Variance is required.

ADDITIONAL INFORMATION

FOR MORE INFORMATION, PLEASE CONTACT PLANNING DEPARTMENT STAFF:

Planner: Ben Fu Telephone: (415) 558-6613 E-Mail: ben.fu@sfgov.org

ARCHITECTURAL PLANS: The site plan and elevations of the proposed project are available on the Planning Department's website at: http://sf-planning.org/ftp/files/notice/2010.1133V.pdf

中文詢問請電: 415.558.5956

Para información en Español llamar al: 415.558.5952

GENERAL INFORMATION ABOUT PROCEDURES

VARIANCE HEARING INFORMATION

Under Planning Code Section 306.3, you, as a property owner or resident within 300 feet of this proposed project or interested party on record with the Planning Department, are being notified of this Variance Hearing. You are not obligated to take any action. For more information regarding the proposed work, or to express concerns about the project, please contact the Applicant/Agent or Planner listed on this notice as soon as possible. Additionally, you may wish to discuss the project with your neighbors and neighborhood association or improvement club, as they may already be aware of the project.

Persons who are unable to attend the public hearing may submit written comments regarding this application to the Zoning Administrator, Planning Department, 1650 Mission Street, Suite 400, San Francisco, CA 94103, by 5:00pm the day prior to the hearing. These comments will be made a part of the official public record, and will be brought to the attention of the person or persons conducting the public meeting or hearing.

BUILDING PERMIT APPLICATION INFORMATION

Under Planning Code Section 311/312, the Building Permit Application for this proposal is also subject to a 30-day notification to occupants and owners within 150-feet of the subject property. **The mailing of such notification will be performed separately.**

BOARD OF APPEALS

An appeal of the approval (or denial) of a **variance application** by the Zoning Administrator may be made to the **Board of Appeals within 10 days** after the **Variance Decision Letter** is issued by the Zoning Administrator.

An appeal of the approval (or denial) of a **building permit application** by the Planning Department may be made to the **Board of Appeals within 15 days** after the **building permit** is issued (or denied) by the Director of the Department of Building Inspection.

Appeals must be submitted in person at the **Board's office at 1650 Mission Street**, **3rd Floor**, **Room 304**. For further information about appeals to the Board of Appeals, including current fees, **contact the Board of Appeals** at **(415) 575-6880**.

ABOUT THIS NOTICE

The Planning Department is currently reviewing its processes and procedures for public notification as part of the Universal Planning Notification (UPN) Project. The format of this Public Hearing notice was developed through the UPN Project and is currently being utilized in a limited trial-run for notification of Variance Hearings.

If you have any comments or questions related to the UPN Project or the format of this notice, please visit our website at http://upn.sfplanning.org for more information.

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2. CONTRACTOR SHALL BE RESPONSIBLE FOR THE DEVELOPMENT, COORDINATION AND EXECUTION OF CONSTRUCTION METHODS AND PROCEDURES. THE CONTRACTOR SHALL ALSO BE RESPONSIBLE FOR INITIATING, MAINTAINING AND SUPERVISING ALL SAFETY PRECAUTIONS AND PROGRAMS IN CONNECTION WITH THE WORK.

3. NO GUARANTEE FOR QUALITY OF CONSTRUCTION IS IMPLIED OR INTENDED BY THE ARCHITECTURAL DOCUMENTS, AND THE CONTRACTOR SHALL ASSUME FULL RESPONSIBILITY FOR ANY AND ALL CONSTRUCTION DEFICIENCIES.

4. IN CASE OF ANY DISCREPANCY, NOTIFY THE OWNER BEFORE PROCEEDING. CONTRACTOR SHALL BE RESPONSIBLE FOR CORRECTION OF WORK, AT HIS/HER EXPENSE, INSTALLED IN CONFLICT WITH THE CONTRACT DOCUMENTS.

5. NO DIMENSIONS SHALL BE TAKEN BY MEASURING FROM THE DRAWINGS. DETAILS TAKE PRECEDENCE OVER GENERAL PLANS, SECTIONS, ELEVATIONS, ETC. WRITTEN DIMENSIONS TAKE PRECEDENCE OVER SCALE. ALL DIMENSIONS SHALL BE VERIFIED IN THE FIELD FOR COORDINATION WITH EXISTING AND NEW CONDITIONS.

6. DURING DEMOLITION, PROTECT ALL AREAS, PRODUCTS, AND FINISHES FROM DAMAGE FROM CONSTRUCTION OPERATIONS, WEATHER, AND THEFT. REMOVE ALL WALLS, STRUCTURAL ELEMENTS, FINISHES, PAVING, AND UTILITIES AS INDICATED ON THE DRAWINGS AS REQUIRED FOR NEW CONSTRUCTION. REMOVE ONLY THOSE ELEMENTS NECESSARY FOR COMPLETION OF PROJECT. REPLACE OR REPAIR ELEMENTS UNNECESSARILY REMOVED OR DAMAGED DURING CONSTRUCTION REMOVE MATERIALS FROM SITE AND DISPOSE OF IN ACCORDANCE WITH APPLICABLE CODES.

7. ASBESTOS REMOVAL IS NOT INTENDED TO BE COVERED BY THIS CONTRACT. IF ASBESTOS IS SUSPECTED, A TESTING AGENCY MUST BE HIRED TO VERIFY, AND SPECIAL PROCEDURES MUST BE USED FOR REMOVAL AND DISPOSAL. FRIABLE ASBESTOS IS THE DANGEROUS TYPE AND WAS USED EXTENSIVELY FOR PIPE INSULATION, FIREPROOFING AND CERTAIN BUILDING MATERIALS UP TO 1970.

8. CUT AND FIT COMPONENTS AS REQUIRED. PATCH DISTURBED AREAS TO MATCH ADJACENT MATERIALS AND FINISHES.

9. ALL PLUMBING. MECHANICAL AND ELECTRICAL WORK IS DESIGN/BUILD BY THE PLUMBING AND ELECTRICAL CONTRACTORS AND IS TO MEET REQUIRED TITLE 24 REQUIREMENTS.


10. WATERPROOFING IS NOT INCLUDED IN THE CURRENT SCOPE OF WORK AND IS THE SOLE RESPONSIBILITY OF THE CONTRACTOR.

ABBREVIATIONS

E (E) EXT. FL. FIN. FLUOR GYP. BD. H, HT	ABOVE ALUMINUM AT BOTTOM OF CABINET CLEAR CENTERLINE DIAMETER DIMENSION(S) DOWN DETAIL CEILING EAST EXISTING EXTERIOR FLOOR FINISH FLUORESCENT (LIGHT) GYPSUM BOARD HEIGHT	MTL. N (N) OPNG. ORG (P) PT PTD. R R.O. S.C.D. SF SIM. S.S.D. STL. T&G T.O.	METAL NORTH NEW OPENING ORGANICS PROPOSED PRESSURE TREATED PAINTED RECYCLING ROUGH OPENING SOUTH SOLID CORE SEE CIVIL DRAWINGS SQUARE FOOT SIMILAR SEE STRUCTURAL DRAWINGS STAINLESS STEEL TONGUE AND GROOVE TOP OF
DIM(S) DN DTL. CLNG. E (E) EXT. FL. FIN. FLUOR GYP. BD.	DIMENSION(S) DOWN DETAIL CEILING EAST EXISTING EXTERIOR FLOOR FINISH FLUORESCENT (LIGHT) GYPSUM BOARD HEIGHT HOLLOW CORE INTERIOR NOT IN CONTRACT	R R.O. S.C. S.C.D. SF SIM. S.S.D. ST. STL. T&G T.O.	RECYCLING ROUGH OPENING SOUTH SOLID CORE SEE CIVIL DRAWINGS SQUARE FOOT SIMILAR SEE STRUCTURAL DRAWINGS STAINLESS STEEL TONGUE AND GROOVE TOP OF TRASH TYPICAL UNLESS OTHERWISE NOTED WEST

LEGEND

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FLOOR ELEVATION

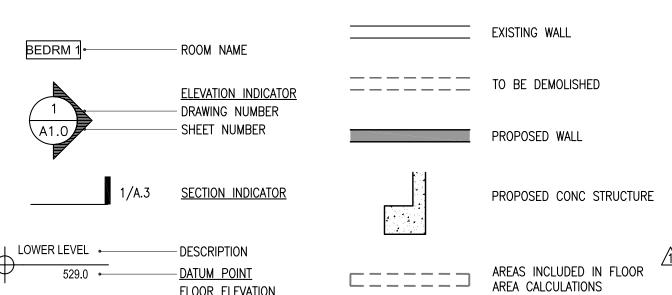SCOPE OF WORK

1. RECONFIGURE EXISTING FRONT ENTRY PORCH, BEDROOM AND LIVING ROOM AT GROUND FLOOR INTO ENCLOSED MUDROOM (FRONT YARD EXTENSION), ENLARGED FOYER AND 2 BEDROOMS 2. ENLARGE KITCHEN/DINING AREA WITH EXTENSION INTO REAR YARD
3. CONVERT ATTIC INTO HABITABLE SPACE
4. ADD CONNECTING STAIR TO ATTIC AND BASEMENT

CODE ANALYSIS

CURRENT SAN FRANCISCO PLANNING CODE 2007 CALIFORNIA BUILDING CODE, 2007 SAN FRANCISCO BUILDING CODE 2007 CALIFORNIA MECHANICAL CODE WITH AMENDMENTS 2007 CALIFORNIA PLUMBING CODE WITH AMENDMENTS 2007 NATIONAL ELECTRIC CODE WITH AMENDMENTS 2007 CALIFORNIA FIRE CODE 2005 CALIFORNIA ENERGY BUILDING STANDARDS

RH-2 ZONE BERNAL HEIGHTS SUD/INDUSTRIAL PROTECTION ZONE HEIGHT AND BULK LIMITS: 40-X EXISTING AND PROPOSED USE: SINGLE FAMILY HOUSE

EXISTING NUMBER OF STORIES: 1, PROPOSED: 2 1

LOT AREA: 2500 SF (25'X100') PER CITY RECORD YEAR BUILT: 1900 EXISTING BUILDING GROSS FLOOR AREA: 2013 SF, ******* EXISTING BUILDING USABLE FLOOR AREA: 1259 SF PROPOSED: 2314SF

EXISTING BUILDING HEIGHT: 23', NO CHANGE PARKING: EXISTING: ONE, NO CHANGE R-3 OCCUPANCY TYPE V-B CONSTRUCTION

PROJECT DATA

ADDRESS: 352 RICHLAND AVE., SF, CA 94110 BLOCK/LOT: 5744/062

MARK BLOOM AND CYNTHIA VAUGHN 352 RICHLAND AVE., SF, CA 94110

ARCHITECT: OJANEN CHIOU ARCHITECTS LLP 1290 SUTTER STREET, SUITE 210 SF. CA 94109 CONTACT: MARC OJANEN 415-398-3002

STRUCTURAL ENGINEER Fareed A. Himmati, P.E. HIMMATI ENGINEERING, INC. 311 W. Hunter Ct., Fremont, CA 94539 Ph.: 510-440-9602; Cell: 415-559-9418 Fax: 510-490-3199; Email: fhimmati@sbcglobal.net

DRAWING INDEX

AO TITLE SHEET, PROJECT DATA, MAP & SITE PLAN

A1 EXISTING FLOOR PLANS

A1.1 EXISTING ELEVATIONS

A1.2 EXISTING ELEVATIONS

A2 PROPOSED FLOOR PLANS

A3 PROPOSED ELEVATIONS

A3.1 PROPOSED ELEVATIONS

A3.2 PROPOSED SECTIONS

S1 NOT USED


S2 NOT USED

S3 NOT USED

S4 NOT USED

S6 NOT USED

S5 NOT USED

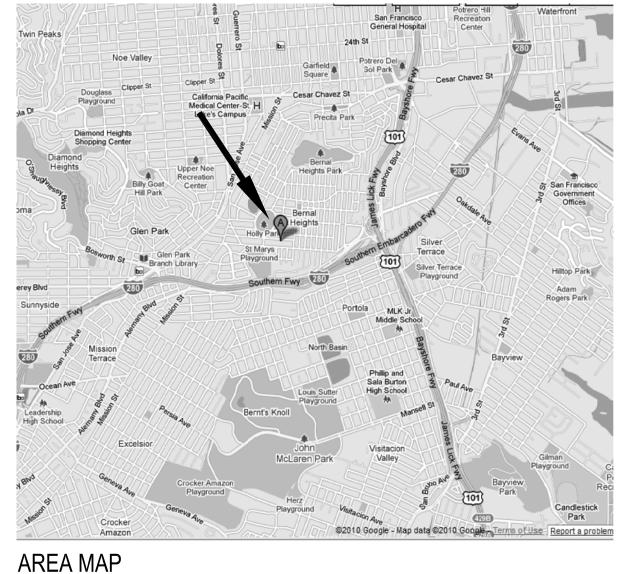



AERIAL VIEW

LOCATION OF PROPERTY LINE IS ASSUMED BASED ON CITY RECORD, AND SITE OBERVATION AND IS NOT INTENDED TO BE AN OFFICIAL SURVEY. ARCHITECT MAKES NO CLAIMS AS TO THE ACCURACY THEREOF

SUBJECT . PROPERTY

PROP. LINE 25.00

—(E) 6' HIGH FENCE, TYP.

DRIVE-

WAY

12:12

12:12

12:12

FRONT YARD

13"∖DIA.

12:12

9'-8"

10'-8"

1/A3.2 RICHLAND AVE SUBJECT PROPERT 356 350 SIDEWALK PROP. LINE 25,00 AVG. FRONT SETBACK (E) 6' HIGH FENCE, TYP. FRONT YARD DRIVE-WAY ~13**"**\\DIA. JAPANESE, /OVER-X HANG/L (NY DORMER) 1&/SKYLIGHT<u>FY/</u> 1/4"/FT. -(E) 6' HIGH FENCE, TYP. OVERHANG <u>KEY</u> **EXISTING** NEW **DECK** (E) WINDOW SKYLIGHT COMP SHINGLE ROOFING BUILT-UP ROOF 1'-1" REAR YARD PROP. LINE 25.00

PROPOSED SITE PLAN/ ROOF PLAN

1/8" = 1'- 0"

RICHLAND AVE.

SAN FRANCISCO, CA

Ojanen_Chiou architects LLP

1290 Sutter Street Suite 210 San Francisco, CA 94109 T 415 398 3002 F 415 398 3836

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12/16/10 VARIANCE/ENV EVAL REVISION 03/02/11

DATE

08/30/10

11/05/10

Issued For

ISSUE

311 NOTIFICATION

PLANNING REVISION



Job Number: 09109

TITLE SHEET

Drawing Title:

___Checked By: MO Drawn By: MO

Scale: AS NOTED

A0.0

Drawing Number:

(E) SITE PLAN/ ROOF PLAN 1/8" = 1'- 0"

—(E) 6' HIGH FENCE, TYP.

REAR YARD

PROP. LINE 25.00

1'-1"



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2	REVISION	03/02/11

* NO. C 29102 *

REN. 9.30.11

OF CALIFORN

Job Number: 09109

EXISTING ELEVATIONS

Drawing Title:

Drawn By: MO Checked By: MO

111

Drawing Number:

File Name: Scale: 1/4"=1'-0"



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* NO. C 29102 *

REN. 9.30.11

OF CALIFORNIA

Job Number: 09109

EXISTING ELEVATIONS

Drawing Title:

Drawn By: MO Checked By: MO

A1.2

Drawing Number:

File Name: Scale: 1/4"=1'-0"

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PROPOSED ELEVATIONS

Drawing Title:


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A3

Drawing Number:

File Name:

Scale: 1/4"=1'-0"

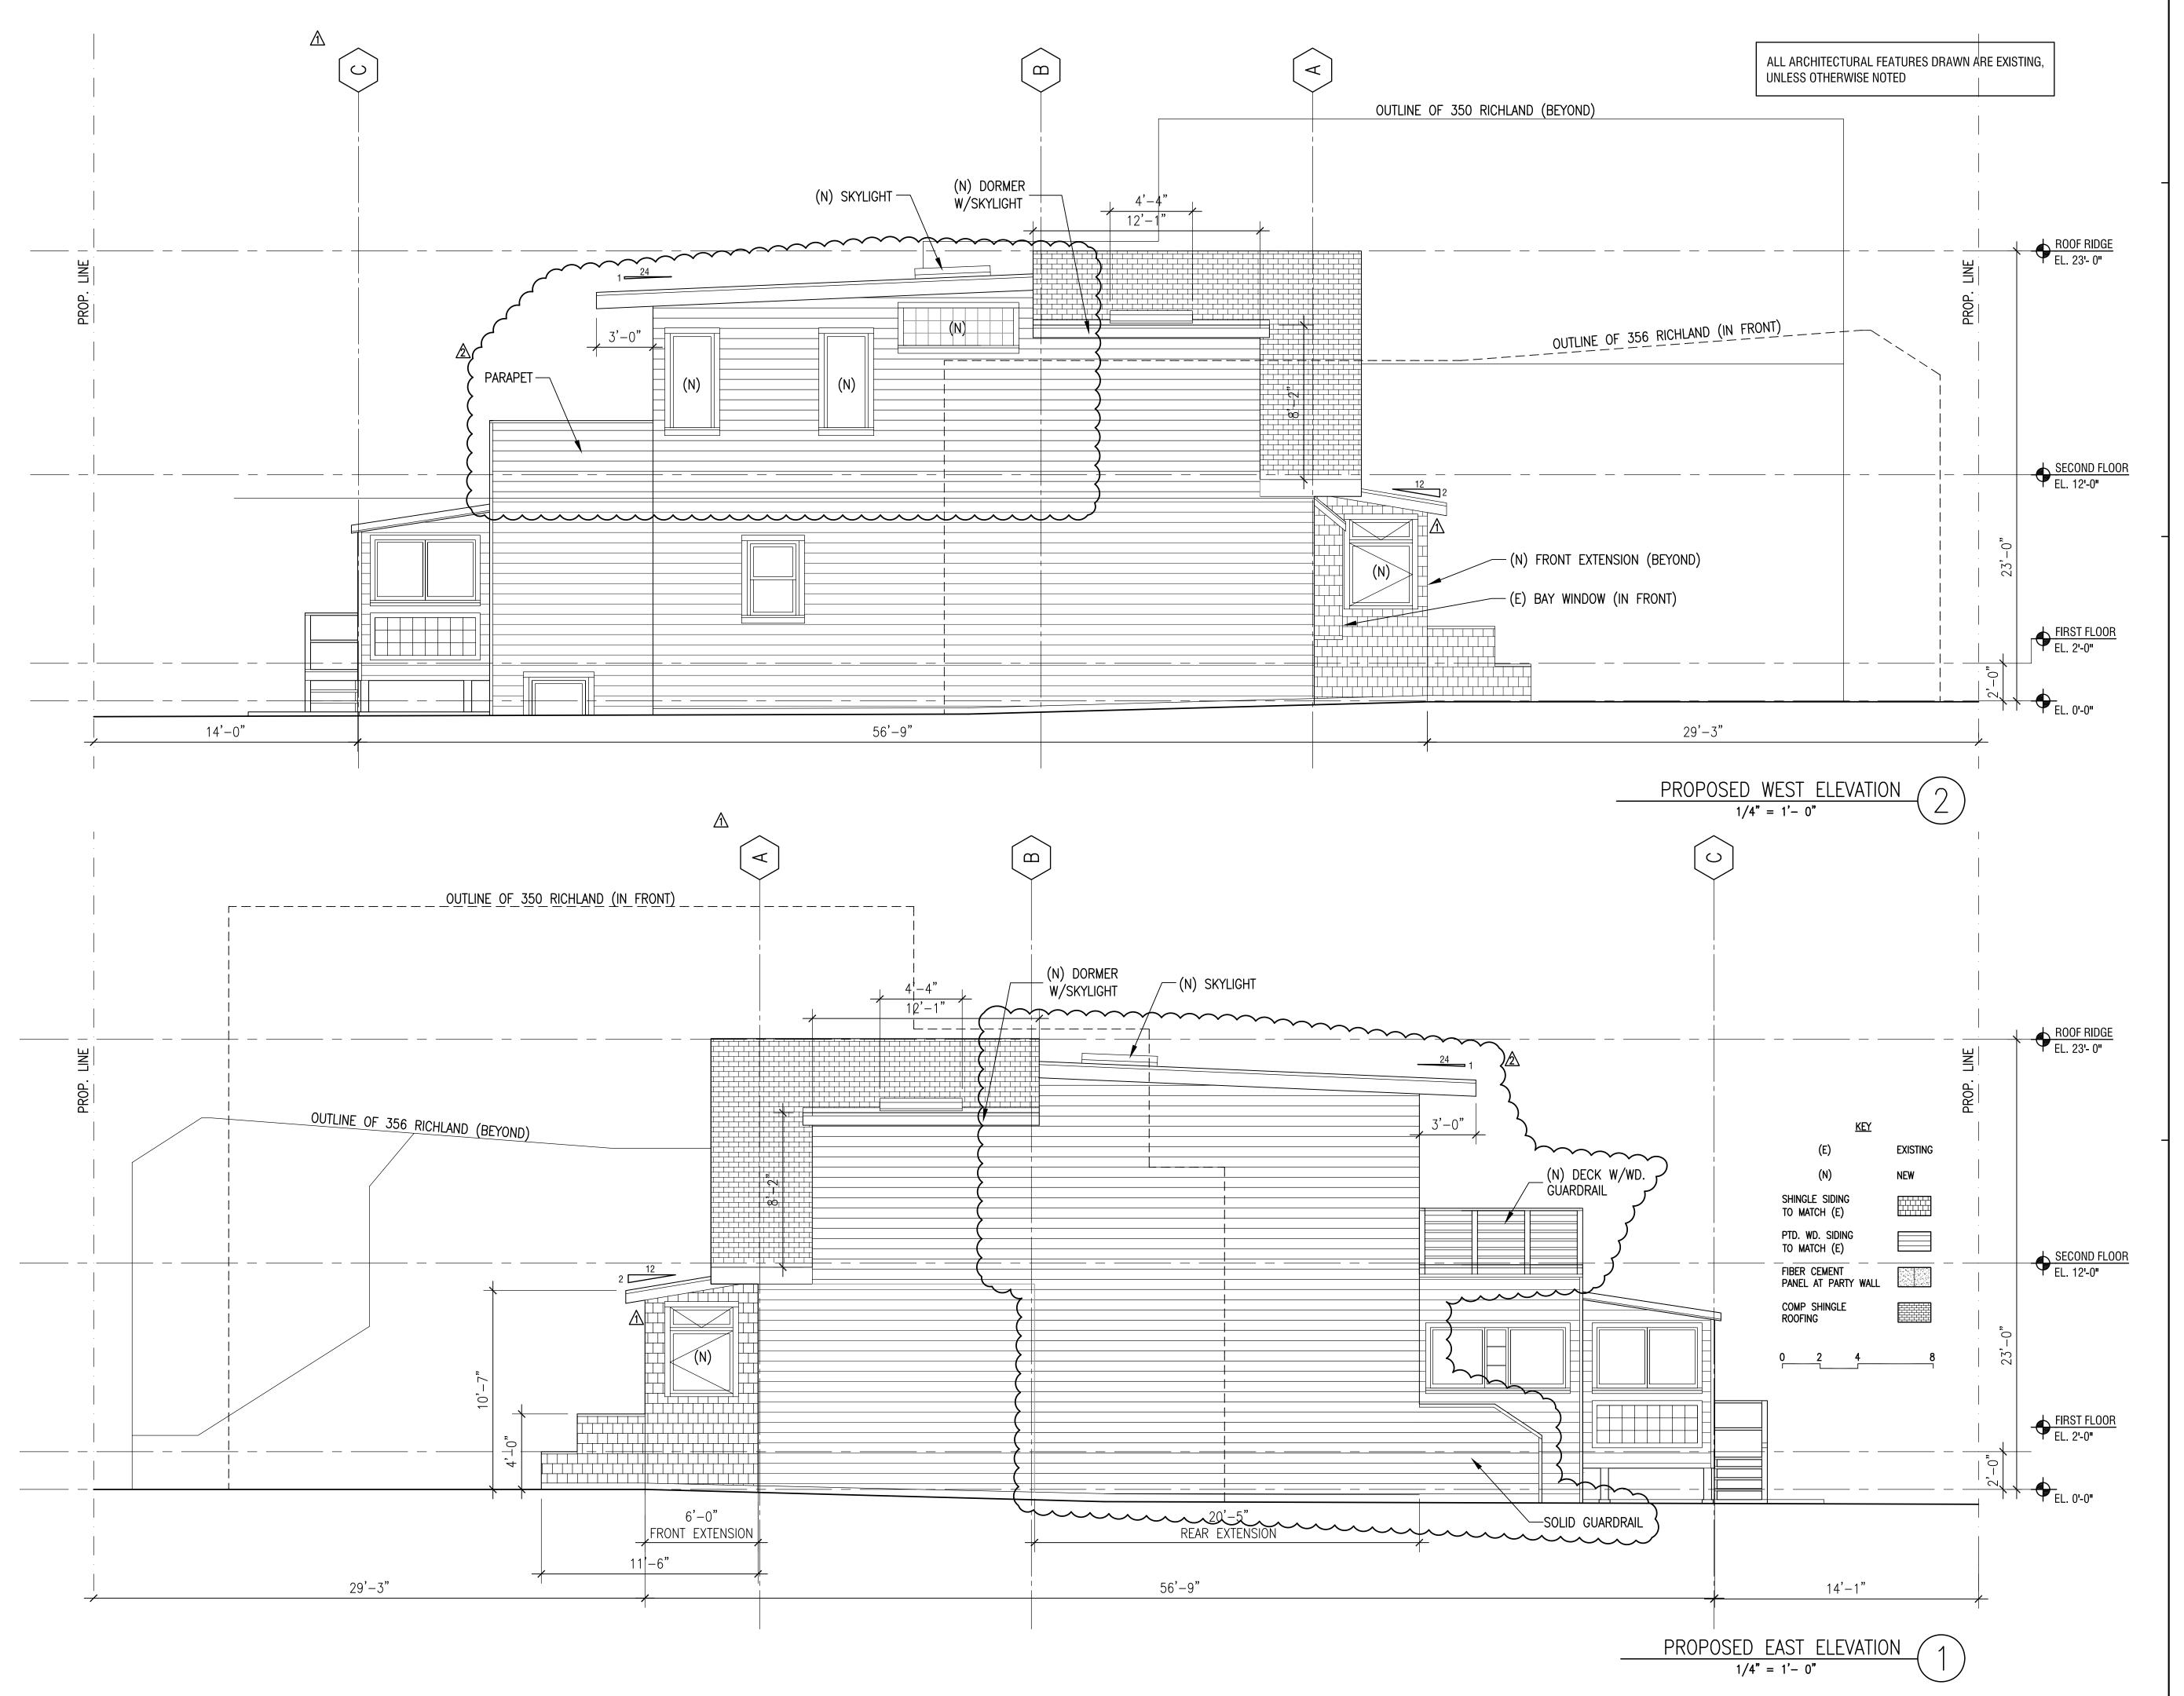

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352

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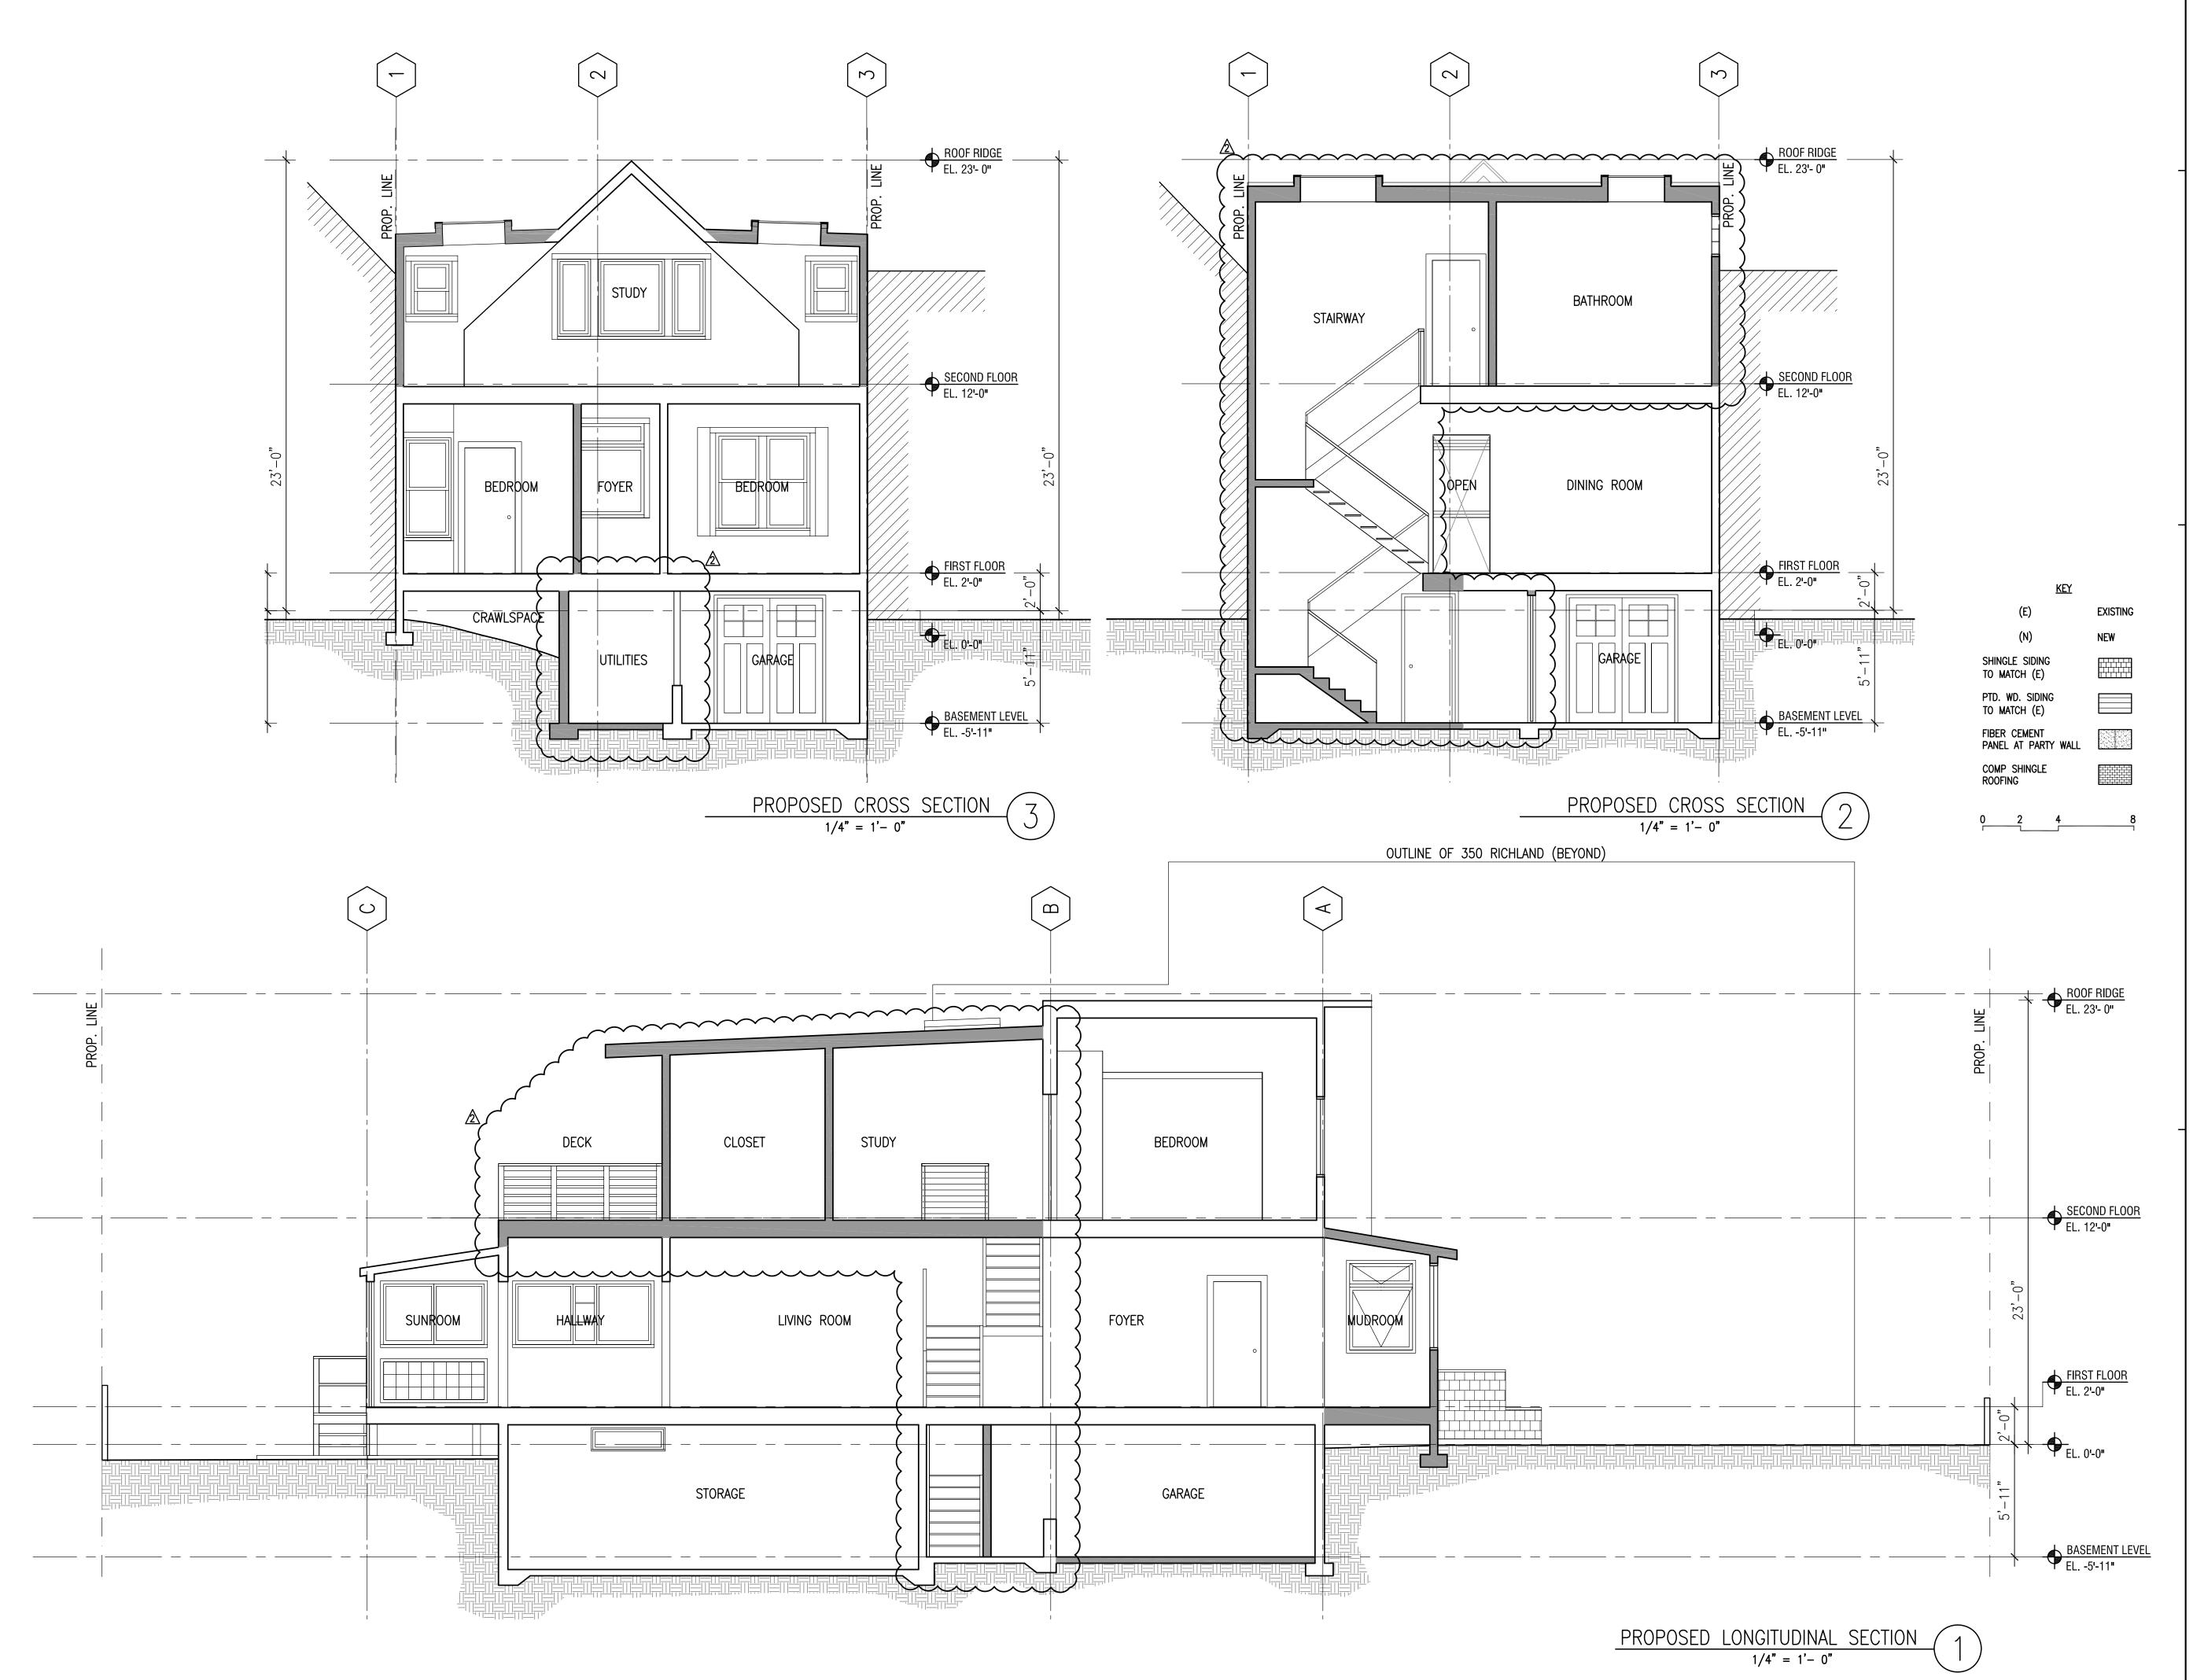
Drawing Title:

Drawn By: MO Checked By: MO

A3.1

Drawing Number:

File Name: Scale: 1/4"=1'-0"



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Job Number: 09109

PROPOSED SECTIONS

Drawing Title:

Drawn By: MO Checked By: MO

Δ32^Δ

Drawing Number:

File Name: Scale: 1/4"=1'-0"