### MEMO

## **Disclaimer for Review of Plans**

The San Francisco Planning Code requires that the plans of certain proposed projects be provided to members of the public prior to the City's approval action on the project. Accordingly, any images of plans featured on this website are provided for the primary purpose of facilitating public input prior to the City's action. The City and County of San Francisco does not own the copyright to these images. Please be aware that the unauthorized reproduction, distribution, or alteration of these images may result in a violation of Federal Copyright Law (17 U.S.C.A. Sections 101 et seq.) and that any party who seeks to reproduce or alter these images does so at his or her own risk.

Additionally, plans provided on this website are limited to site plans, elevations and/or section details (floor plans and structural details may not be included). These are DRAFT PLANS being provided for public review PRIOR to the City's approval action on the project. Final plans may differ from those that are currently available for review.

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# NOTICE OF PUBLIC HEARING

Hearing Date: Wednesday, May 26, 2010

Time: **Beginning at 9:30 AM** 

Location: City Hall, 1 Dr. Carlton B. Goodlett Place, Room 408
Case Type: Variance (Rear Yard, Open Space, Mass Reduction)

Hearing Body: Zoning Administrator

PROPERTY INFORMATION		APPLICATION INFORMATION		
Project Address:	687 Moultrie Street	Case No.: Building Permit: Applicant/Agent: Telephone:	2008.1029V	
Cross Street(s):	NE corner Ogden Ave		2008.12.05.7940	
Block /Lot No.:	5723 / 016		2008.12.05.7935	
Zoning District(s):	RH-1 / 40-X		Li-Sheng Fu	
Area Plan:	Bernal Heights SUD		(510) 656-8287	

## PROJECT DESCRIPTION

The proposal is to demolish and reconstruct a single car garage located in the front yard of an existing single family residence on a corner lot. The garage will be replaced with a new two car garage with living area on the second floor and a connection to the existing two-story single family residence. The project also includes a horizontal addition on the ground floor with a new second story deck.

**PER SECTION 242(e)(2) OF THE PLANNING CODE** the subject property is required to maintain a minimum rear yard depth equal to 35 percent of the total depth of the lot for lots that have a depth of 70 feet or less. The existing single family residence and the proposed horizontal addition encroach into the required rear yard of 24 feet 6 inches. An equivalent amount of rear yard is currently provided in the center of the lot. The proposal would further encroach into the rear yard and would reduce the amount of equivalent rear yard space. Therefore, the project requires a variance from the rear yard requirement (Section 242(e)(2)) of the Planning Code.

**PER SECTION 242(e)(3) OF THE PLANNING CODE** the subject property is required to subtract 650 square feet of usable floor area from the maximum building envelope. The proposed project results in a mass reduction calculation of 260 square feet. Therefore, the project requires a variance from the mass reduction requirement (Section 242(e)(3)) of the Planning Code.

### ADDITIONAL INFORMATION

FOR MORE INFORMATION, PLEASE CONTACT PLANNING DEPARTMENT STAFF:

Planner: Erika S. Jackson Telephone: (415) 558-6363 E-Mail: erika.jackson@sfgov.org

**ARCHITECTURAL PLANS:** The site plan and elevations of the proposed project are available on the Planning Department's website at: <a href="http://sf-planning.org/ftp/files/notice/2008.1029V.pdf">http://sf-planning.org/ftp/files/notice/2008.1029V.pdf</a>

中文詢問請電: 558.6378

Para información en Español llamar al: 558.6378

## GENERAL INFORMATION ABOUT PROCEDURES

#### VARIANCE HEARING INFORMATION

Under Planning Code Section 306.3, you, as a property owner or resident within 300 feet of this proposed project or interested party on record with the Planning Department, are being notified of this Variance Hearing. You are not obligated to take any action. For more information regarding the proposed work, or to express concerns about the project, please contact the Applicant/Agent or Planner listed on this notice as soon as possible. Additionally, you may wish to discuss the project with your neighbors and neighborhood association or improvement club, as they may already be aware of the project.

Persons who are unable to attend the public hearing may submit written comments regarding this application to the Zoning Administrator, Planning Department, 1650 Mission Street, Suite 400, San Francisco, CA 94103, by 5:00pm the day prior to the hearing. These comments will be made a part of the official public record, and will be brought to the attention of the person or persons conducting the public meeting or hearing.

#### BUILDING PERMIT APPLICATION INFORMATION

Under Planning Code Section 311/312, the Building Permit Application for this proposal is also subject to a 30-day notification to occupants and owners within 150-feet of the subject property. The mailing of such notification will be performed separately.

#### **BOARD OF APPEALS**

An appeal of the approval (or denial) of a **variance application** by the Zoning Administrator may be made to the **Board of Appeals within 10 days** after the **Variance Decision Letter** is issued by the Zoning Administrator.

An appeal of the approval (or denial) of a **building permit application** by the Planning Department may be made to the **Board of Appeals within 15 days** after the **building permit** is issued (or denied) by the Director of the Department of Building Inspection.

Appeals must be submitted in person at the **Board's office at 1650 Mission Street**, **3rd Floor**, **Room 304**. For further information about appeals to the Board of Appeals, including current fees, **contact the Board of Appeals** at **(415) 575-6880**.

#### **ABOUT THIS NOTICE**

The Planning Department is currently reviewing its processes and procedures for public notification as part of the Universal Planning Notification (UPN) Project. The format of this Public Hearing notice was developed through the UPN Project and is currently being utilized in a limited trial-run for notification of Variance Hearings.

If you have any comments or questions related to the UPN Project or the format of this notice, please visit our website at <a href="http://upn.sfplanning.org">http://upn.sfplanning.org</a> for more information.

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# **ABBREVIATIONS**

F.H.C.

FIN.

FLASH.

FIRE HOSE CABINET

FINISH

**FLOOR** 

FLASHING

PT.

P.T.D.

QT.

PAPER TOWEL DISPENSER

QUARRY TILE

ABBI	REVIATIONS				
& L @ Q # EN (N)	AND ANGLE AT CENTERLINE DIAMETER OR ROUND PERPENDICULAR POUND OR NUMBER EXISTING	FLOUR. F.O.C. F.O.F. F.O.S. FPPF. F.S. FT. FTG.	FLOURESCENT FACE OF CONCRETE FACE OF FINISH FACE OF STUDS FIREPROOF FULL SIZE FOOT OR FEET FOOTING	R. RAD. R.D. REF. REFR. RGTR. REINF. REQ.	RISER RADIUS ROOF DRAIN REFERENCE REFRIGERATOR REGISTER REINFORCED REQUIRED
(N)  ACOUS. A.D. ADJ. AGGR. AL.	NEW  ACOUSTICAL AREA DRAIN ADJUSTABLE AGGREGATE ALUMINUM	FURR. FUT. GA. GALV. G.B.	FURRING FUTURE GAUGE GALVANIZED GRAB BAR	RESIL. RM. R.O. RWD. R.W.L.	RESILIENT ROOM ROUGH OPENING REDWOOD RAIN WATER LEADER SOUTH
APPROX. ARCH. ASB. ASPH.	APPROXIMATE ARCHITECTURAL ASBESTOS ASPHALT	GL. GND. GR. GYP.	GLASS GROUND GRADE GYPSUM HOSE BIBB	S.C. S.C.D. SCHED. S.D. SECT. SH. SHR.	SOUTH SOUTH SOUTH SOUTH SOUTH SEAT COVER DISPENSER SCHEDULE SOAP DISPENSER SECTION SHELF SHOWER
BD. BITUM. BLDG. BLK BLKG. BM. BOT.	BOARD BITUMINOUS BUILDING BLOCK BLOCKING BEAM BOTTOM	H.C. HDWD. HDWE H.M. HOR. HR. HGT.	HOLLOW CORE HARDWOOD HARDWARE HARDWARE HOLLOW METAL HORIZON HOUR HEIGHT	SHT. SIM. S.N.D. S.N.R. SPEC.	SHEET SIMILAR SANITARY NAPKIN DISPENSER SANITARY NAPKIN RECEPTACLE SPECIFICATION
CAB. C.B. CEM. CER. C.I. CL.	CABINET CATCH BASIN CEMENT CERAMIC CAST IRON CEILING	I.D. INSUL. INT. JAN.	INSIDE DIAMETER INSULATION INTERIOR  JANITOR	SQ. SST. S.SX. STA. STD. STL. STOR.	SQUARE STAINLESS STEEL SERVICE SINK STATION STANDARD STEEL STORAGE
CLKG. CLO. CLR. COL. CONC. CONN. CONST.	CAULKING CLOSET CLEAR COLUMN CONCRETE CONNECTION CONSTRUCTION	JT. KIT. LAB.	JOINT  KITCHEN  LABORATORY	STRL. SUSP. SYM. TRD. T.B.	STRUCTURAL SUSPENDED SYMMETRICAL  TREAD TOWEL BAR
CONT. CORR. CTR. DBL. DEPT.	CONTINOUS CORRIDOR CENTER  DOUBLE DEPARTMENT	LAM. LAV. LKR. LT. MAX.	LAMINATE LAVATORY LOCKER LIGHT MAXIMUM	T.C. TEL. TER. T.&G. THK. T.P.	TOP OF CURB TELEPHONE TERRAZZO TONGUE AND GROOVE THICK TOP OF PAVEMENT TOILET PAPER
D.F. DET. DIA. DIM. DISP. DN. D.O.	DRINKING FOUNTAIN DETAIL DIAMETER DIMENSION DISPENSER DOWN DOOR OPENING	M.C. MECH. MEMB. MET. MFR. M.H. MIN.	MEDICINE CABINET MECHANICAL MEMBRANE METAL MANUFACTURER MANHOLE MINIMUM	T.V. T.W. TYP. UNF.	DISPENSER TELEVISION TOP PF WALL TYPICAL UNFINISHED
DR. DWR. DS. D.S.P. DWG.	DOOR DRAWER DOWNSPOUT DRY STANDPIPE DRAWING	MIR. MISC. M.O. MTD. MUL.	MIRROR MISCELLANEOUS MANSONRY OPENING MOUNTED MULLION	U.O.N.  UR.  VERT.  VEST.	UNLESS OTHERWISE NOTED URINAL VERTICAL VESTIBULE
E. EA. E.J. ELEC. ELEV. EMER. ENCL.	EAST EACH EXPANSION JOINT ELEVATION ELECTRICAL ELEVATOR EMERGENCY ENCLOSURE	N. N.I.C. NO. OR # NOM. N.T.C.	NORTH NOT IN CONTRACT NUMBER NOMINAL NOT TO SCALE  OVERALL	W. W/ W.C. WD. W/O	WEST WITH WATER CLOSET WOOD WITHOUT
EP. EQ. EQPT. E.W.C. EXIST. EXPO. EXP. EXT.	ELECTRICAL PANELBOARD EQUAL EQUIPMENT ELECTRIC WATER COOLER EXISTING EXPOSED EXPANSION EXTERIOR	O.A. OBS. O.C. O.D. OFF. OPNG. OPP. O.H.	OBSCURE ON CENTER OUTSIDE DIAMETER (DIM.) OFFICE OPENING OPPOSITE OPPOSITE HAND	WP. WSCT. WT.	WATERPROOF WAINSCOT WEIGHT
F.A. F.B. F.D. FDN. F.E. F.E.C. F.H.C.	FIRE ALARM FLAT BAR FLOOR DRAIN FOUNDATION FIRE EXTINGUISHER FIRE EXTINGUISHER FIRE HOSE CABINET	PRCST. PL. P.LAM. PLAS PLYWD. PR. PT.	PRE-CAST PLATE PLASTIC LAMINATE PLASTER PLYWOOD PAIR POINT		

## DRAWING INDEX


ARCHITECTURAL

A-1 COVER

A-2 RPOPOSED SITE PLAN, MASS REDUCTION CALC. A-3 PROPOSED FLOOR PLANS


A-4 PROPOSED ELEVATIONS

A-5 ELEVATIONS, LOFT PLAN & ROOF PLAN A-6 EXISTING SITE PLAN, FLOOR PLANS & ELEVATIONS

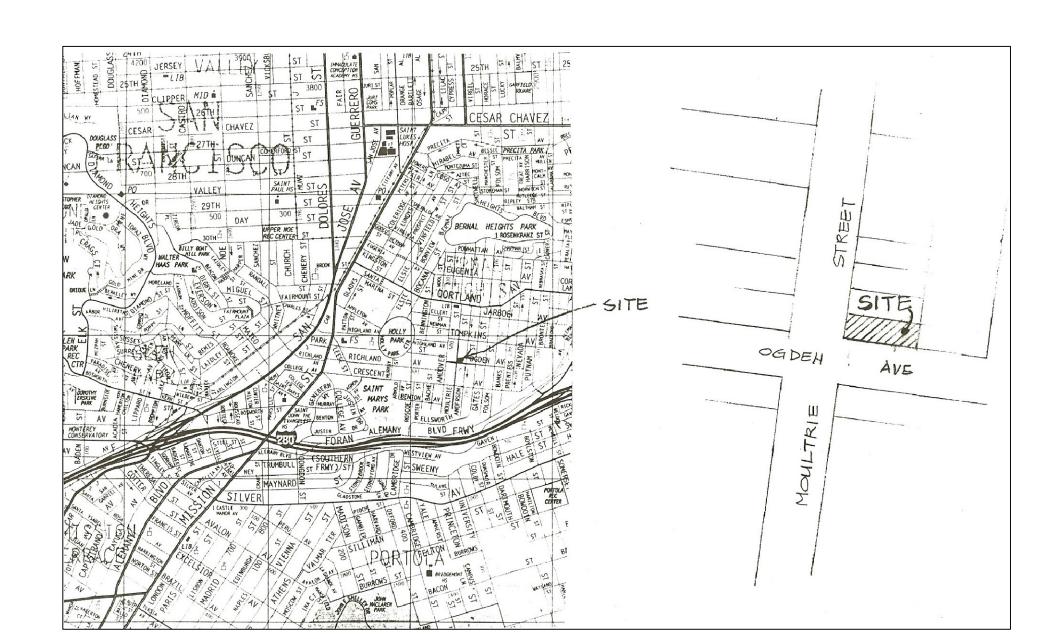



**BLOCK MAP** 

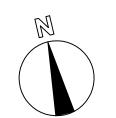

## **BUILDING INFORMATIONS**

687 MOULTRIE STREET SAN FRANCISCO, CA. 687 MOULTRIE STREET SAN FRANCISCO, CA.

OWNER'S NAME: OWNER'S ADDRESS PROJECT ADDRESS ASSESSOR'S BLOCK/LOT

ZONING LOT SIZE EXISTING LOT COVERAGE PROPOSED LOT COVERAGE

EXISTING BLDG. HT. PROPOSED BLDG. HT.

MAX. ALLOWED FLOOR AREA

1887 SF.

70'X25'=1750 SF.

5723/16

±26'-1"

±30'-10"

GLENN FONG & ANN CHEN

46.69% (817/1750=46.69%) 74.86% (1310/1750=74.86%)


22' X44'-6" X 3 -400 - 650 = 1887 S.F.

TOTAL FLOOR AREA

FLOOR AREA	EXISTING BLDG	PROPOSED ADDITION	TOTAL
1ST. FLOOR	( 547 S.F. )	241 S.F.	788 S.F.)
2ND FLOOR	558 S.F.	871 S.F.	1429 S.F.
(2ND FLOOR+ LOFT)		(626+245)	
TOTAL	1105 S.F.	1112S.F.	2217 S.F.
GARAGE	270 SF.	252 S.F.	522 S.F.



REVISION BY 03/ 05/ 09 PLANING COMMENTS

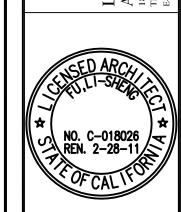



ALIFORNI STREET MOULTRIE **687** 

CONTENTS: COVER SHEET

Date: 06/14/07 Scale: N/A Drawn:

Job: Sheet: A-I

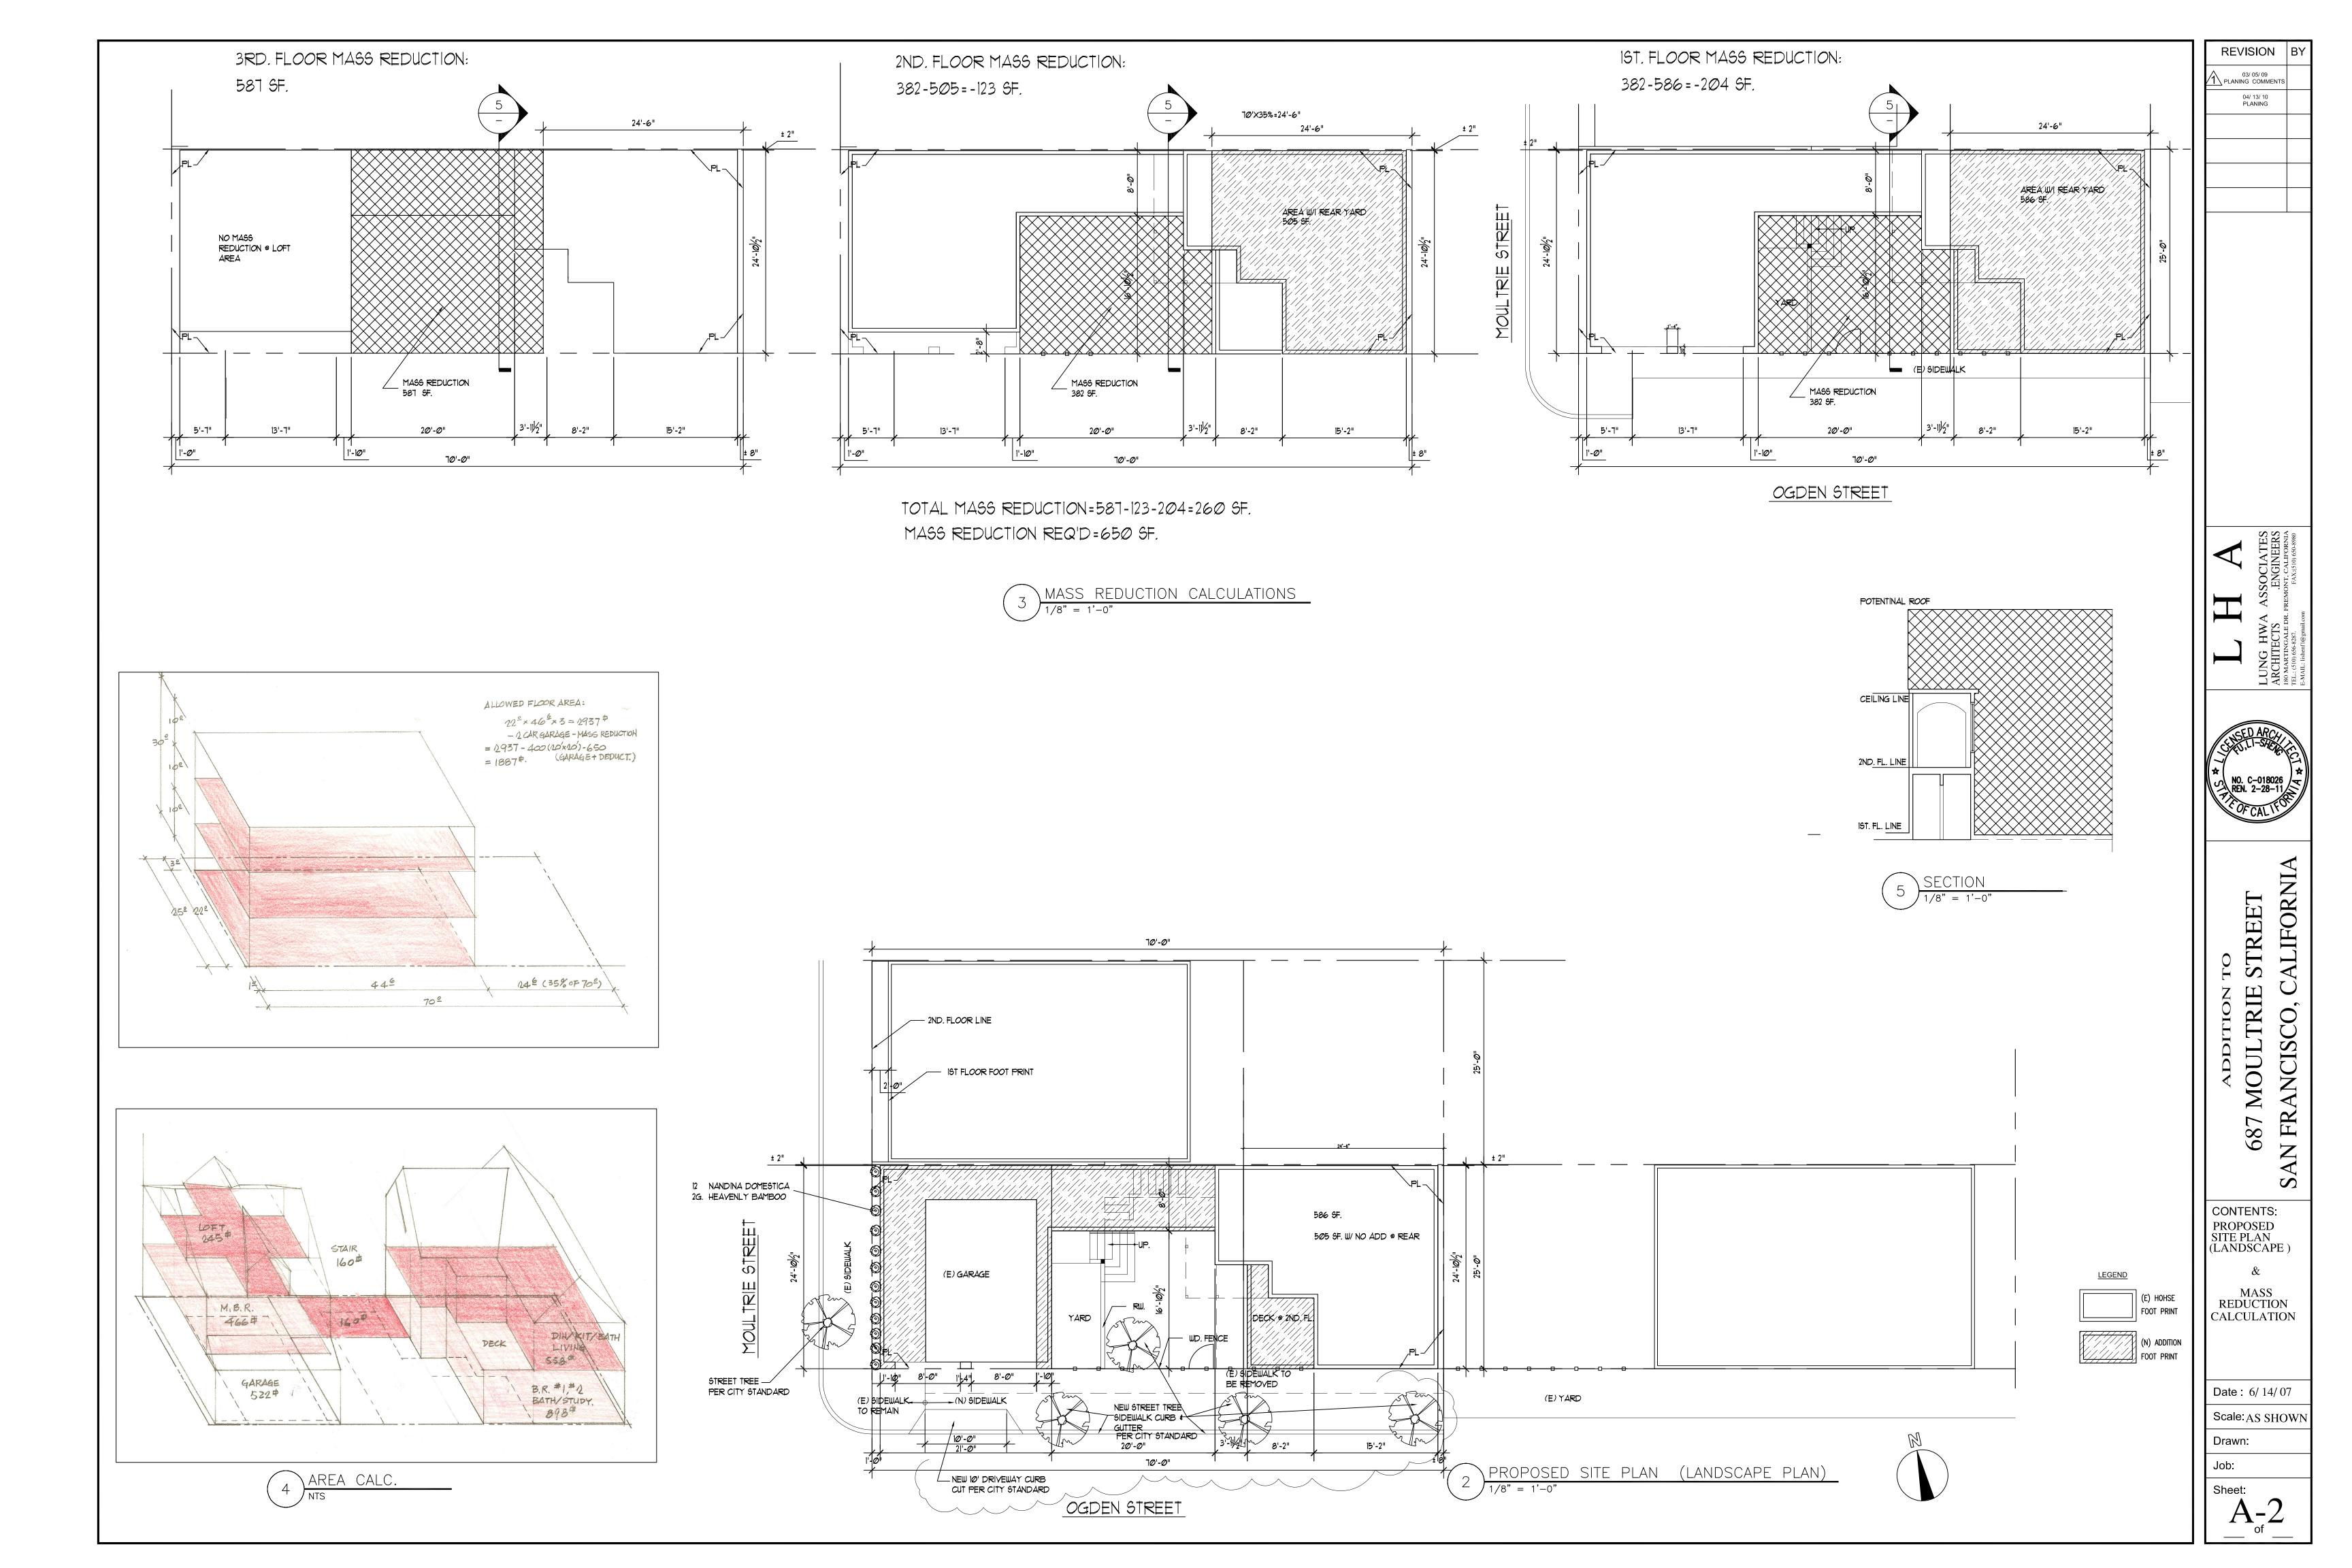

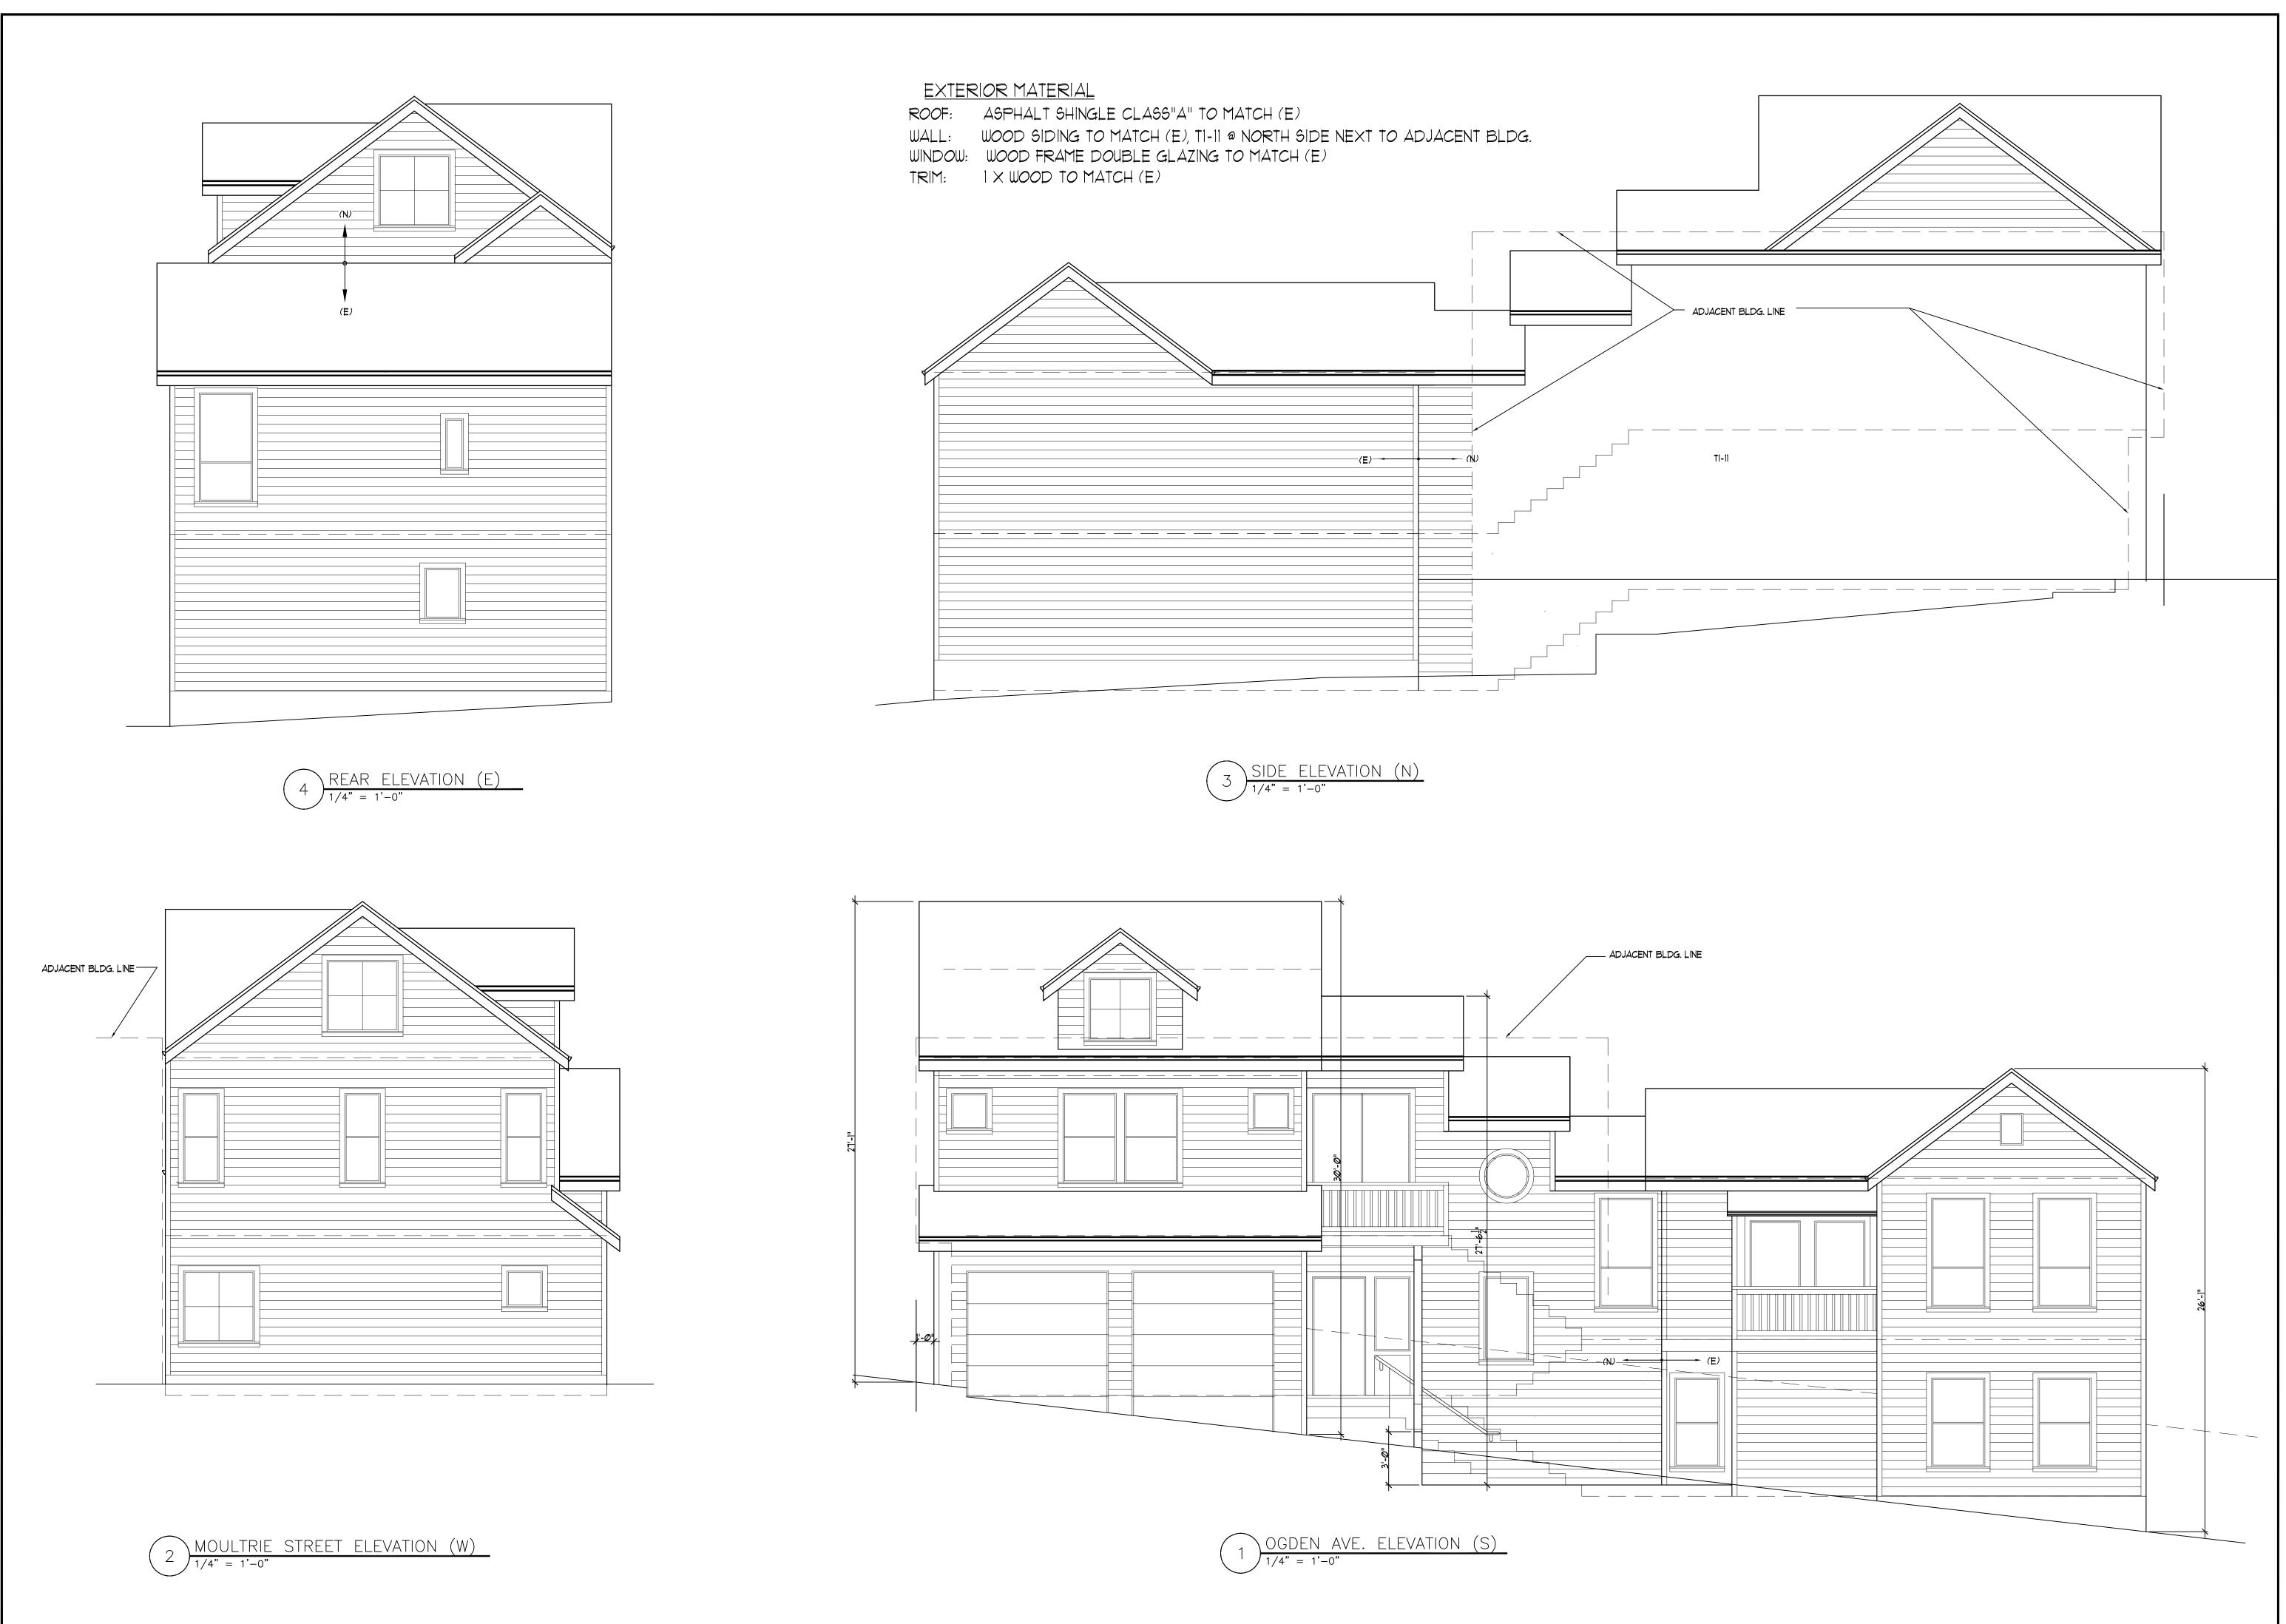

H ASSOCIATES

A ASSOCIATES


S. ENGINEERS

DR. FREMONT, CALIFORNIA
FAX;G10,650-8980

A GLOW

Hoom

LUNG HWA ASSOCIA'
ARCHITECTS ENGINE
180 MARTINGALE DR. FREMONT, CALIFO
TEL.: (510) 656-8287.
E-MAIL: lishenfl@gmail.com

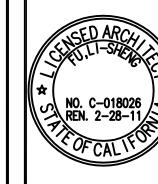

687 MOULTRIE STREET N FRANCISCO, CALIFORNIA


CONTENTS:
PROPOSED
ELEVATIONS

Date : 06/ 14/ 07


Scale: 1/4"=1'-0"

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Job:
Sheet:

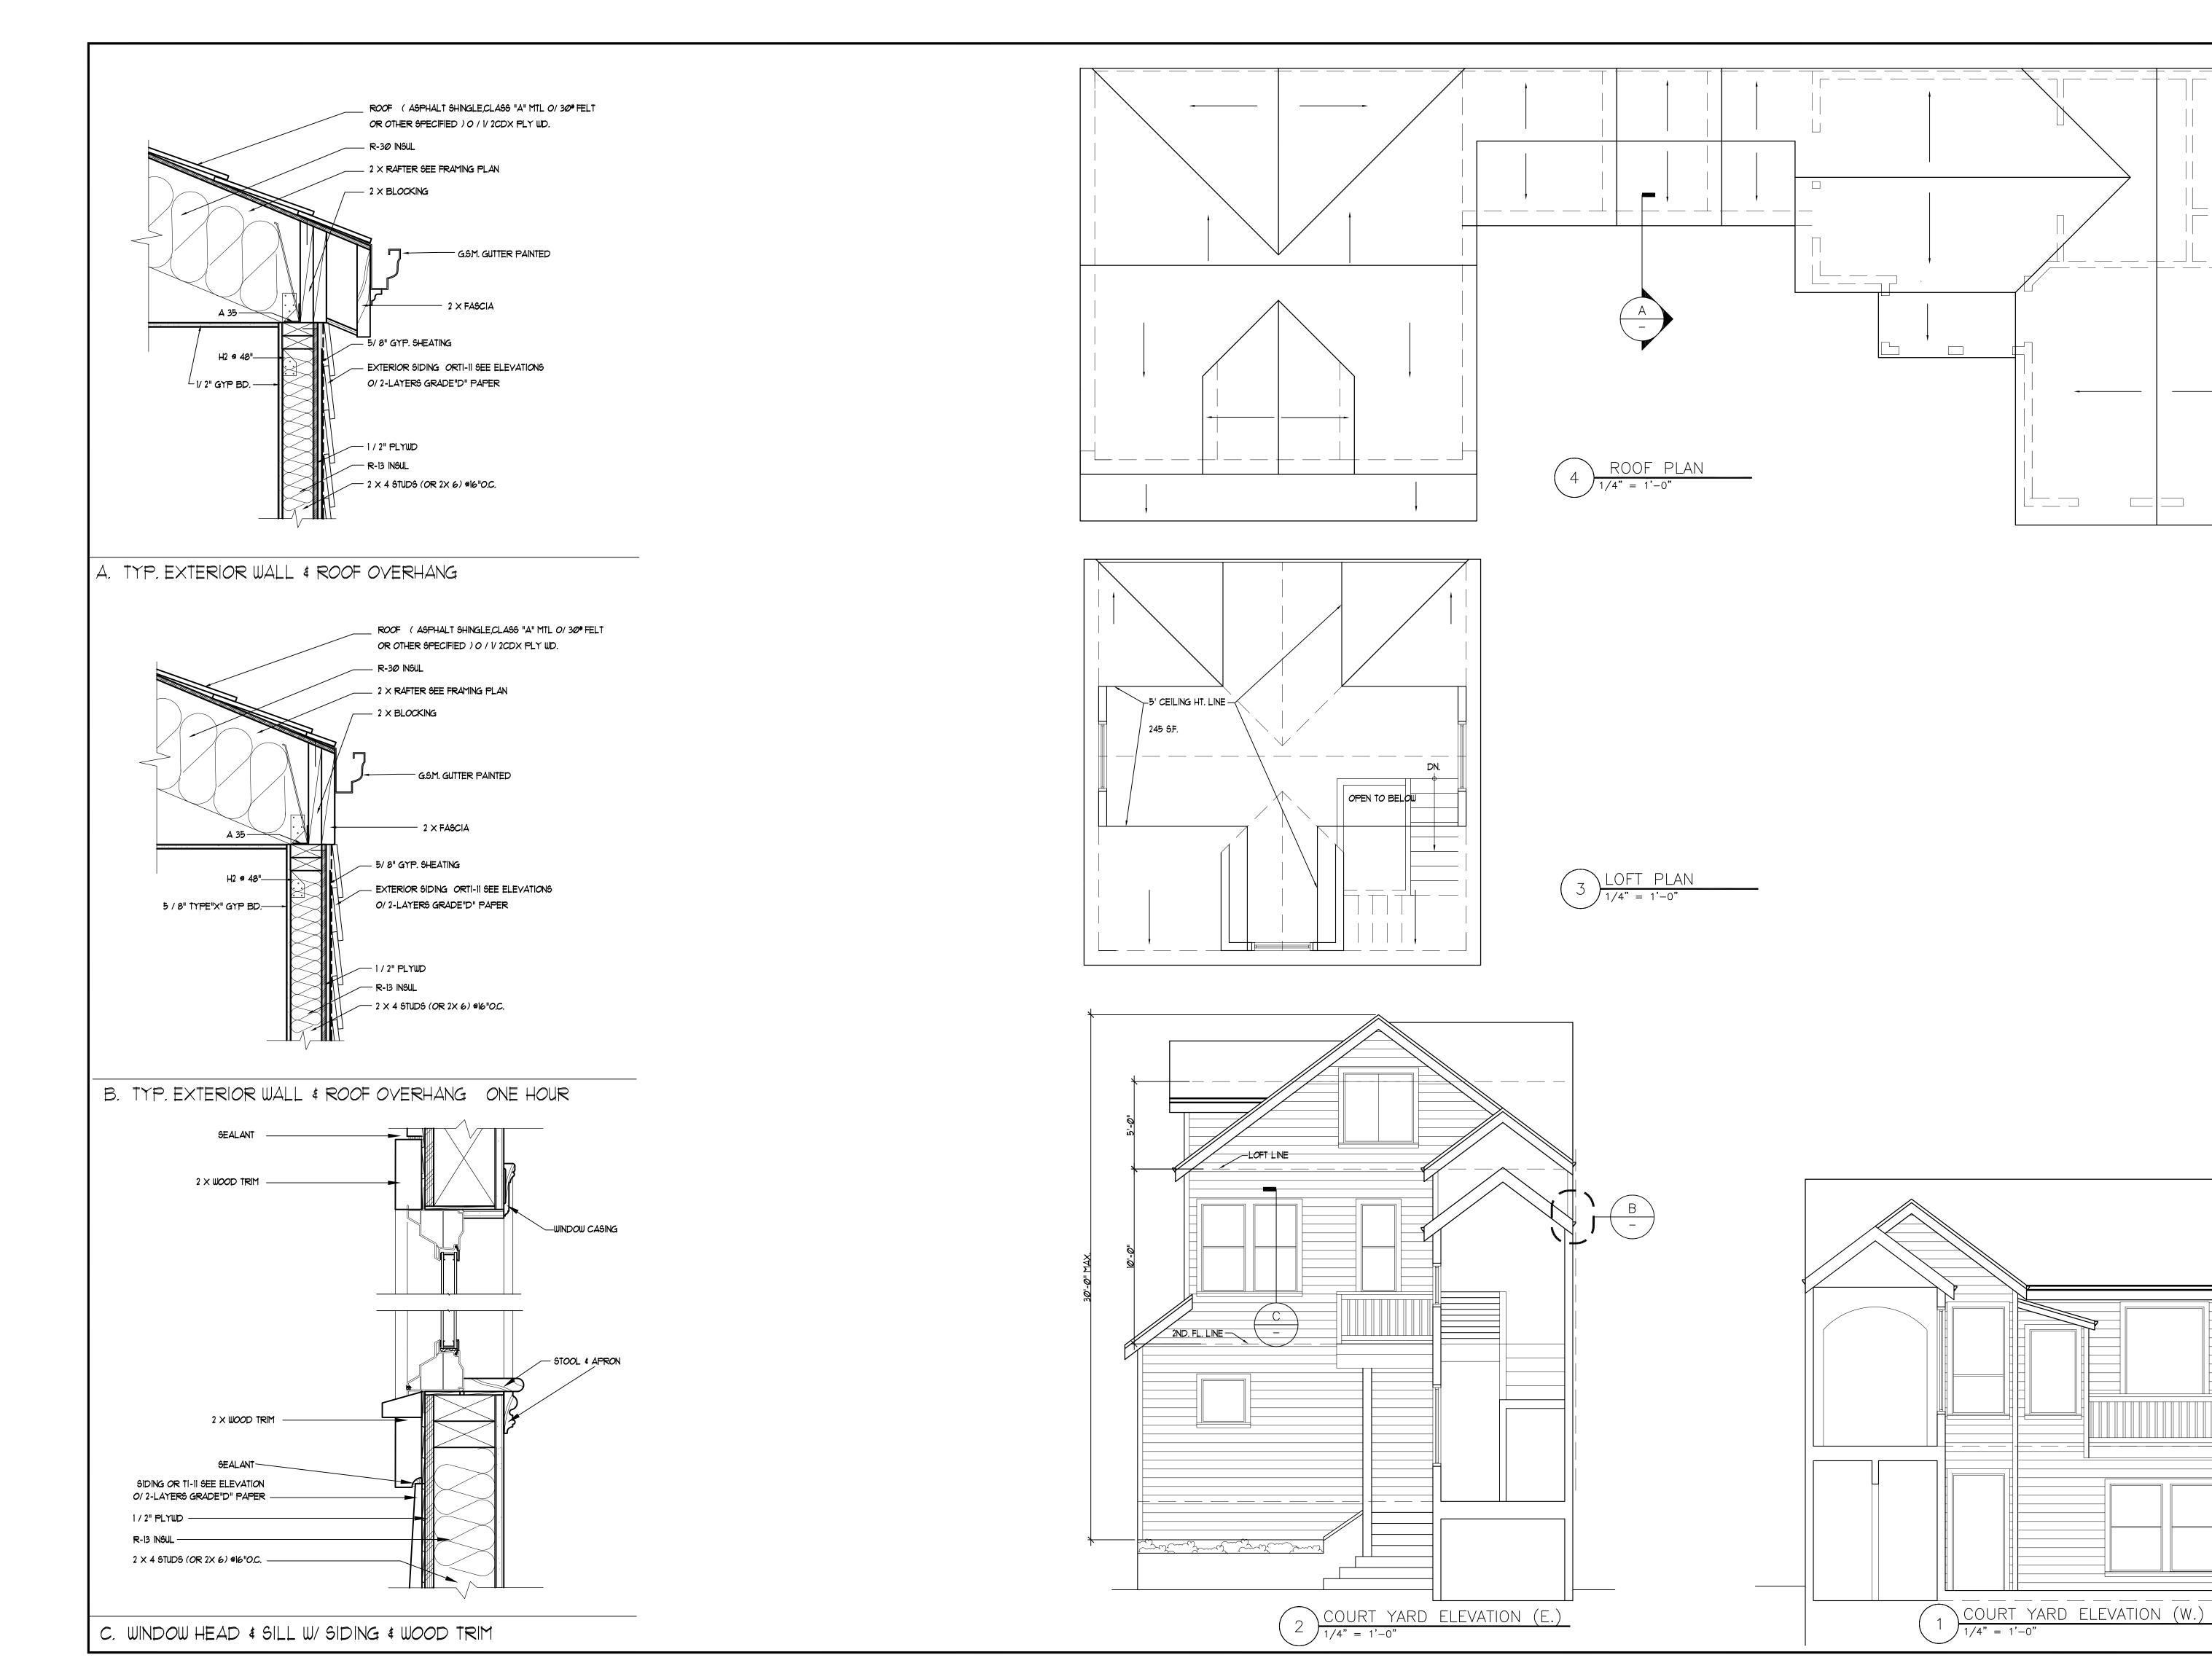

REVISION BY NEW @ 03/ 05/ 09 PLANING COMMENTS CALIFORNIA STREET ADDITION TO MOULTRIE CONTENTS: PROPOSED ELEVATIONS, LOFT PLAN, ROOF PLAN **DETAILS** Date: 03/05/09 Scale:<sub>1/4"=1'-0"</sub> Drawn: Job: Sheet: A-5

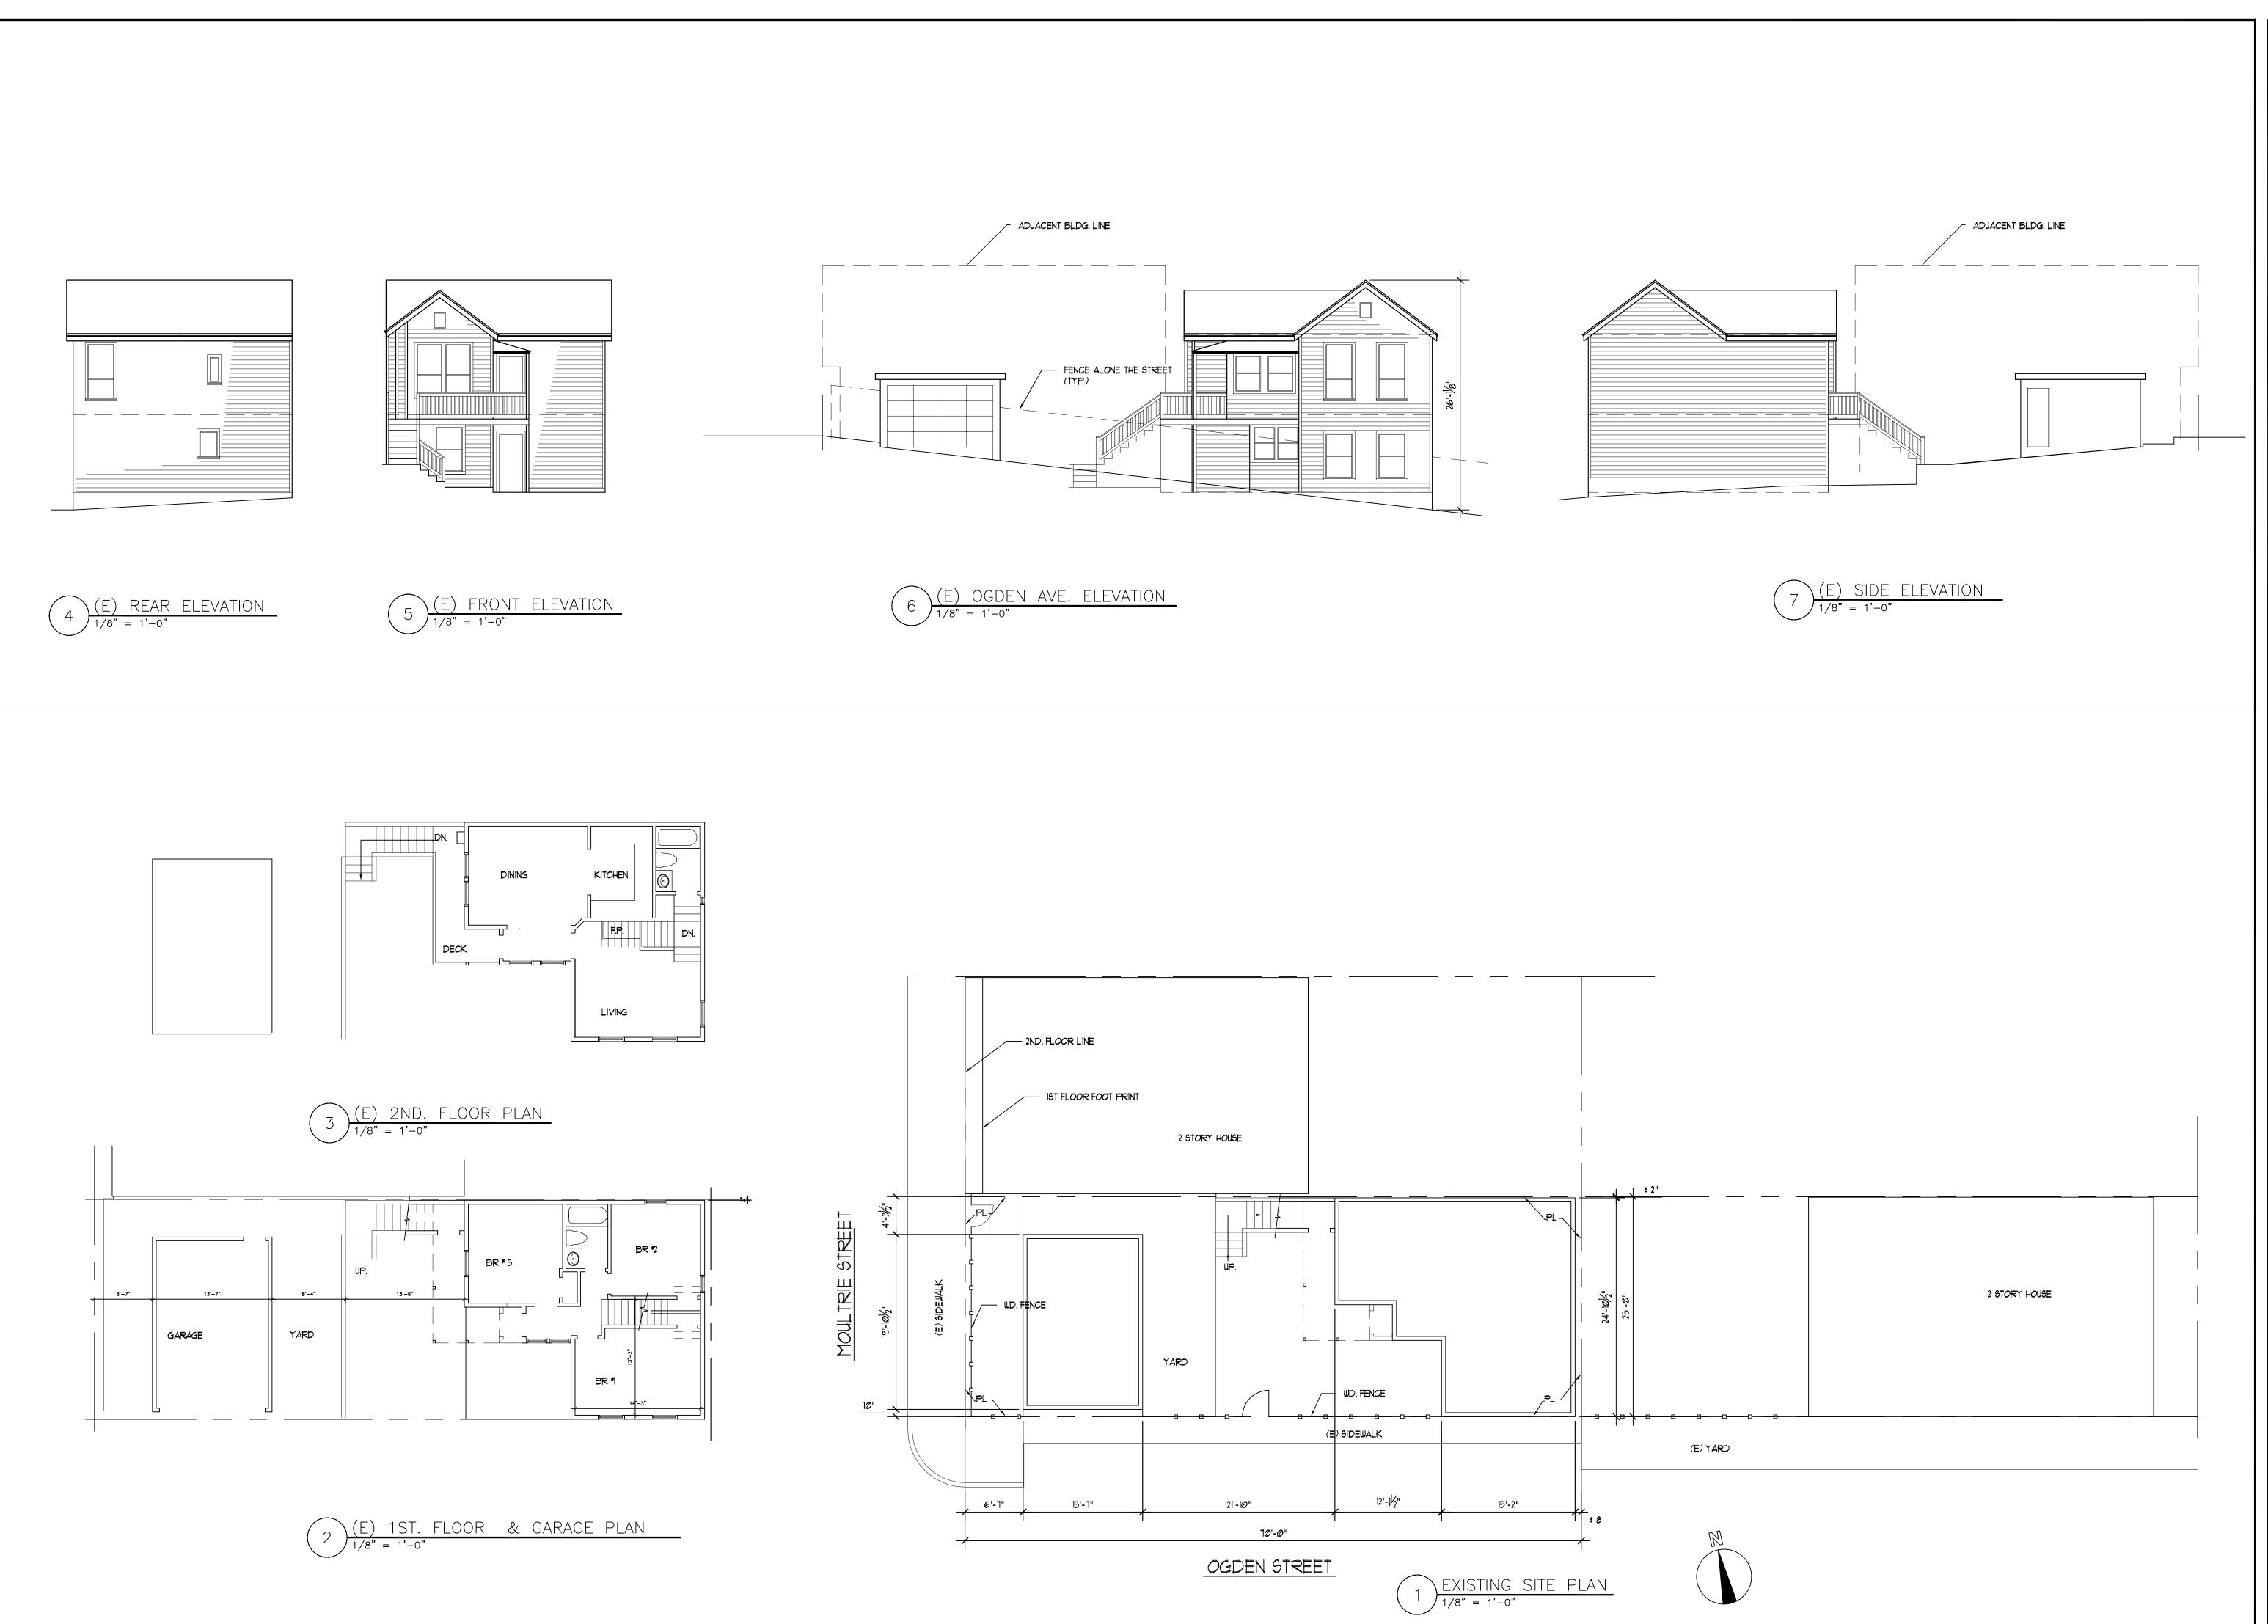

REVISION BY

O3/ 05/ 09
PLANING COMMENTS

CUNG HWA ASSOCIATES
ARCHITECTS ENGINEERS
80 MARTINGALE DR. FREMONT, CALIFORNIA
EL.: (\$10) 656-8287. FAX: (\$10) 650-8980



687 MOULTRIE STREET N FRANCISCO, CALIFORNIA

CONTENTS:
EXISTING
SITE PLAN,
FLOOR PLANS,
& ELEVATIONS

Date: 6/ 14/ 07

Scale:<sub>1/8"=1'-0"</sub> Drawn:

Job:

Sheet: A-6 of