

# SAN FRANCISCO PLANNING DEPARTMENT

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### **Disclaimer for Review of Plans**

The San Francisco Planning Code requires that the plans of certain proposed projects be provided to members of the public prior to the City's approval action on the project. Accordingly, any images of plans featured on this website are provided for the primary purpose of facilitating public input prior to the City's action. The City and County of San Francisco does not own the copyright to these images. Please be aware that the unauthorized reproduction, distribution, or alteration of these images may result in a violation of Federal Copyright Law (17 U.S.C.A. Sections 101 et seq.) and that any party who seeks to reproduce or alter these images does so at his or her own risk.

Additionally, plans provided on this website are limited to site plans, elevations and/or section details (floor plans and structural details may not be included). These are DRAFT PLANS being provided for public review PRIOR to the City's approval action on the project. Final plans may differ from those that are currently available for review.

1650 Mission St. Suite 400 San Francisco, CA 94103-2479

Reception: 415.558.6378

Fax: 415.558.6409

Planning Information: 415.558.6377



# SAN FRANCISCO PLANNING DEPARTMENT

1650 Mission Street, Suite 400 • San Francisco, CA 94103 • Fax (415) 558-6409

# NOTICE OF PUBLIC HEARING

Hearing Date:Wednesday, January 22, 2014Time:9:30 AMLocation:City Hall, 1 Dr. Carlton B. Goodlett Place, Room 408Case Type:Variance(Rear Yard and Front Setback)Hearing Body:Zoning AdministratorPORPERTY INFORMATION

PORPERTY INFORMATION		APPLICATION INFORMATION	
Project Address:	1000 Broadway	Case No.:	2006.1202V
Cross Street(s):	Taylor Street	Building Permit:	
Block / Lot No.:	0150/054	Applicant/Agent:	David P. Cincotta
Zoning District(s):	RH-2 / 40-X	Telephone:	415-398-8080
Area Plan:		E-Mail:	dcincotta@jmbm.com
DROLLOT DECORDINAN			

**PROJECT DESCRIPTION** 

The proposal is to subdivide one parcel into three lots and one airspace parcel. Two lots are proposed to front on Broadway (1000 and 1010 Broadway) and be developed with single-family homes. A two-family dwelling is proposed to front on Taylor Street (1601-1625 Taylor Street). The airspace parcel will include below grade parking for the proposed buildings.

**PLANNING CODE SECTION 132** requires a front setback of 4'-5½ " for 1000 Broadway, 8'-11" for 1010 Broadway, and 9'-1" for 1601-1625 Taylor Street. Below grade and above grade portions of both 1010 Broadway and 1601-1625 Taylor Street extend into the front setback, therefore a variance is required. 1000 Broadway complies with the front setback requirement and does not require a variance from this requirement Above grade the project will feature the following front setbacks: 1000 Broadway - 21'-1"; 1010 Broadway - 5'-0"; and, 1601-1625 Taylor Street - 4'-6".

**PLANNING CODE SECTION 134** requires a rear yard of 15' for each of the three lots. Each lot contains below grade development within the required rear yard; therefore, a variance is required. Above grade the project will feature the following rear yard setbacks: 1000 Broadway - no rear yard at any level; 1010 Broadway - 15'; and, 1601-1625 Taylor Street -15'-1".

# ADDITIONAL INFORMATION

FOR MORE INFORMATION, PLEASE CONTACT PLANNING DEPARTMENT STAFF:Planner: Kate ConnerTelephone: 415-575-6914Mail: kate.conner@sfgov.org

**ARCHITECTURAL PLANS:** The site plan and elevations of the proposed project are available on the Planning Department's website at: <a href="http://sf-planning.org/ftp/files/notice/2006.1202V.pdf">http://sf-planning.org/ftp/files/notice/2006.1202V.pdf</a>

# **GENERAL INFORMATION ABOUT PROCEDURES**

### VARIANCE HEARING INFORMATION

Under Planning Code Section 306.3, you, as a property owner or resident within 300 feet of this proposed project or interested party on record with the Planning Department, are being notified of this Variance Hearing. You are not obligated to take any action. For more information regarding the proposed work, or to express concerns about the project, please contact the Applicant/Agent or Planner listed on this notice as soon as possible. Additionally, you may wish to discuss the project with your neighbors and neighborhood association or improvement club, as they may already be aware of the project.

Persons who are unable to attend the public hearing may submit written comments regarding this application to the Zoning Administrator, Planning Department, 1650 Mission Street, Suite 400, San Francisco, CA 94103, by 5:00pm the day prior to the hearing. These comments will be made a part of the official public record, and will be brought to the attention of the person or persons conducting the public meeting or hearing

### **BUILDING PERMIT APPLICATION INFORMATION**

Under Planning Code Section 311/312, the Building Permit Application for this proposal is also subject to a 30-day notification to occupants and owners within 150-feet of the subject property. The mailing of such notification will be perfromed separately.

### **BOARD OF APPEALS**

An appeal of the approval (or denial) of a **variance application** by the Zoning Administrator may be made to the **Board of Appeals within 10 days** after the **Variance Decision Letter** is issued by the Zoning Administrator.

An appeal of the approval (or denial) of a **building permit application** by the Planning Department may be made to the **Board of Appeals within 15 days** after the **building permit** is issued (or denied) by the Director of the Department of Building Inspection.

Appeals must be submitted in person at the **Board's office at 1650 Mission Street**, **3rd Floor**, **Room 304**. For further information about appeals to the Board of Appeals, including current fees, **contact the Board of Appeals** at **(415) 575-6880**.

### ABOUT THIS NOTICE

The Planning Department is currently reviewing its processes and procedures for public notification as part of the Universal Planning Notification (UPN) Project. The format of this Public Hearing notice was developed through the UPN Project and is currently being utilized in a limited trial-run for notification of Variance Hearings.

If you have any comments or questions related to the UPN Project or the format of this notice, please visit our website at <u>http://upn.sfplanning.org</u> for more information.



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P	PAGE & TURNBULL		
	ARCHITECTURE	HISTORIC PRESERVATION	URBAN DESIGN

# WYSTERIA RESIDENCES SAN FRANCISCO, CALIFORNIA DRAWING INDEX

# NEIGHBORHOOD CONTEXT

N001	SITE THEN & NOW
N002	BUILDINGS OPPOSITE TH
N003	CONTRIBUTORS TO HIST
N004	RECENT NEW CONSTRUC
	HISTORIC DISTRICT

# RENDERINGS

R001	RENDERINGS #1, #2, & #3
R004	BROADWAY STREETSCAPE
R005	TAYLOR STREETSCAPE

# ARCHITECTURAL

A100	SITE PLAN
A202 A203 A204 A205 A206 A207	GARAGE PLAN LEVEL ONE PLANS LEVEL TWO PLANS LEVEL THREE PLANS LEVEL FOUR PLANS
A302 A303 A304 A305 A401	EXTERIOR ELEVATIONS I EXTERIOR ELEVATIONS, 1 EXTERIOR ELEVATIONS, 1 BUILDING SECTIONS B-B BUILDING SECTIONS C-C

# PROJECT DIRECTORY

OWNER WYSTERIA HOLDINGS LLC. 600 Montgomery Street 39th Floor San Francisco, California 94111 t: 415.568.2760 Frank Cupido / Medley Capital

THIS SITE STORIC DISTRICT UCTION WITHIN

CODE COMPLIANCE ANALYSIS

C002 CODE COMPLIANCE - BROADWAY HEIGHT & SETBACK ANALYSIS C003 CODE COMPLIANCE - TAYLOR STREET HEIGHT& SETBACK ANALYSIS CODE COMPLIANCE - NORTH ELEVATION HEIGHT& SETBACL ANALYSISCODE COMPLIANCE - WEST ELEVATION HEIGHT & SETBACK ANALYSIS

I TAYLOR STREET I BROADWAY I WEST , 1601/1625 TAYLOR I NORTH AND SOUTH , 1010 BROADWAY I NORTH AND EAST

ARCHITECT PAGE & TURNBULL 1000 Sansome St. Suite 200 San Francisco, California 94111 t: 415.362.5154 f: 415.362.5560 Lada Kocherovsky

CODE

A.R.SANCHEZ-COREA, INC. 301 Junipero Serra Blvd. San Francisco, California 94127 t: 415.333.8080 f: 415. Tony Sanchez-Corea



\ PHOTO MONTAGE FROM OPPOSITE CORNER OF BROADWAY AND TAYLOR

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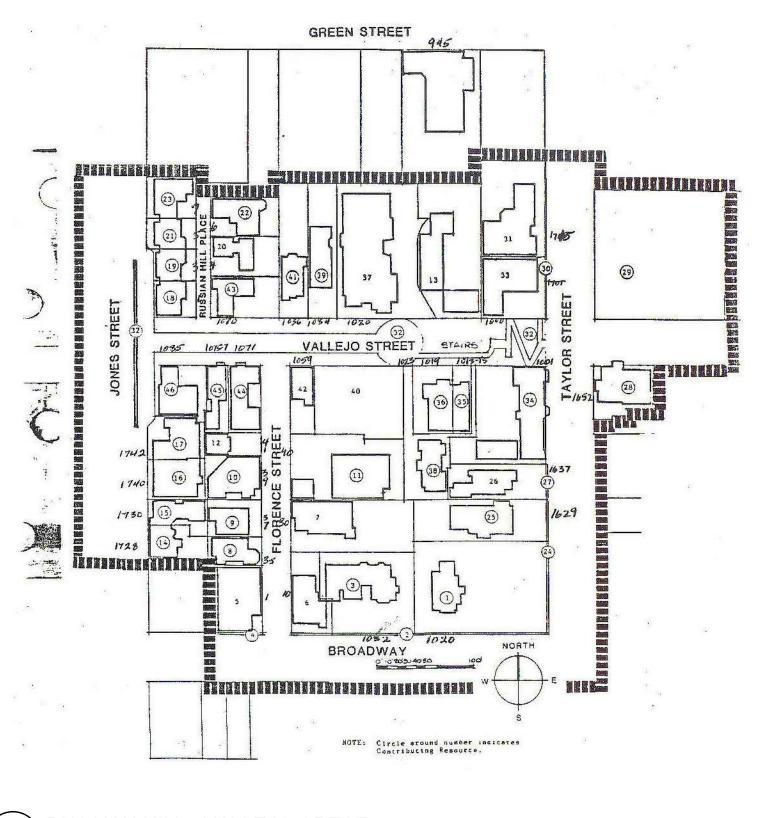


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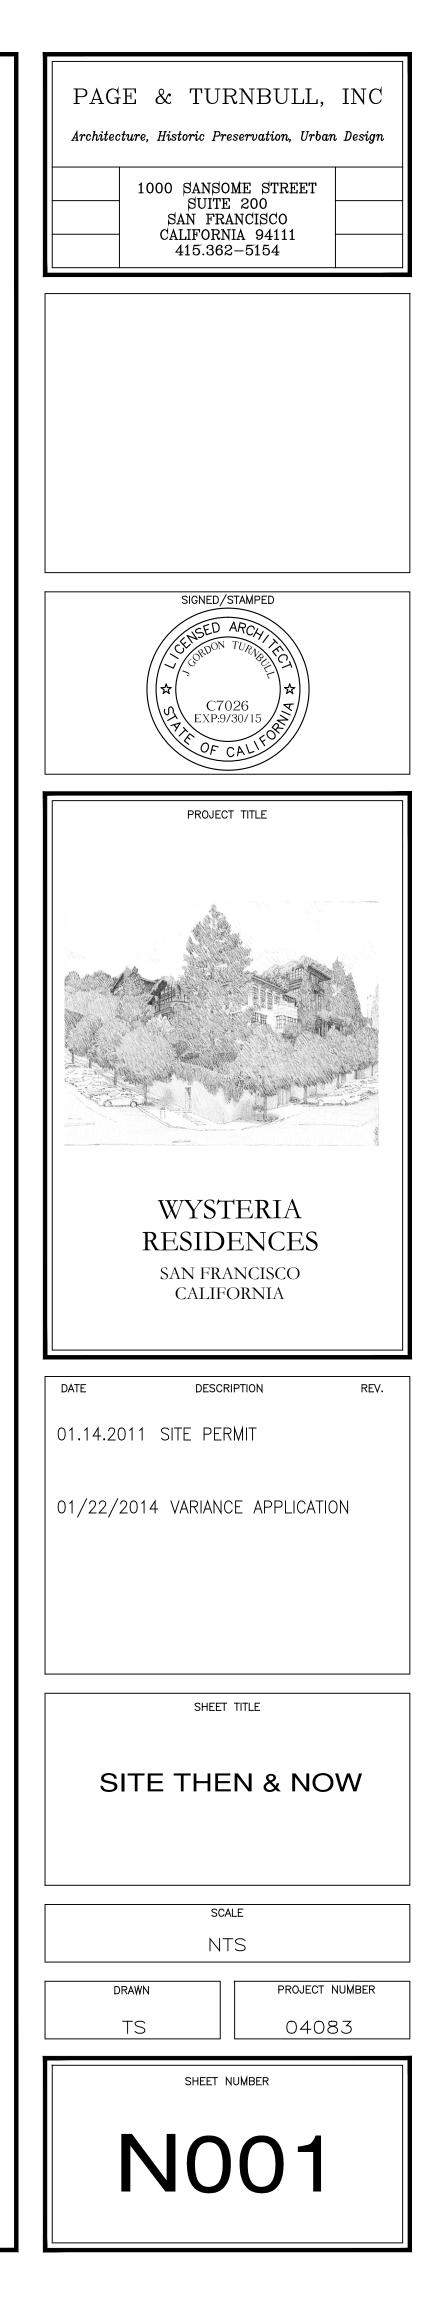
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HOMER HOUSE (1853, DEMOLISHED 1910), CIRCA 1898 




NATIONAL REGISTER HISTORIC DISTRICT MAP 





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PAGE & TURNBULL, INC Architecture, Historic Preservation, Urban Design 1000 SANSOME STREET SUITE 200 SAN FRANCISCO
CALIFORNIA 94111 415.362-5154
SIGNED/STAMPED
PROJECT TITLE
WYSTERIA RESIDENCES SAN FRANCISCO CALIFORNIA
DATE DESCRIPTION REV.
01.14.2011 SITE PERMIT
01/22/2014 VARIANCE APPLICATION
SHEET TITLE
NEIGHBORHOOD CONTEXT: BUILDINGS OPPOSITE THE SITE
scale NTS
DRAWN PROJECT NUMBER
TS 04083
sheet number

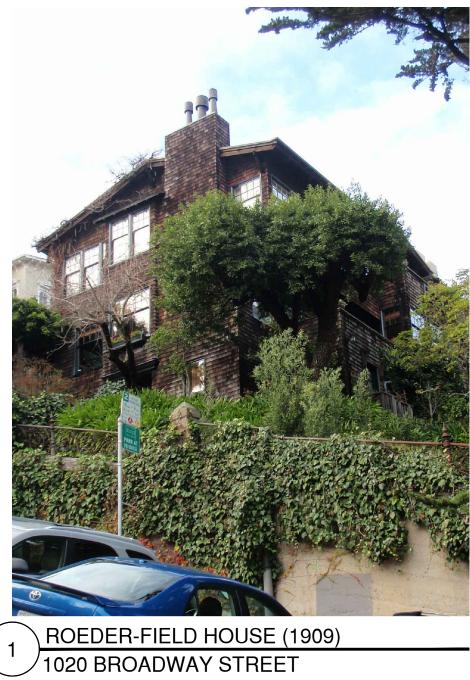

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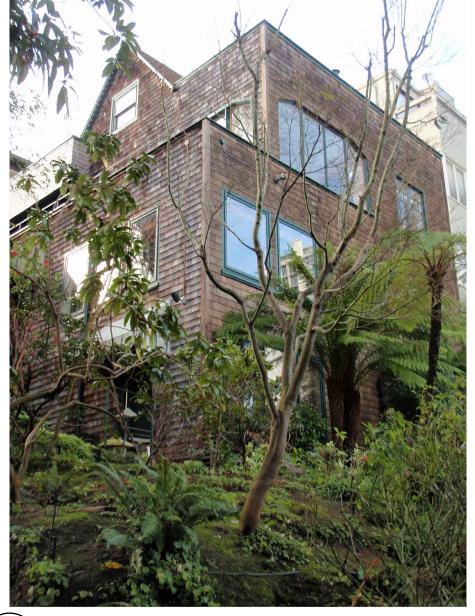
HANFORD-VERDIER MANSION (1905-1906) 1001 VALLEJO STREET 4



LIVERMORE-MCCALL HOUSE II (1915) 1742 JONES STREET

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PARKER-HOMER HOUSE (1909) 1629 TAYLOR STREET 2






5 HORATIO PUTNAM LIVERMORE RESIDENCE (CA. 1857/97) 40 FLORENCE STREET



LIVERMORE POLK HOUSES I-IV (1915-191) 1 - 7 RUSSIAN HILL PLACE 6

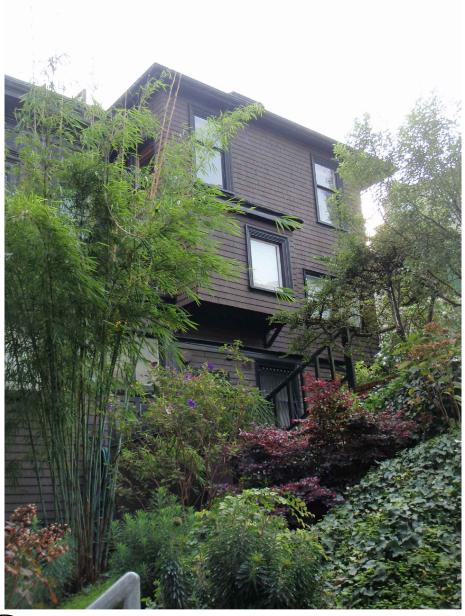

HOUSE OF THE FLAG (1864 / 1903) 1652-1656 TAYLOR STREET 8


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	PROJECT TITLE
Initial       Date         01.14.2011	<image/> <section-header><section-header></section-header></section-header>
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# THE HERMITAGE (1984) 1020 VALLEJO STREET

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HOUSE (1954, TOP FLOOR ADDED CA. 1999) 1059 VALLEJO STREET 4



1032 BROADWAY STREET (PARKER-ATKINSON RETAININGWALL)


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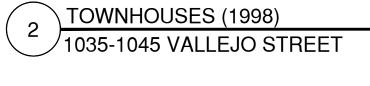


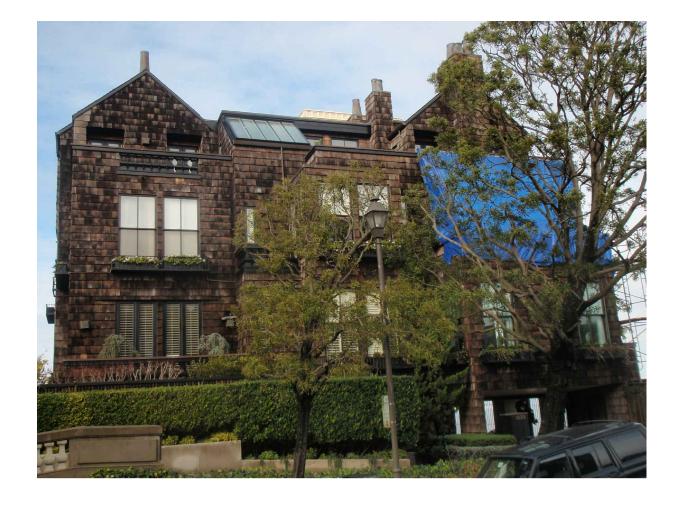
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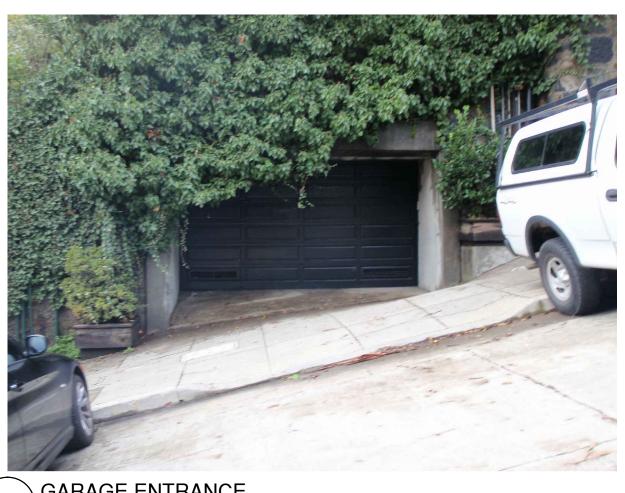
PEDESTRIAN ENTRANCE 1020 BROADWAY STREET (PARKER-ATKINSON RETAINING WALL) 5



6 PEDESTRIAN ENTRANCE 1637 TAYLOR ST. (SAMUEL P. THELLER RETAINING WALL)

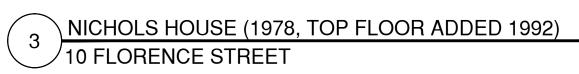

GARAGE ENTRANCE 8 1001 VALLEJO STREET (HANFORD-VERDIER RETAINING WALL)

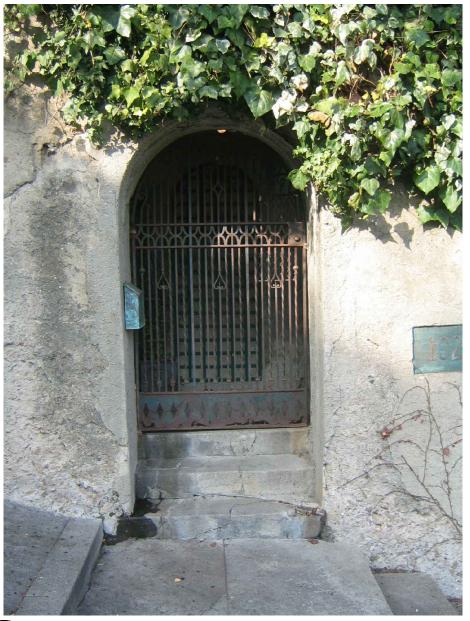

GARAGE ENTRANCE 9 1637 TAYLOR STREET (SAMUEL P. THELLER RETAINING WALL)

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PAGE & TURNBULL, INC Architecture, Historic Preservation, Urban Design 1000 SANSOME STREET SUITE 200 SAN FRANCISCO CALIFORNIA 94111 415.362-5154
SIGNED/STAMPED
PROJECT TITLE
WYSTERIA RESIDENCES san francisco california
DATE DESCRIPTION REV.
01.14.2011 SITE PERMIT
01/22/2014 VARIANCE APPLICATION
SHEET TITLE RECENT NEW CONSTRUCTION WITHIN HISTORIC DISTRICT
SCALE NTS
DRAWN PROJECT NUMBER
TS 04083
SHEET NUMBER



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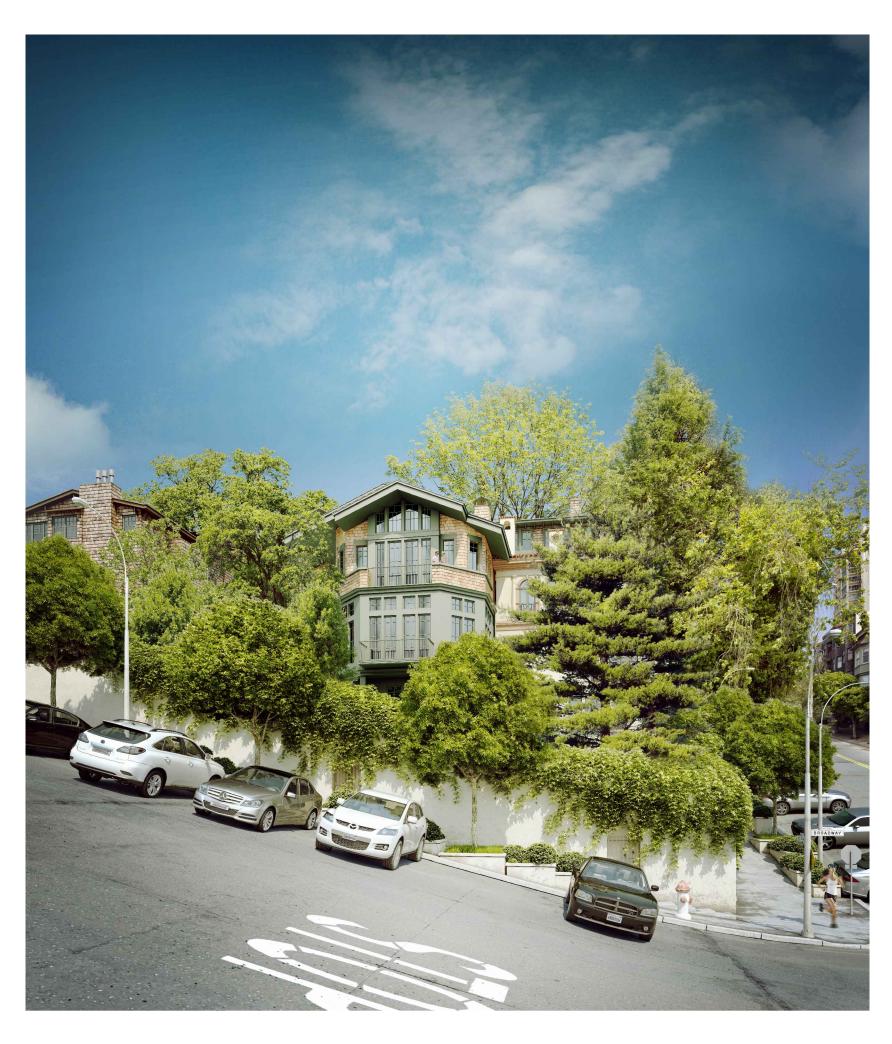
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RENDERING #1 - FROM OPPOSITE CORNER OF BROADWAY AND TAYLOR




2 RENDERING #2 - FROM BROADWAY STREET

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NOTE: ALL RENDERINGS HAVE BEEN CONSTRUCTED ATOP A THREE DIMENSIONAL COMPUTER AIDED DESIGN (CAD) MODEL DERIVED FROM THE PROJECT'S ARCHITECTURAL CAD DRAWINGS. THE 3D MODEL HAS BEEN VARIOUSLY ROTATED TO SIMULATE THE VIEW FROM EYE LEVEL AT POINTS SHOWN ON THE POINT OF VIEW MAP. ALL GREENERY SHOWN IS AS SPECIFIED ON THE LANDSCAPE PLAN.

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PAGE & TURNBULL, INC Architecture, Historic Preservation, Urban Design
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PROJECT TITLE
WYSTERIA
RESIDENCES SAN FRANCISCO CALIFORNIA
DATE DESCRIPTION REV. 01.14.2011 SITE PERMIT
01/22/2014 VARIANCE APPLICATION
SHEET TITLE
RENDERINGS
#1, #2, & #3
SCALE
DRAWN PROJECT NUMBER CL, JCR, SY 12219
SHEET NUMBER
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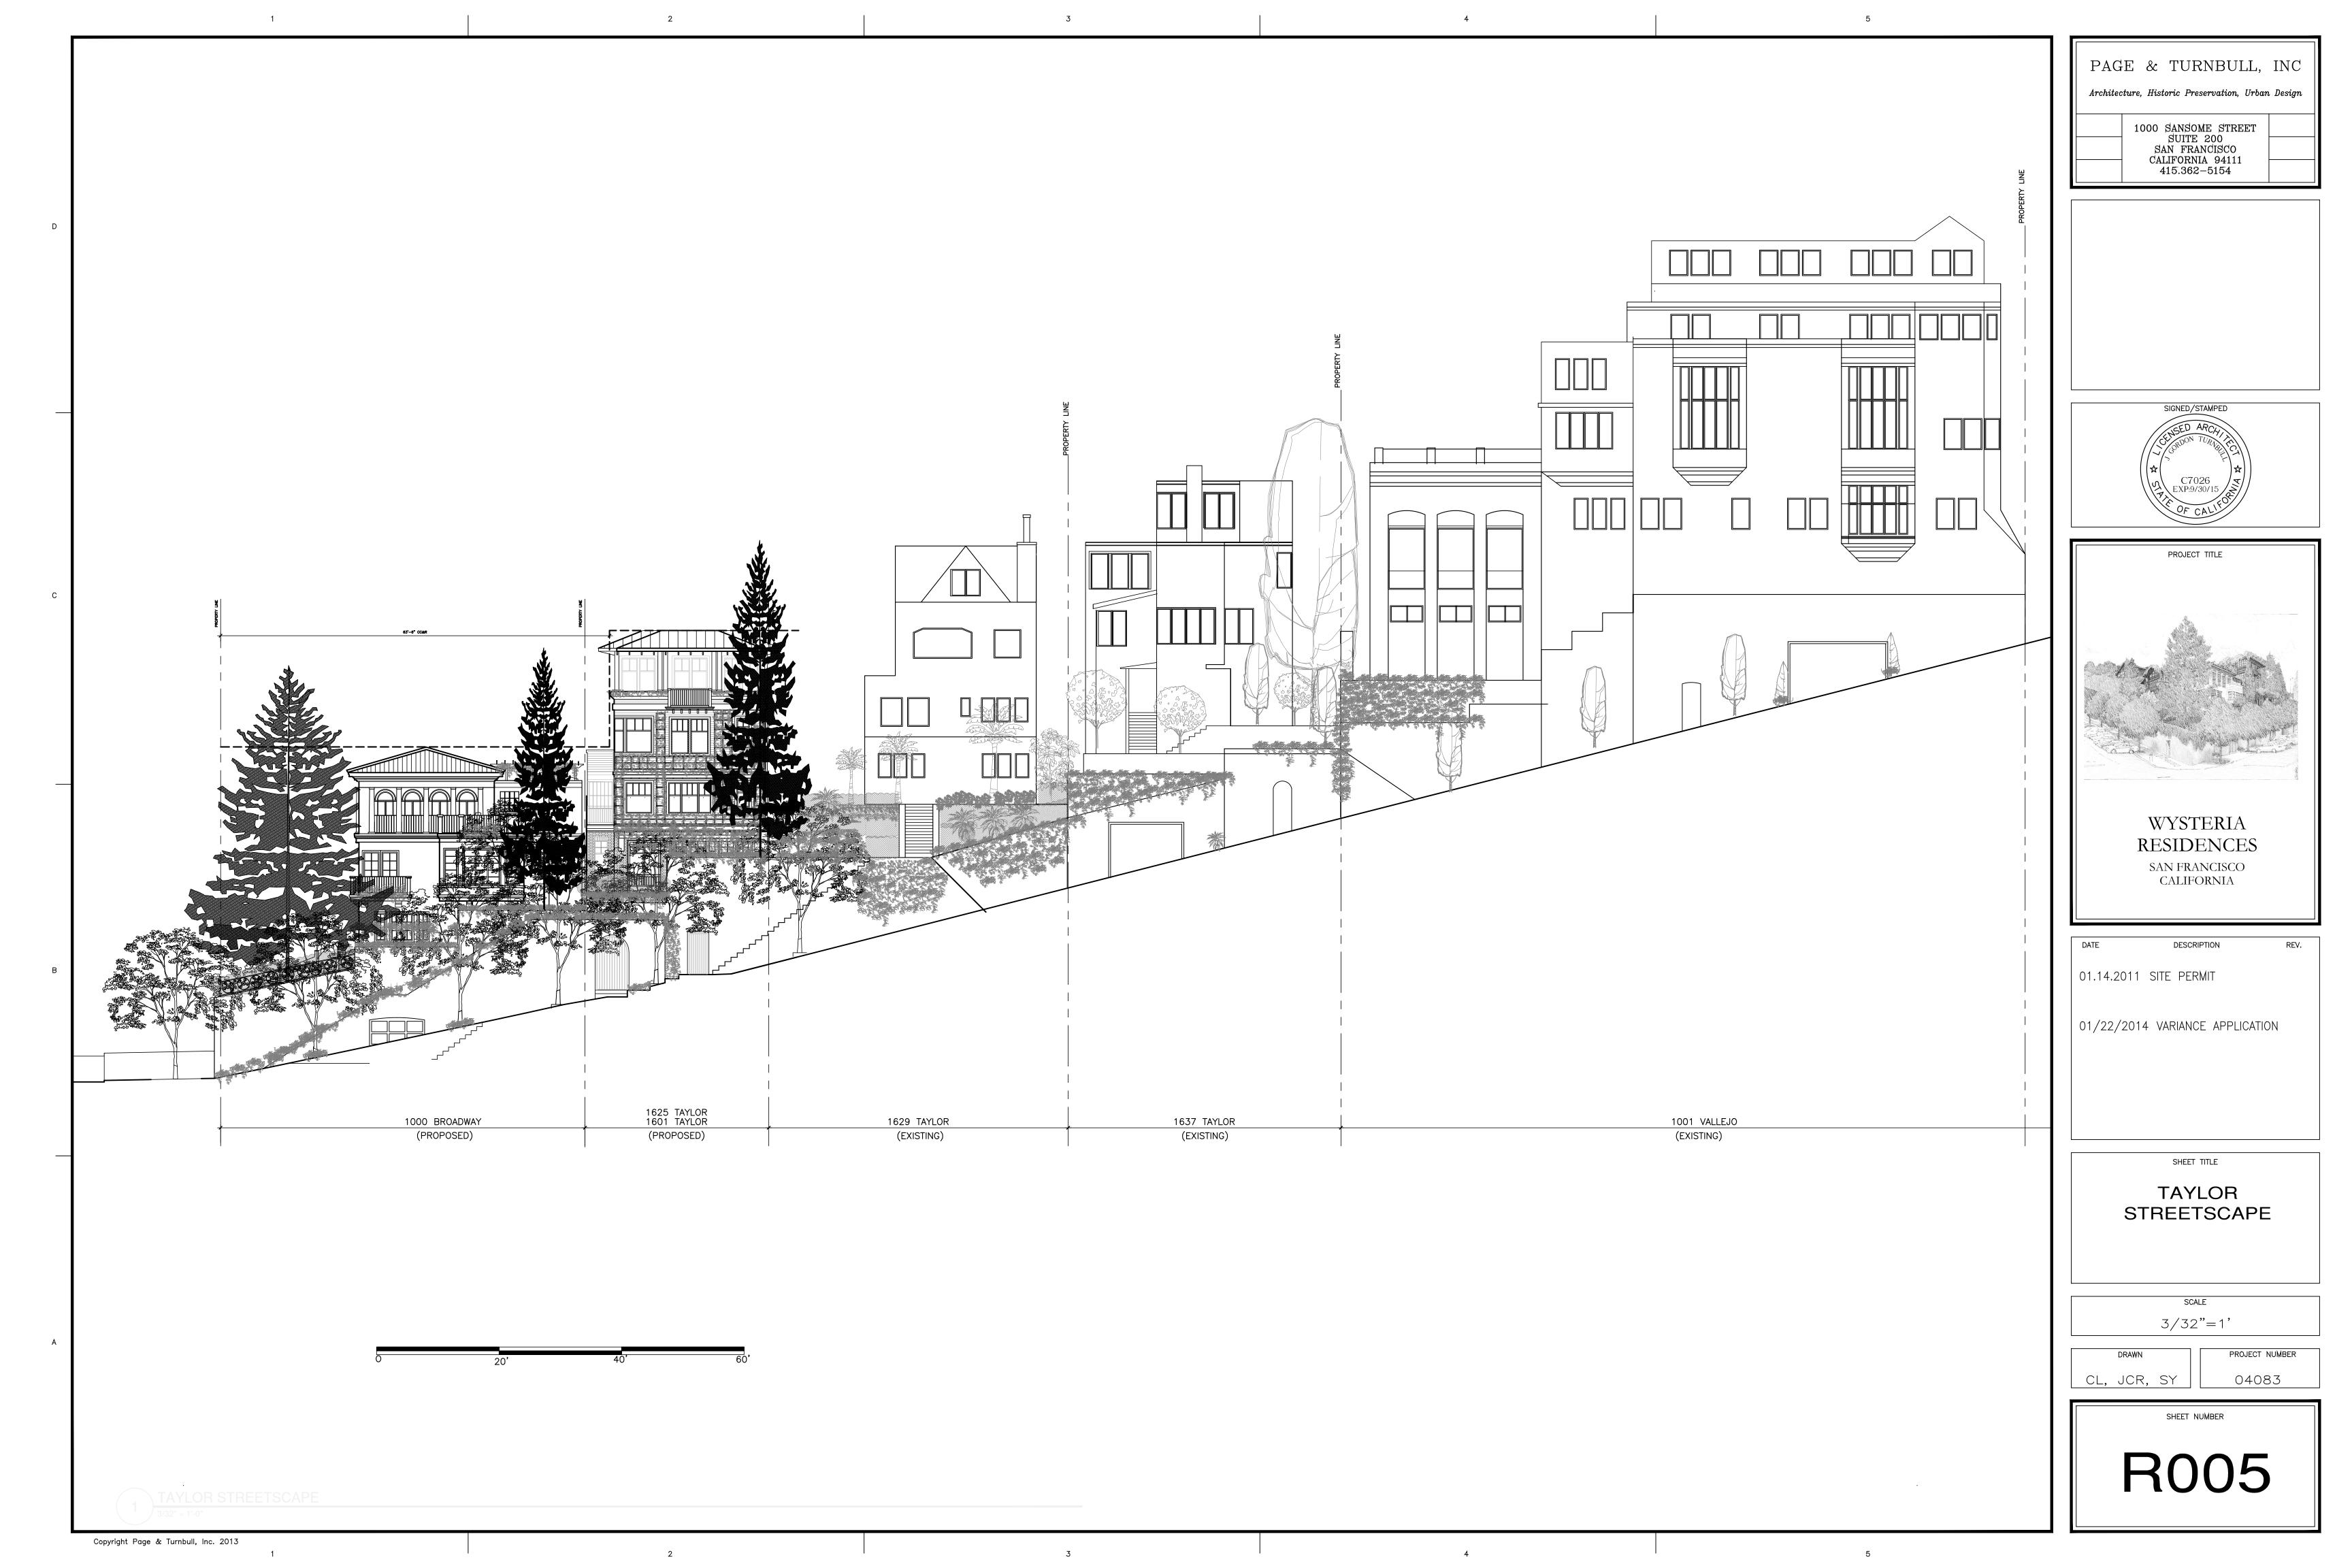
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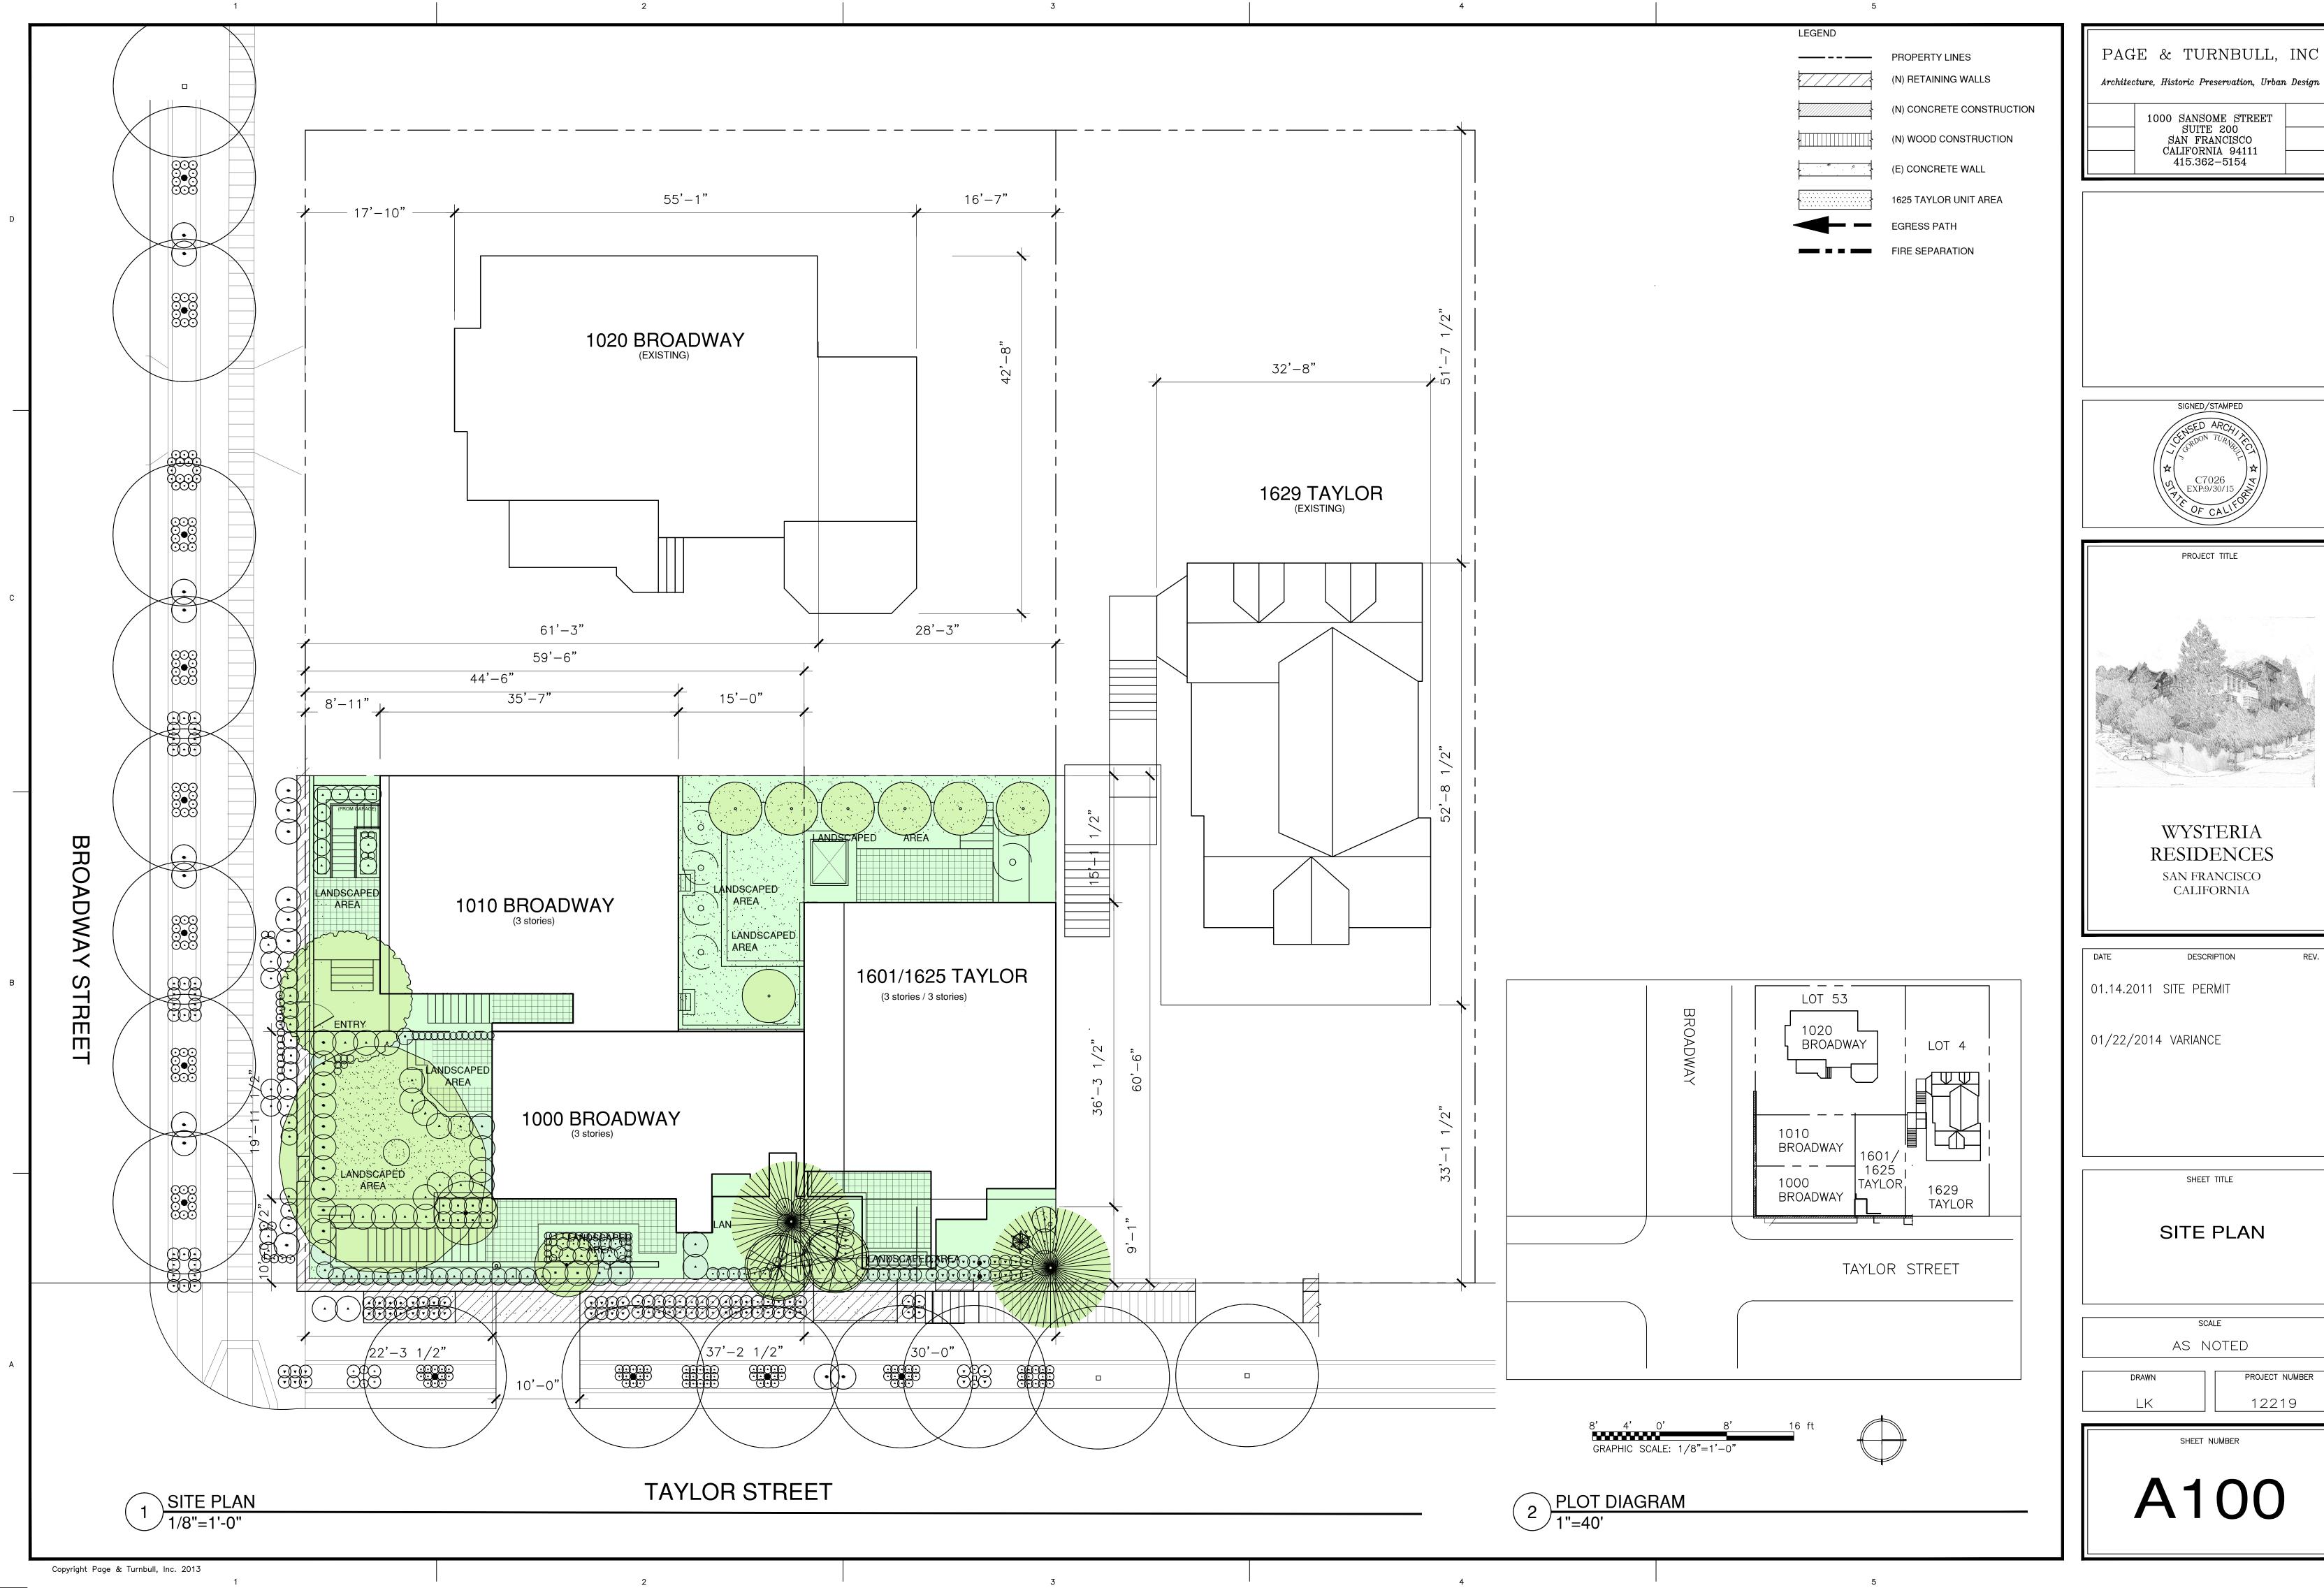
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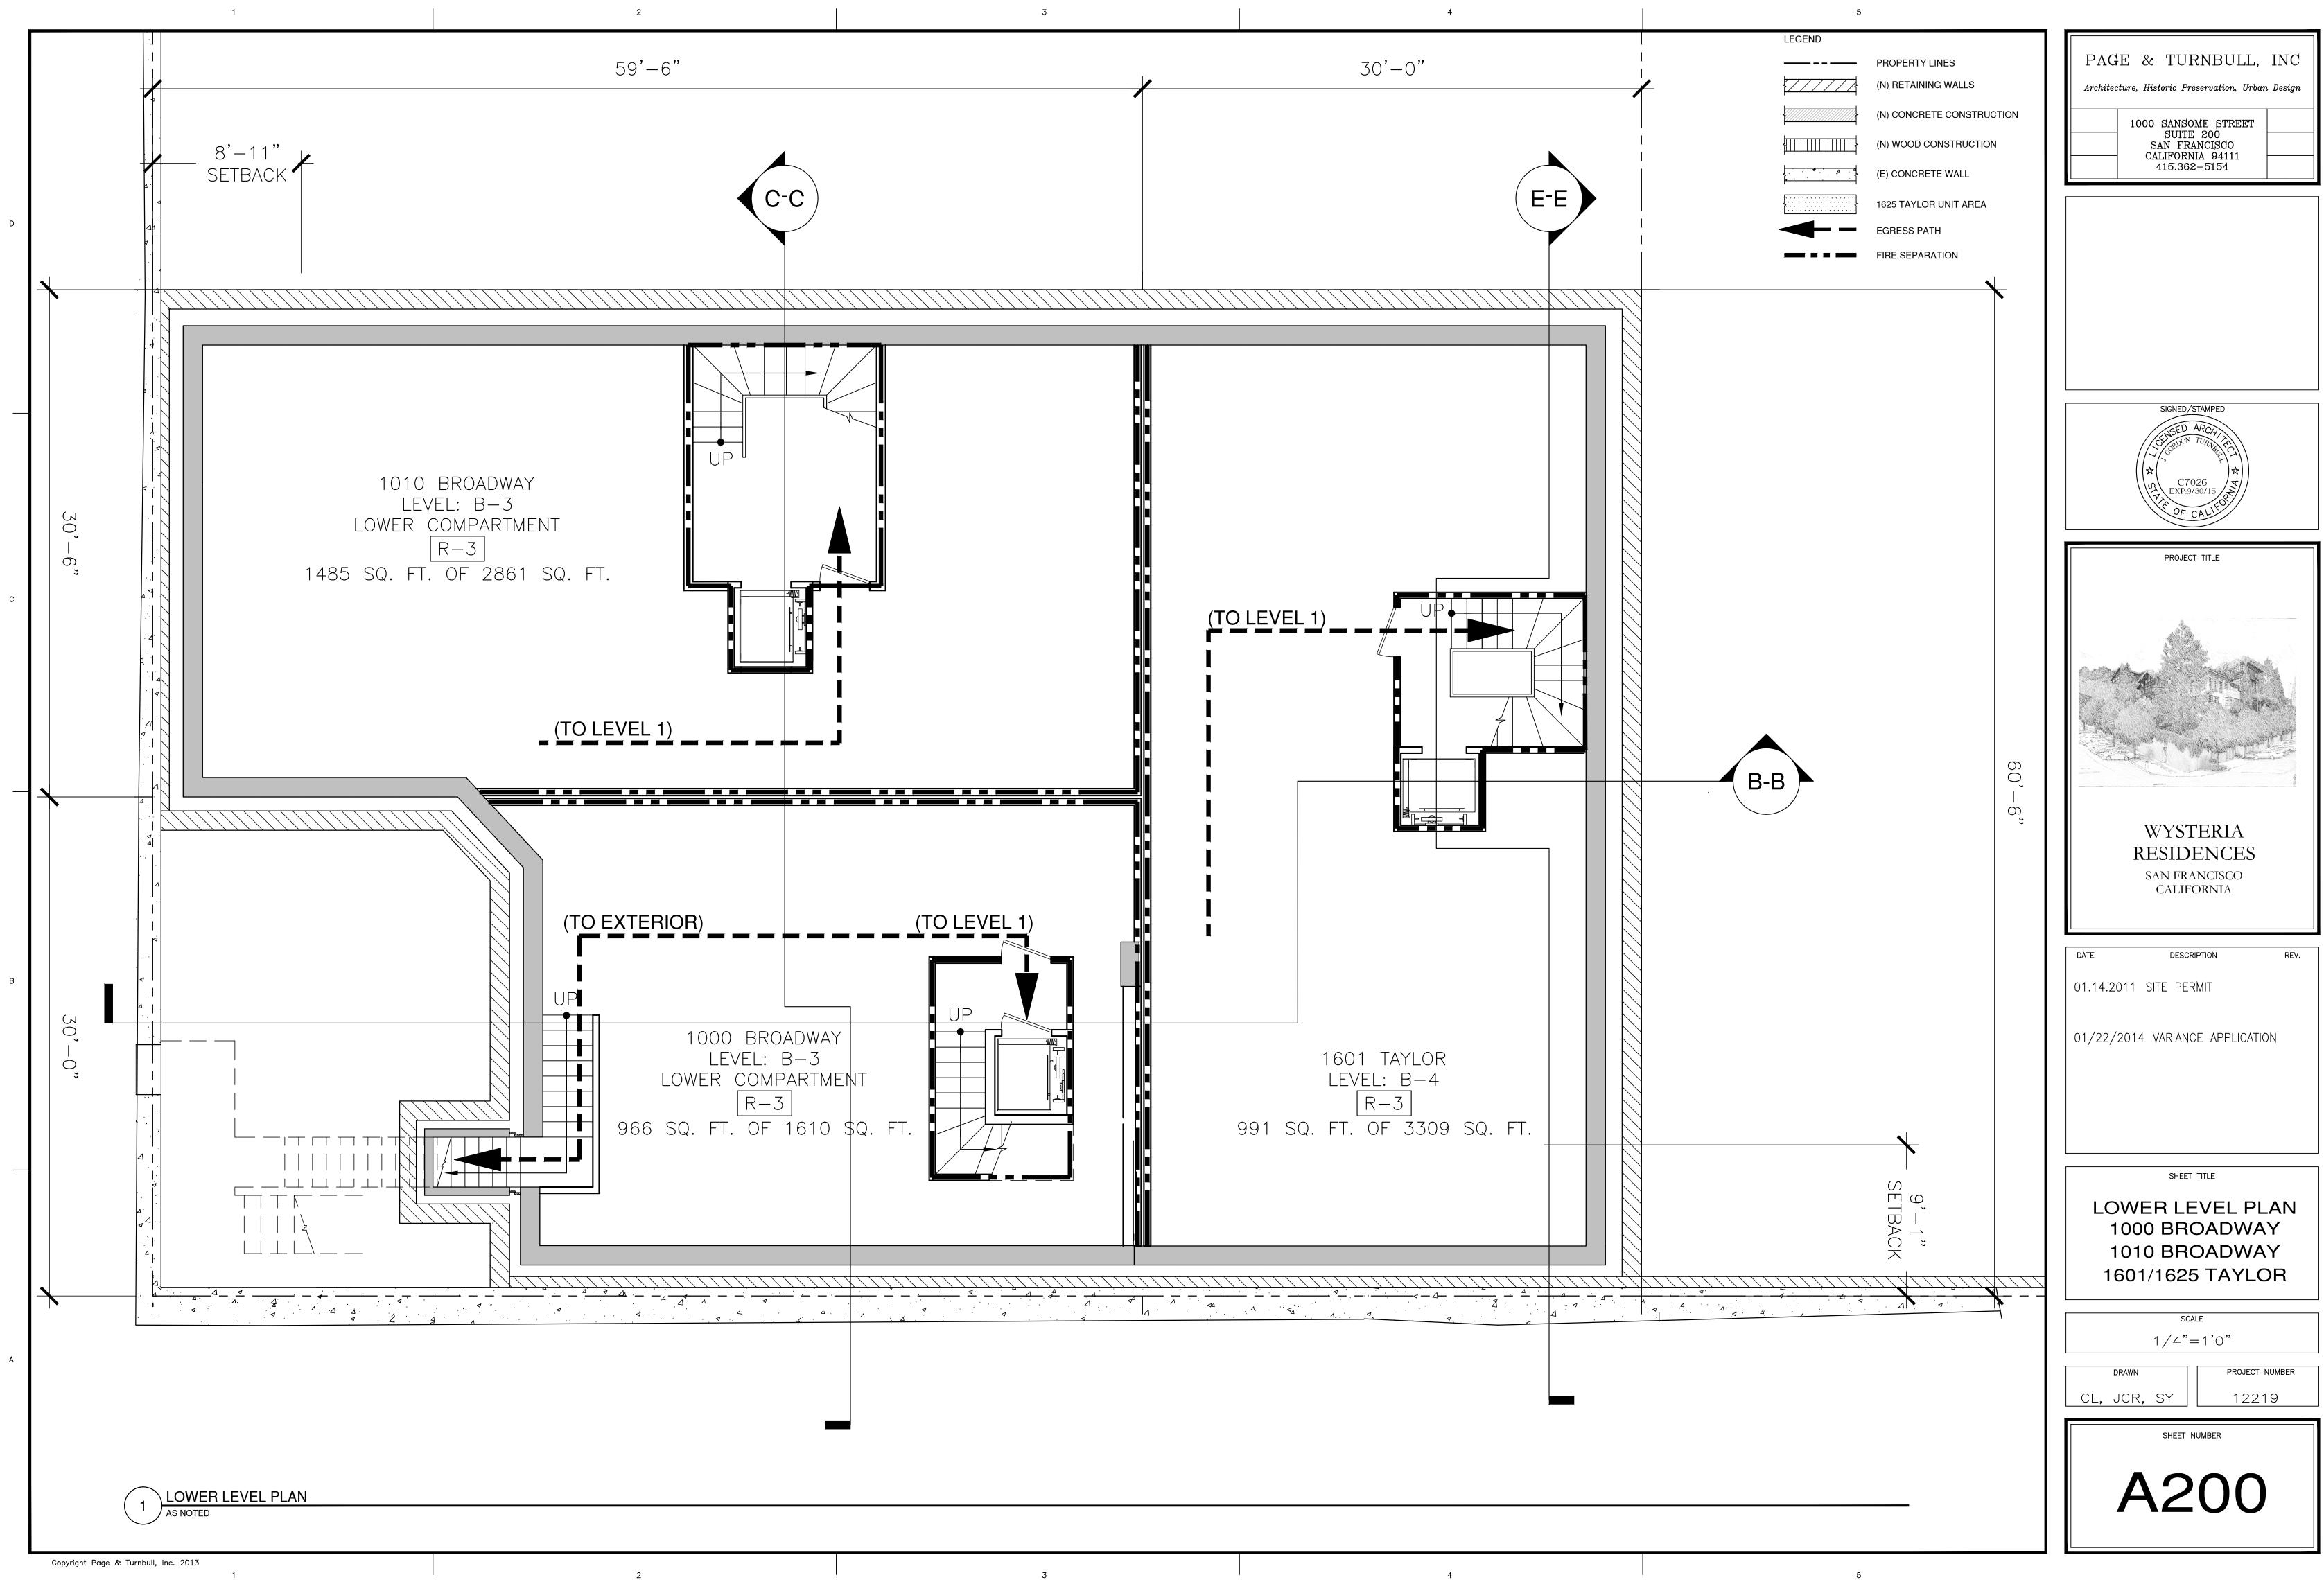
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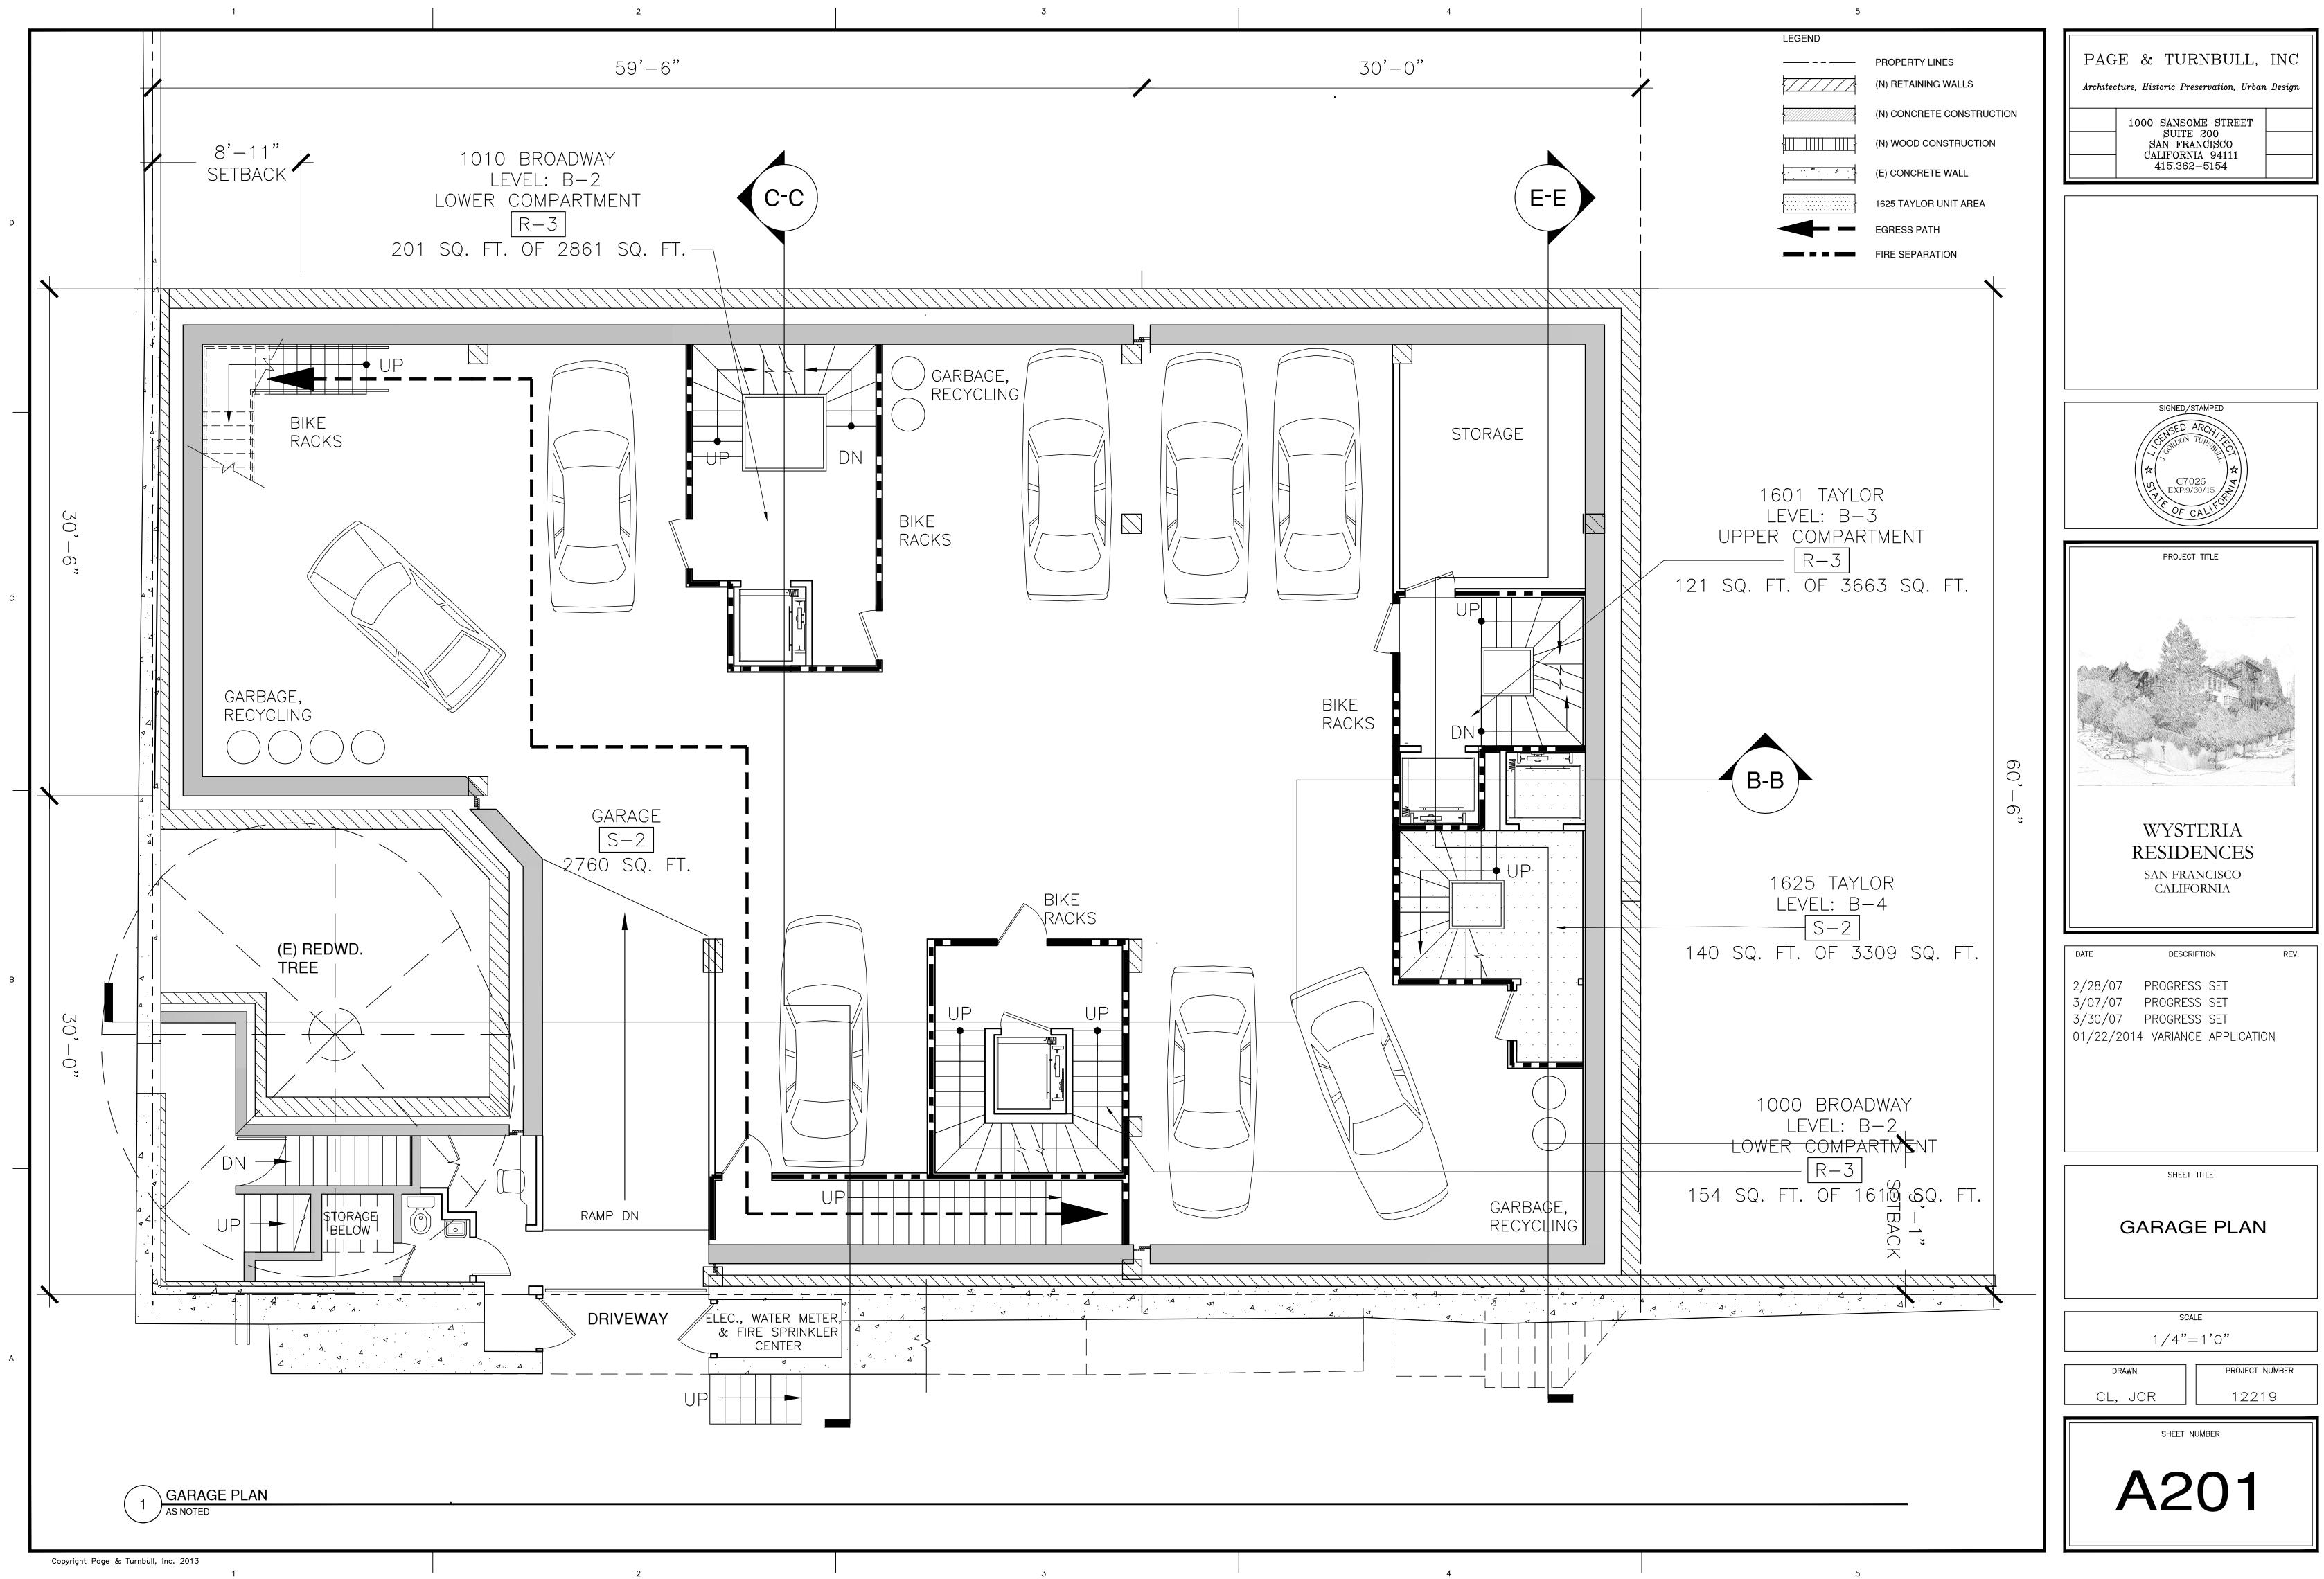
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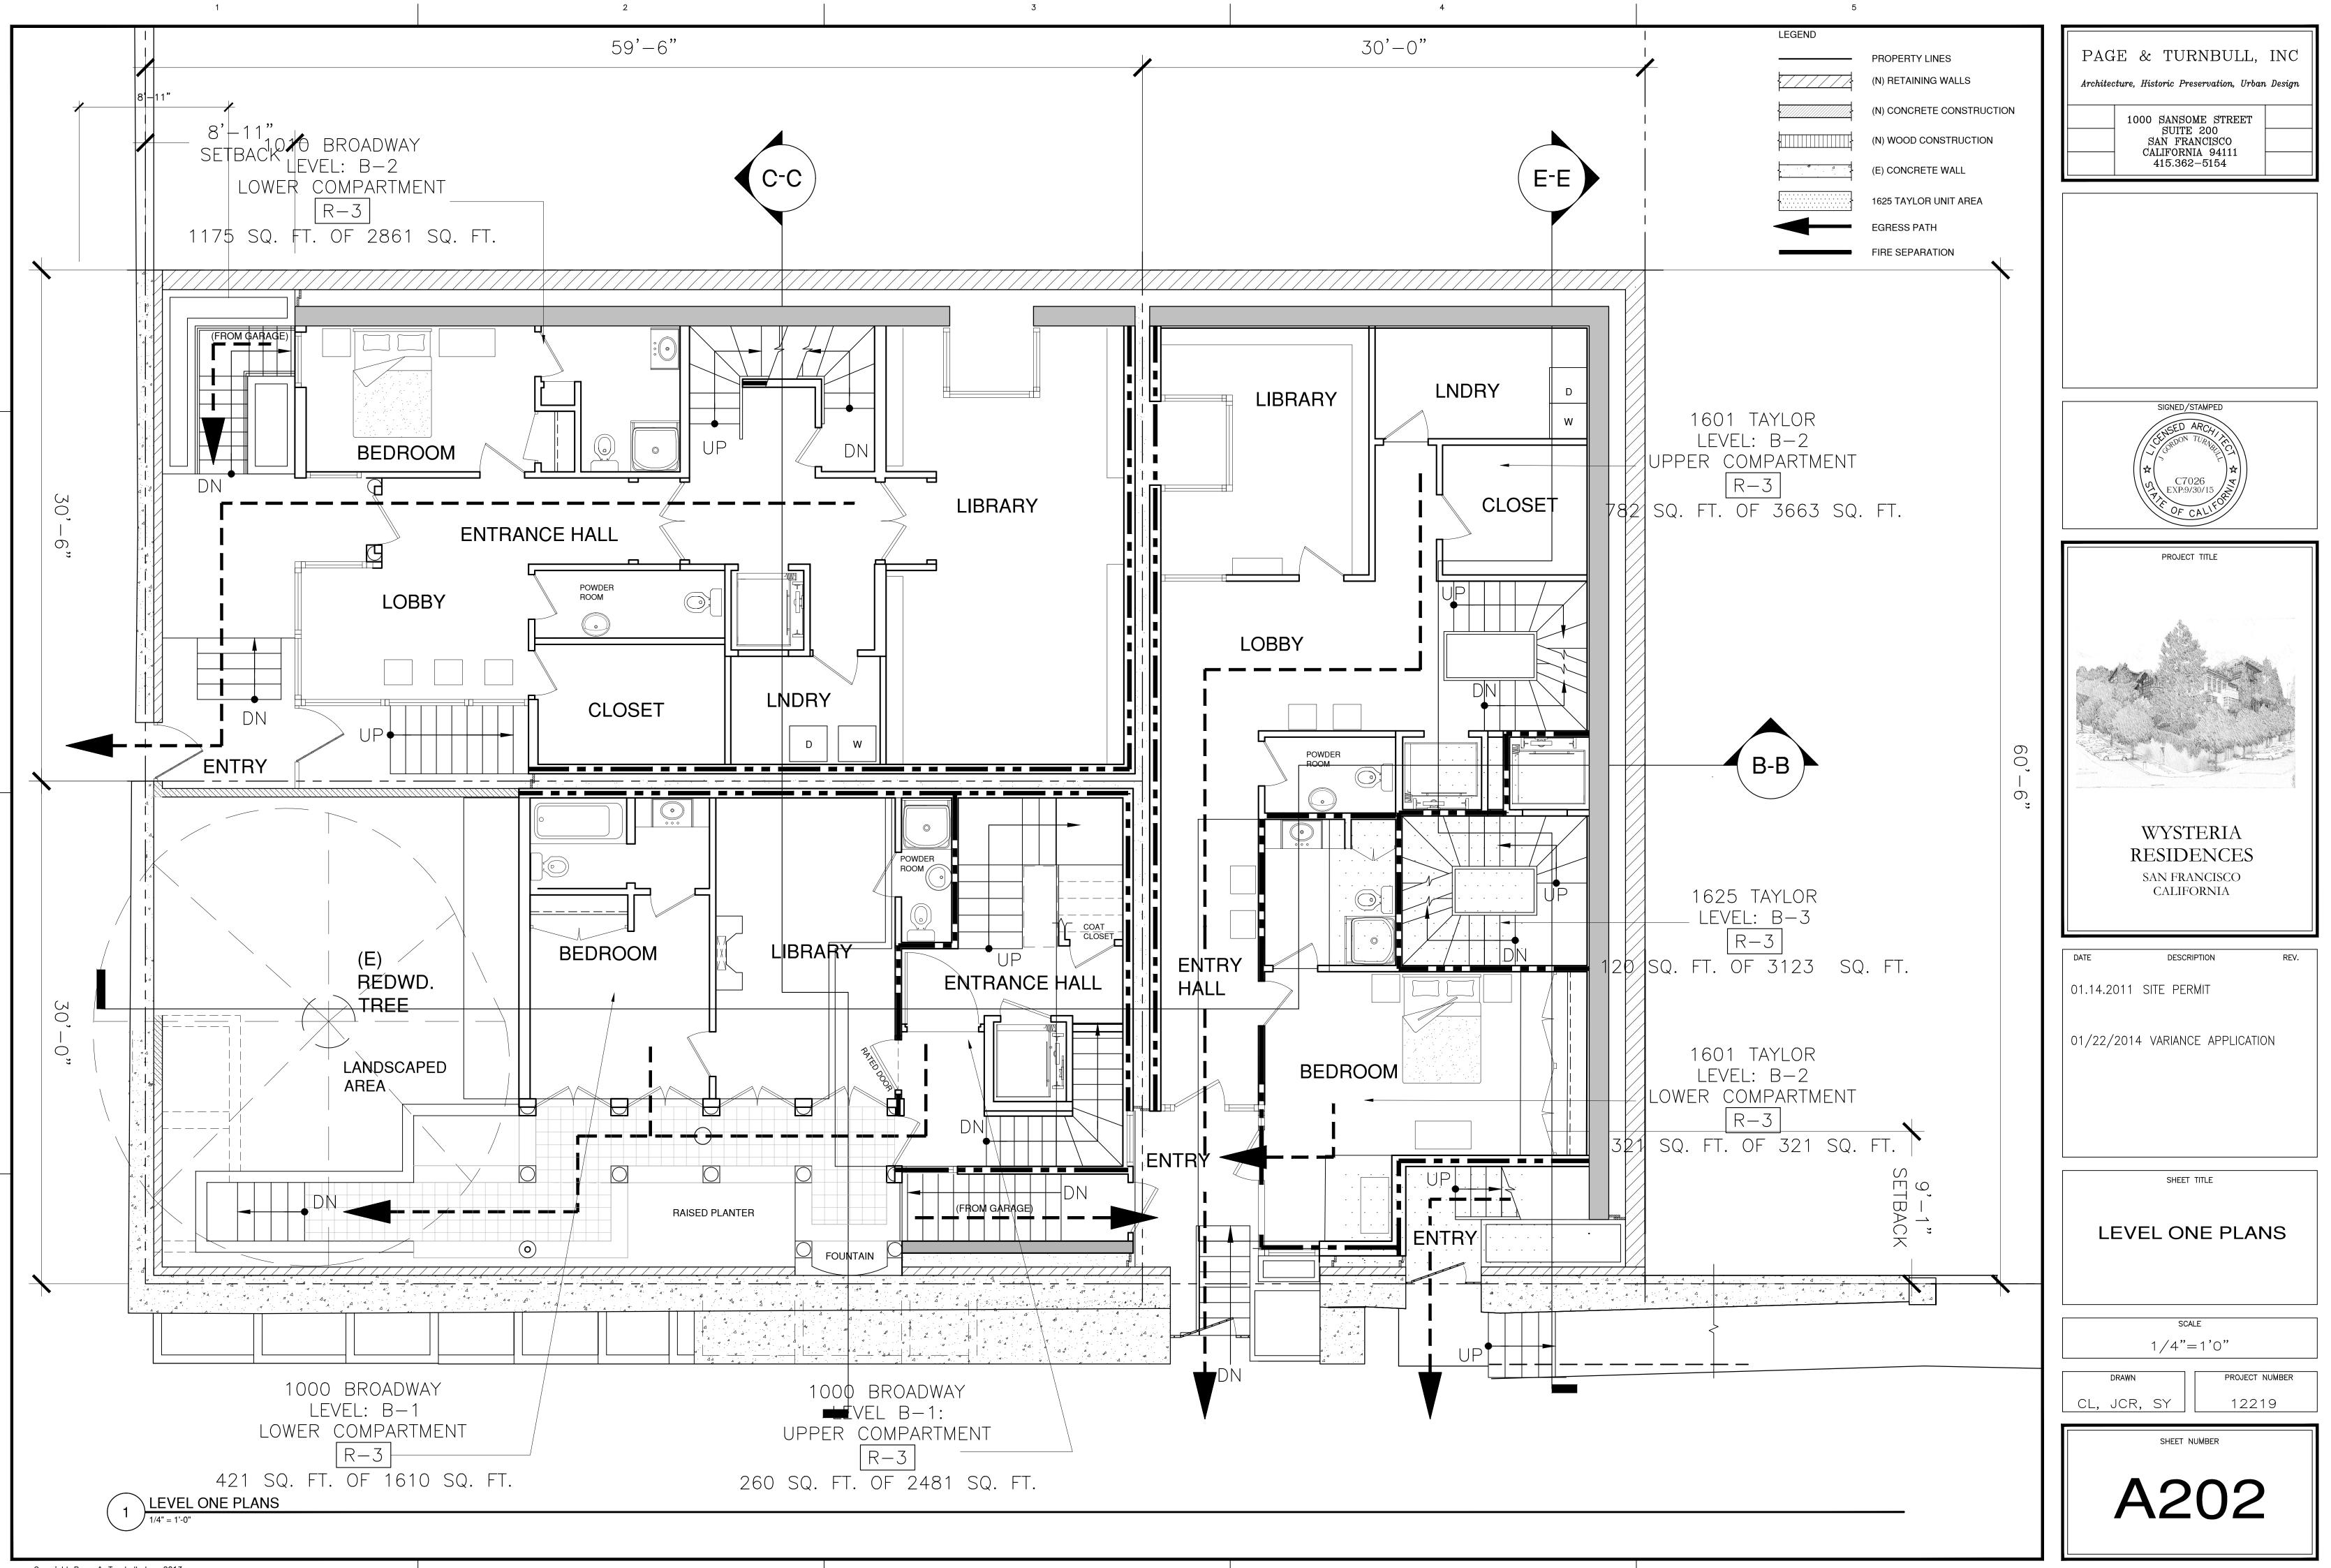
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DO BROADWAY PROPOSED)	01/22/2014 VARIANCE APPLICATION
	SHEET TITLE BROADWAY STREETSCAPE
	SCALE 3/32"=1' DRAWN CL, JCR, SY 04083
	sheet NUMBER






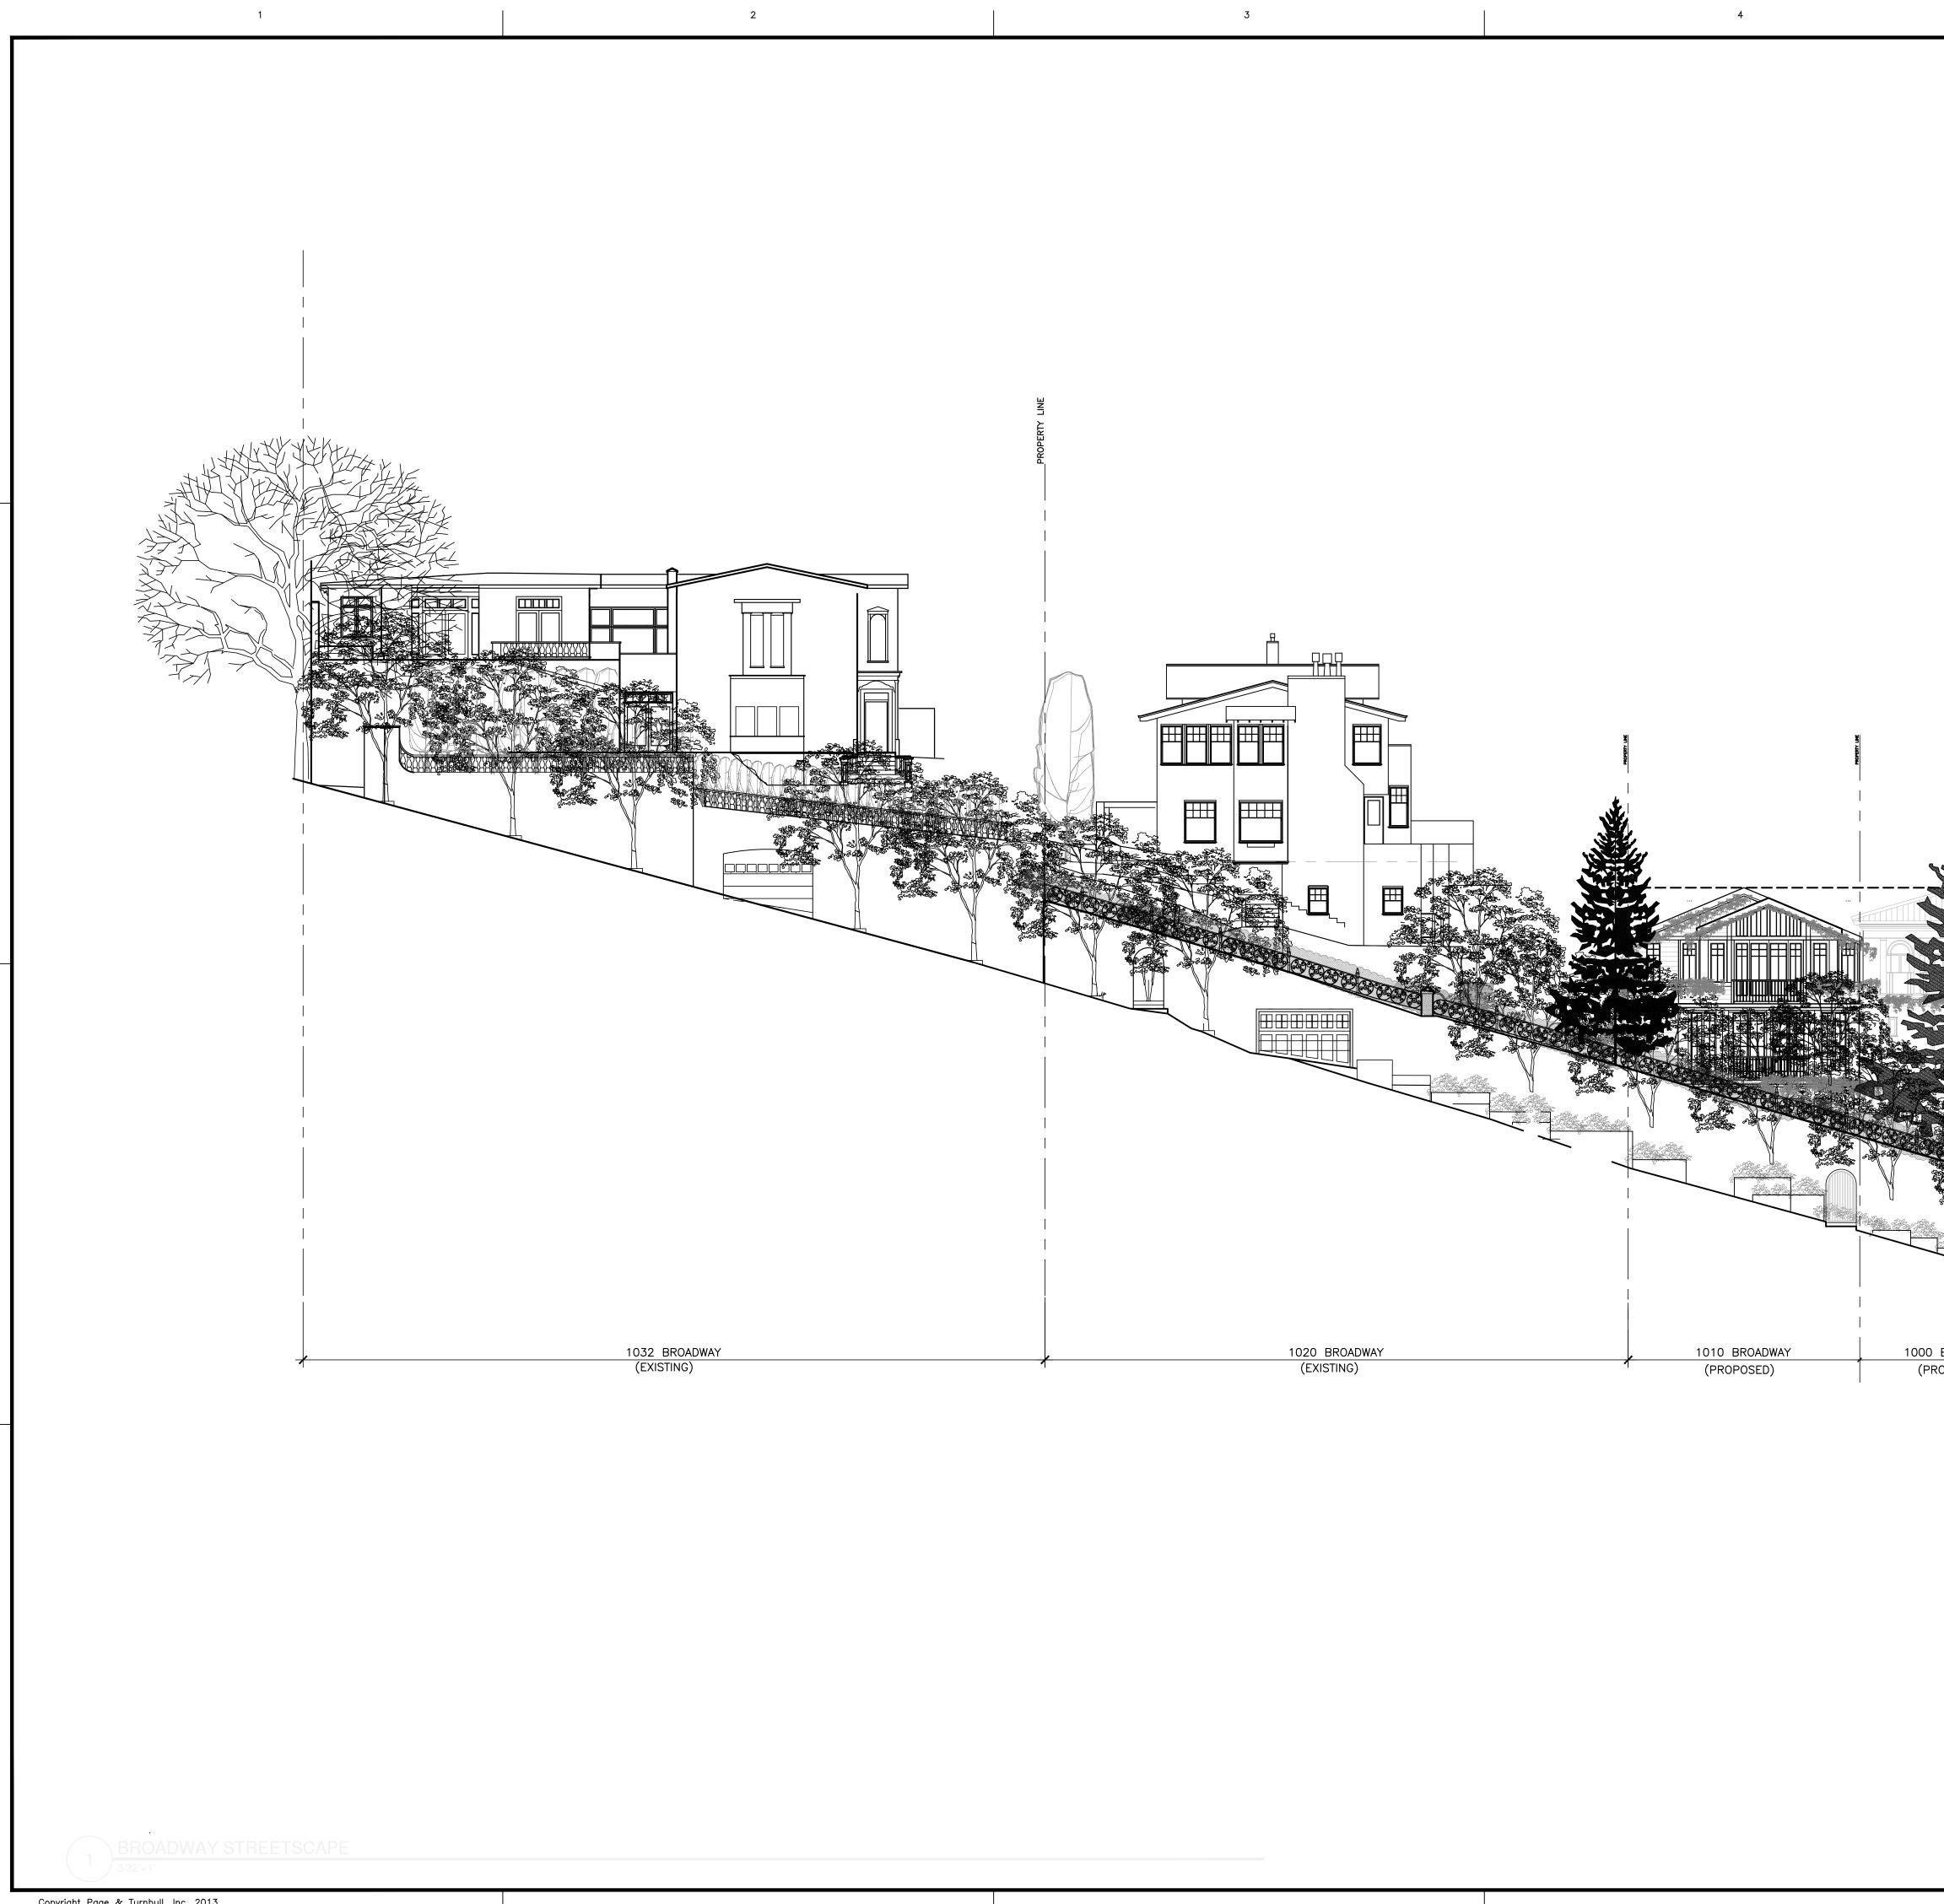








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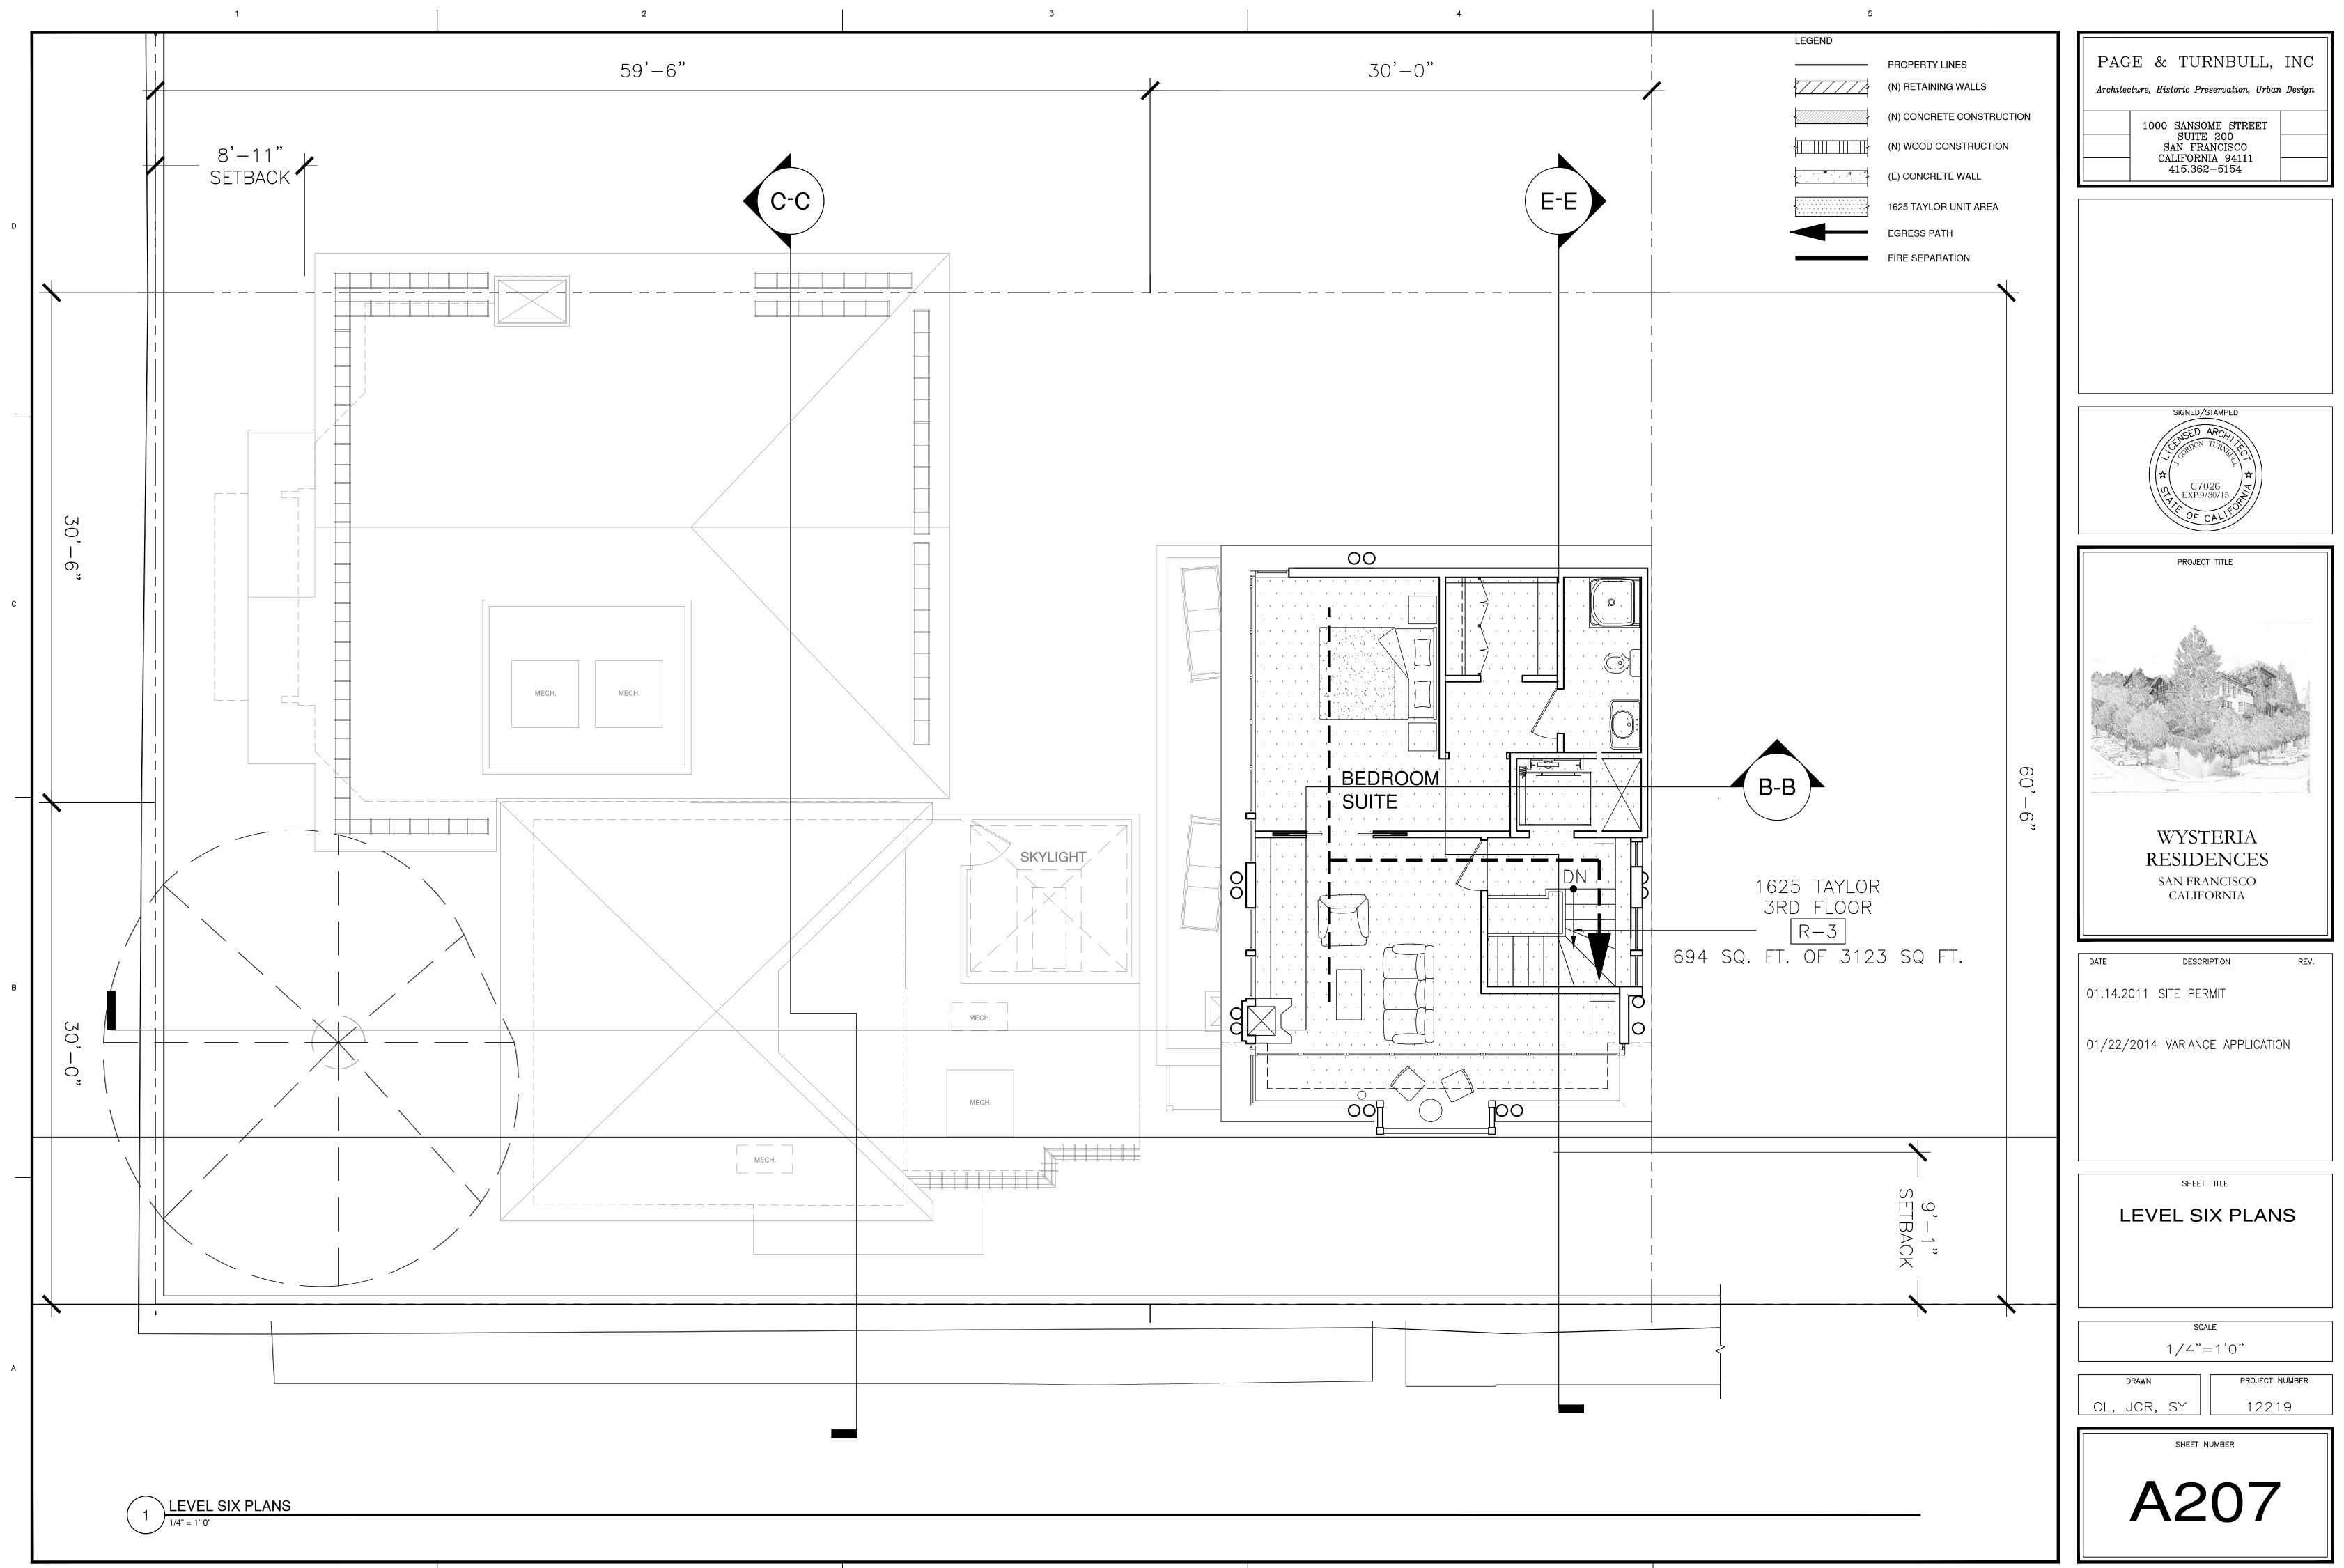


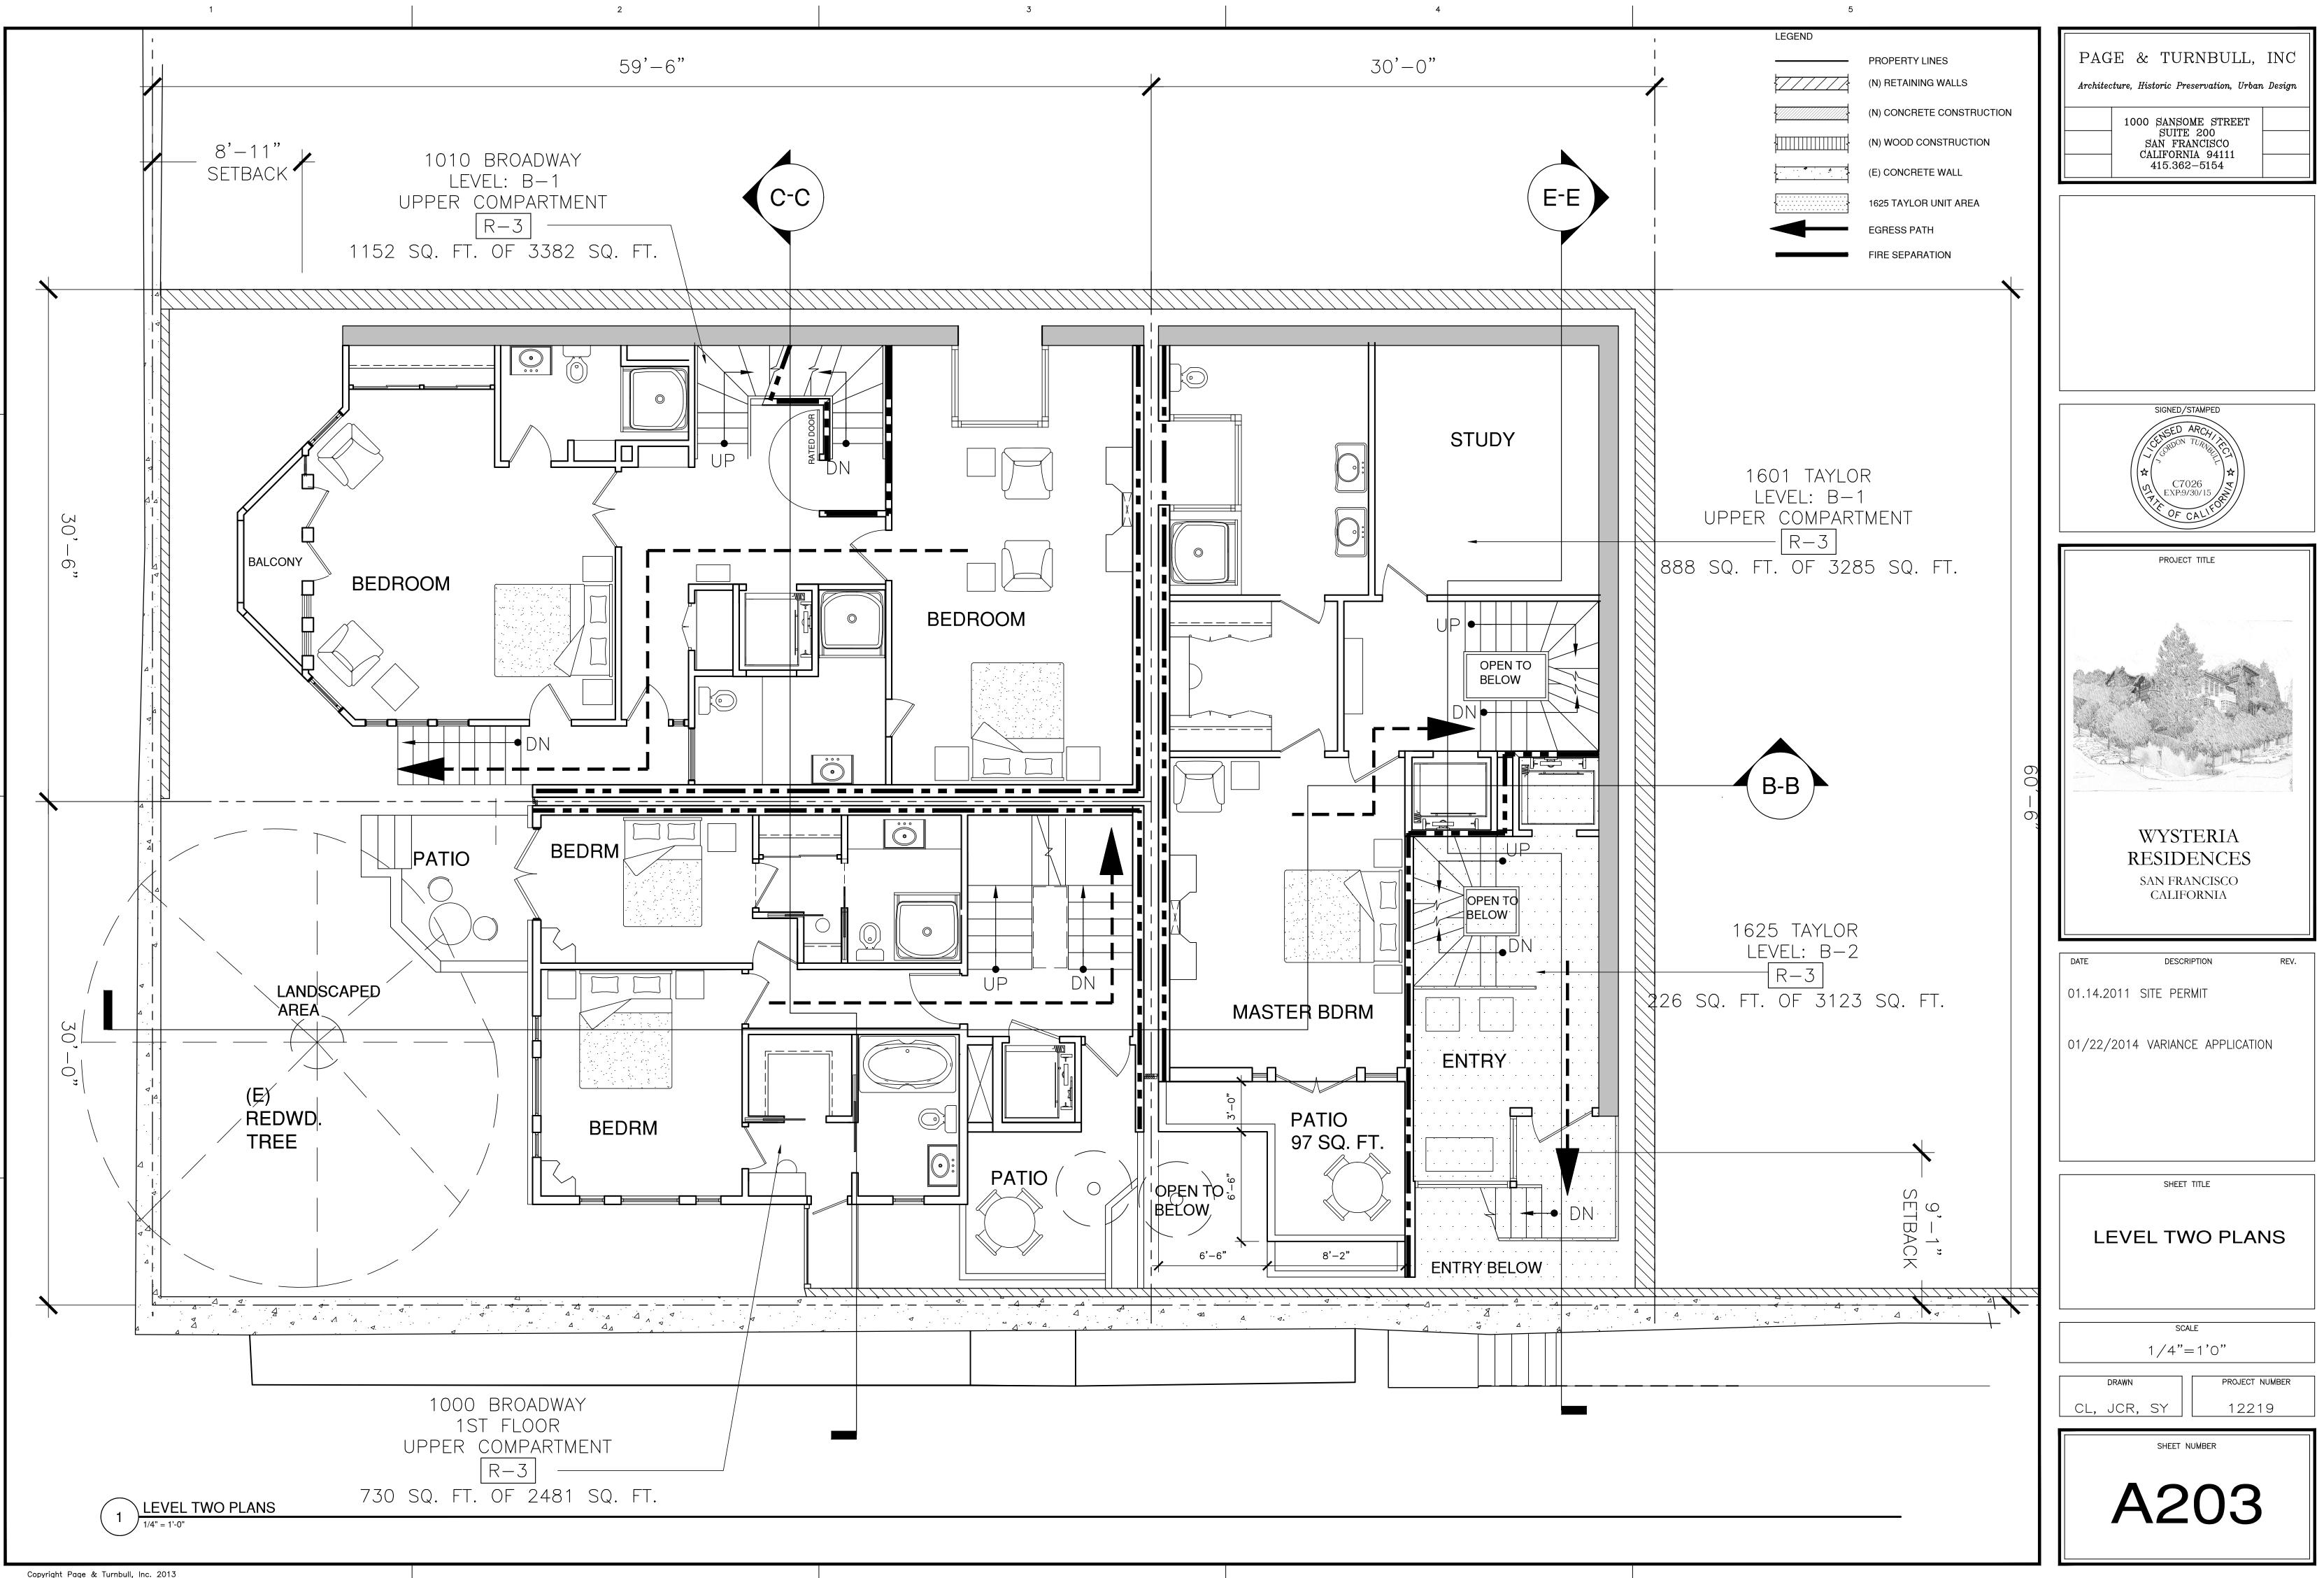
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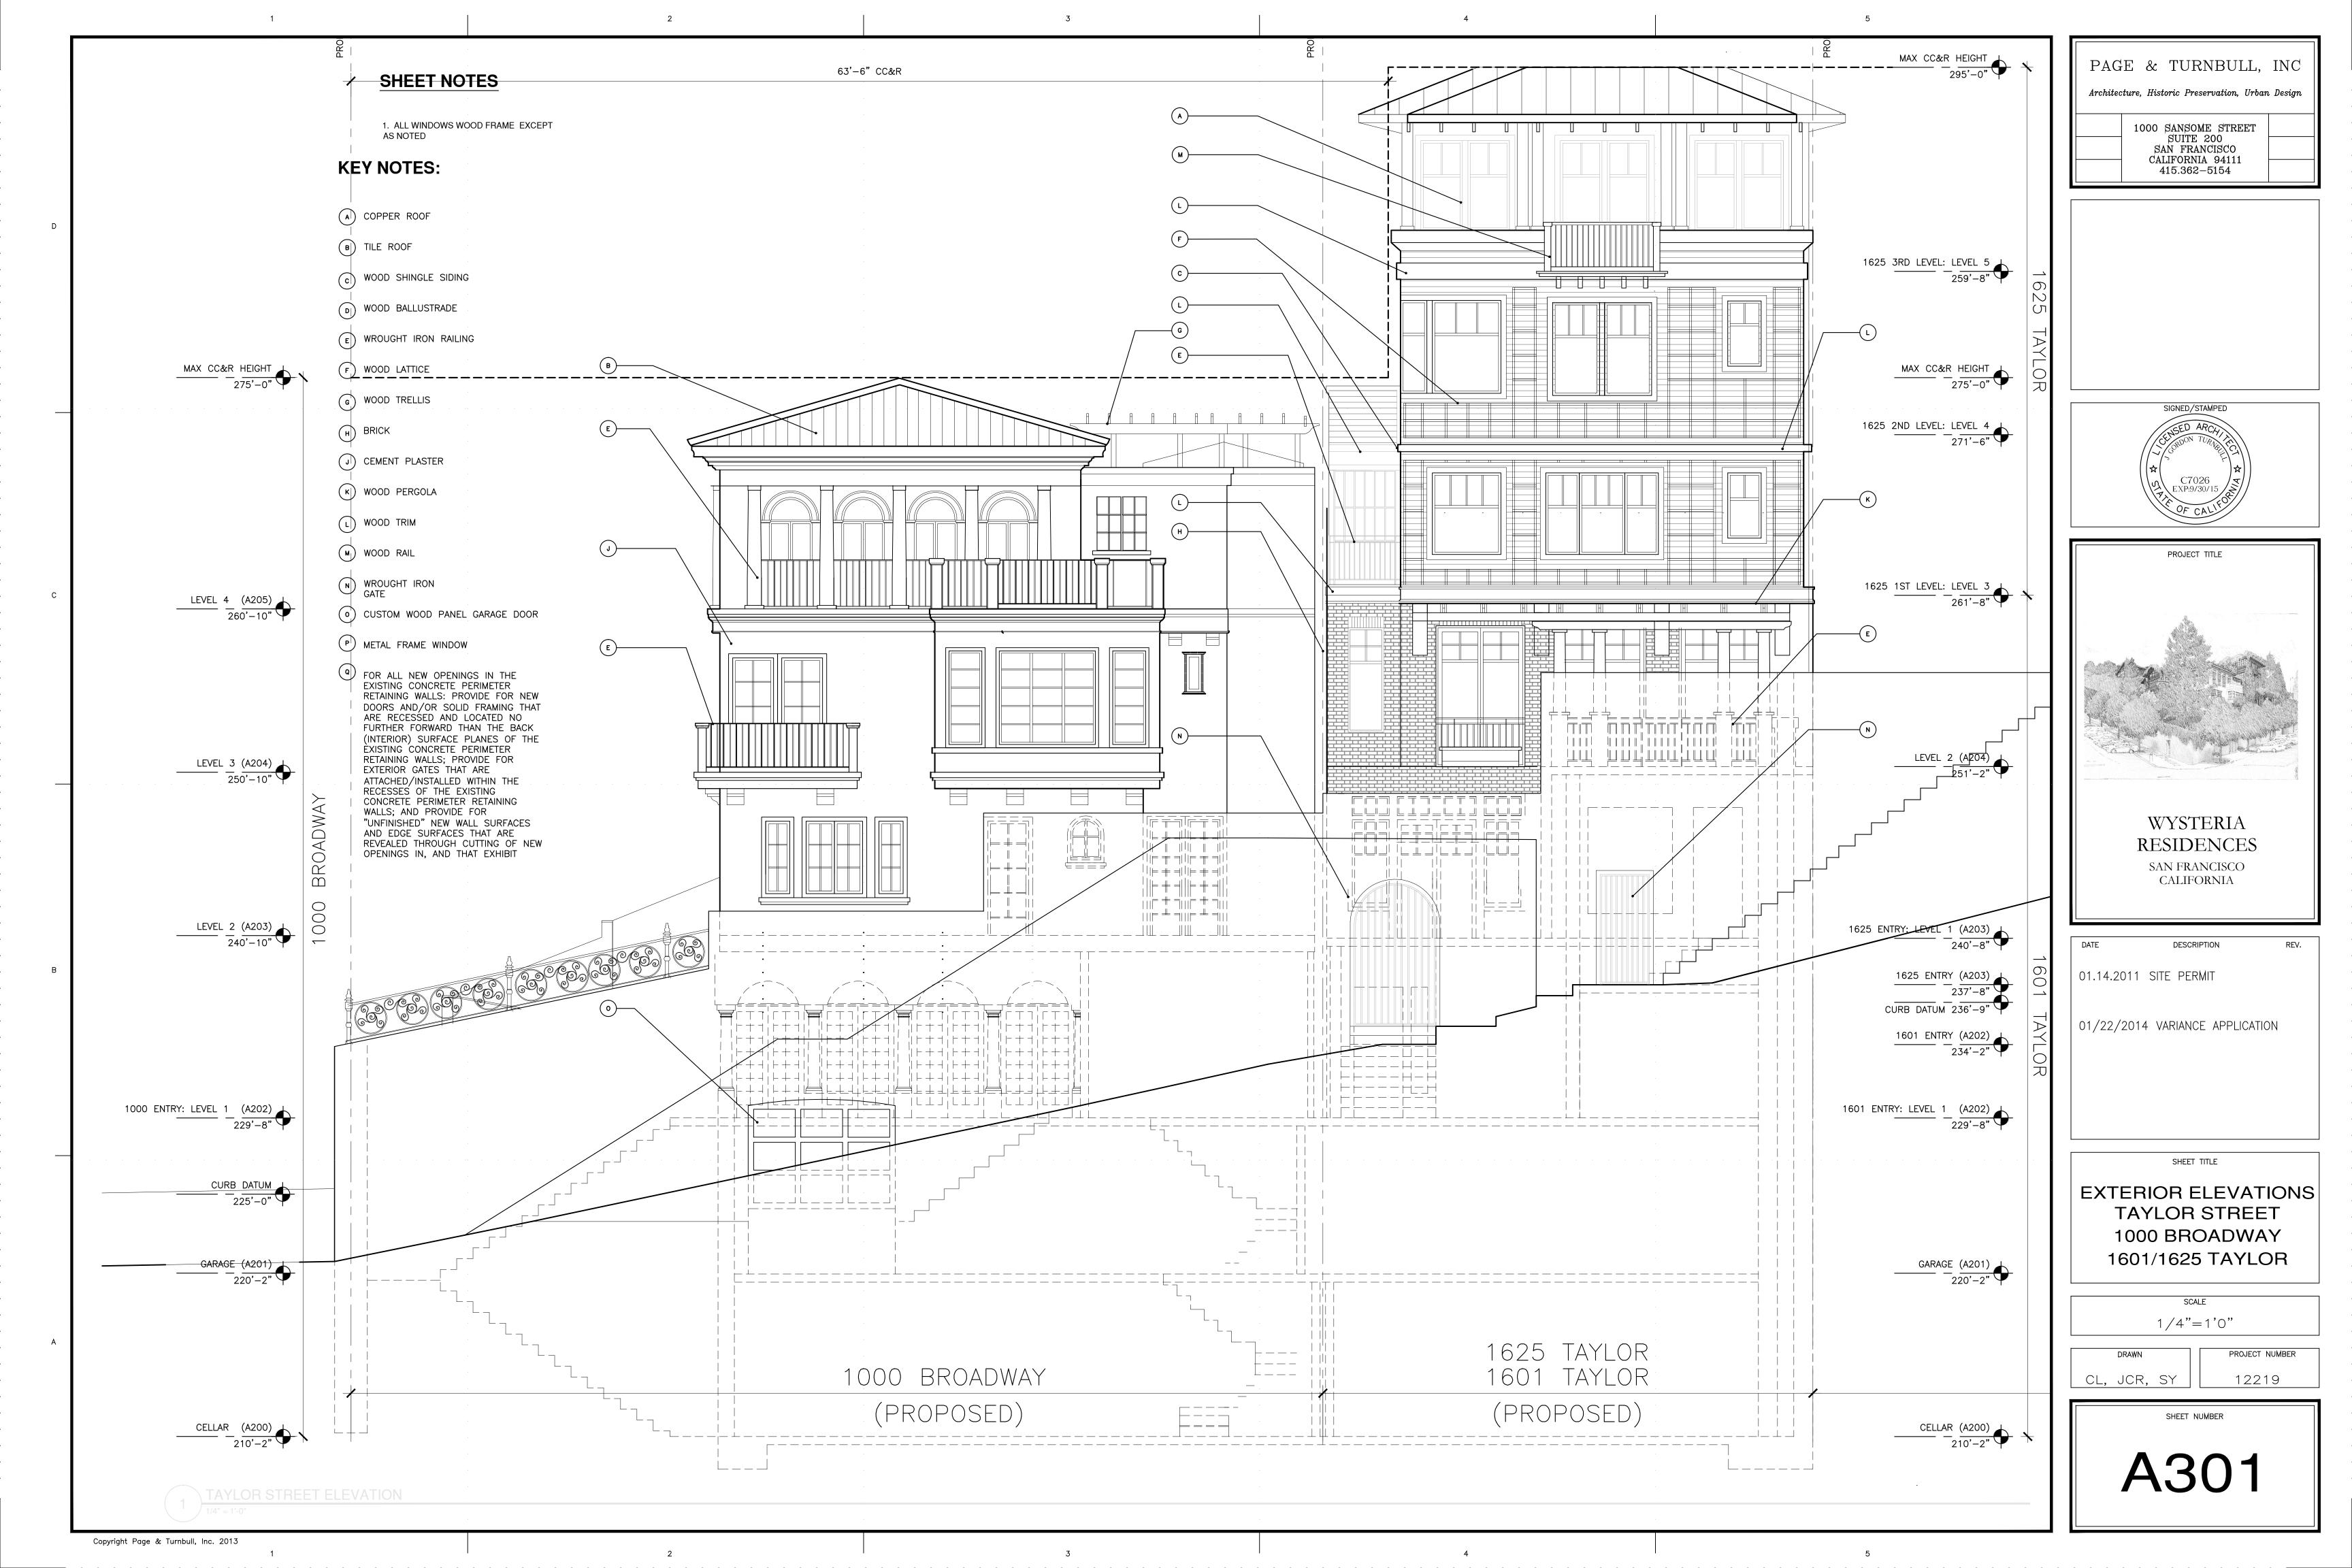
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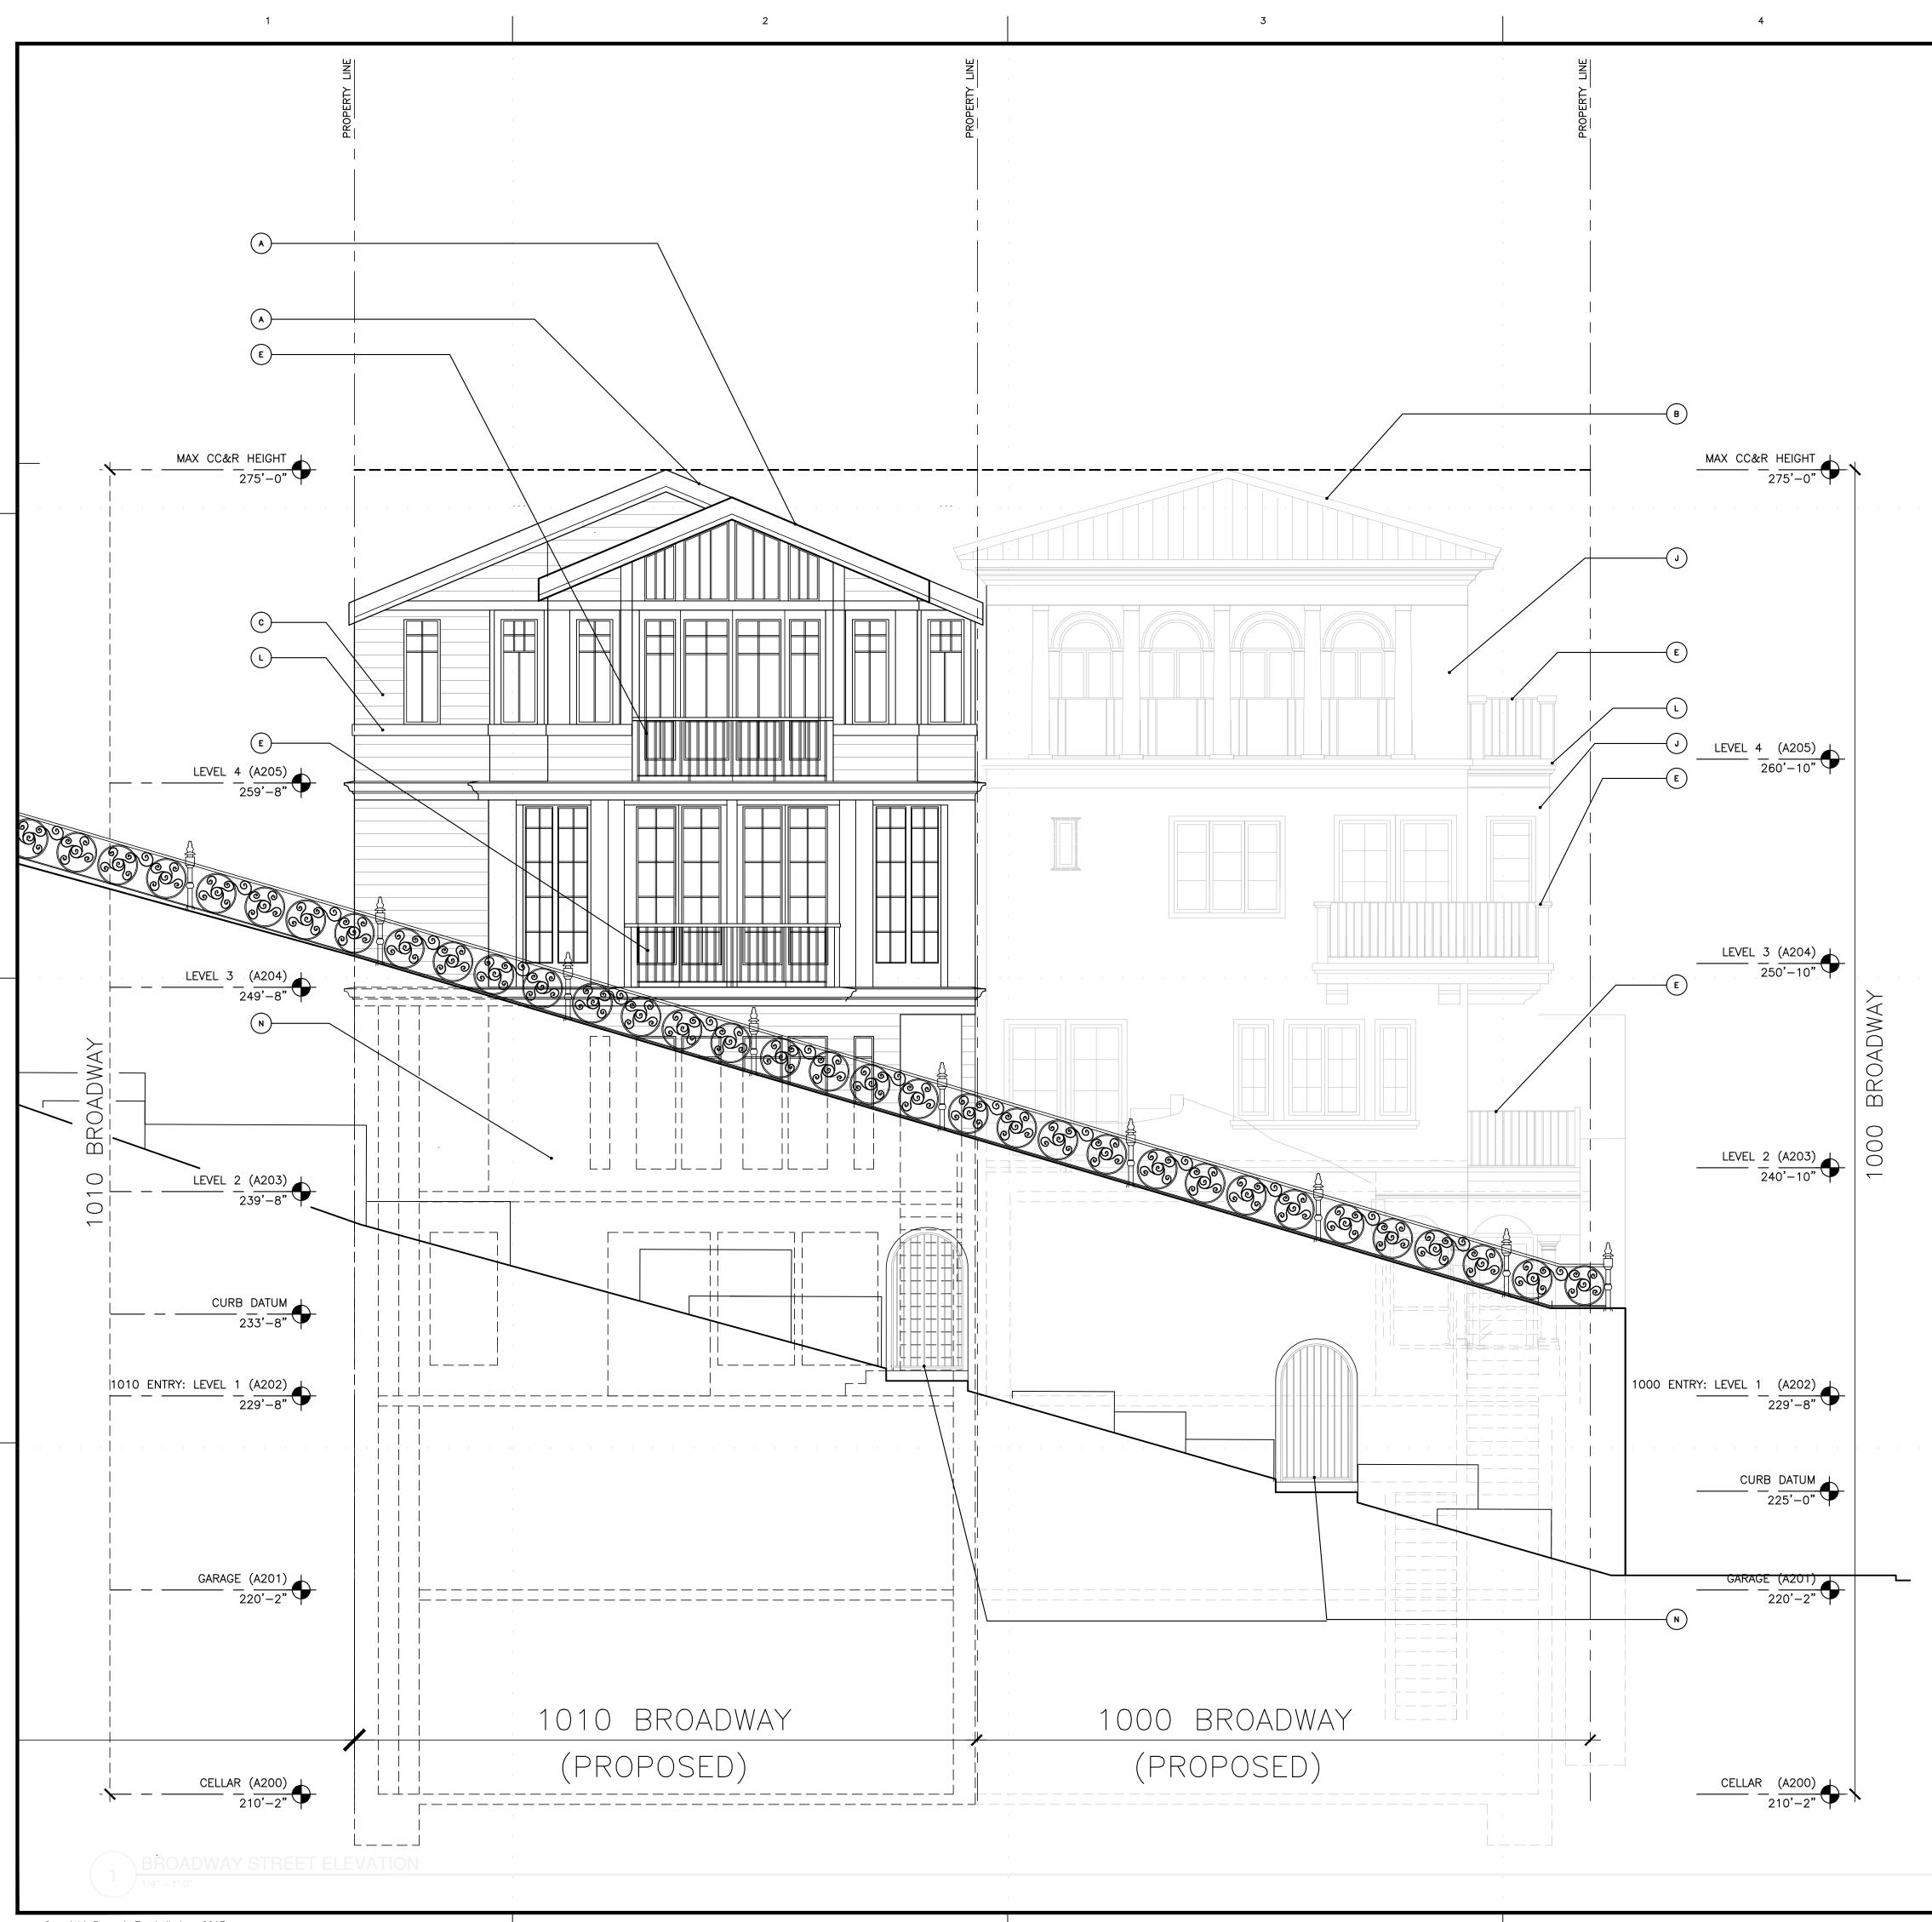
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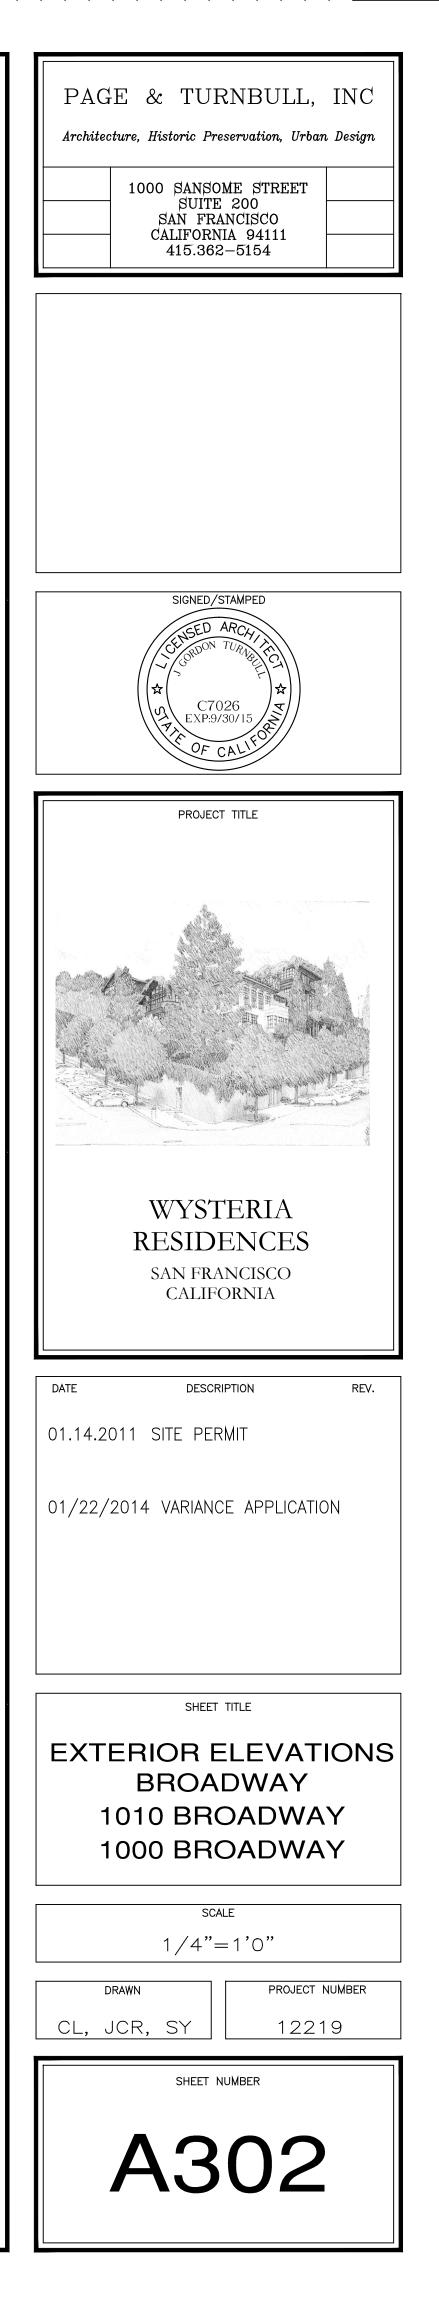



# SHEET NOTES

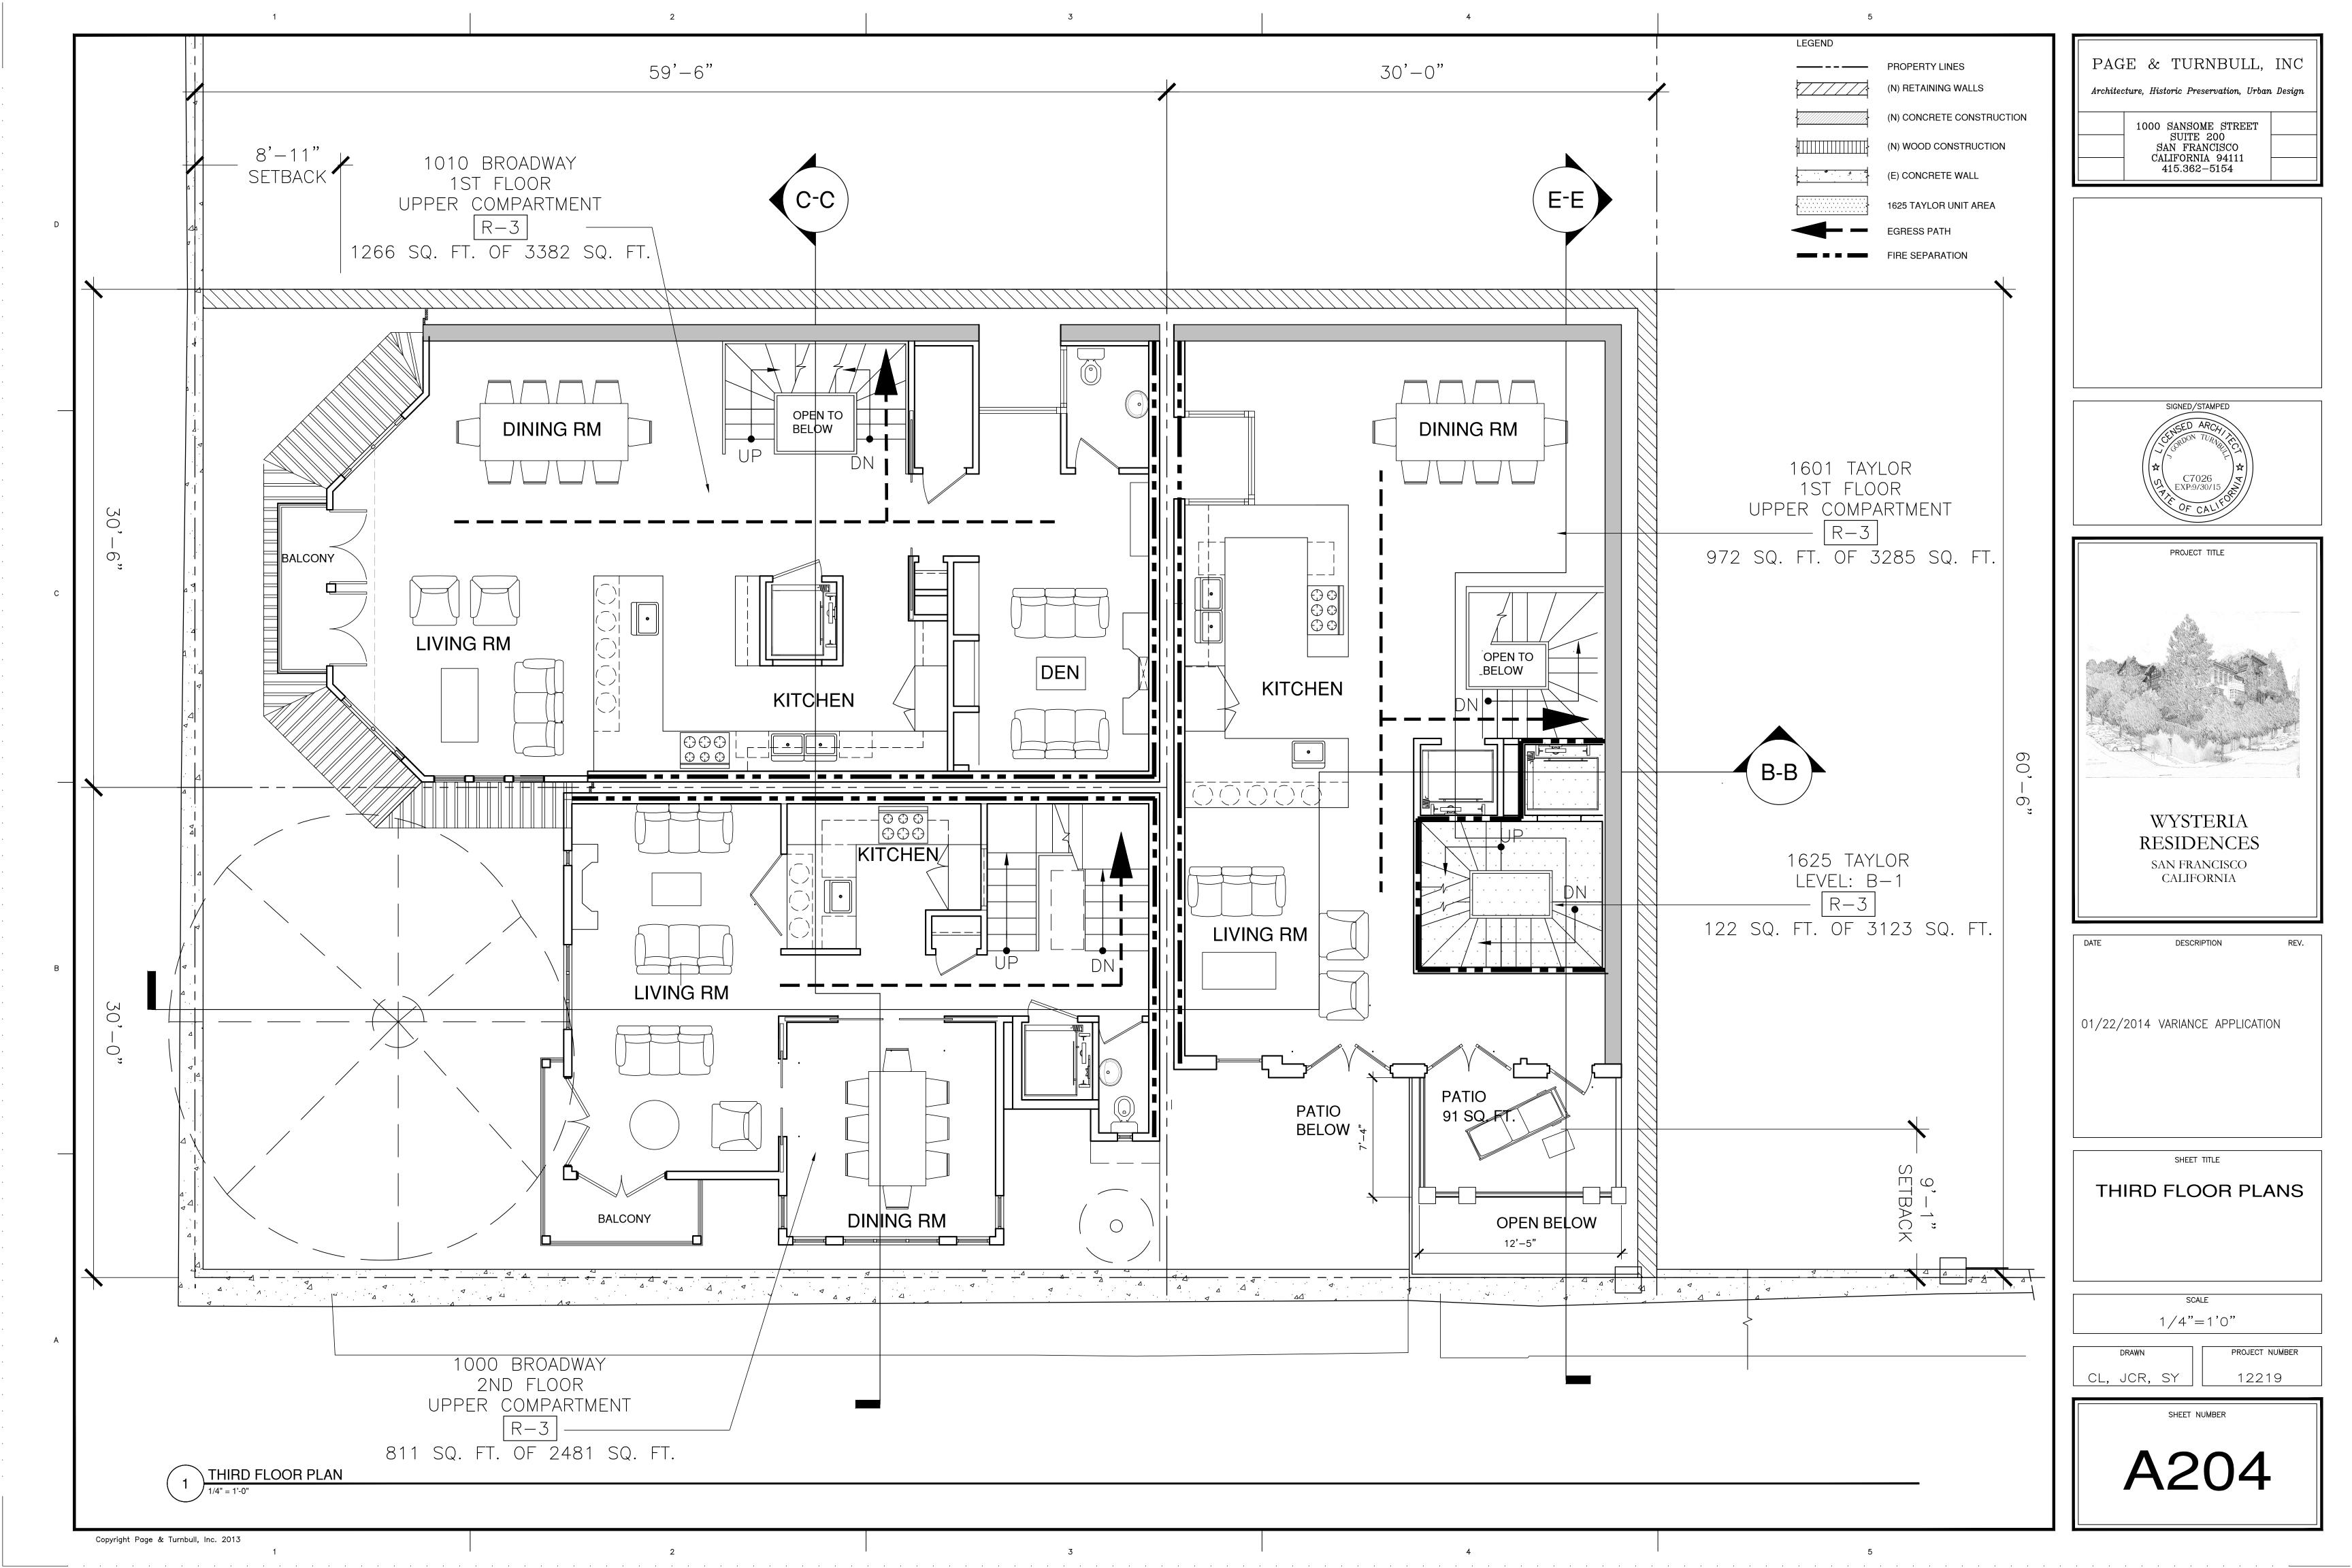1. ALL WINDOWS WOOD FRAME EXCEPT AS NOTED
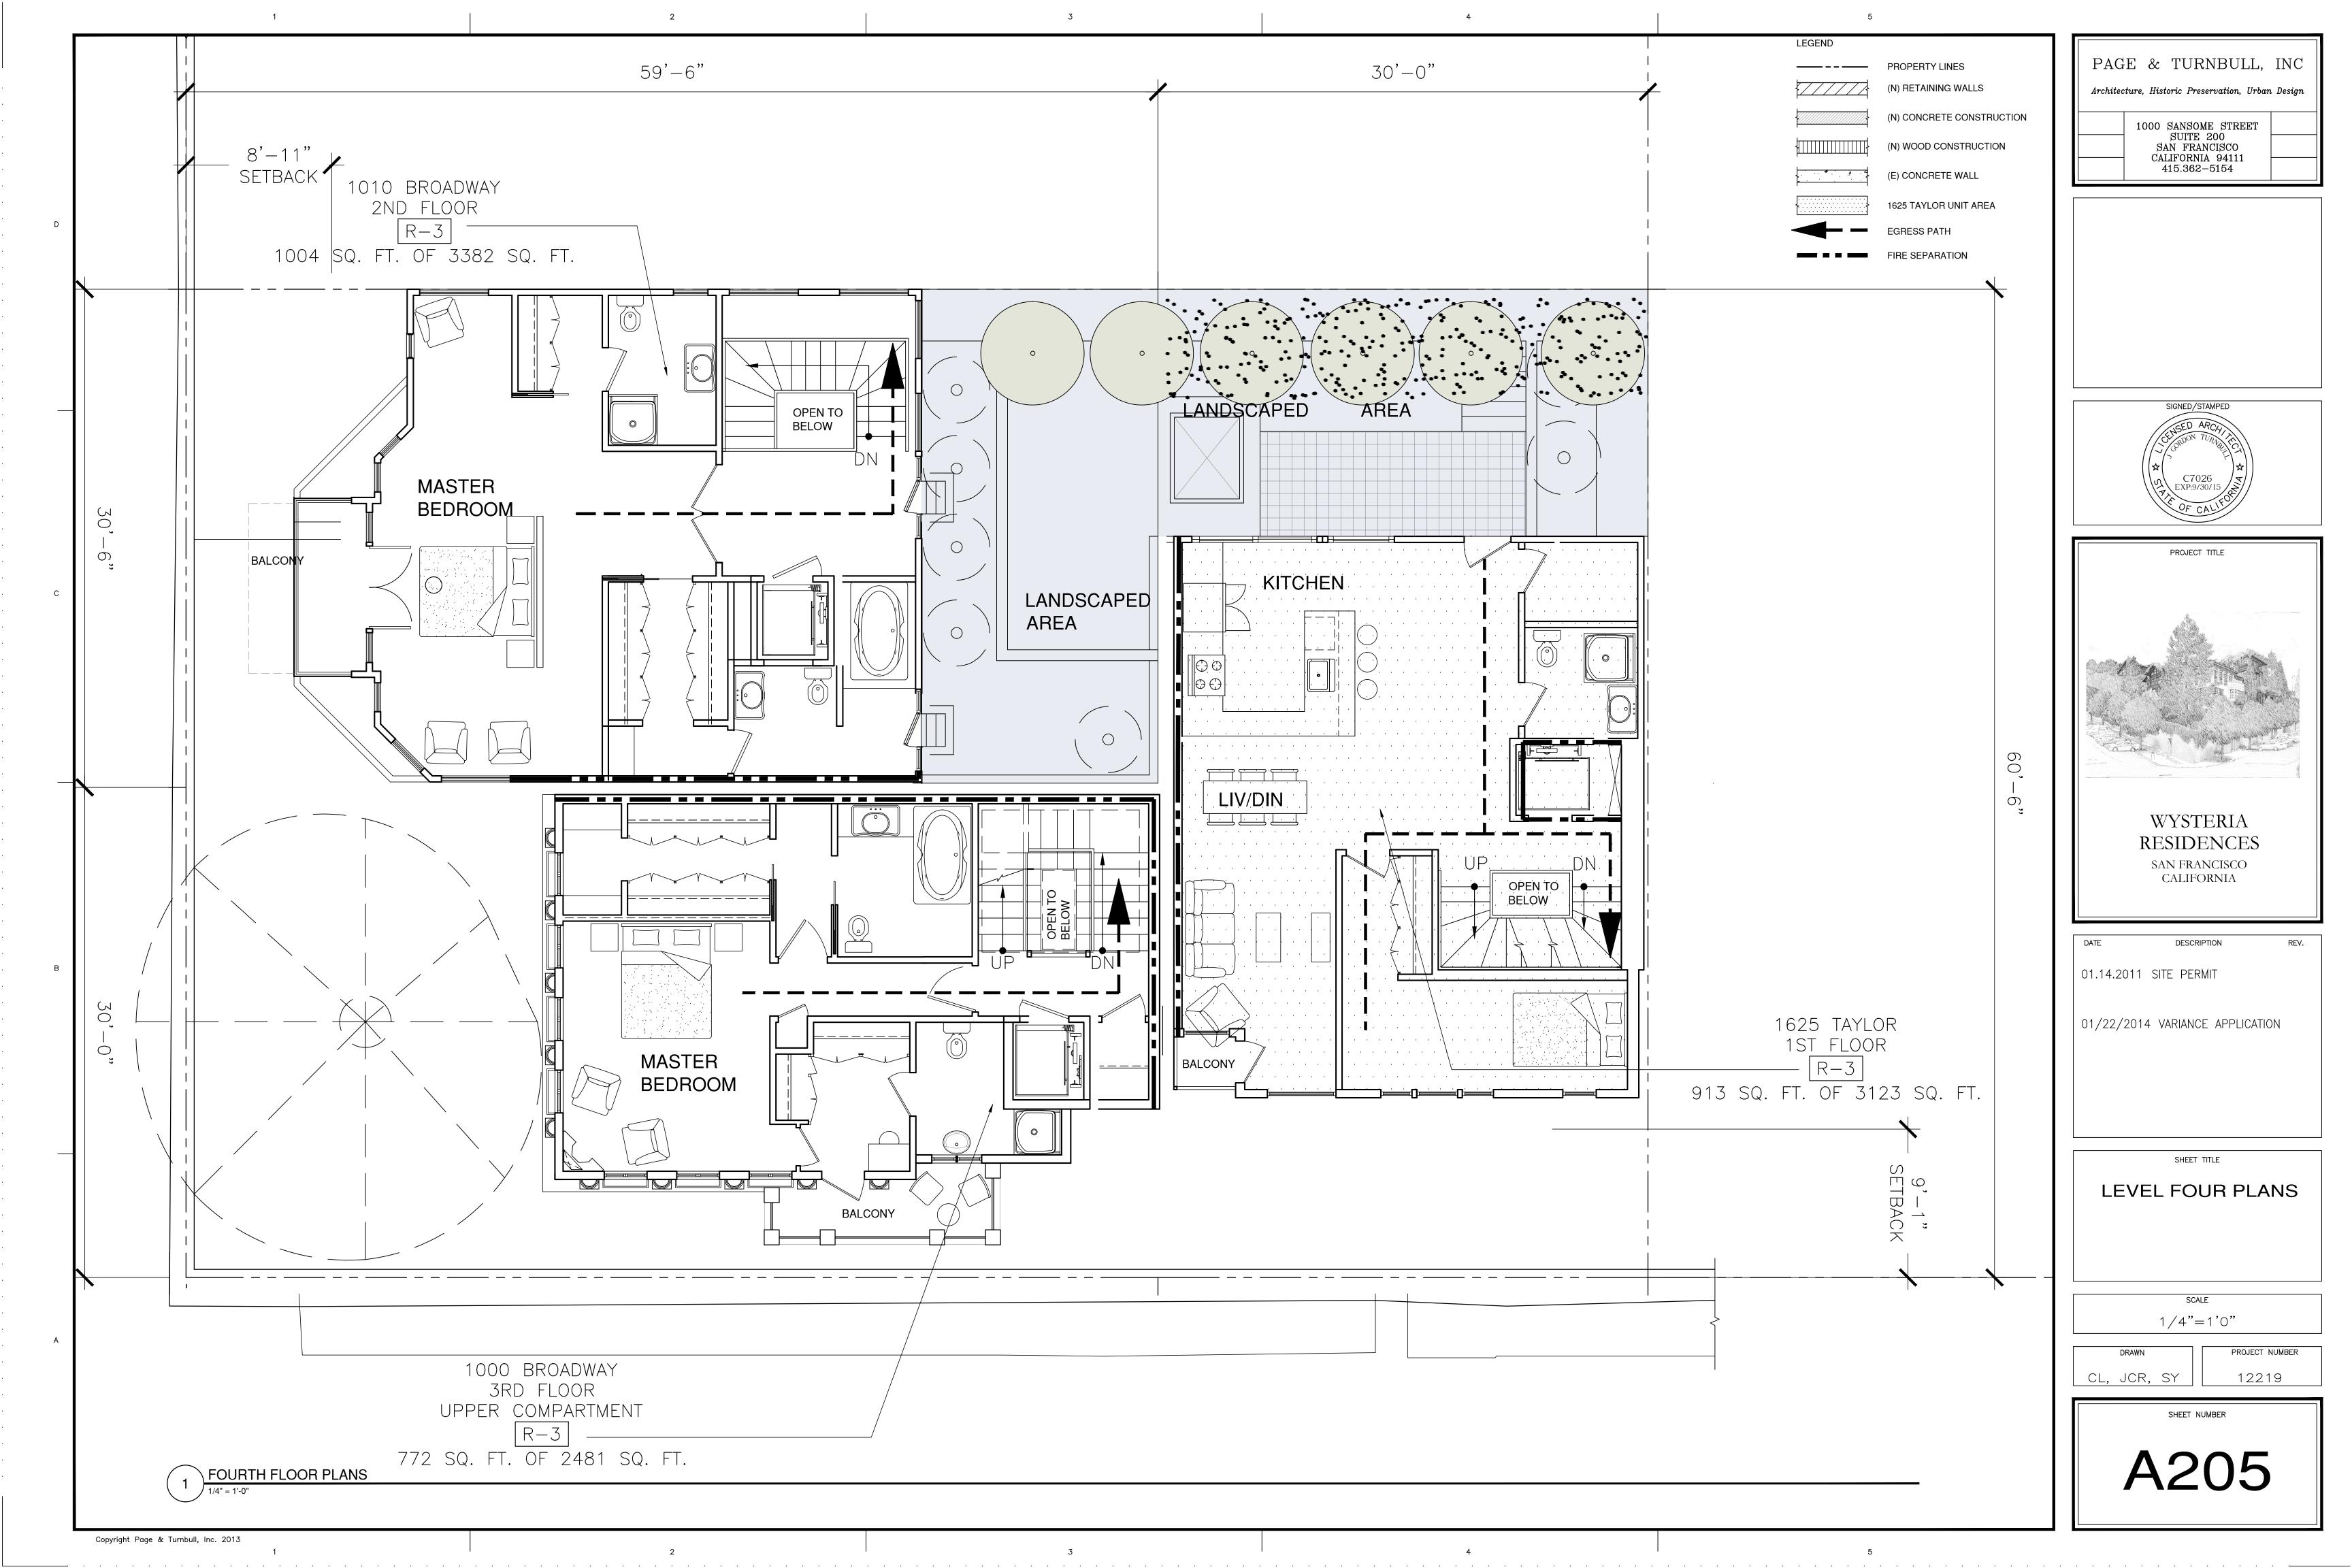
# **KEY NOTES:**

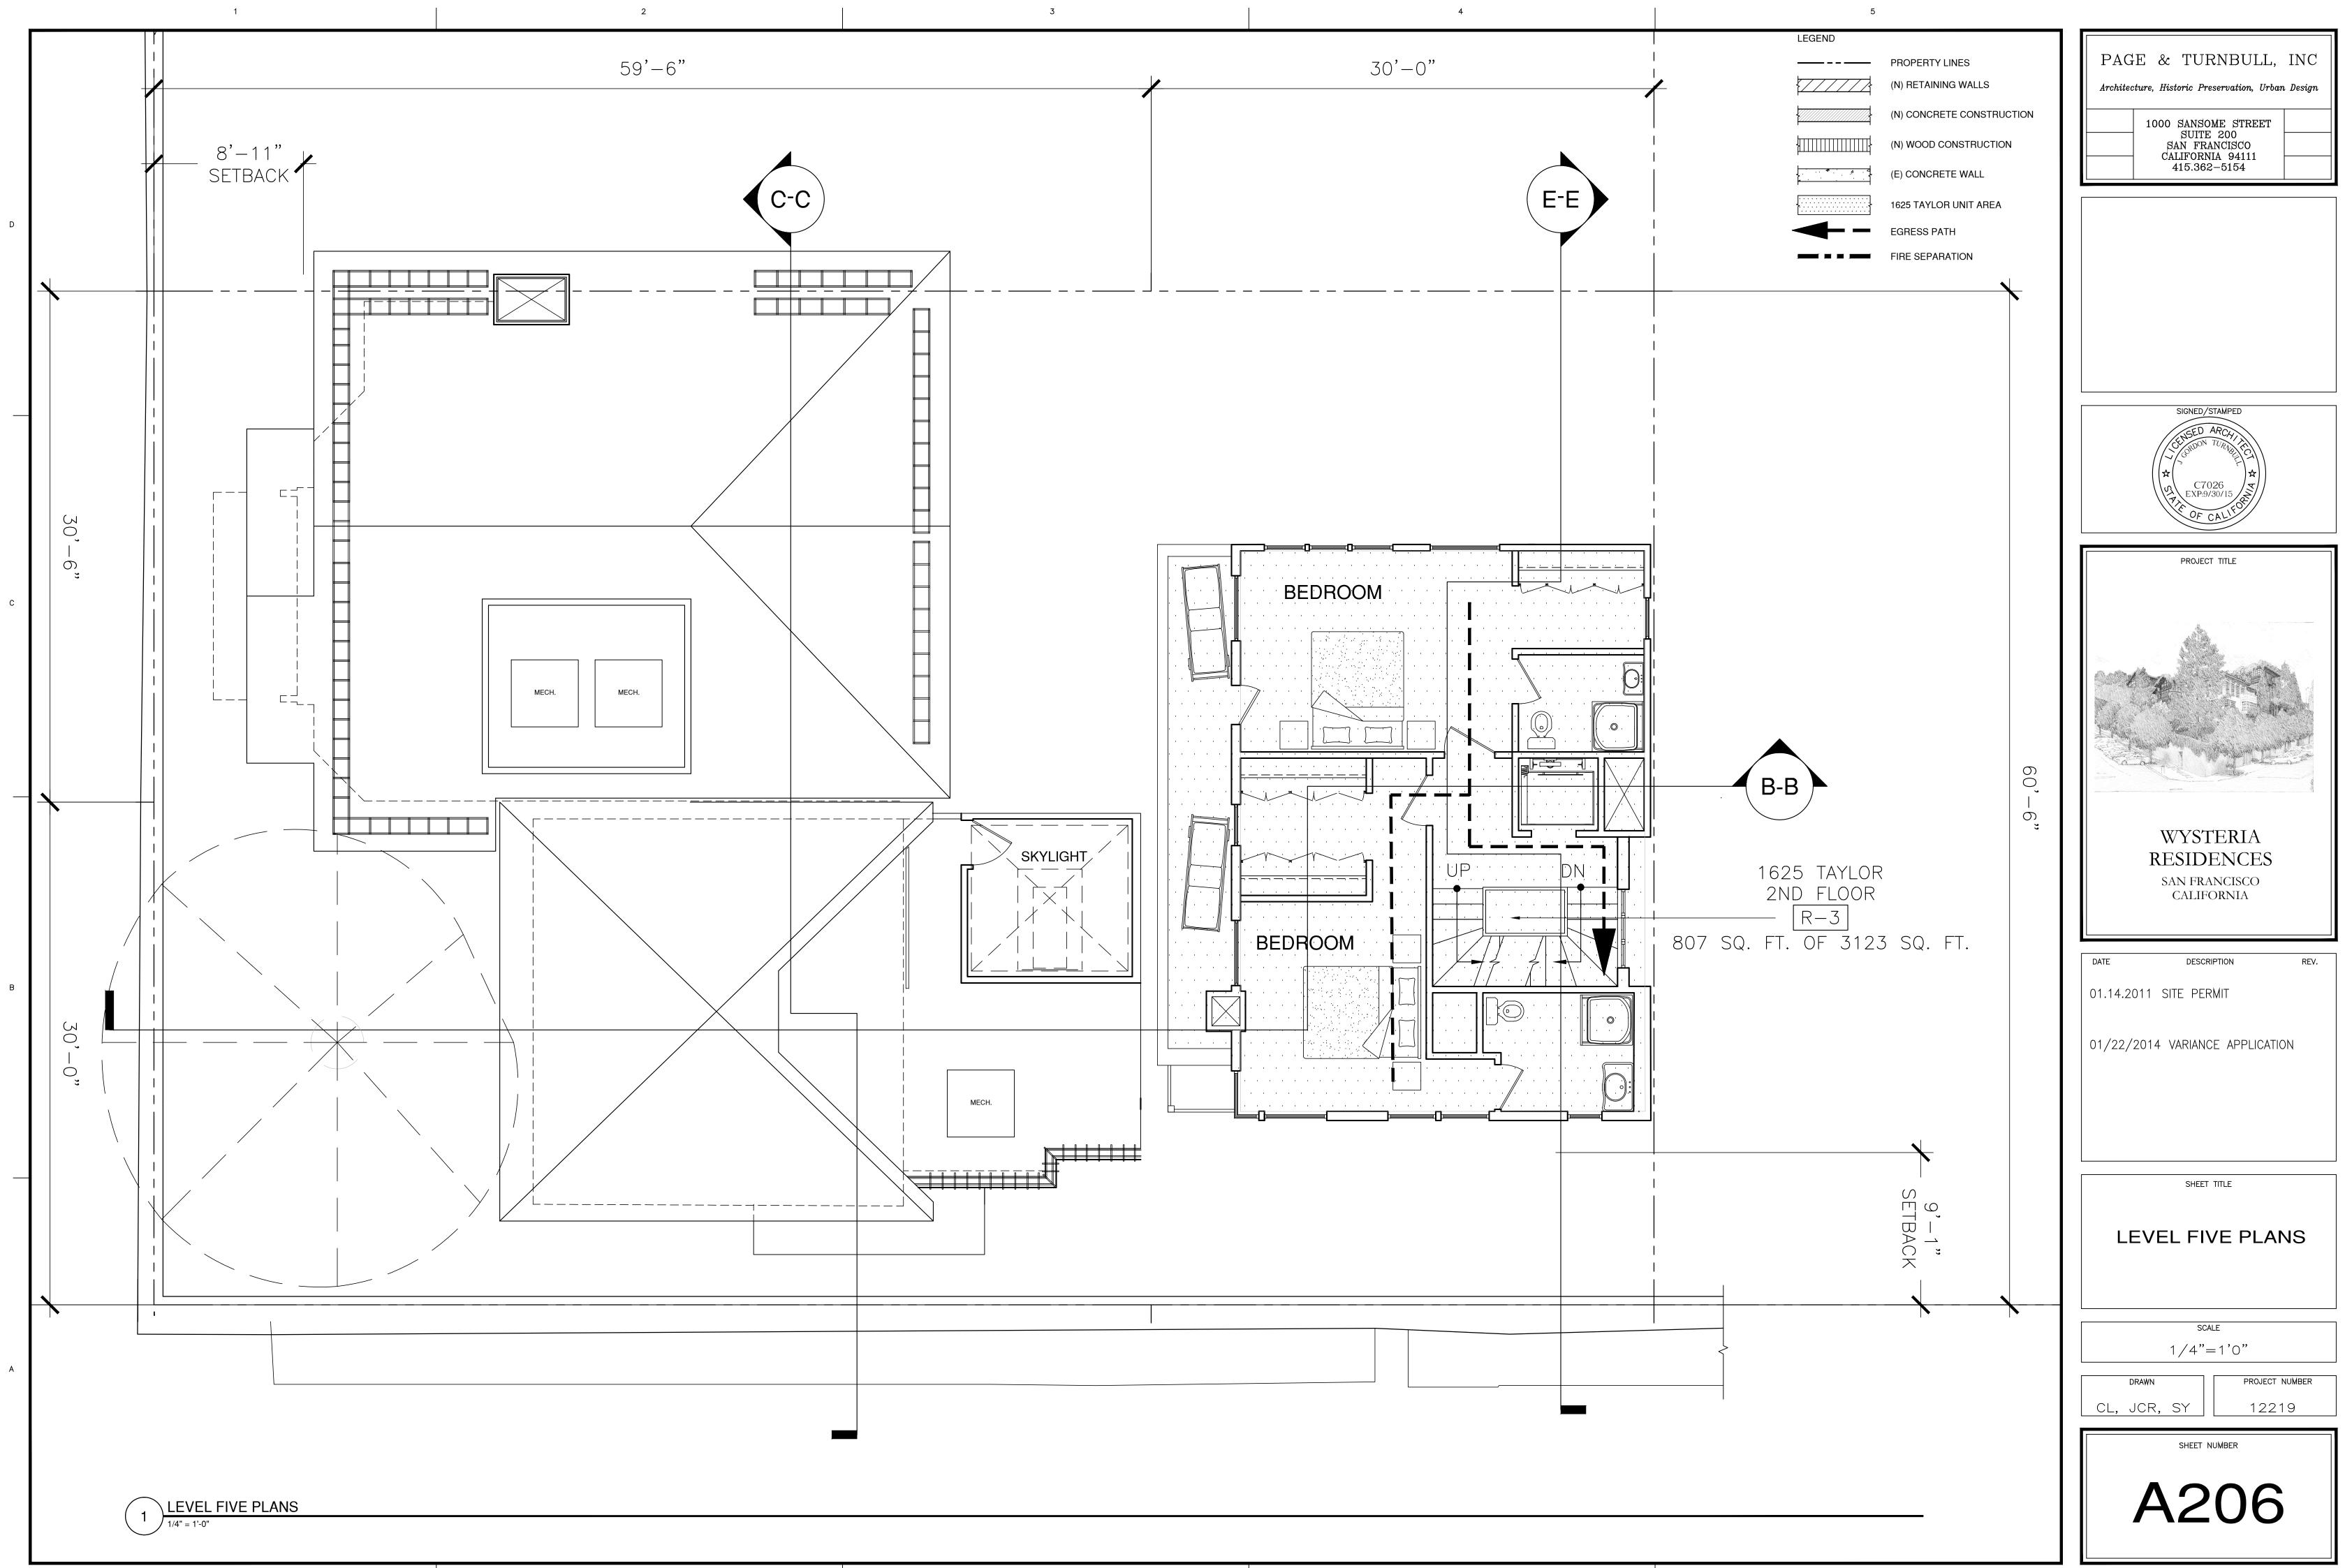- (A) COPPER ROOF
- B TILE ROOF
- (c) WOOD SHINGLE SIDING
- (D) WOOD BALLUSTRADE
- E WROUGHT IRON RAILING
- (F) WOOD LATTICE
- G WOOD TRELLIS
- (H) BRICK
- J CEMENT PLASTER
- (K) WOOD PERGOLA
- L WOOD TRIM
- WOOD RAIL
- N WROUGHT IRON GATE
- CUSTOM WOOD PANEL GARAGE DOOR
- P METAL FRAME WINDOW
- FOR ALL NEW OPENINGS IN THE EXISTING CONCRETE PERIMETER RETAINING WALLS: PROVIDE FOR NEW DOORS AND/OR SOLID FRAMING THAT ARE RECESSED AND LOCATED NO FURTHER FORWARD THAN THE BACK (INTERIOR) SURFACE PLANES OF THE EXISTING CONCRETE PERIMETER RETAINING WALLS; PROVIDE FOR EXTERIOR GATES THAT ARE ATTACHED/INSTALLED WITHIN THE RECESSES OF THE EXISTING CONCRETE PERIMETER RETAINING WALLS; AND PROVIDE FOR "UNFINISHED" NEW WALL SURFACES AND EDGE SURFACES THAT ARE REVEALED THROUGH CUTTING OF NEW OPENINGS IN, AND THAT EXHIBIT COLORS, TEXTURES, AND OTHER VISUAL AND MATERIAL QUALITIES OF THE INTERIOR CONSTRUCTION AND COMPOSITION OF, THE EXISTING CONCRETE PERIMETER RETAINING WALLS.

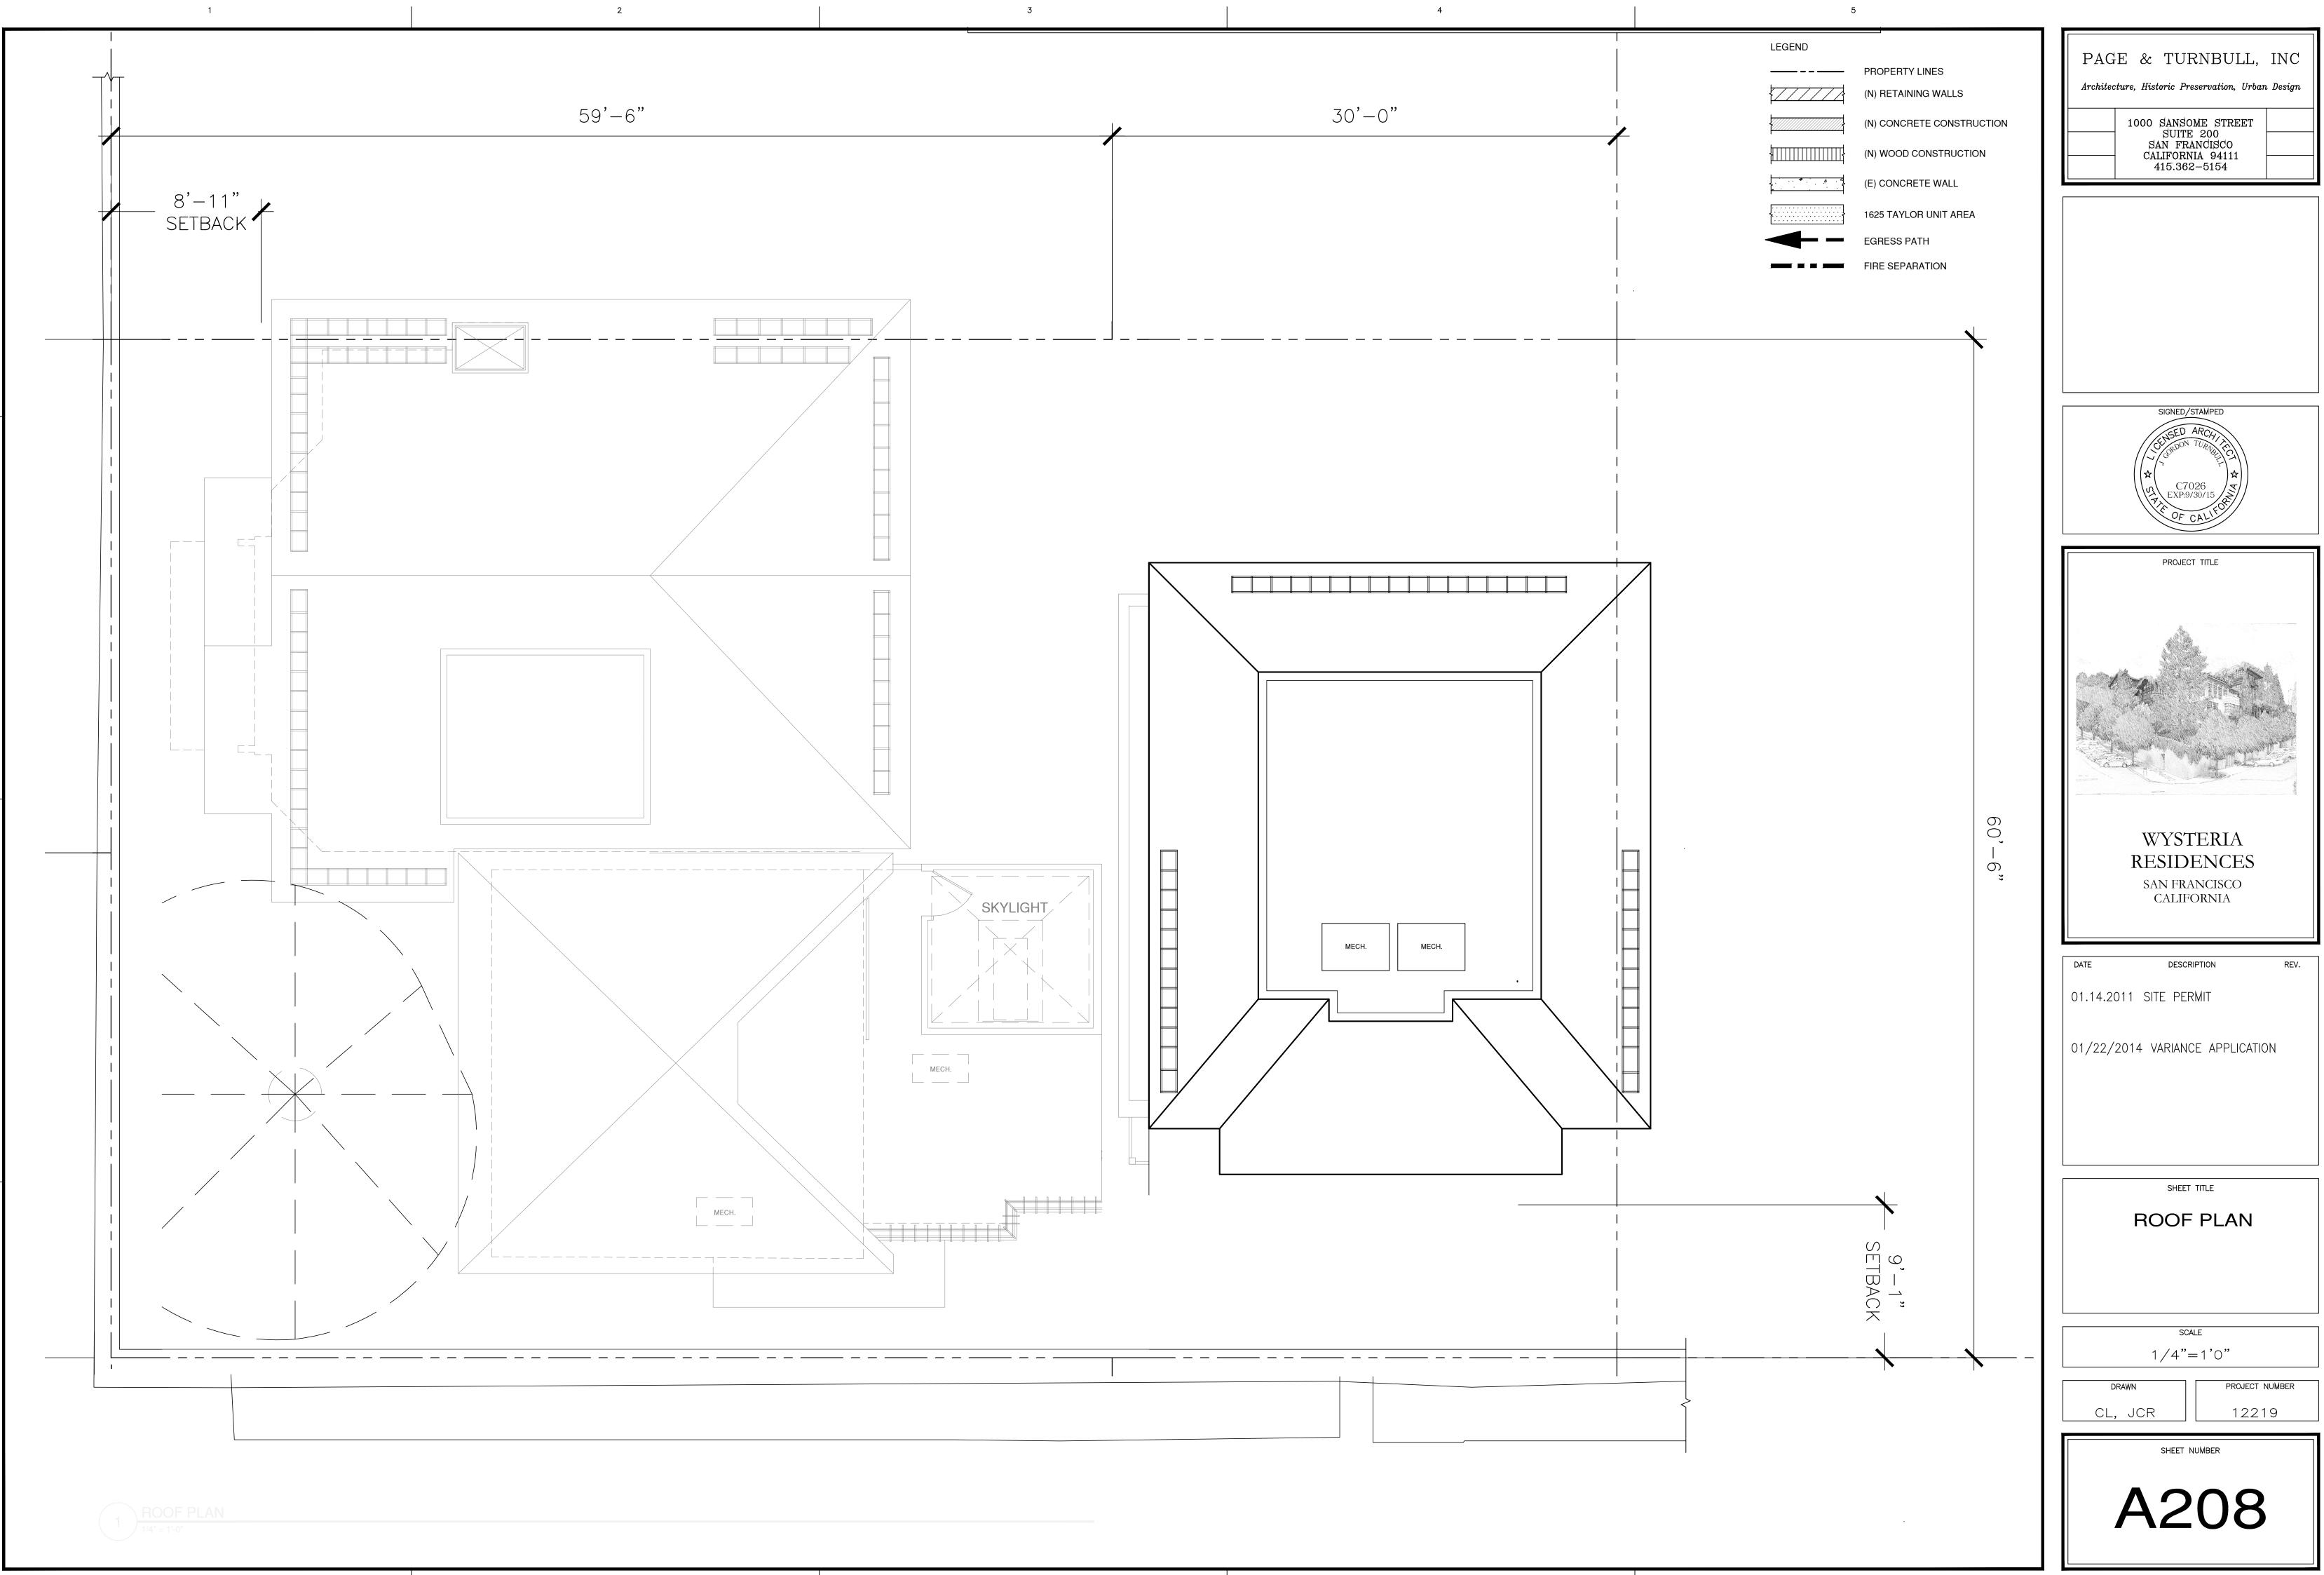


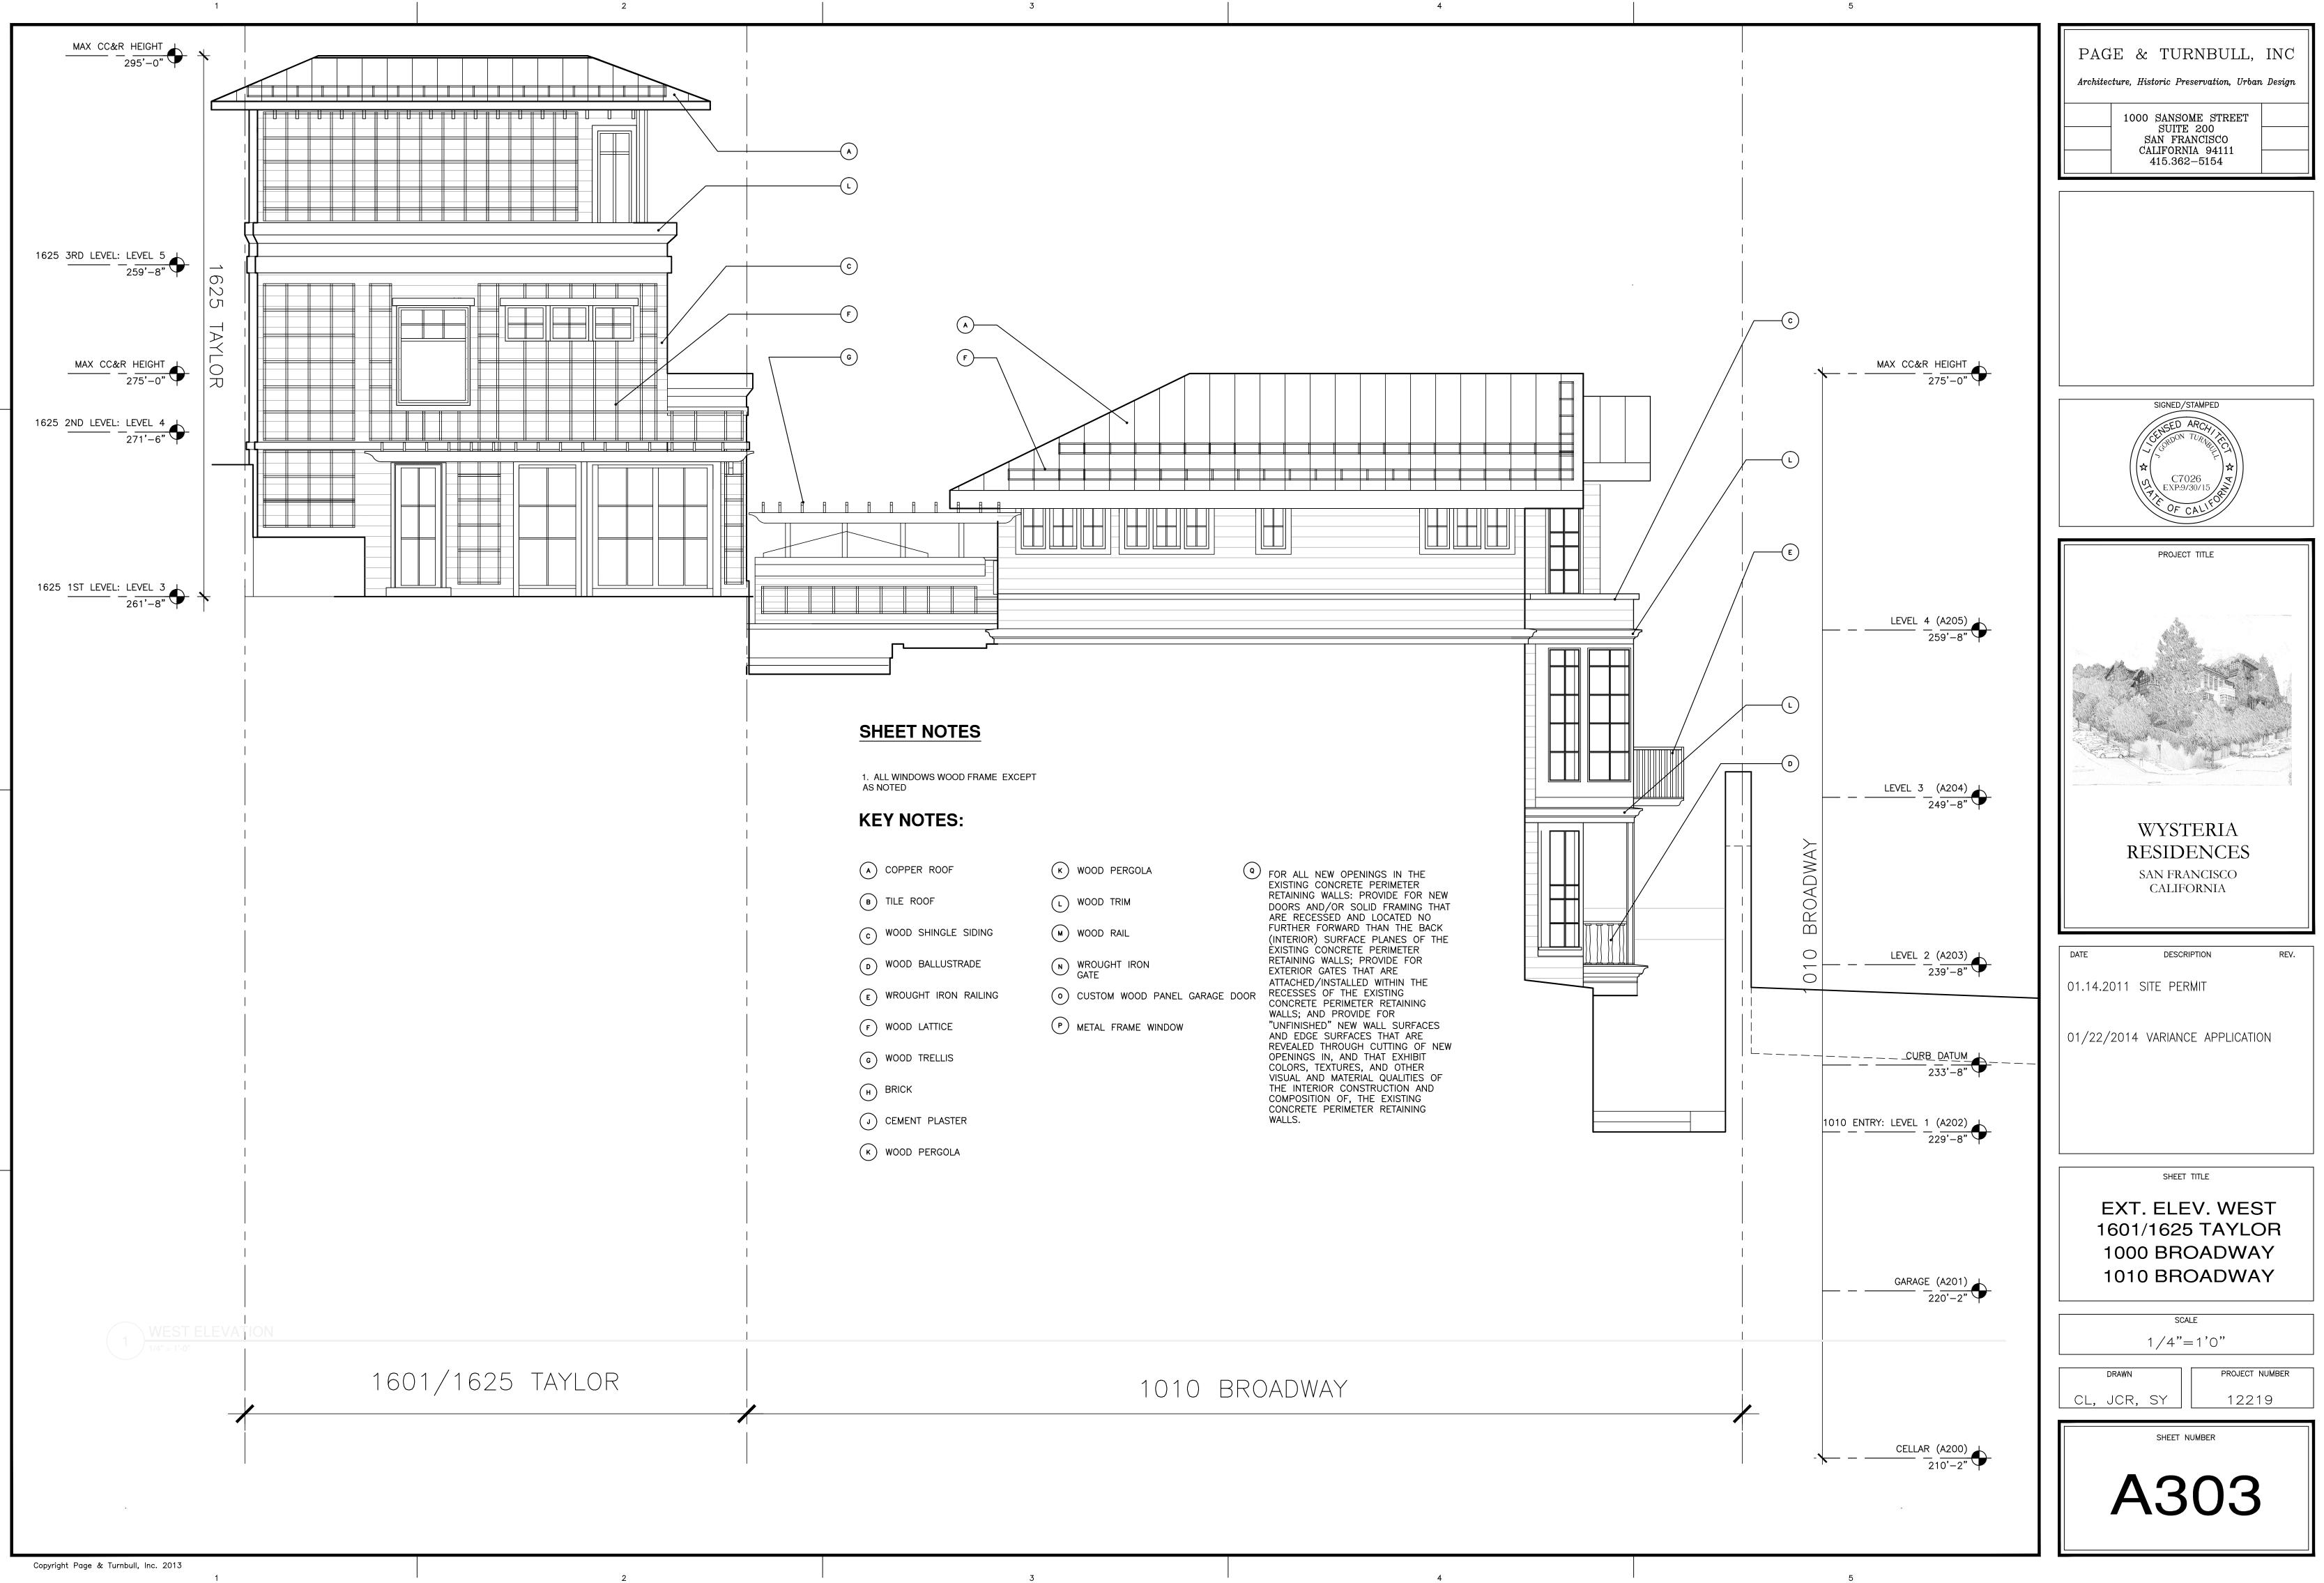

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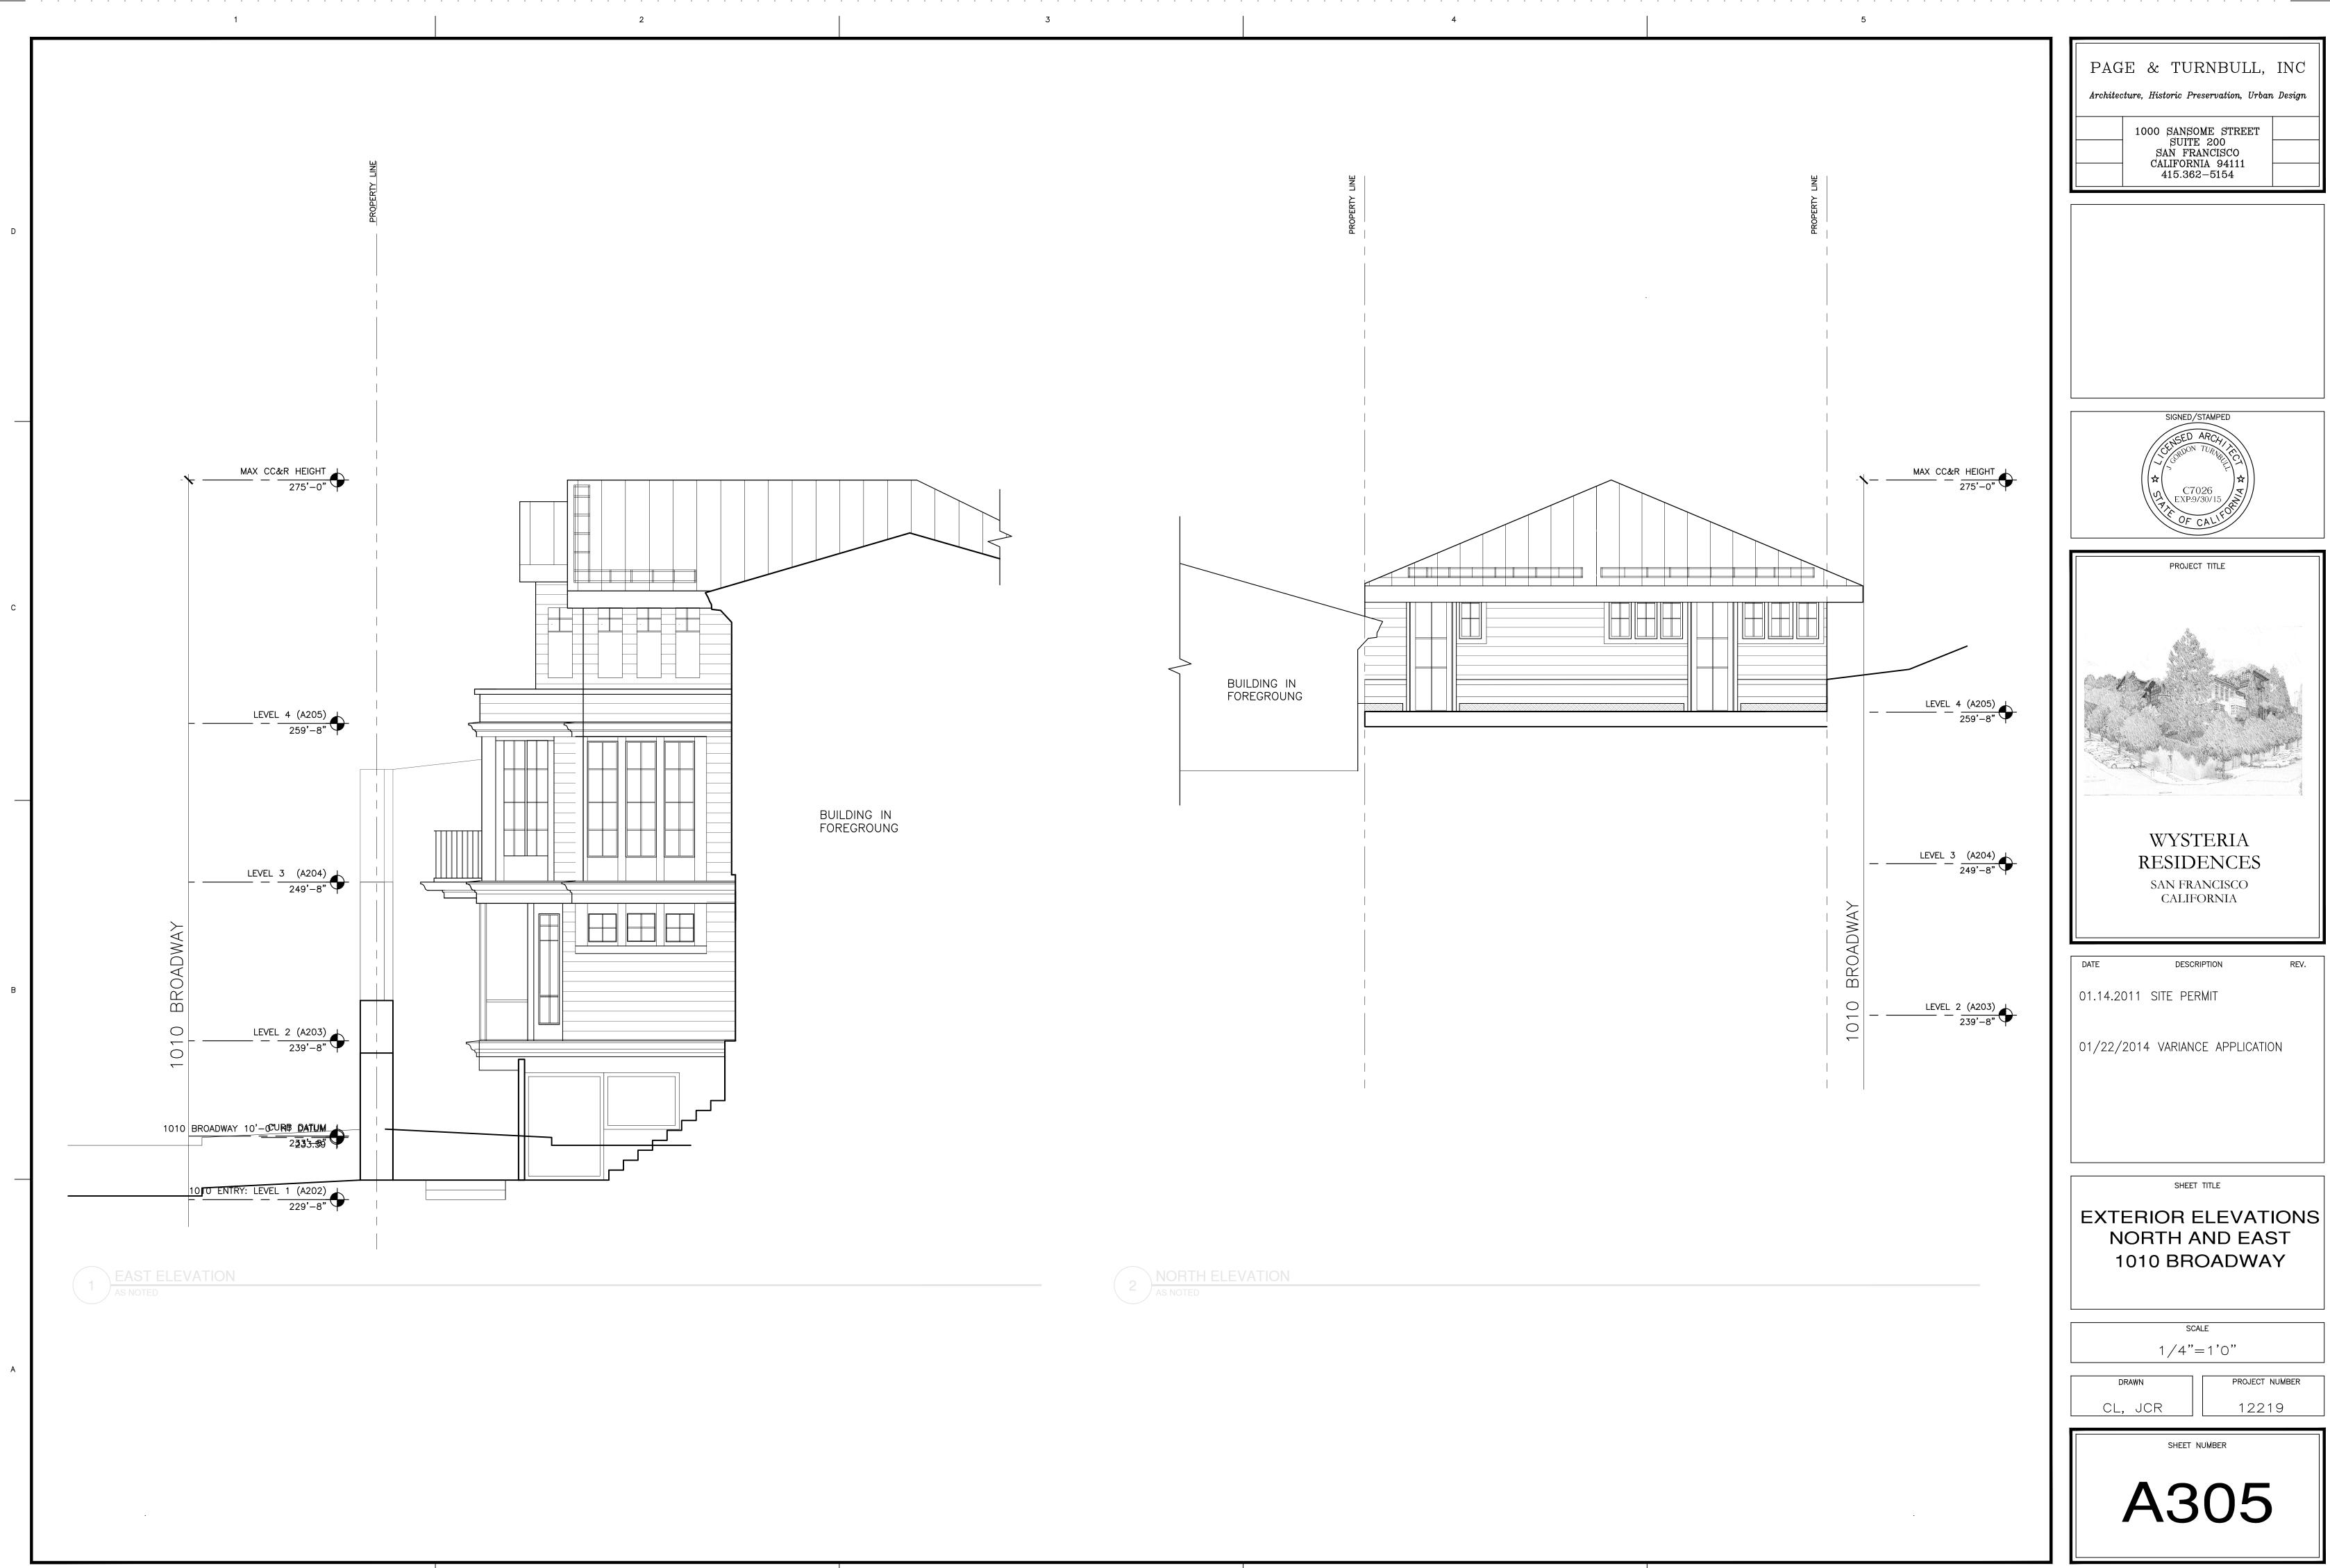
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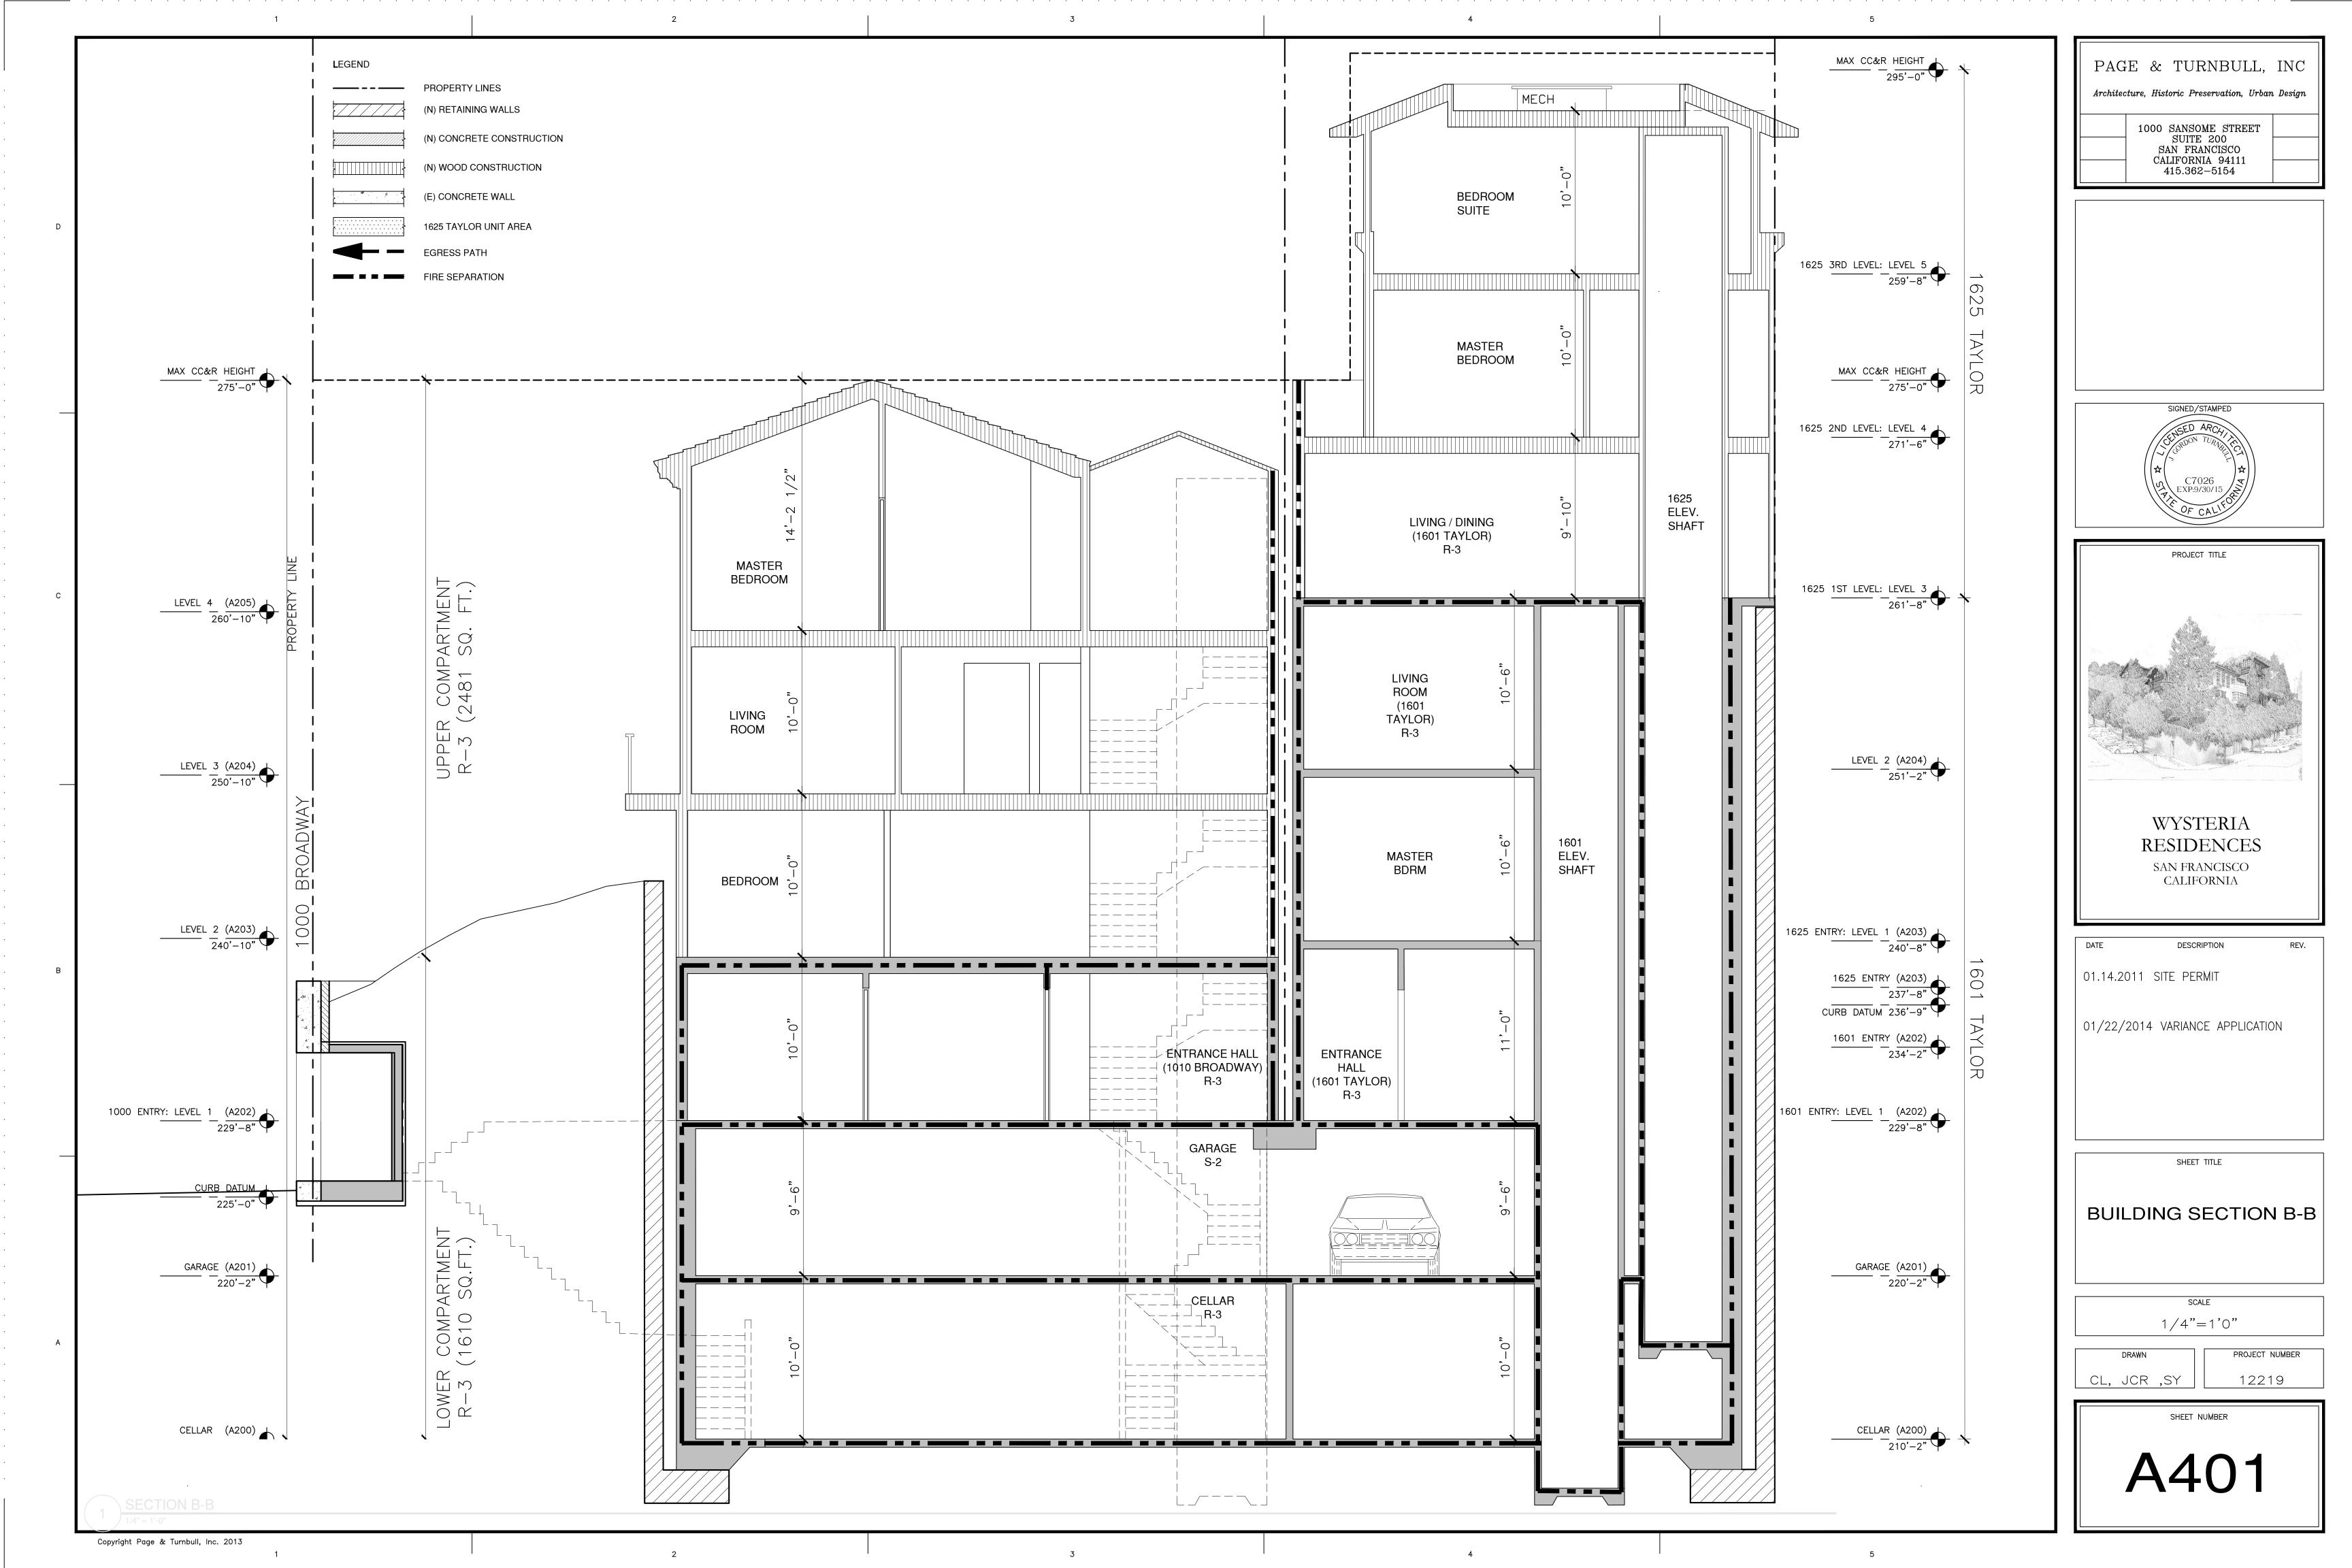
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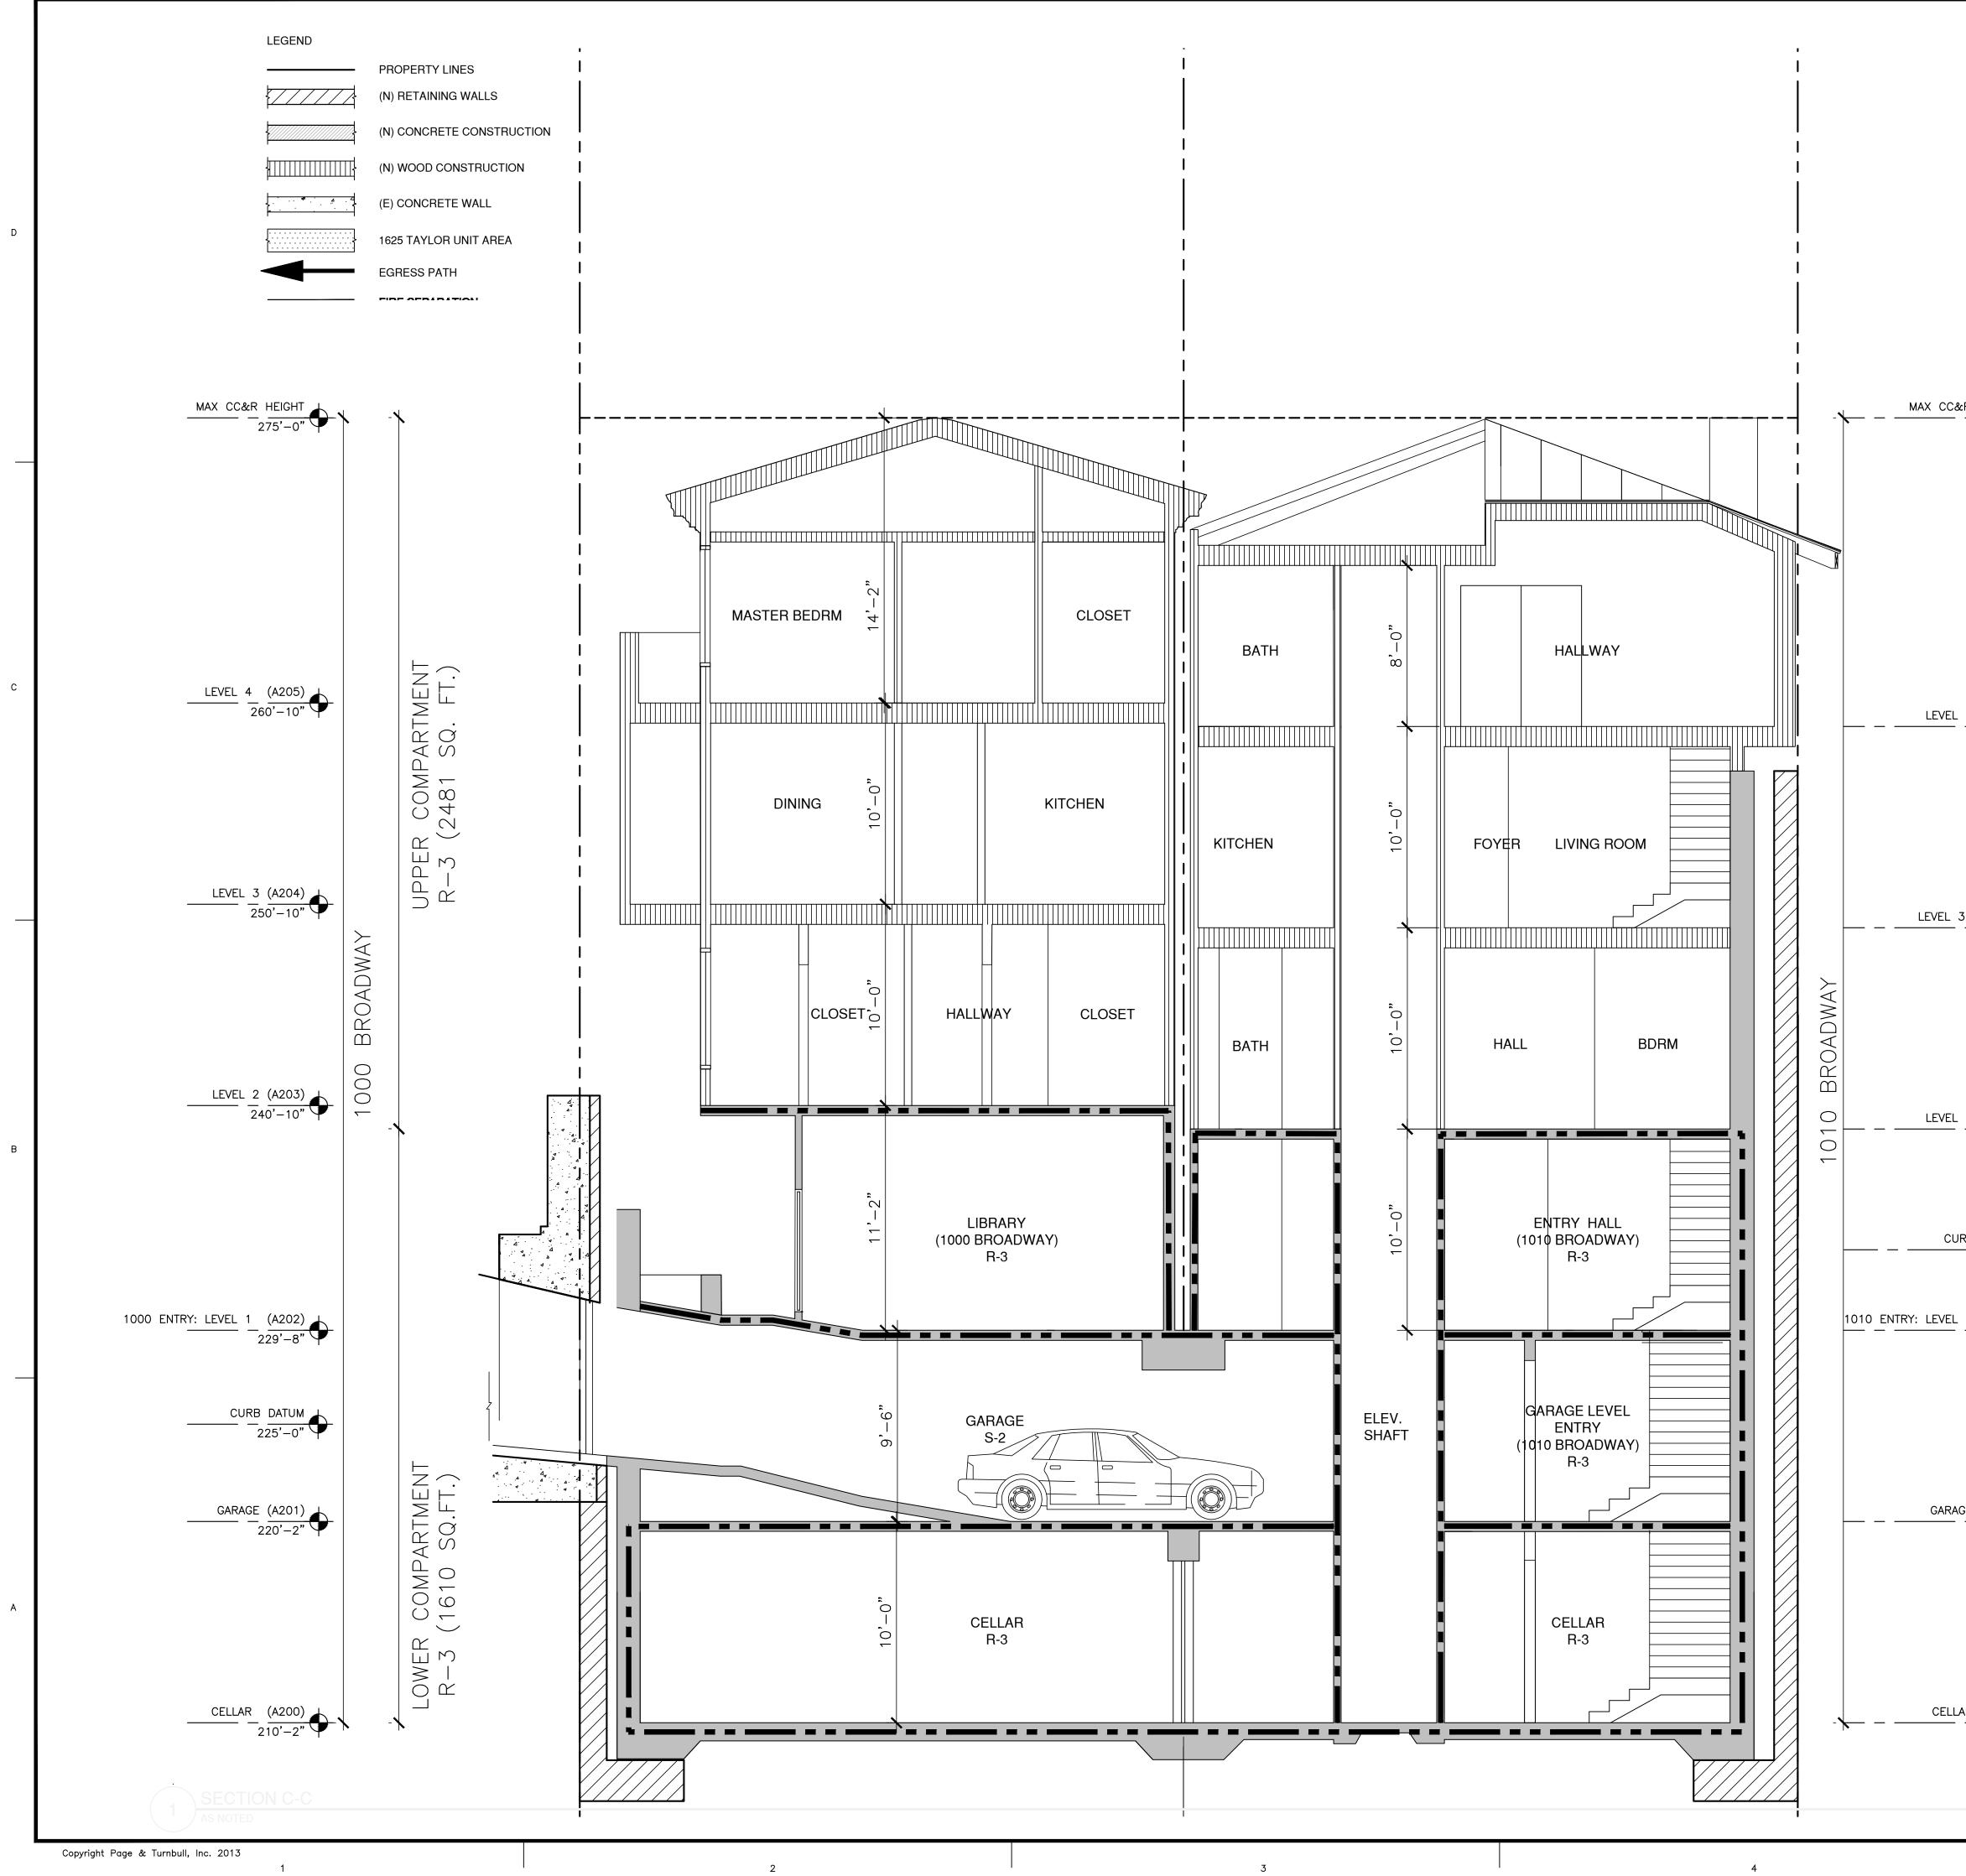


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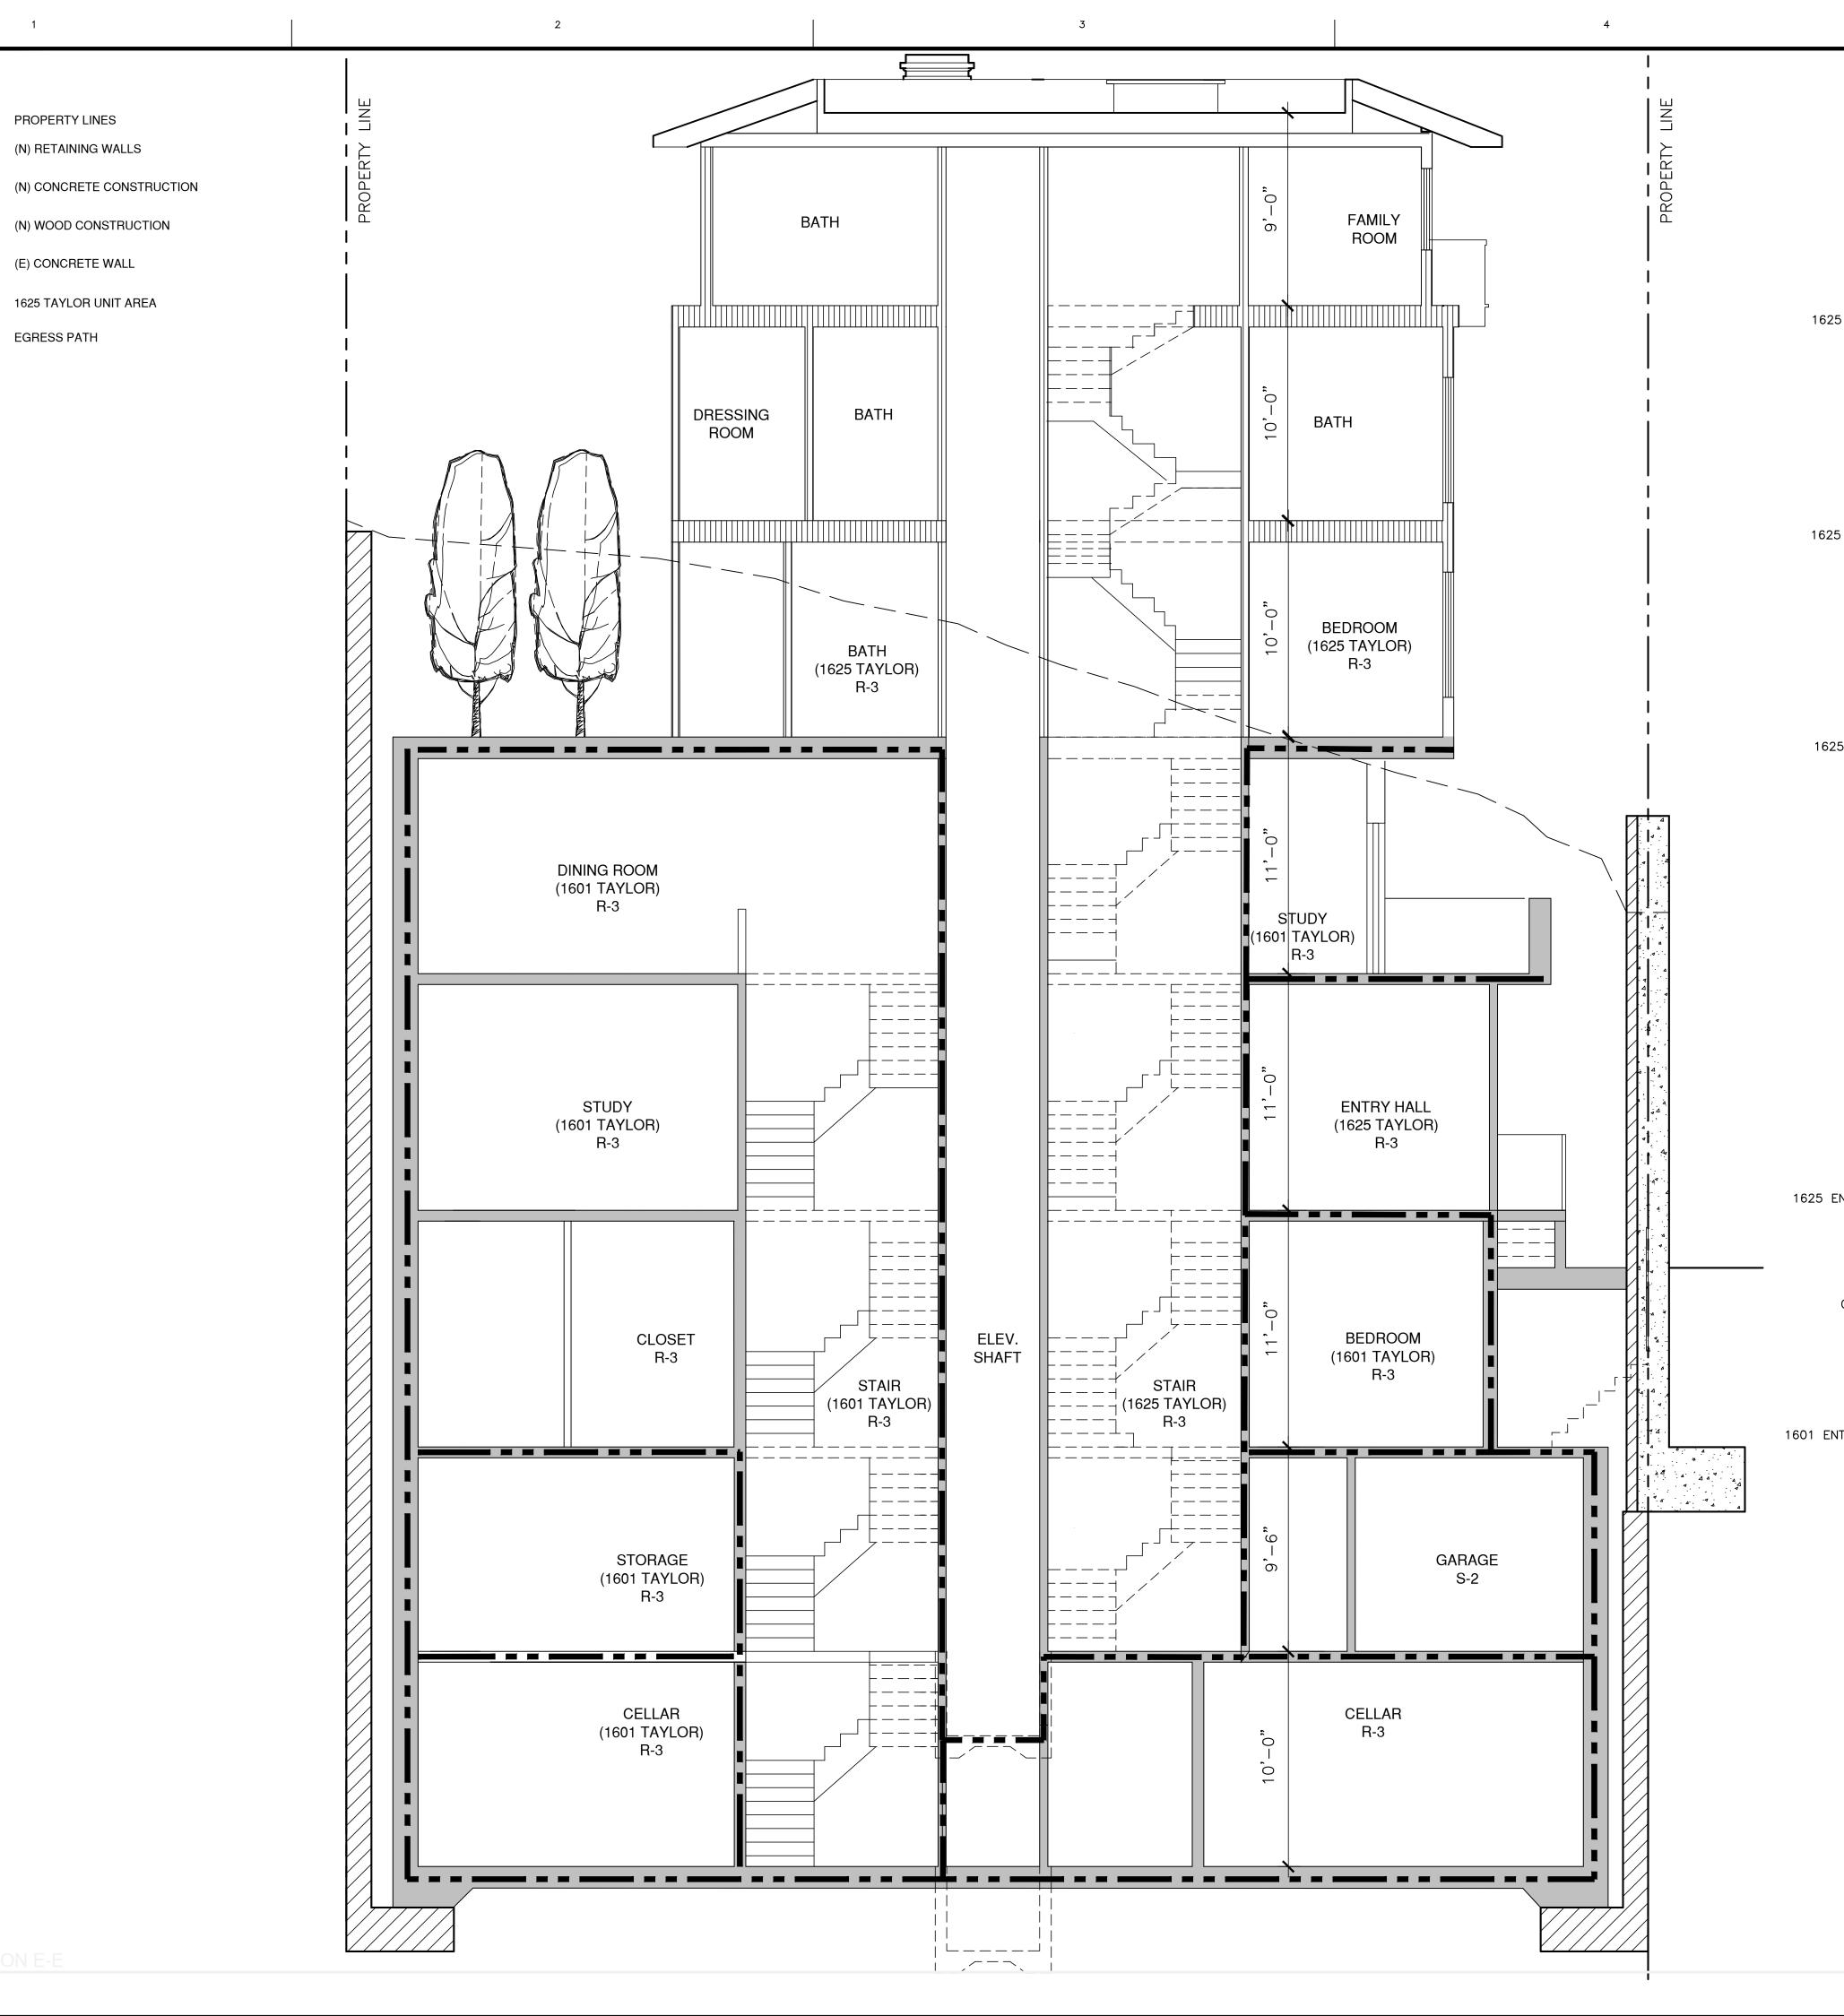




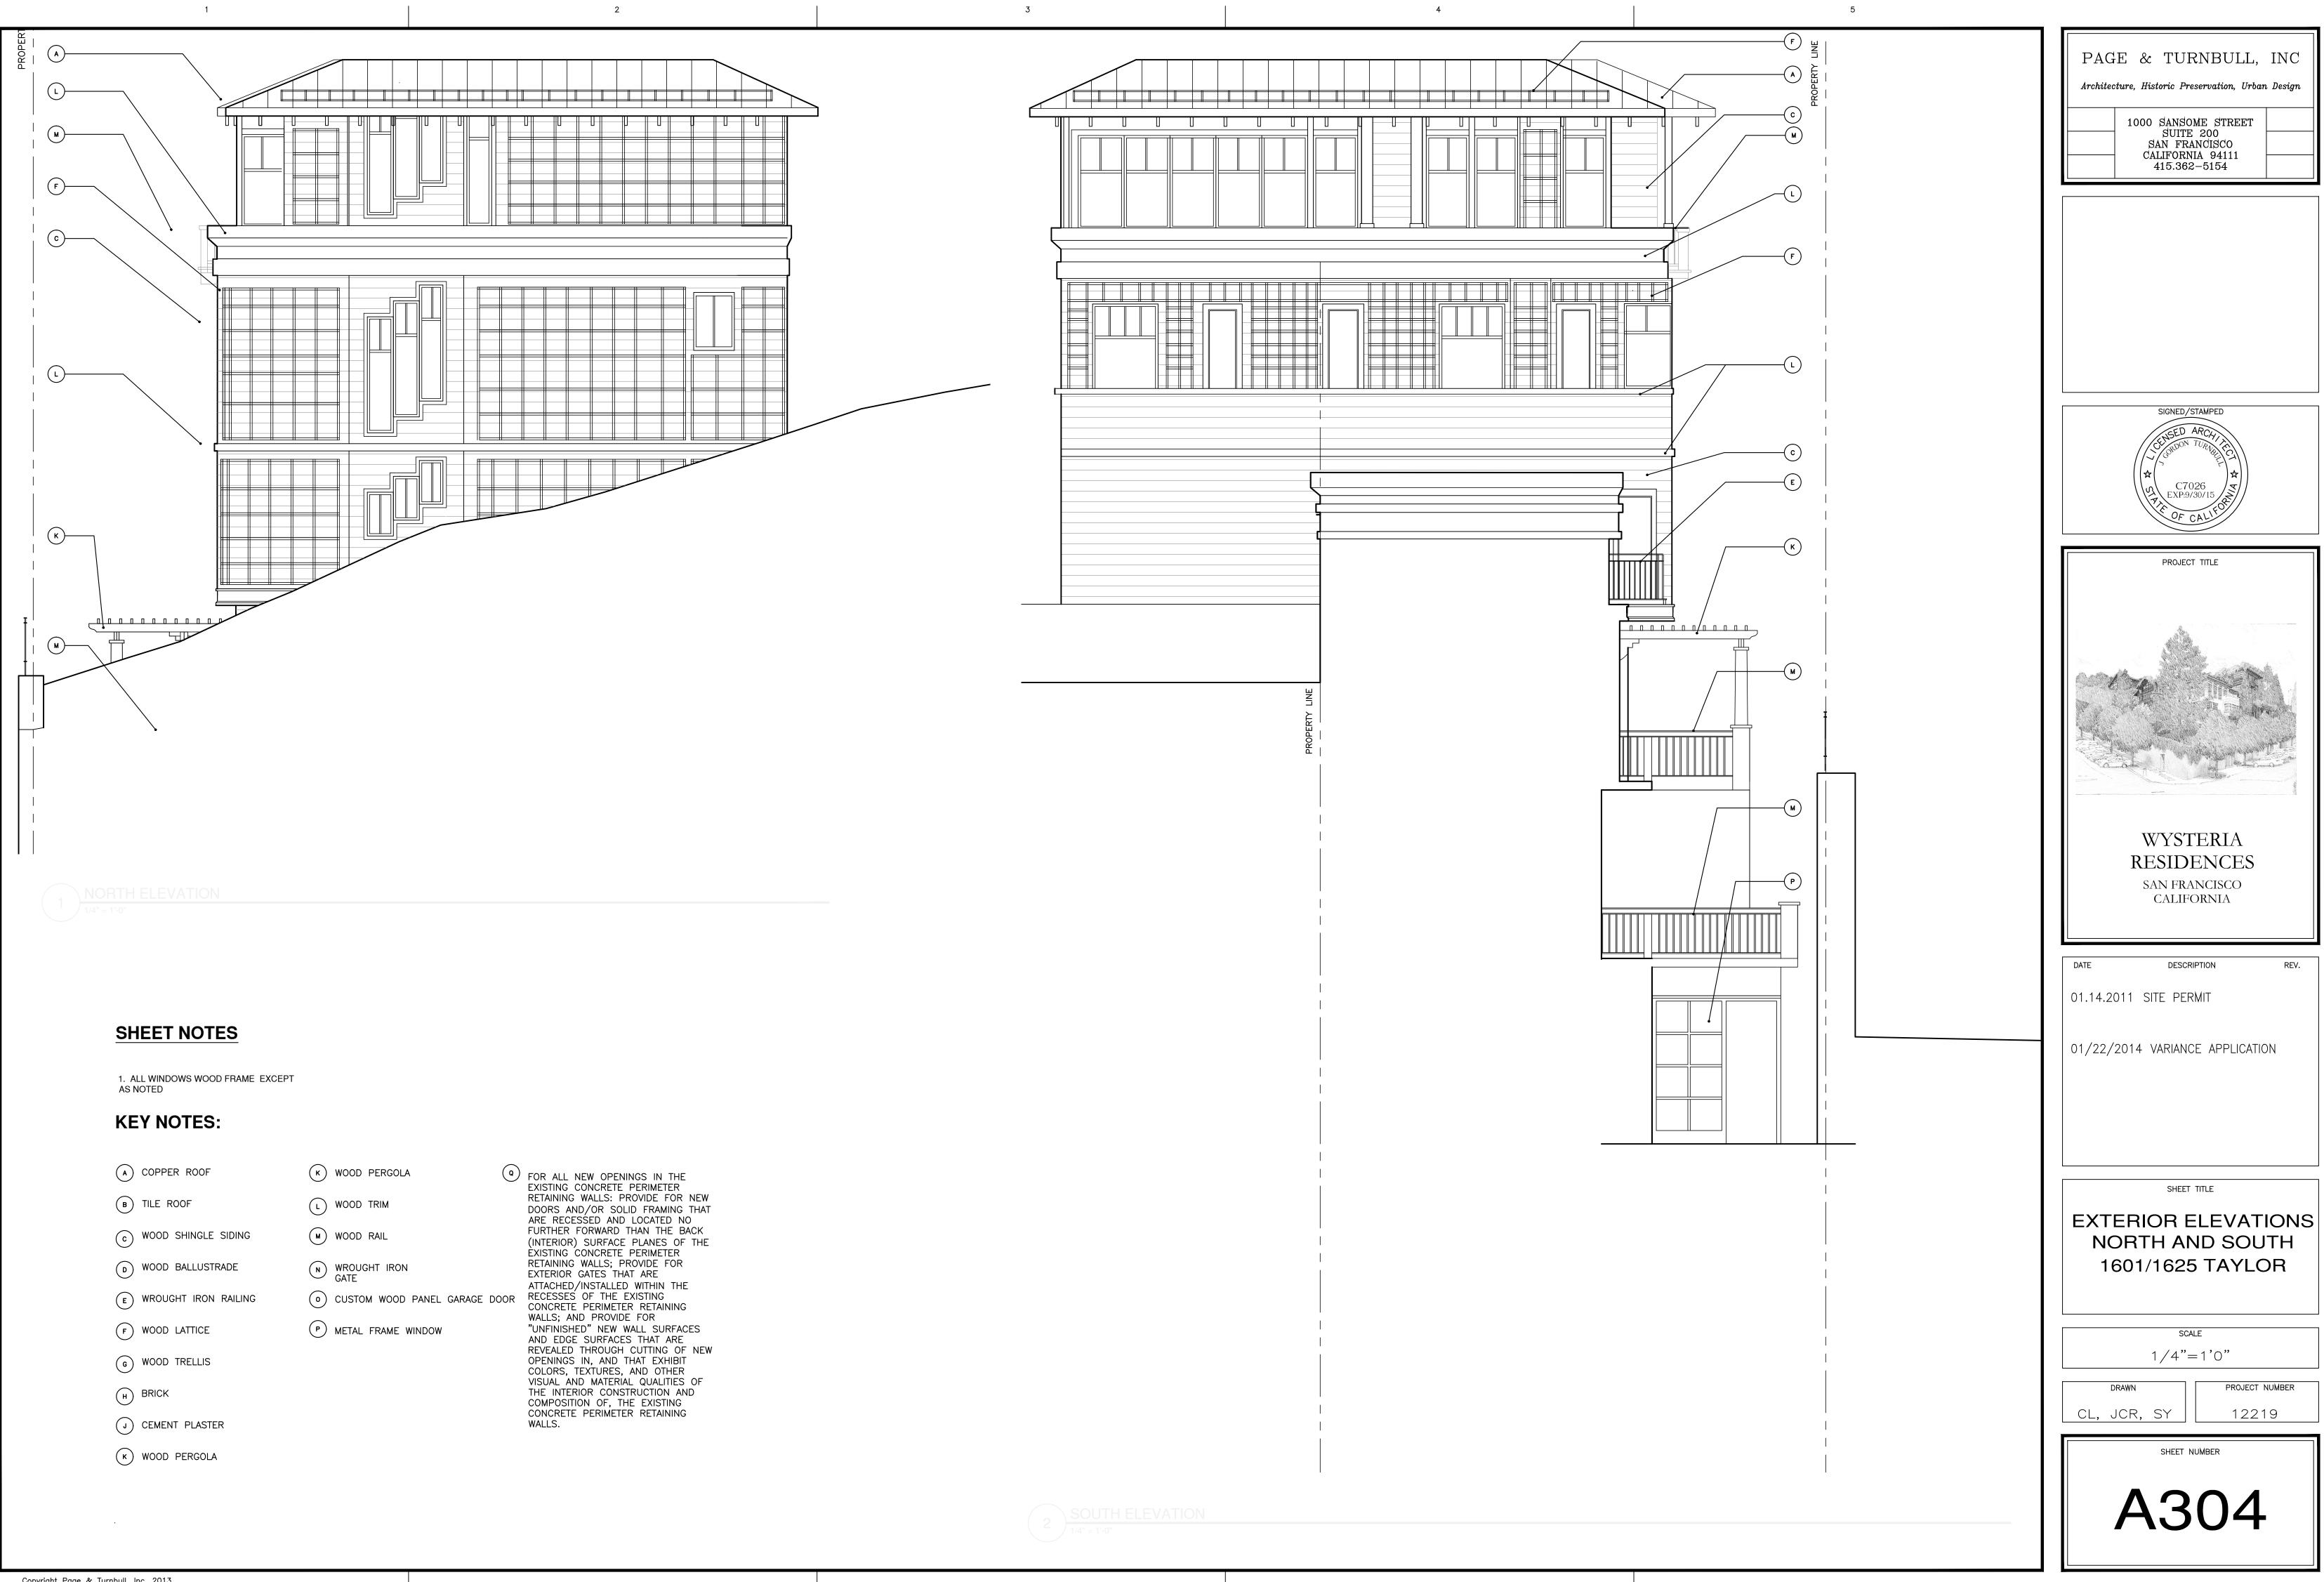

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	PAGE & TURNBULL, INC         Architecture, Historic Preservation, Urban Design         1000 SANSOME STREET         SUITE 200         SAN FRANCISCO         CALIFORNIA 94111         415.362-5154
275'-0"	SIGNED/STAMPED CFNSED ARCS CFNSED ARCS CF
H-3 (3626 SQ. FT.)	PROJECT TITLE
3_(A204) 249'-8"	WYSTERIA RESIDENCES SAN FRANCISCO CALIFORNIA
$\frac{2}{239'-8''}$	DATE DESCRIPTION REV. 01.14.2011 SITE PERMIT 01/22/2014 VARIANCE APPLICATION
$\frac{1}{229'-8"} \begin{pmatrix} A202 \\ -8" \end{pmatrix}$	
$GE (A201) \longrightarrow I I I I I I I I I I I I I I I I I I $	SHEET TITLE BUILDING SECTION C-C
GE (A201) 220'-2"	SCALE 1/4"=1'0" DRAWN CL, JCR PROJECT NUMBER 12219
$\frac{AR}{210'-2''} + \frac{1}{2}$	SHEET NUMBER A402



SECTION E-E

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LEGEND

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В

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295'–0" <b>Y</b>	
5 3RD LEVEL: LEVEL 5 259'-8"	
MAX CC&R HEIGHT	
278 8 1	
$5 \frac{2\text{ND LEVEL: LEVEL 4}}{271'-6"} \bullet$	
25 1ST LEVEL: LEVEL 3 ⊥	
$\frac{1\text{ST LEVEL: LEVEL 3}}{261'-8"} \bigoplus$	
LEVEL 2 (A204) 251'-2"	
251'-2" 🗡	
ENTRY: LEVEL 1 (A203) 🖵	
ENTRY: LEVEL 1 (A203) 240'-8"	
$\frac{1625 \text{ ENIRY}}{-237'-8"} \left( \frac{(A203)}{-237'-8"} \right)$	
1625 ENTRY (A203) 237'-8" CURB DATUM 236'-9"	
$\frac{1601 \text{ ENTRY}}{234'-2"} (A202)$	
NTRY: LEVEL 1 (A202) 📥	
NTRY: LEVEL $1 - (A202) + 229' - 8'' + 32''$	
GARAGE (A201)	
220'-2" 🍸	
CELLAR (A200) 210'-2"	
210'–2" 🚩	
	•

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Architecture, Historic Preservation, Urban Design
1000 SANSOME STREET
SUITE 200 SAN FRANCISCO CALIFORNIA 94111
415.362–5154
SIGNED/STAMPED
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RESIDENCES
SAN FRANCISCO
CALIFORNIA
DATE DESCRIPTION REV.
01.14.2011 SITE PERMIT
01.14.2011 SITE PERMIT 01/22/2014 VARIANCE APPLICATION
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01/22/2014 VARIANCE APPLICATION SHEET TITLE BUILDING SECTION E-E SCALE
01/22/2014 VARIANCE APPLICATION SHEET TITLE BUILDING SECTION E-E SCALE 1/4"=1'0" DRAWN PROJECT NUMBER
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