MEMO

Disclaimer for Review of Plans

The San Francisco Planning Code requires that the plans of certain proposed projects be provided to members of the public prior to the City's approval action on the project. Accordingly, any images of plans featured on this website are provided for the primary purpose of facilitating public input prior to the City's action. The City and County of San Francisco does not own the copyright to these images. Please be aware that the unauthorized reproduction, distribution, or alteration of these images may result in a violation of Federal Copyright Law (17 U.S.C.A. Sections 101 et seq.) and that any party who seeks to reproduce or alter these images does so at his or her own risk.

Additionally, plans provided on this website are limited to site plans, elevations and/or section details (floor plans and structural details may not be included). These are DRAFT PLANS being provided for public review PRIOR to the City's approval action on the project. Final plans may differ from those that are currently available for review.

1650 Mission St. Suite 400 San Francisco, CA 94103-2479

Reception: 415.558.6378

Fax: 415.558.6409

Planning Information: 415.558.6377

NOTICE OF PUBLIC HEARING

Hearing Date: Wednesday, October 22, 2014

Time: Not before 9:30 AM

Location: City Hall, 1 Dr. Carlton B. Goodlett Place, Room 408

Case Type: Variance (Rear Yard)
Hearing Body: Zoning Administrator

PROPERTY INFORMATION		APPLICATION INFORMATION	
Project Address:	104 Retiro Way	Case No.: Building Permit: Applicant (agent): Telephone: E-Mail:	2013.1739V
Cross Street(s):	Casa Way / Fillmore St.		2013.11.26.2917
Block /Lot No.:	0438A / 031A		Lorin Hill
Zoning District(s):	RH-3 / 40-X		(510) 654-2552
Area Plan:	N/A		Lhill@hillarch.com

PROJECT DESCRIPTION

The proposal is to construct an approximately 400 square-foot vertical addition (with roof terrace above) to the existing three-story, single family dwelling. The proposed vertical addition will be set back approximately 26 feet 6 inches from the front property line (inclusive of a 10-foot legislative front setback) and approximately 8 feet from the rear property line. The proposal includes interior renovations, removal of existing exterior stairs located within the rear yard, and construction of new interior stairs located within the existing building envelope that are not the subject of this variance.

PER SECTION 134 OF THE PLANNING CODE, requires the subject property to maintain a 15-foot deep rear yard. A portion of the proposed vertical addition will extend approximately 5 feet into the required rear yard; therefore, the project requires a variance from the rear yard requirement of the Planning Code.

ADDITIONAL INFORMATION

ARCHITECTURAL PLANS: The site plan and elevations of the proposed project are available on the Planning Department's website at: http://sf-planning.org/ftp/files/notice/2013.1739V.pdf

Members of the public are not required to provide personal identifying information when they communicate with the Commission or the Department. All written or oral communications, including submitted personal contact information, may be made available to the public for inspection and copying upon request and may appear on the Department's website or in other public documents.

FOR MORE INFORMATION, PLEASE CONTACT PLANNING DEPARTMENT STAFF:

Planner: Sharon M. Young Telephone: (415) 558-6346 E-Mail: sharon.m.young@sfgov.org

中文詢問請電: (415) 575-9010

Para información en Español llamar al: (415) 575-9010

GENERAL INFORMATION ABOUT PROCEDURES

HEARING INFORMATION

You are receiving this notice because you are either a property owner or resident that is adjacent to the proposed project or are an interested party on record with the Planning Department. You are not required to take any action. For more information regarding the proposed work, or to express concerns about the project, please contact the Applicant or Planner listed on this notice as soon as possible. Additionally, you may wish to discuss the project with your neighbors and/or neighborhood association, as they may already be aware of the project.

Persons who are unable to attend the public hearing may submit written comments regarding this application to the Planner listed on the front of this notice, Planning Department, 1650 Mission Street, Suite 400, San Francisco, CA 94103, by 5:00 pm the day before the hearing. These comments will be made a part of the official public record and will be brought to the attention of the person or persons conducting the public hearing.

Comments that cannot be delivered by 5:00 pm the day before the hearing may be taken directly to the hearing at the location listed on the front of this notice. Comments received at 1650 Mission Street after the deadline will be placed in the project file, but may not be brought to the attention of the Zoning Administrator at the public hearing.

BUILDING PERMIT APPLICATION INFORMATION

Pursuant to Planning Code Section 311 or 312, the Building Permit Application for this proposal may also be subject to notification of property owners and residents within 150-feet of the subject property. The mailing of such notification will be performed separately.

APPEAL INFORMATION

An appeal of the approval (or denial) of a **Variance application** by the Zoning Administrator may be made to the **Board of Appeals within 10 calendar days** after the Variance Decision Letter is issued by the Zoning Administrator.

An appeal of the approval (or denial) of a **building permit application** by the Planning Commission may be made to the **Board of Appeals within 15 calendar days** after the building permit is issued (or denied) by the Director of the Department of Building Inspection.

Appeals must be submitted in person at the Board's office at 1650 Mission Street, 3rd Floor, Room 304. For further information about appeals to the Board of Appeals, including current fees, contact the Board of Appeals at (415) 575-6880.

中文詢問請電: (415) 575-9010

Para información en Español llamar al: (415) 575-9010

Variance Submittal

Minick Residence

Additions & Renovations

104 Retiro Way

San Francisco, CA 94123

VICINITY MAP

Marina

PARCEL MAP

75.756

102.299

102.299

PROJECT SITE:

BLOCK & LOT # :

0438A / 031A

5

18 WHITNEY STREET

09 . 06 . 2013

as noted

PROJECT DIRECTORY

Elizabeth & Jeffrey Minick 104 Retiro Way San Francisco, CA 94123 H: 415.409.1802

Contractor:

To Be Determined

Lorin Hill Architect 6573 Shattuck Avenue Oakland, CA 94609 O: 510 . 654 . 2552 F: 510.654.2555

DRAWING LIST

COVER SHEET, PROJECT DATA & MAPS

EXISTING AND PROPOSED SITE / ROOF PLANS

EXISTING / DEMOLITION AND PROPOSED 1ST FLOOR PLANS

EXISTING / DEMOLITION AND PROPOSED 2ND FLOOR PLANS

EXISTING / DEMOLITION AND PROPOSED 3RD FLOOR PLANS

PROPOSED 4TH FLOOR PLAN AND ROOF TERRACE PLAN

EXISTING / DEMOLITION AND PROPOSED EXTERIOR ELEVATIONS

50 25 25 25 25 25 25 25 25 24.844 25.156 25 25 25

EXISTING AND PROPOSED BUILDING SECTIONS

EXISTING AND PROPOSED BUILDING SECTIONS

ARCHITECTURAL

A1.1

Structural Engineer: SEMCO Engineering Inc. 360 Langton Street, suite 304 San Francisco, CA 94103 O: 415.553.8810 F: 415 . 553 . 8768

Energy Compliance: Gene Clements 2348 McKinley Ave. Berkeley, CA 94703 O: 510.549.2019

PROJECT DESCRIPTION:

GENERAL NOTES

WITH THE FOLLOWING CALIFORNIA ADMINISTRATIVE CODES:

- 2010 SAN FRANCISCO BUILDING/ELECTRICAL/MECHANICAL/PLUMBING CODE AMENDMENTS

REGARDLESS OF WHAT IS SHOWN OR NOT ON THESE DRAWINGS. ALL WORK SHALL COMPLY

2. THE CONTRACTOR SHALL COMPLY WITH ANY OTHER APPLICABLE STATE OR LOCAL ORDINANCES

3. ANY DISCREPANCIES BETWEEN THE CONSTRUCTION DOCUMENTS AND ACTUAL SITE CONDITIONS

4. THESE DRAWINGS MAY NOT BE TO SCALE AND ARE FOR ILLUSTRATION PURPOSES ONLY. THE

5. DETAILS TAKE PRECEDENCE OVER SMALLER SCALE DRAWINGS. WRITTEN DIMENSIONS TAKE

WHERE SUCH ITEMS OCCUR. ALL MANUFACTURED ITEMS SHALL BE INSTALLED PER

CONFLICTS BETWEEN DRAWINGS AND MANUFACTURER'S RECOMMENDATIONS PRIOR TO

FULLY DESCRIBED IN THESE DOCUMENTS. ALL CONSTRUCTION SHALL BE WATERTIGHT.

SUBTRADE PERMITS AND BE RESPONSIBLE FOR SCHEDULING INSPECTIONS.

SHALL BE BROUGHT TO THE ATTENTION OF THE ARCHITECT IN WRITING FOR CLARIFICATION

CONTRACTOR SHALL VERIFY ALL DIMENSIONS AND EXISTING CONDITIONS IN THE FIELD. EACH

SUBCONTRACTOR SHALL MAKE MEASUREMENTS PERTAINING TO HIS/HER RESPECTIVE WORK AND

PRECEDENCE OVER GRAPHIC SCALE SHOWN ON THE DRAWINGS. DO NOT SCALE THE DRAWINGS.

AND EQUIPMENT FROM THE MFR'S. INSTALLATION DATA PRIOR TO STARTING LAYOUT IN AREAS

6. THE CONTRACTOR SHALL VERIFY THE ROUGH-IN DIMENSIONS FOR DOORS, WINDOWS, FIXTURES

MANUFACTURER'S RECOMMENDATIONS. CONTRACTOR SHALL NOTIFY THE ARCHITECT OF ANY

7. ALL BUILDING SYSTEMS AND ASSEMBLIES SHALL BE COMPLETE AND OPERATIVE THOUGH NOT

8. THE CONTRACTOR SHALL BE RESPONSIBLE FOR COORDINATING THE VARIOUS BUILDING TRADES

AND FOR COORDINATING BETWEEN THE VARIOUS CONSTRUCTION DOCUMENTS AS NECESSARY IN

9. THE OWNER SHALL PAY FOR THE GENERAL BUILDING PERMIT. THE CONTRACTOR SHALL PAY FOR

10. THE CONTRACTOR SHALL REMOVE FROM THE SITE ALL TRASH, WASTE, RUBBISH AND DEBRIS RESULTING FROM THE WORK AT REGULAR INTERVALS DURING THE COURSE OF THE WORK. ALL

SUCH WASTE SHALL BE LEGALLY DISPOSED OF OFF-SITE. PATCH DAMAGED FINISHES AS

11. SECURITY OF THE WORK SITE SHALL BE THE RESPONSIBILITY OF THE CONTRACTOR DURING THE

12. THE CONTRACTOR SHALL PROVIDE ALL TEMPORARY FACILITIES AS REQUIRED TO PROPERLY AND

SAFELY EXECUTE THE WORK. SUCH FACILITIES SHALL INCLUDE BUT ARE NOT NECESSARILY

CONTRACTOR SHALL MAINTAIN ONE EXISTING TOILET OPERABLE THROUGHOUT THE COURSE OF

14. UNLESS OTHERWISE NOTED ALL CONNECTIONS AND FASTENERS SHALL BE CONCEALED. THE USE

15. ANY OPENINGS LEFT IN FLOORS OR CEILINGS SHALL BE PROTECTED FOR THE SAFETY OF

17. ANY WORK INTERFACING WITH CITY PROPERTY OR CITY SERVICES SHALL BE PERFORMED PER

18. SUBMIT SHOP DRAWINGS AND MANUFACTURER'S DATA FOR APPROVAL BY ARCHITECT FOR:

CASEWORK, COUNTERS, APPLIANCES, LIGHTING FIXTURES, PLUMBING FIXTURES.

OF EXPOSED FASTENERS SHALL BE APPROVED BY THE DESIGNER. ALL EXTERIOR FASTENERS

LIMITED TO, SHORING, BRACING, SCAFFOLDING, BARRIERS AND TEMPORARY UTILITIES. THE

WORK DAY. THE WORK SITE SHALL BE SECURED AGAINST ENTRY DURING NON-WORK HOURS.

IN THE EVENT OF ANY CONFLICT THE MORE STRINGENT PROVISIONS SHALL APPLY.

PRIOR TO PROCEEDING WITH THE WORK. DO NOT PROCEED ON ASSUMPTIONS.

ALL DIMENSIONS ARE TO FACE OF FINISH UNLESS OTHERWISE NOTED.

1. ALL WORK SHALL COMPLY WITH THE REQUIREMENTS OF

2010 CALIFORNIA BUILDING CODE
2010 CALIFORNIA ELECTRICAL CODE

- 2010 CALIFORNIA ENERGY CODE

- TITLE 19 PUBLIC SAFETY

- TITLE 24 BUILDING STANDARDS

- 2010 CALIFORNIA PLUMBING CODE

- 2010 CALIFORNIA MECHANICAL CODE

- CAL/OSHA CONSTRUCTION SAFETY ORDERS

SHALL BE RESPONSIBLE FOR THE ACCURACY.

SETTING OUT ALL BUILDING LINES AND DETAILS.

13. ALL WORK SHALL BE INSTALLED PLUMB, LEVEL, AND TRUE.

SHALL BE STAINLESS STEEL OR HOT DIP GALVANIZED.

16. ALL DIMENSIONS ARE TO FACE OF FINISH UNLESS OTHERWISE NOTED.

THOSE WORKING ON SITE AND OTHERS.

SCHEDULE

SECTION

SIMILAR

SQUARE

STANDARD

STORAGE

STRUCTURAL

SUSPENDED

T & B TOP AND BOTTOM

THICK

TYPICAL

TREAD

NOTED

VERTICAL

WATERPROOF

TELEPHONE

TOP OF STEEL

STEEL

SPECIFICATION

SERVICE SINK

SEE STRUCTURAL

STAINLESS STEEL

TO BE DETERMINED

TONGUE AND GROOVE

TOP OF CONCRETE

UNLESS OTHERWISE

SHEET

SECT

SPEC

SQ

SS

SSD

STD

STL

STOR

T.B.D.

T & G

THK

TOC

TOS

TYP

VERT

Consists of several areas of improvement:

- Foundation replacement and ground floor build-out to habitable space / outboard stair enclosure. - Ground floor area will be reconfigured to a den/recreation room and a reduced parking space.

- A new enclosed stair from the kitchen provides access to the ground level.

- A bathroom remodel with the existing footprint of the bathroom containing a new layout. - A new stairway will be extended from the existing stairs up to the new fourth floor addition.

- A new vertical addition: master suite with small terrace

from or the house.	
ROJECT ADDRESS:	104 RETIRO WAY SAN FRANCISCO, CA 94123
ASSESSOR'S PARCEL NUMBER	BLOCK 0438A LOT 031A
ONING	RH-3
IEIGHT & BULK DISTRICT	40-X
RONT SETBACK	10 FT LEGISLATIVE
EAR YARD SETBACK	15 FT. MINIMUM, GRANFATHERED ENCROACHMENT BASED ON

DWELLING

GARAGE

1,389 SF

LICENSED C-16 DESIGN-BUILD SPRINKLER CONTRACTOR TO PROVIDE FIRE SPRINKLER SYSTEM UNDER SEPERATE PERMIT.

3. ALL ROOMS USED FOR SLEEPING PURPOSES WILL MEET THE REQUIREMENTS OF

SFBC SECTION 1026. REQUIREMENTS OF SFBC SECTION 406.1.4.

Fourth Floor

A stairway will be extended up to the roof of the fourth floor via a minimal sloped-roof penthouse volume providing access to a rooftop terrace covering much of the roof but not extending to the

DDO JEOT ADDDEGO	4 RETIRO WAY
	AN FRANCISCO, CA 94123
ASSESSOR'S PARCEL NUMBER BLO	OCK 0438A LOT 031A
ZONING	H-3
HEIGHT & BULK DISTRICT 40-	l-X
FRONT SETBACK 10	FT LEGISLATIVE
GR EN	FT. MINIMUM, RANFATHERED ICROACHMENT BASED ON /G. DEPTH = +/- 6'-6"

EXISTING TWO (2) ABOVE

REFERENCE SHEET A1.1 FOR PROJECT DATA SQUARE FOOTAGE CALCULATIONS.

- 1. FULL AUTOMATIC SPRINKLER SYSTEM WILL BE PROVIDED THROUGHOUT PER THE NOTE ON LINE 16 OF THE FORM III APPLICATION.
- 4. THE GARAGE SHALL BE SEPARATED FROM THE LIVING SPACE PER THE

PROJECT DATA

Rooftop View Terrace

PROJECT ADDRESS:	104 RETIRO WAY SAN FRANCISCO, CA 94123
ASSESSOR'S PARCEL NUMBER	BLOCK 0438A LOT 031A
ZONING	RH-3
HEIGHT & BULK DISTRICT	40-X
FRONT SETBACK	10 FT LEGISLATIVE
REAR YARD SETBACK	15 FT. MINIMUM, GRANFATHERED ENCROACHMENT BASED ON AVG. DEPTH = +/- 6'-6"
OCCUPANCY GROUP	R-3

- 2. ALL PROPOSED NEW DOORS WILL MEET THE REQUIREMENT OF SFBC SECTION

REQ'D **FINISH FLOOR** FLASH FLASHING

SYMBOLS

FIRE EXTINGUISHER

-----DETAIL NUMBER

ABREVIATIONS

ACOUS (AC) ACOUSTICAL

ALUM (AL) ALUMINUM

BD, (BRD) BOARD

BOTT (BOT) BOTTOM

APPROX

ARCH

BLDG

BLKG

CLKG

CONC

CONN

CONT

CORR

CTSK

ENCL

EXIST

EQUIP

CONSTR

AIR CONDITIONING

APPROXIMATE

BUILDING

BLOCKING

CENTER LINE

CERAMIC TILE

CEMENT

CEILING

CAULKING

CLOSET

COLUMN

CONCRETE

CONNECTION

CONTINUOUS

COUNTERSUNK

CONTROL JOINT

CORRIDOR

DOUBLE

DETAIL

DIAMETER

DIAGONAL

DIMENSION

DISPENSER

DOOR OPENING

DOWN

DOOR

EJ (EXP JT)EXPANSION JOINT

DRAWING

ELEVATION

ELECTRICAL

ENCLOSURE

EQUIPMENT

EXPANSION

EXTERIOR

EACH WAY

COOLER

HEATER

EQUIPMENT

FLOOR DRAIN

FOUNDATION

FIXED GLASS

CABINET

ELECTRIC WATER

ELECTRIC WATER

EXISTING

EQUAL

CONSTRUCTION

CLEAR

BLOCK

BEAM

ARCHITECTURAL

FOG

FOW

FOS

FTG

GALV

GSM

HCP

НМ

HDWD

LAM

LIQ

MACH

MAINT

MATL

MECH

MEMB

MAX

MET

MIN

NTS

OFF

OPNG

PL, Ł

REINF

GYP BD

FACE OF GIRT

FACE OF WALL

FACE OF STUDS

FOOT OR FEET

FULL SIZE

FOOTING

FURRING

GLASS

GALVANIZED

HANDICAP

HARDWOOD

JANITOR

KNOCKDOWN

KICKPLATE

LAMINATE

LAVATORY

LIQUID

MACHINE

MATERIAL

MAXIMUM

MECHANICAL

MEMBRANE

MISCELLANEOUS

MASONRY OPENING

NOT IN CONTRACT

NOT TO SCALE

ON CENTER

OFFICE

OPENING

OPPOSITE

PERPEN PERPENDICULAR

PLATE

PLYWD PLYWOOD

PTN PARTITION

PRECAST

PRECAST

REFERENCE

REINFORCED

RECESSED

REQUIRED

ROUGH OPENING

RAIN WATER LEADER

ROOM

METAL

MFR (MFGRANUFACTURER

MOUNTED

NO OR # NUMBER

MAINTENANCE

JOINT

HOLLOW METAL


GALVANIZED IRON

GALVANIZED SHEET

GYPSUM WALLBOARD

SEE WINDOW SCHEDULE

SEE DOOR SCHEDULE

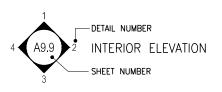



REFERENCE GRID


WALL CONSTRUCTION SEE WALL TYPES





ELEVATION/CONTROL POINT

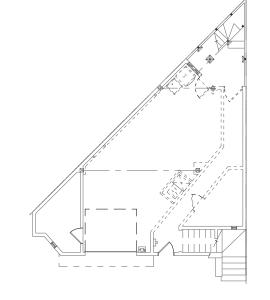


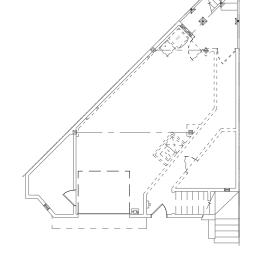


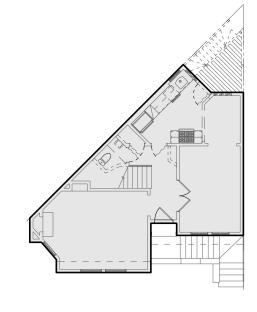


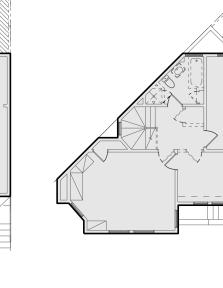


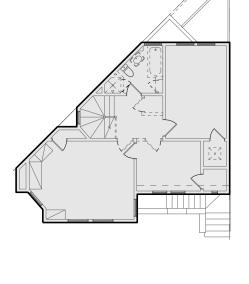

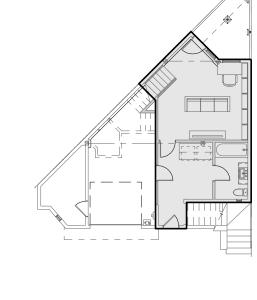


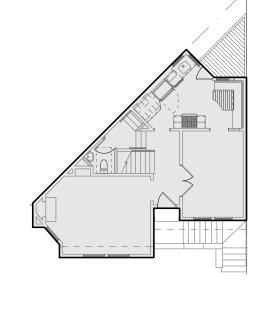

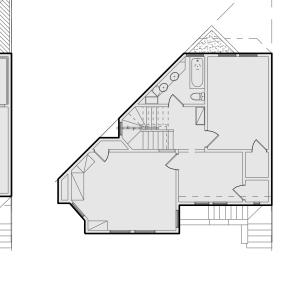

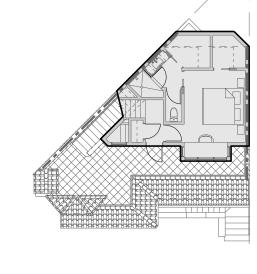



AREA DIAGRAMS

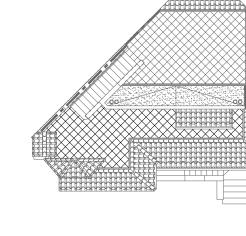

37.50

37.50

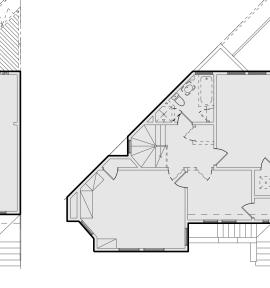

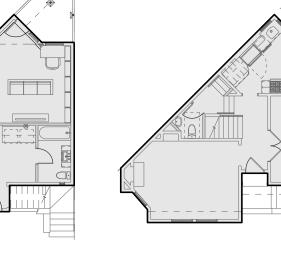



1.com 2552 2555

CRIN HILLOW

LORIN F.

HILL

C-23266

DO - 31

DO -

ONS & RENOVATION

Print Date:

10 . 09 . 2013
NEIGHBORHOOD
PRE-APPLICATION
MEETING

11 . 26 . 2013
VARIANCE
SUBMITTAL

SUBMITTAL

07 . 22 . 2014

VARIANCE
SUBMITTAL
REVISIONS

09 . 12 . 2014
REVISED VARIANCE
SUBMITTAL
REVISIONS

drawing title:
Site Plans

by:

ASQ
date:

07 . 09 . 2013
scale:

1/8"=1'-0"

A1.1

1. ALL DIMENSIONS ARE TO FACE OF FINISH UNLESS OTHERWISE NOTED

2. SEE STRUCTURAL DRAWINGS FOR PROPOSED SHEAR WALL LOCATIONS. (PATCH AND FILL TO MATCH EXISTING AT EXISTING WALLS

3. ALL INTERIOR WALL PARTITIONS ARE 2x4 WOOD STUDS WITH \S " GYP.


BD. EA. SIDE U.O.N.. PLUMBING WALLS ARE 2x6 STUDS, U.O.N. 4. ALL EXTERIOR WALL PARTITIONS ARE 2x6 WOOD STUDS WITH $\frac{5}{8}$ " GYF

BD. AT INTERIOR SIDE U.O.N. AND 3 LAYERS INTEGRAL COLOR CEMENT PLASTER o/ METAL LATH o/ 2 LAYERS GRADE 'D' BUILDING PAPER o/ PLYWOOD SHEATHING (S.S.D.) UNLESS OTHERWISE NOTED.

KEY NOTES:

- 1 PROVIDE §" W.P. GYP. IN WET AREAS
- 2 PROVIDE CERAMIC TILE 84" A.F.F. MIN. IN SHOWER STALL, SEE DTL. 3/A7.1
- 3 FOR TOILET CLEAREANCES, SEE DETAIL
- 4 TEMPERED GLASS SHOWER ENCLOSURE AND DOOR
- 5 20 MINUTE DOOR, PROVIDE SELF CLOSING HINGES, WEATHER STRIPPRING AND THRESHOLD
- 6 STAIRS AND HADRAILS PER IBC/CBC SECTION
- (7) EGRESS WINDOW/DOOR SEE DETAIL 2/A7.1
- 8 NEW INTERIOR WALL, TYP., SEE SHEET NOTES
- THE GARAGE SHALL BE SEPARATED FROM THE DWELLING UNIT AND ITS ATTIC AREA B MEANS OF %" GYPSUM BOARD APPLIED TO THE GARGE SIDE AT WALLS, PROVIDE %" TYPE 'X' GYP. AT CEILINGS AND UNDERSTAIRS.
- 10 FOR ALL OPEN GUARDRAILS MUST BE +42" A.F.F., ENSURE SPACING OF MEMBERS TO PREVENT PASSAGE OF 4" SPHERE. SEE IBC/CBC SECTION
- 11 LINE OF ROOF ABOVE
- 12 LINE OF WALL ABOVE
- 13 LINE OF WALL BELOW
- GAS-FUELED FIREPLACE WITH NON-COMBUSTIBLE HEARTH PER MFGR. REQS., SEE M.E.P. PLANS
- TERRA COTTA PAVERS o/ MORTAR BED o/ W.P. MEMBRANE o/ SLOPING STRUCTURE, S.S.D., TYP.
- BALCONY / DECK W/ REDWOOD DECKING W/ CONCEALED FASTENERS & IRON RAILING, S.S.D.
- BUILT-IN CASEWORK, TYP.
- BUILT-IN BANQUETTE SEATING, TYP.
- PARTIAL HEIGHT WALL W/ TERRA COTTA CAP, TYP.
- 20 BEAM ABOVE, S.S.D., TYP.
- BUILT-IN RECESSED SOAP/SHAMPOO NICHE, TYP.
- (E) STAIRS, REMOVE (E) PAVERS DOWN TO SÚBFLOOR, REPAIR WATER DAMAGE, PROVIDE (N) WATERPROOFING & TERRA COTTA TREADS/PAVERS o/ MORTAR, ALSO REPAIR WATER DAMAGE TO ADJACENT PLASTER STAIR
- 23 LINE OF COFFERED CEILING ABOVE., TYP.
- 6-FOOT HIGH REDWOOD FENCE., TYP.
- HANRAIL ANCHOR TO WALL +36" A.F.F., SEE DETAIL ON A7.1
- 26 2X6 STUD FRAMING AT 16" O.C.
- 27 2X8 STUD FRAMING AT 16" O.C.
- 2X10 STUD FRAMING AT 16" O.C.

WALL / DOOR LEGEND:

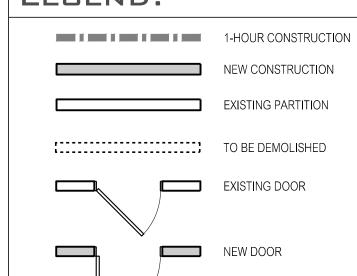

10.09.2013 NEIGHBORHOOD PRE-APPLICATION MEETING 11 . 26 . 2013 VARIANCE SUBMITTAL

07 . 22 . 2014 VARIANCE SUBMITTAL

REVISIONS 09 . 12 . 2014 REVISED VARIANCE SUBMITTAL REVISIONS

drawing title:

Existing / Demo. and Proposed First Floor

Plans

ASQ

09 . 11 . 2013 1/4"=1'-0"

1. ALL DIMENSIONS ARE TO FACE OF FINISH UNLESS OTHERWISE NOTED

2. SEE STRUCTURAL DRAWINGS FOR PROPOSED SHEAR WALL LOCATIONS. (PATCH AND FILL TO MATCH EXISTING AT EXISTING WALLS


3. ALL INTERIOR WALL PARTITIONS ARE 2x4 WOOD STUDS WITH %" GYP.

4. ALL EXTERIOR WALL PARTITIONS ARE 2x6 WOOD STUDS WITH $\frac{5}{8}$ " GYF BD. AT INTERIOR SIDE U.O.N. AND 3 LAYERS INTEGRAL COLOR CEMENT PLASTER o/ METAL LATH o/ 2 LAYERS GRADE 'D' BUILDING PAPER o/

KEY NOTES:

- 1 PROVIDE §" W.P. GYP. IN WET AREAS
- 2 PROVIDE CERAMIC TILE 84" A.F.F. MIN. IN SHOWER STALL, SEE DTL. 3/A7.1
- 3 FOR TOILET CLEAREANCES, SEE DETAIL
- 4 TEMPERED GLASS SHOWER ENCLOSURE AND DOOR
- 5 20 MINUTE DOOR, PROVIDE SELF CLOSING HINGES,
- WEATHER STRIPPRING AND THRESHOLD 6 STAIRS AND HADRAILS PER IBC/CBC SECTION
- T EGRESS WINDOW/DOOR SEE DETAIL 2/A7.1
- 8 NEW INTERIOR WALL, TYP., SEE SHEET NOTES
- 9 THE GARAGE SHALL BE SEPARATED FROM THE DWELLING UNIT AND ITS ATTIC AREA B MEANS OF %" GYPSUM BOARD APPLIED TO THE GARGE SIDE AT WALLS, PROVIDE %" TYPE 'X' GYP. AT CEILINGS AND UNDERSTAIRS.
- 10 FOR ALL OPEN GUARDRAILS MUST BE +42" A.F.F., ENSURE SPACING OF MEMBERS TO PREVENT PASSAGE OF 4" SPHERE. SEE IBC/CBC SECTION
- 11 LINE OF ROOF ABOVE
- 12 LINE OF WALL ABOVE
- 13 LINE OF WALL BELOW
- GAS-FUELED FIREPLACE WITH NON-COMBUSTIBLE HEARTH PER MFGR. REQS., SEE M.E.P. PLANS
- TERRA COTTA PAVERS o/ MORTAR BED o/ W.P. MEMBRANE o/ SLOPING STRUCTURE, S.S.D., TYP.
- BALCONY / DECK W/ REDWOOD DECKING W/ CONCEALED FASTENERS & IRON RAILING, S.S.D.
- BUILT-IN CASEWORK, TYP.
- BUILT-IN BANQUETTE SEATING, TYP.
- PARTIAL HEIGHT WALL W/ TERRA COTTA CAP, TYP.
- 20 BEAM ABOVE, S.S.D., TYP.
- BUILT-IN RECESSED SOAP/SHAMPOO NICHE, TYP.
- (E) STAIRS, REMOVE (E) PAVERS DOWN TO SUBFLOOR, REPAIR WATER DAMAGE, PROVIDE (N) WATERPROOFING & TERRA COTTA TREADS/PAVERS o/ MORTAR, ALSO REPAIR WATER DAMAGE TO ADJACENT PLASTER STAIR WALL, TYP.
- 23) LINE OF COFFERED CEILING ABOVE., TYP.
- 6-FOOT HIGH REDWOOD FENCE., TYP.
 - HANRAIL ANCHOR TO WALL +36" A.F.F., SEE DETAIL ON A7.1
- 26 2X6 STUD FRAMING AT 16" O.C.
- 28) 2X10 STUD FRAMING AT 16" O.C.

WALL / DOOR LEGEND:

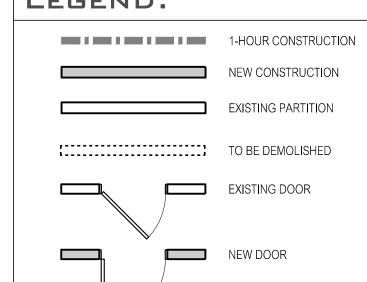

10.09.2013 NEIGHBORHOOD PRE-APPLICATION MEETING

11 . 26 . 2013 VARIANCE SUBMITTAL

07 . 22 . 2014

VARIANCE SUBMITTAL REVISIONS 09 . 12 . 2014

REVISED VARIANCE SUBMITTAL REVISIONS drawing title:

> Existing / Demo. and Proposed Second Floor Plans

ASQ

09 . 11 . 2013 1/4"=1'-0"

1. ALL DIMENSIONS ARE TO FACE OF FINISH UNLESS OTHERWISE NOTED

2. SEE STRUCTURAL DRAWINGS FOR PROPOSED SHEAR WALL LOCATIONS. (PATCH AND FILL TO MATCH EXISTING AT EXISTING WALLS


3. ALL INTERIOR WALL PARTITIONS ARE 2x4 WOOD STUDS WITH \S " GYP.


4. ALL EXTERIOR WALL PARTITIONS ARE 2x6 WOOD STUDS WITH $\frac{5}{8}$ " GYF BD. AT INTERIOR SIDE U.O.N. AND 3 LAYERS INTEGRAL COLOR CEMENT PLASTER o/ METAL LATH o/ 2 LAYERS GRADE 'D' BUILDING PAPER o/

KEY NOTES:

- 1 PROVIDE §" W.P. GYP. IN WET AREAS
- 2 PROVIDE CERAMIC TILE 84" A.F.F. MIN. IN SHOWER STALL, SEE DTL. 3/A7.1
- 3 FOR TOILET CLEAREANCES, SEE DETAIL
- 4 TEMPERED GLASS SHOWER ENCLOSURE AND DOOR
- 5 20 MINUTE DOOR, PROVIDE SELF CLOSING HINGES, WEATHER STRIPPRING AND THRESHOLD
- 6 STAIRS AND HADRAILS PER IBC/CBC SECTION
- T EGRESS WINDOW/DOOR SEE DETAIL 2/A7.1
- 8 NEW INTERIOR WALL, TYP., SEE SHEET NOTES
- THE GARAGE SHALL BE SEPARATED FROM THE DWELLING UNIT AND ITS ATTIC AREA B MEANS OF %" GYPSUM BOARD APPLIED TO THE GARGE SIDE AT WALLS, PROVIDE %" TYPE 'X' GYP. AT CEILINGS AND UNDERSTAIRS.
- 10 FOR ALL OPEN GUARDRAILS MUST BE +42" A.F.F., ENSURE SPACING OF MEMBERS TO PREVENT PASSAGE OF 4" SPHERE. SEE IBC/CBC SECTION
- 11 LINE OF ROOF ABOVE
- 12 LINE OF WALL ABOVE
- 13 LINE OF WALL BELOW
- GAS-FUELED FIREPLACE WITH NON-COMBUSTIBLE HEARTH PER MFGR. REQS., SEE M.E.P. PLANS
- TERRA COTTA PAVERS o/ MORTAR BED o/ W.P. MEMBRANE o/ SLOPING STRUCTURE, S.S.D., TYP
- BALCONY / DECK W/ REDWOOD DECKING W/ CONCEALED FASTENERS & IRON RAILING, S.S.D.
- BUILT-IN CASEWORK, TYP.
- BUILT-IN BANQUETTE SEATING, TYP.
- PARTIAL HEIGHT WALL W/ TERRA COTTA CAP,
- 20 BEAM ABOVE, S.S.D., TYP.
- BUILT-IN RECESSED SOAP/SHAMPOO NICHE, TYP.
- (E) STAIRS, REMOVE (E) PAVERS DOWN TO SÚBFLOOR, REPAIR WATER DAMAGE, PROVIDE (N) WATERPROOFING & TERRA COTTA TREADS/PAVERS o/ MORTAR, ALSO REPAIR WATER DAMAGE TO ADJACENT PLASTER STAIR
- 23 LINE OF COFFERED CEILING ABOVE., TYP.
- 6-FOOT HIGH REDWOOD FENCE., TYP.
- HANRAIL ANCHOR TO WALL +36" A.F.F., SEE DETAIL ON A7.1
- 26 2X6 STUD FRAMING AT 16" O.C.
- 27 2X8 STUD FRAMING AT 16" O.C.
- 28) 2X10 STUD FRAMING AT 16" O.C.

WALL / DOOR

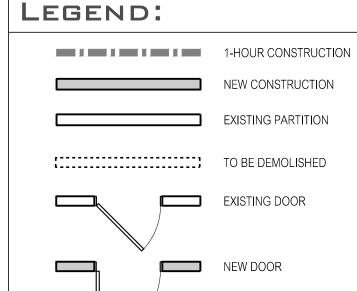

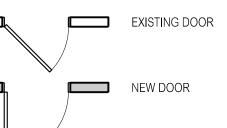

10.09.2013 NEIGHBORHOOD PRE-APPLICATION MEETING

11 . 26 . 2013 VARIANCE SUBMITTAL

07 . 22 . 2014 VARIANCE SUBMITTAL REVISIONS

09 . 12 . 2014 REVISED VARIANCE SUBMITTAL REVISIONS

drawing title: Existing / Demo.

and Proposed Third Floor Plans

ASQ

09 . 11 . 2013 1/4"=1'-0"

I. ALL DIMENSIONS ARE TO FACE OF FINISH UNLESS OTHERWISE NOTED

2. SEE STRUCTURAL DRAWINGS FOR PROPOSED SHEAR WALL LOCATIONS. (PATCH AND FILL TO MATCH EXISTING AT EXISTING WALLS

3. ALL INTERIOR WALL PARTITIONS ARE 2x4 WOOD STUDS WITH \S " GYP.

4. ALL EXTERIOR WALL PARTITIONS ARE 2x6 WOOD STUDS WITH 5%" GY BD. AT INTERIOR SIDE U.O.N. AND 3 LAYERS INTEGRAL COLOR CEMENT PLASTER o/ METAL LATH o/ 2 LAYERS GRADE 'D' BUILDING PAPER o/ PLYWOOD SHEATHING (S.S.D.) UNLESS OTHERWISE NOTED.

KEY NOTES:

- 1 PROVIDE §" W.P. GYP. IN WET AREAS
- 2 PROVIDE CERAMIC TILE 84" A.F.F. MIN. IN SHOWER STALL, SEE DTL. 3/A7.1
- FOR TOILET CLEAREANCES, SEE DETAIL
- 4 TEMPERED GLASS SHOWER ENCLOSURE AND DOOR

LORIN F.

짓 C-23266

7

10.09.2013

NEIGHBORHOOD PRE-APPLICATION MEETING

11 . 26 . 2013 VARIANCE SUBMITTAL

07 . 22 . 2014 VARIANCE

09 . 12 . 2014

Fourth Floor Plan

Roof Terrace Plan

REVISED VARIANCE SUBMITTAL REVISIONS

SUBMITTAL REVISIONS

drawing title:

and

ASQ


09 . 11 . 2013

1/4"=1'-0"

Proposed

- 5 20 MINUTE DOOR, PROVIDE SELF CLOSING HINGES, WEATHER STRIPPRING AND THRESHOLD
- 6 STAIRS AND HADRAILS PER IBC/CBC SECTION 1003.3.
- T EGRESS WINDOW/DOOR SEE DETAIL 2/A7.1
- 8 NEW INTERIOR WALL, TYP., SEE SHEET NOTES
- THE GARAGE SHALL BE SEPARATED FROM THE DWELLING UNIT AND ITS ATTIC AREA B MEANS OF %" GYPSUM BOARD APPLIED TO THE GARGE SIDE AT WALLS, PROVIDE %" TYPE 'X' GYP. AT CEILINGS AND UNDERSTAIRS.
- 10 FOR ALL OPEN GUARDRAILS MUST BE +42" A.F.F., ENSURE SPACING OF MEMBERS TO PREVENT PASSAGE OF 4" SPHERE. SEE IBC/CBC SECTION
- 11 LINE OF ROOF ABOVE
- 12 LINE OF WALL ABOVE
- 13 LINE OF WALL BELOW
- GAS-FUELED FIREPLACE WITH NON-COMBUSTIBLE HEARTH PER MFGR. REQS., SEE M.E.P. PLANS
- TERRA COTTA PAVERS o/ MORTAR BED o/ W.P. MEMBRANE o/ SLOPING STRUCTURE, S.S.D., TYP
- BALCONY / DECK W/ REDWOOD DECKING W/ CONCEALED FASTENERS & IRON RAILING, S.S.D.
- BUILT-IN CASEWORK, TYP.
- BUILT-IN BANQUETTE SEATING, TYP.
- PARTIAL HEIGHT WALL W/ TERRA COTTA CAP,
- 20 BEAM ABOVE, S.S.D., TYP.
- BUILT-IN RECESSED SOAP/SHAMPOO NICHE, TYP.
- (E) STAIRS, REMOVE (E) PAVERS DOWN TO SÚBFLOOR, REPAIR WATER DAMAGE, PROVIDE (N) WATERPROOFING & TERRA COTTA TREADS/PAVERS o/ MORTAR, ALSO REPAIR WATER DAMAGE TO ADJACENT PLASTER STAIR
- 23 LINE OF COFFERED CEILING ABOVE., TYP.
- 6-FOOT HIGH REDWOOD FENCE., TYP.
- HANRAIL ANCHOR TO WALL +36" A.F.F., SEE DETAIL ON A7.1
- 26 2X6 STUD FRAMING AT 16" O.C.
- 28) 2X10 STUD FRAMING AT 16" O.C.

WALL / DOOR

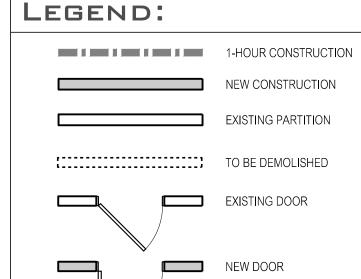

LDRIN HILL Com 6573 Shattuck Avenue tel. 510.654.2552 Oakland. California 94609 fax. 510.654.2555



MINICK RESIDENCE
ADDITIONS & RENOVATIONS

Print Date:

10 . 09 . 2013
NEIGHBORHOOD
PRE-APPLICATION
MEETING

11 . 26 . 2013
VARIANCE
SUBMITTAL

07 . 22 . 2014
VARIANCE
SUBMITTAL
REVISIONS

09 . 12 . 2014
REVISED VARIANCE
SUBMITTAL
REVISED VARIANCE
SUBMITTAL
REVISIONS

Building
Elevations

by:

ASQ
date:

09. 11 . 2013
scale:

1/4"=1'-0"

A4.1 project no.: 1217

MEETING

11 . 26 . 2013
VARIANCE
SUBMITTAL

07 . 22 . 2014

07 . 22 . 2014
VARIANCE
SUBMITTAL
REVISIONS

09 . 12 . 2014
REVISED VARIANCE
SUBMITTAL
REVISIONS

Building

Elevations

by:

ASQ
date:

07 . 23 . 2013
scale:

1/4"=1'-0"

A4.2



INICK RESIDENCE

DOITIONS & RENOVATIONS

Print Date:

10 . 09 . 2013
NEIGHBORHOOD
PRE-APPLICATION
MEETING

11 . 26 . 2013
VARIANCE
SUBMITTAL

07 . 22 . 2014

07 . 22 . 2014
VARIANCE
SUBMITTAL
REVISIONS

09 . 12 . 2014
REVISED VARIANCE
SUBMITTAL
REVISIONS

Building
Elevations

by:

ASQ
date:

07 . 23 . 2013
scale:

1/4"=1'-0"

A4.3



MINICK RESIDENCE
ADDITIONS & RENOVATION

Print Date:

10 . 09 . 2013

NEIGHBORHOOD

PRE-APPLICATION

MEETING

11.26.2013
VARIANCE
SUBMITTAL


07.22.2014
VARIANCE
SUBMITTAL
REVISIONS

09 . 12 . 2014
REVISED VARIANCE
SUBMITTAL
REVISIONS

Building
Elevations

by:
ASQ
date:
07 . 23 . 2013
scale:
1/4"=1'-0"

A4.4 project no.: 1217

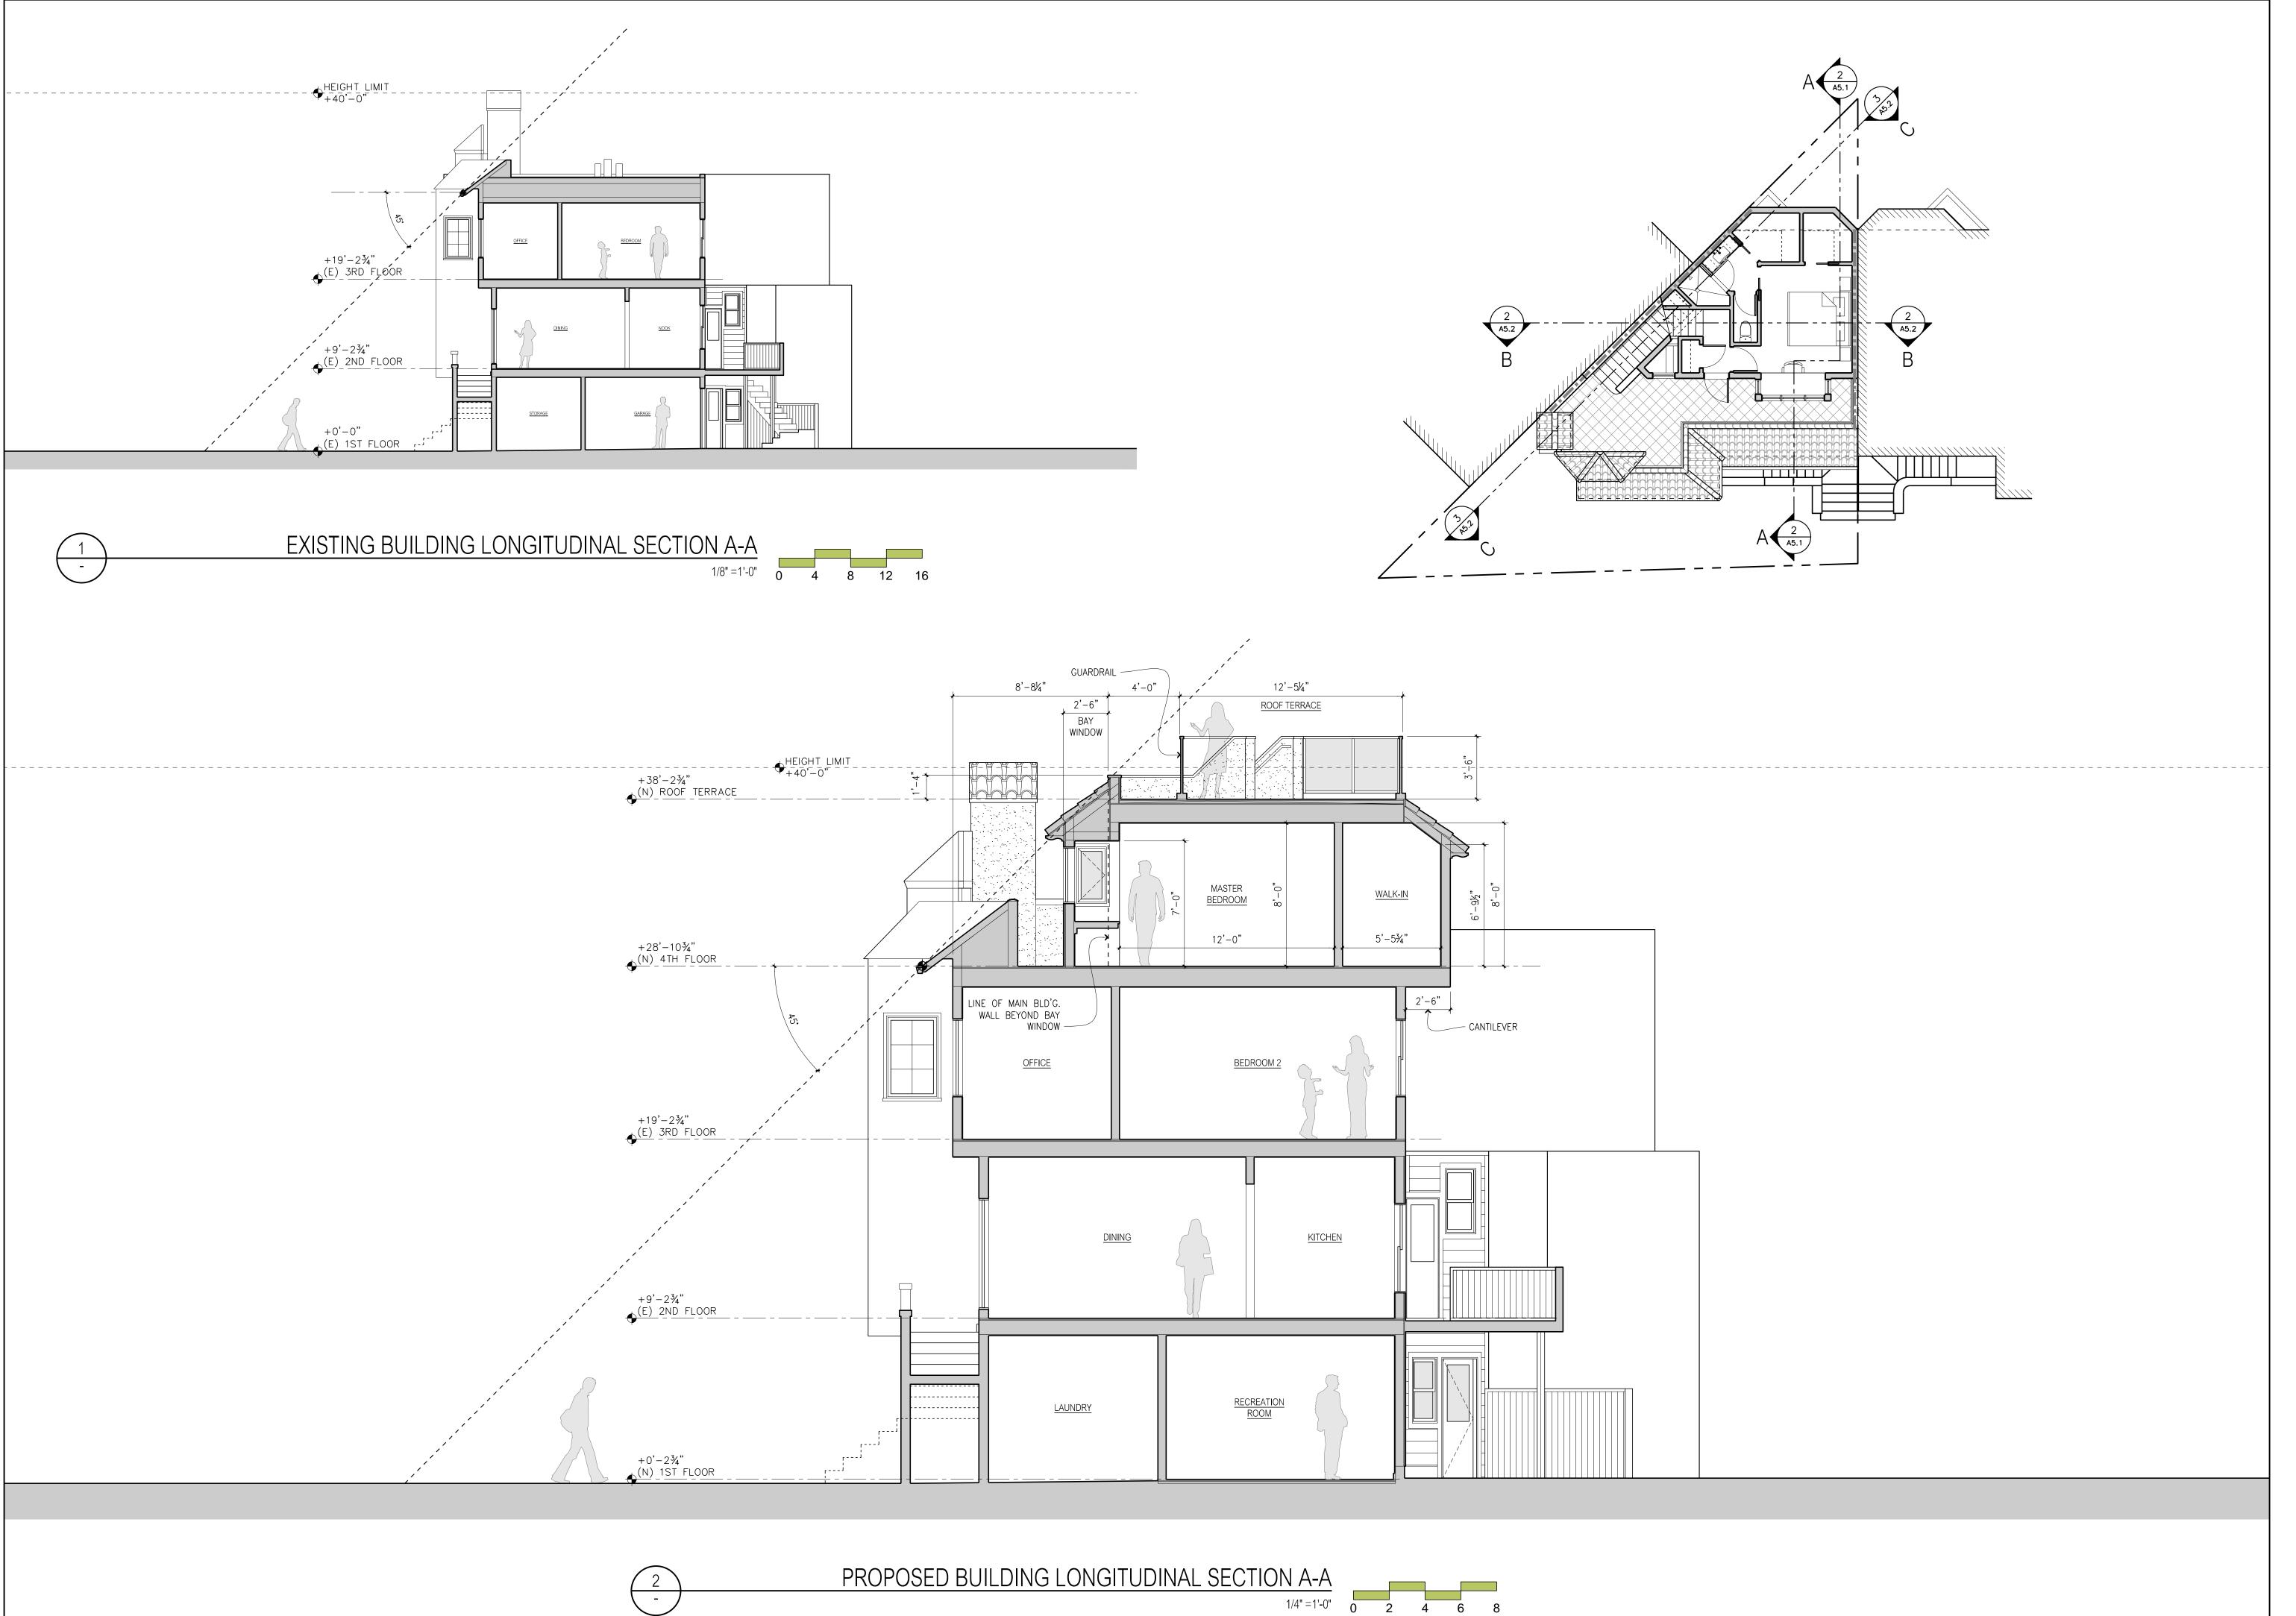





K RENOVATIONS

Print Date:

10 . 09 . 2013

NEIGHBORHOOD

PRE-APPLICATION

MEETING

MEETING

11 . 26 . 2013
VARIANCE
SUBMITTAL


07 . 22 . 2014
VARIANCE
SUBMITTAL
REVISIONS

09.12.2014
REVISED VARIANCE
SUBMITTAL
REVISIONS

Building
Sections

by:
ASQ
date:
10 . 09 . 2013
scale:
1/4"=1'-0"

A5.1

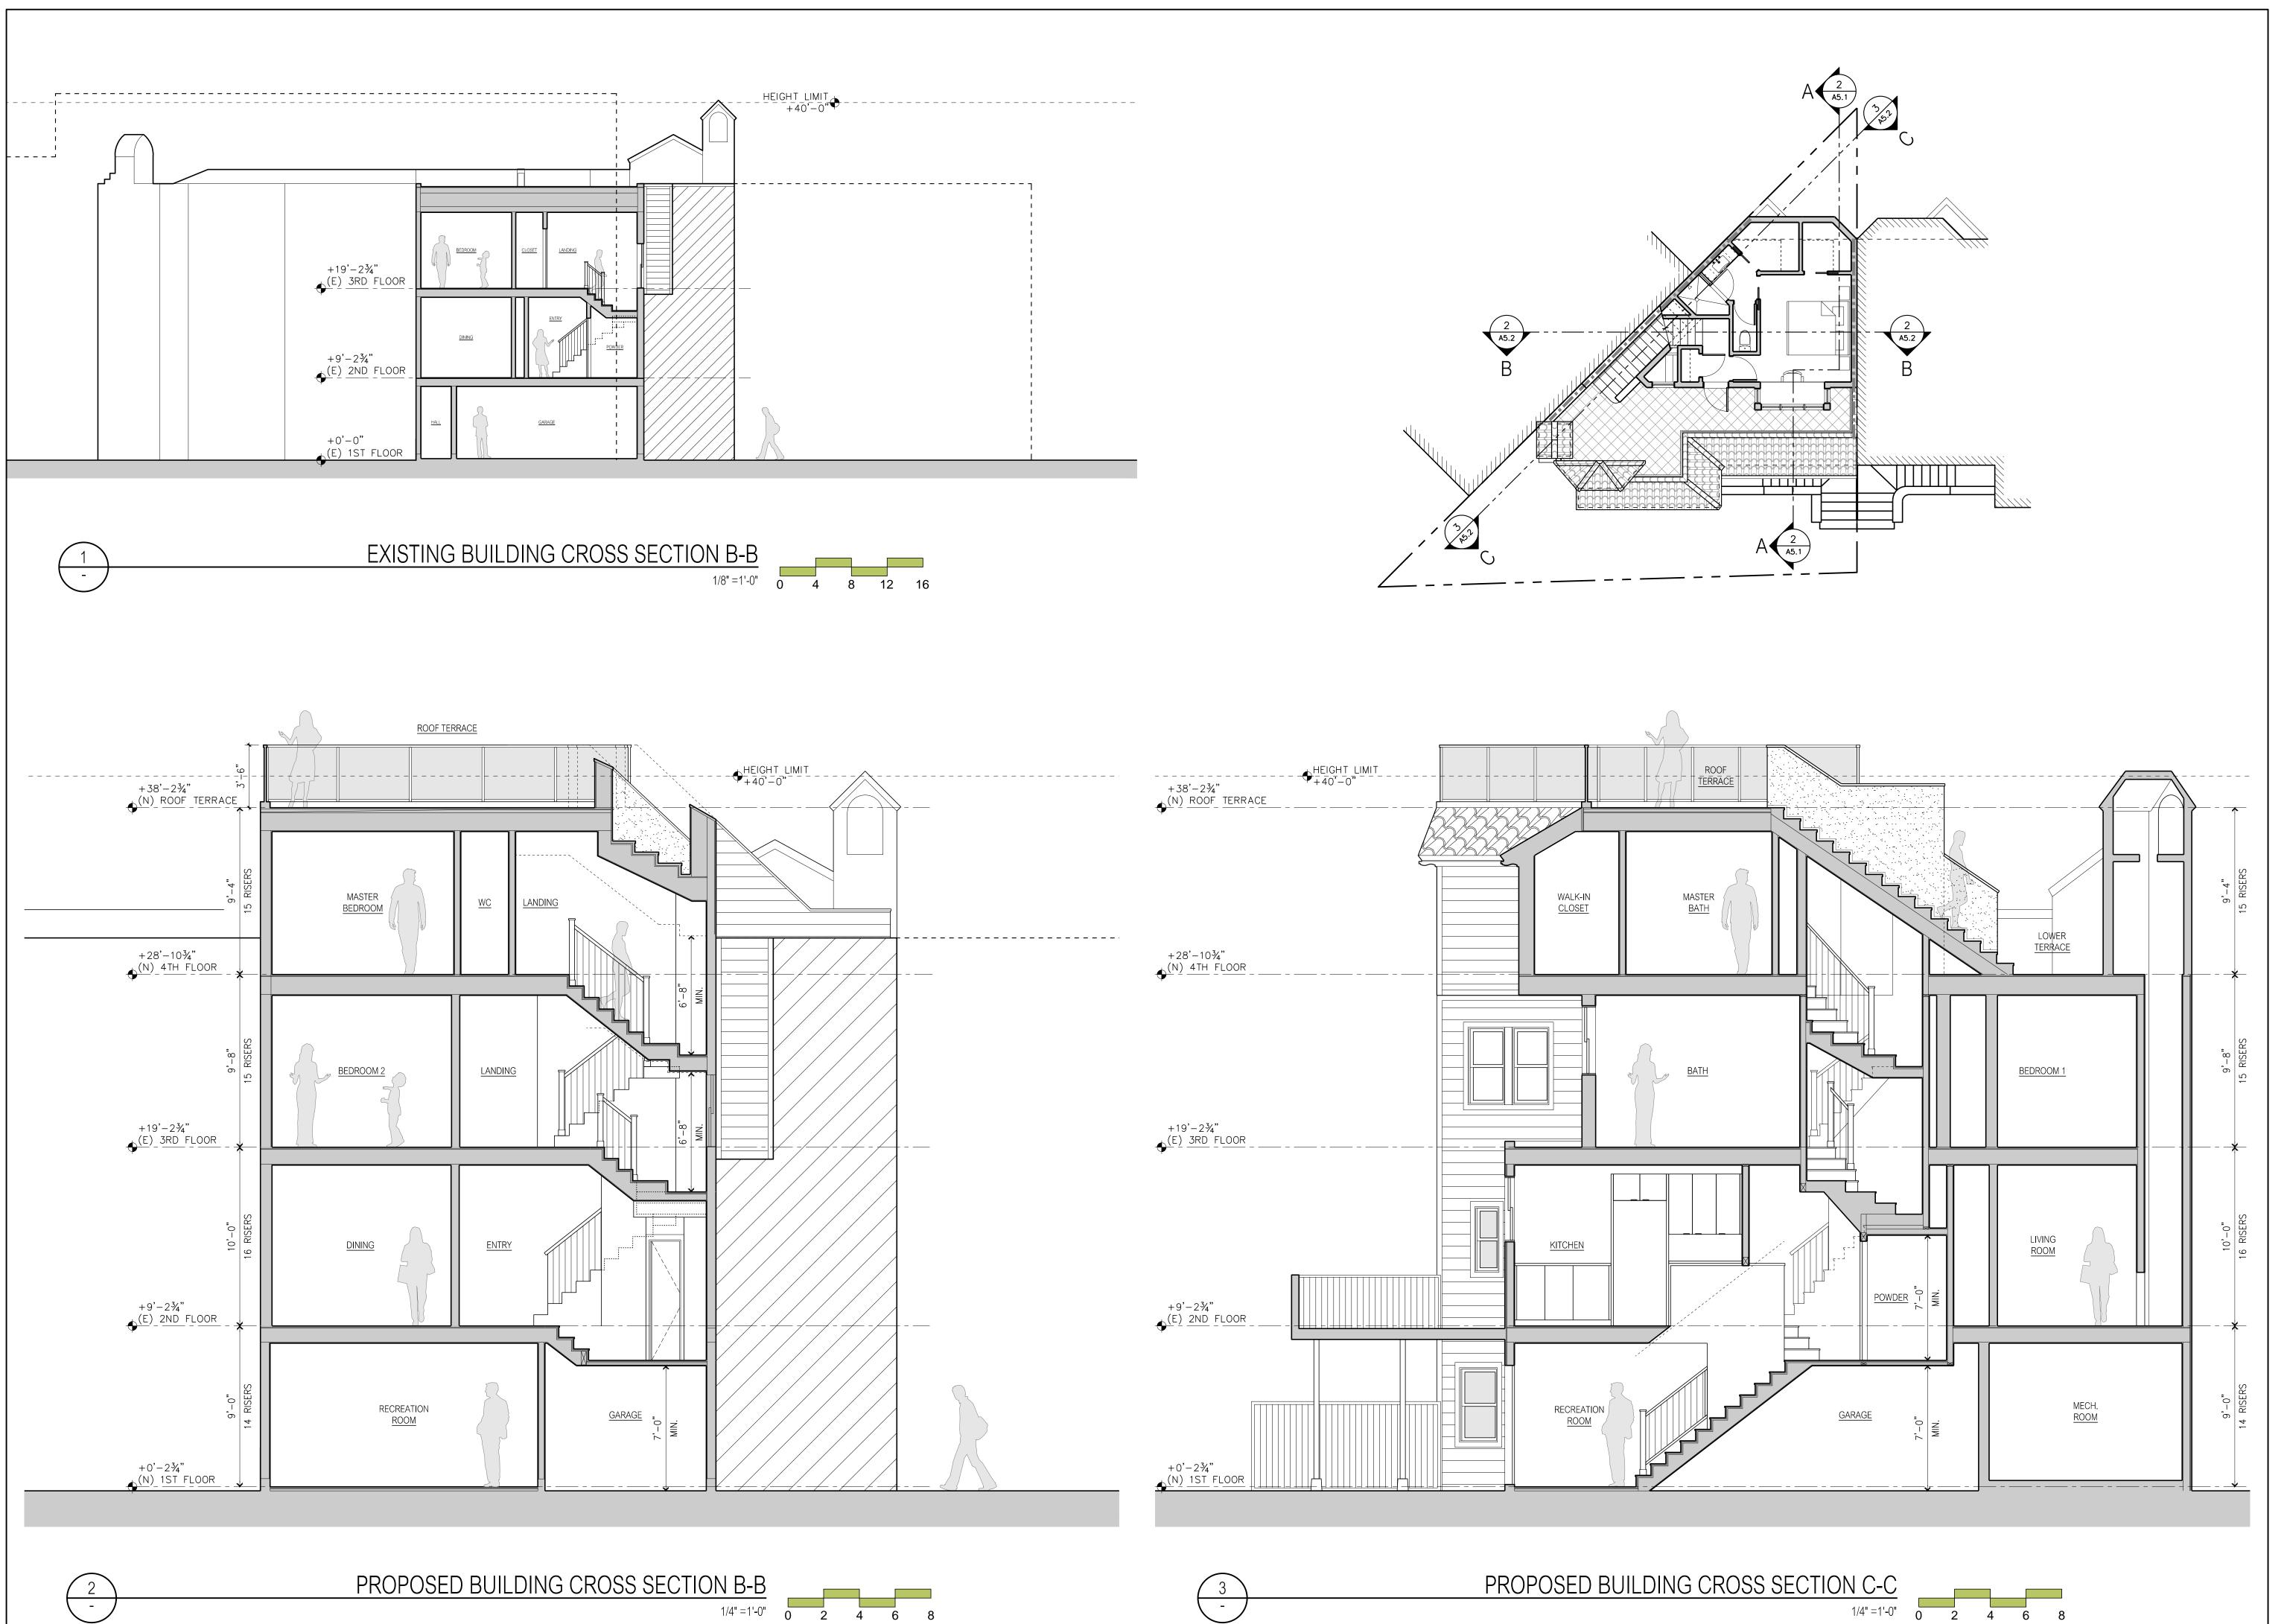

RIN HILCH.Com

k Avenue tel. 510.654.2552 fax. 510.654.2555





MINICK RESIDENCE
ADDITIONS & RENOVATION

Print Date:

10 . 09 . 2013
NEIGHBORHOOD
PRE-APPLICATION
MEETING

11 . 26 . 2013
VARIANCE
SUBMITTAL

07 . 22 . 2014
VARIANCE
SUBMITTAL
REVISIONS

09 . 12 . 2014
REVISED VARIANCE
SUBMITTAL
REVISED VARIANCE
SUBMITTAL
REVISIONS

Building
Sections

by:
ASQ
date:
10 . 09 . 2013
scale:
1/4"=1'-0"

A5.2 project no.: 1217