



# SAN FRANCISCO PLANNING DEPARTMENT

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## Executive Summary

HEARING DATE: JULY 22, 2010

*Date:* July 15, 2010  
*Case No.:* **2009.1117C**  
*Project Address:* **1100 OCEAN AVENUE**  
*Zoning:* Ocean Avenue NC-T (Neighborhood Commercial Transit)  
55-X Height and Bulk District  
*Block/Lot:* 3180/001  
*Project Sponsor:* Steve Rajninger  
Herman Coliver Locus Architecture  
363 Clementina Street  
San Francisco, CA 94103  
*Staff Contact:* Michael Smith – (415) 558.6322  
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### PROJECT DESCRIPTION

The request is for Conditional Use Authorization pursuant to Planning Code Sections: 737.11, for development of a lot that is greater than 9,999 square-feet; and Planning Code Sections 303 and 304 to allow a Planned Unit Development, with a request for exceptions from Planning Code Sections: 134 (rear yard); 135 (open space dimensions); and 136 (permitted obstructions over streets and alleys).

The proposal is to demolish the existing bus shelter and surface parking lot and to construct a mixed-use, five-story, 55-foot-tall building totaling approximately 86,500 gross square feet (gsf) with five- off-street parking spaces all as part of a Planned Unit Development (PUD). The project would include 71 affordable dwelling units and approximately 7,300 gsf of ground-floor commercial space (tenants not yet determined). The project requires subdividing the 30-acre lot creating a 25,772 square-foot lot with approximately 137-feet of frontage on Ocean Avenue.

The project is a joint partnership between the Mayor's Office of Housing and the Bernal Heights Neighborhood Center. The building will have four levels of residential occupancy above ground-floor retail space. The residential units will be provided as follows: (18) studio units, (18) one-bedroom units, (21) two-bedroom units, and (13) three-bedroom units. Forty-eight percent of the units contain two-bedrooms or more. The units are 100% affordable with approximately 21 of the units intended for occupancy by young adults transitioning out of foster care. The remaining residential units are intended for occupancy by households earning less than 50% of area median income. The parking garage is located at grade level and is accessed from the Lee Avenue extension. The garage contains five- off-street parking spaces including a handicap accessible space and a car share space. The building will have 32 class 1 bicycle parking spaces for the residential space and four class 1 bicycle parking spaces for the

commercial space. The remainder of the ground floor will provide supportive service and community space.

The Project includes approximately 7,841 square-feet of on-site residential open space with the remainder of the open space requirement being met by the proposed adjacent public plaza open space. The adjacent open space will be developed by the City separate from the project. The primary areas of on-site open space are located within the courtyard at the podium level and the rear yard.

## **SITE DESCRIPTION AND PRESENT USE**

The Project Site (Assessor's Block 3180, Lot 001) is a City owned parcel located on the north side of Ocean Avenue, between Phelan and Plymouth Avenues. The lot measures 30-acres in area with frontage on both Ocean and Phelan Avenues. The project site is located just west of Highway 280 and San Francisco City College. The property is improved with the PUC water reservoir at the rear, the Phelan Loop bus turnaround and layover area, a surface parking lot for 23 vehicles, and a fire station. The property is on the border of the Westwood Park and Ingleside neighborhoods. The Project Site is within the boundaries of the Balboa Park Station Area Plan and was recently rezoned from NC-2 (Small-Scale, Neighborhood Commercial) Zoning District to the Ocean Avenue NCT (Neighborhood Commercial Transit) Zoning District and the height limit for the property was changed in the process from a 65-A Height and Bulk District to a 55-X Height and Bulk District.

The Balboa Park Station Area Plan calls for rerouting the Phelan Loop bus turnaround to circle the fire station.

## **SURROUNDING PROPERTIES AND NEIGHBORHOOD**

The Ocean Avenue NCT District is mixed use, transitioning from a predominantly one- and two-story retail district to include taller buildings at its eastern end. The Kragen site, which the Commission approved in May 2009, is one such taller building adjacent to the site to the west. The "Kragen" development includes 173 dwelling units and a ground floor grocery store. The grocery store requires a truck hammerhead easement that is partially located with in the required rear yard of the subject property. To the north, the property abuts an empty PUC water reservoir that is currently used by City College of San Francisco for parking. To the east the site abuts the existing fire station. Across Ocean Avenue, to the south of the site, is a vacant corner lot, a McDonald's restaurant, and a modern, four-story mixed-use building as well as two smaller scale mixed use buildings. The MUNI K-Ingleside line travels down the center of Ocean Avenue with east and west bound MUNI stops in front of the site. The MUNI stops continue the length of the block and consist of raised platforms with barriers, ADA accessible boarding ramps, and covered bus shelters. City College of San Francisco's main campus is located northeast of the site. The single-family neighborhoods of Westwood Park and Ingleside flank Ocean Avenue to the north and south respectively.

## **ENVIRONMENTAL REVIEW**

Pursuant to CEQA Guidelines Section 15168, the Planning Department conducted a program-level EIR for the *Balboa Park Station Area Plan*. The area plan EIR was also a project-level EIR that analyzed the

proposed project at 11 Phelan Avenue (the "Phelan Loop Site"). The analysis was performed at a project level to address the environmental effects associated specifically with the proposed housing project at 11 Phelan Avenue. Pursuant to CEQA Guidelines Section 15090, the Planning Commission certified the Final EIR on December 4, 2008, in its Motion No. 17774. No appeal of the certification was filed with the Department. The Commission found significant unavoidable environmental impacts for the Balboa Park Station Area Plan and related approvals that could not be mitigated to a level of non-significance. Pursuant to CEQA Guidelines Section 15093, the Commission adopted a statement of overriding considerations for approving the Plan on December 4, 2008, in its Motion No. 17776. The Board of Supervisors made the same findings in Ordinance Nos. 58-09, 59-09, 60-09, and 61-09. Said motion and ordinances are incorporated herein by reference. As part of the Planning Commission's actions related to the 11 Phelan Avenue, the Commission is adopting additional CEQA findings specific to this development project.

### HEARING NOTIFICATION

TYPE	REQUIRED PERIOD	REQUIRED NOTICE DATE	ACTUAL NOTICE DATE	ACTUAL PERIOD
Classified News Ad	20 days	July 2, 2010	June 30, 2010	22 days
Posted Notice	20 days	July 2, 2010	July 2, 2010	20 days
Mailed Notice	20 days	July 2, 2010	July 2, 2010	20 days

### PUBLIC COMMENT

At the completion of this report the Department had received no comments from the neighborhood regarding this project.

### ISSUES AND OTHER CONSIDERATIONS

Currently there are no tenants for the ground floor commercial space. The applicant intends to have several smaller commercial spaces with a café at the corner adjacent to the open space plaza. The applicant is aware that a tenant would need to obtain the proper approvals prior to opening.

The project is exempt from the Balboa Park Impact Fee requirement pursuant to Section 331 of the Code because it is a 100% affordable project.

The Project site is well served by MUNI's K-Ingleside line as well as the 15, 29, 36, 43, and 49 buses.

The sponsor proposes that the dwellings will be rental units which will help to fill the need for affordable rental housing in the Ocean Avenue neighborhood.

Pursuant to Section 331 of the Code, the project requires payment into the Balboa Park Community Improvements Fund. The fee is currently set at \$8.00 per net occupied square foot

of residential development and \$1.50 per square-foot of net additional commercial square-footage. The project includes 79,166 gross square-feet of residential uses and 7,300 gross square-feet of commercial uses. Per the Balboa Park Community Improvements Fund the project currently requires a payment of approximately \$633,000 for residential uses and \$11,000 for commercial uses.

### REQUIRED COMMISSION ACTION

In order for the Project to proceed, the Commission must grant Conditional Use Authorization pursuant to Section 737.11 of the Planning Code for development of a lot that is greater than 9,999 square-feet; Planning Code Sections 303 and 304 to allow a Planned Unit Development, with a request for exceptions from Planning Code Sections: 134 (rear yard); 135 (open space dimensions); and 136 (permitted obstructions over streets and alleys); and adopt CEQA findings.

### BASIS FOR RECOMMENDATION

- The Project would provide 71-units of affordable housing in a neighborhood that is underserved by this use.
- The Project strengthens the Ocean Avenue commercial district.
- The lack of off-street parking takes advantage of the site's transit rich location.
- The Project creates a sense of place on a block now comprised of under-used, and derelict structures and surface parking, on a key site opposite a significant cultural institution.

<b>RECOMMENDATION:</b> <b>Approve with Conditions and Adopt CEQA Findings</b>
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### Attachment Checklist

- |   |   |
|---|---|
| <input checked="" type="checkbox"/> Executive Summary               | <input checked="" type="checkbox"/> Project sponsor submittal |
| <input checked="" type="checkbox"/> Draft Motion with CEQA Findings | Drawings: <u>Existing Conditions</u>                          |
| <input checked="" type="checkbox"/> Environmental Determination     | <input checked="" type="checkbox"/> Check for legibility      |
| <input checked="" type="checkbox"/> Zoning District Map             | Drawings: <u>Proposed Project</u>                             |
| <input checked="" type="checkbox"/> Height & Bulk Map               | <input checked="" type="checkbox"/> Check for legibility      |
| <input checked="" type="checkbox"/> Parcel Map                      |   |
| <input checked="" type="checkbox"/> Sanborn Map                     |   |
| <input checked="" type="checkbox"/> Aerial Photo                    |   |
| <input checked="" type="checkbox"/> Context Photos                  |   |
| <input checked="" type="checkbox"/> Site Photos                     |   |

Exhibits above marked with an "X" are included in this packet

\_\_\_\_\_ MES

Planner's Initials



# SAN FRANCISCO PLANNING DEPARTMENT

Subject to: (Select only if applicable)

- Inclusionary Housing (Sec. 315)
- Jobs Housing Linkage Program (Sec. 313)
- Downtown Park Fee (Sec. 139)
- First Source Hiring (Admin. Code)
- Child Care Requirement (Sec. 314)
- Other

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## Planning Commission Draft Motion

HEARING DATE: JULY 22, 2010

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ADOPTING FINDINGS RELATED TO THE APPROVAL OF A CONDITIONAL USE AUTHORIZATION PURSUANT TO PLANNING CODE SECTION 737.11 TO ALLOW DEVELOPMENT ON A LOT EXCEEDING 9,999 SQUARE FEET, AND TO ALLOW A PLANNED UNIT DEVELOPMENT PER PLANNING CODE SECTIONS 303 AND 304, WITH EXCEPTIONS FROM PLANNING CODE SECTIONS 134 (REAR YARD); 135 (OPEN SPACE DIMENSIONS); AND 136 (PERMITTED OBSTRUCTIONS WITHIN REQUIRED OPEN AREAS), FOR A PROJECT TO DEMOLISH AN EXISTING BUS SHELTER AND SURFACE PARKING LOT AND TO CONSTRUCT A NEW FIVE-STORY MIXED-USE BUILDING WITH 71 DWELLING UNITS OVER GROUND FLOOR COMMERCIAL SPACE. THE RESIDENTIAL COMPONENT OF THE PROJECT WOULD BE 100% AFFORDABLE, INTENDED FOR OCCUPANCY BY YOUNG ADULTS TRANSITIONING OUT OF FOSTER CARE AND HOUSEHOLDS AT OR BELOW 50% OF AREA MEDIAN INCOME. FIVE OFF-STREET PARKING SPACES WOULD BE PROVIDED. THE PROJECT IS LOCATED WITHIN THE OCEAN AVENUE NC-T (NEIGHBORHOOD COMMERCIAL TRANSIT) DISTRICT AND A 55-X HEIGHT AND BULK DISTRICT. THE APPROVAL ALSO INCLUDES ADOPTING FINDINGS UNDER THE CALIFORNIA ENVIRONMENTAL QUALITY ACT.

## **PREAMBLE**

On December 14, 2009, Steve Rajninger, from Herman Coliver Locus Architecture acting on behalf of Bernal Heights Neighborhood Center ("Project Sponsor") filed an application with the San Francisco Planning Department (hereinafter the "Department") requesting, under Sections 737.11, 303, and 304, Conditional Use Authorization to allow development on a lot exceeding 9,999 square feet, to establish a planned unit development (PUD), for a development on a 25,772 square-foot site (Lot 001 in Assessor's Block 3180) at 1100 Ocean Avenue (a.k.a. 11 Phelan Avenue), between Plymouth and Phelan Avenues ("Project Site"). The project proposed to demolish an existing bus shelter and surface parking lot and to construct a mixed-use, five-story, 55-foot-tall buildings totaling approximately 86,500 gross square feet (gsf) with five- off-street parking spaces. The project would include 71 affordable dwelling units and approximately 7,300 gsf of ground-floor commercial space (tenants not yet determined). The project requires subdividing the 30-acre lot creating a 25,772 square-foot lot with approximately 137-feet of frontage on Ocean Avenue.

Pursuant to CEQA Guidelines Section 15168, the Planning Department conducted a program-level EIR for the *Balboa Park Station Area Plan*. The area plan EIR was also a project-level EIR that analyzed the proposed project at 11 Phelan Avenue (the "Phelan Loop Site"). The analysis was performed at a project level to address the environmental effects associated specifically with the proposed housing project at 11 Phelan Avenue. Pursuant to CEQA Guidelines Section 15090, the Planning Commission certified the Final EIR on December 4, 2008, in its Motion No. 17774. No appeal of the certification was filed with the Department. The Commission found significant unavoidable environmental impacts for the Balboa Park Station Area Plan and related approvals that could not be mitigated to a level of non-significance. Pursuant to CEQA Guidelines Section 15093, the Commission adopted a statement of overriding considerations for approving the Plan on December 4, 2008, in its Motion No. 17776. The Board of Supervisors made the same findings in Ordinance Nos. 58-09, 59-09, 60-09, and 61-09. Said motion and ordinances are incorporated herein by reference. As part of the Planning Commission's actions related to the 11 Phelan Avenue, the Commission is adopting additional CEQA findings specific to this development project.

The Planning Department, Linda Avery, is the custodian of records, located in the File for Case No. 2004.1059E, at 1650 Mission Street, Fourth Floor, San Francisco, California.

Department staff prepared a Mitigation Monitoring and Reporting program ("MMRP"), which material was made available to the public and this Commission for this Commission's review, consideration and action.

On July 22, 2010, the Commission conducted a duly noticed public hearing at a regularly scheduled meeting on Conditional Use Application No. 2009.1117C, at which time the Commission reviewed and discussed the findings for approval prepared for its review by Department staff.

The Commission has reviewed and considered reports, studies, plans and other documents pertaining to the Project.

The Commission has heard and considered the testimony presented at the public hearing and has further considered the written materials and oral testimony presented on behalf of the Project Sponsor, Department staff, and other interested parties.

**MOVED**, that the Commission hereby authorizes the Conditional Use requested in Application No. 2009.1117C, subject to the conditions contained in "EXHIBIT A" of this motion, based on the following findings:

## **FINDINGS**

Having reviewed the materials identified in the preamble above, and having heard all testimony and arguments, this Commission finds, concludes, and determines as follows:

1. The above recitals are accurate and constitute findings of this Commission.
2. **Project Description.** The request is for Conditional Use Authorization pursuant to Planning Code Sections: 737.11, for development of a lot that is greater than 9,999 square-feet; and Planning Code Sections 303 and 304 to allow a Planned Unit Development, with a request for exceptions from Planning Code Sections: 134 (rear yard); 135 (open space dimensions); and 136 (permitted obstructions over streets and alleys).

The proposal is to demolish the existing bus shelter and surface parking lot and to construct a mixed-use, five-story, 55-foot-tall building totaling approximately 86,466 gross square feet (gsf) with five- off-street parking spaces. The project would include 71 affordable dwelling units and approximately 7,300 gsf of ground-floor commercial space (tenants not yet determined). The project requires subdividing the 30-acre lot creating a 25,772 square-foot lot with approximately 137-feet of frontage on Ocean Avenue.

The project is a joint partnership between the Mayor's Office of Housing and the Bernal Heights Neighborhood Center. The building will have four levels of residential occupancy above ground-floor retail space. The residential units will be provided as follows: (18) studio units, (18) one-bedroom units, (21) two-bedroom units, and (13) three-bedroom units. Forty-eight percent of the units contain two-bedrooms or more. The units are 100% affordable with approximately 21 of the units intended for occupancy by young adults transitioning out of foster care. The remaining residential units are intended for occupancy by households earning less than 50% of area median income. The parking garage is located at grade level and is accessed from the Lee Avenue extension. The garage contains five- off-street parking spaces including a handicap accessible space and a car share space. The building will have 32 class 1 bicycle parking spaces for the residential space and four class 1 bicycle parking spaces for the commercial space. The remainder of the ground floor will provide supportive service and community space.

The Project includes approximately 7,841 square-feet of on-site residential open space with the remainder of the open space requirement being met by the proposed adjacent



public open space. The adjacent open space will be developed by the City separate from the project. The primary areas of on-site open space are located within the courtyard at the podium level and the rear yard.

- 3. Site Description and Present Use.** The Project Site (Assessor's Block 3180, Lot 001) is a City owned parcel located on the north side of Ocean Avenue, between Phelan and Plymouth Avenues. The lot measures 30-acres in area with frontage on both Ocean and Phelan Avenues. The project site is located just west of Highway 280 and San Francisco City College. The property is improved with the PUC water reservoir at the rear, the Phelan Loop bus turnaround and layover area, a surface parking lot for 23 vehicles, and a fire station. The property is on the border of the Westwood Park and Ingleside neighborhoods. The Project Site is within the boundaries of the Balboa Park Station Area Plan and was recently rezoned from NC-2 (Small-Scale, Neighborhood Commercial) Zoning District to the Ocean Avenue NCT (Neighborhood Commercial Transit) Zoning District and the height limit for the property was changed in the process from 65-A Height and Bulk District to a 55-X Height and Bulk District.

The Balboa Park Station Area Plan calls for rerouting the Phelan Loop bus turnaround to circle the fire station.

- 4. Surrounding Properties and Neighborhood.** The Ocean Avenue NCT District is mixed use, transitioning from a predominantly one- and two-story retail district to include taller buildings at its eastern end. The Kragen site, which the Commission approved in May 2009, is one such taller building adjacent to the site to the west. The "Kragen" development includes 173 dwelling units and a ground floor grocery store. The grocery store requires a truck hammerhead easement that is partially located with in the required rear yard of the subject property. To the north, the property abuts an empty PUC water reservoir that is currently used by City College of San Francisco for parking. To the east the site abuts the existing fire station. Across Ocean Avenue, to the south of the site, is a vacant corner lot, a McDonald's restaurant, and a modern, four-story mixed-use building as well as two smaller scale mixed use buildings. The MUNI K-Ingleside line travels down the center of Ocean Avenue with east and west bound MUNI stops in front of the site. The MUNI stops continue the length of the block and consist of raised platforms with barriers, ADA accessible boarding ramps, and covered bus shelters. City College of San Francisco's main campus is located northeast of the site. The single-family neighborhoods of Westwood Park and Ingleside flank Ocean Avenue to the north and south respectively.
- 5. Public Comment.** The Department has received no correspondence from the public regarding this project.
- 6. Balboa Park Station Area Plan.** As part of the Better Neighborhoods Program, the Balboa Park Station Area Plan has been identified as one of the areas studied. The "plan

area” for the Balboa Park Station Area Plan is in south central San Francisco. The area comprises approximately 210 acres and includes the Ocean Avenue Campus of City College of San Francisco (CCSF), the Ocean Avenue Neighborhood Commercial District, Balboa Park, and the Balboa Park BART station. More specifically, the plan area consists primarily of those parcels fronting on Ocean, Geneva and San Jose Avenues. The area provides a diverse range of uses including; institutional, recreational, retail, housing, and transportation. Seven neighborhoods surround the Plan Area: Westwood Park, Ingleside, Ingleside Terraces, Miraloma Heights, Sunnyside, Oceanview, and Balboa Terraces. The plan area is best characterized by four distinct areas; the Transit Station Neighborhood, City College of San Francisco, the Reservoir, and the Ocean Avenue Commercial District. The Plan’s objectives and policies are informed by three key principles;

- a. Improve the area’s public realm,
  - b. Make the transit experience safer and more enjoyable,
  - c. And improve the economic vitality of the Ocean Avenue Neighborhood Commercial District.
7. **Ocean Avenue NC-T (Neighborhood Commercial Transit).** The Ocean Avenue Neighborhood Commercial Transit District is located on Ocean Avenue from Phelan to Manor Avenues. Ocean Avenue is a multi-purpose transit-oriented small-scale commercial district that is modeled on the NC-T-2 District. Ocean Avenue was developed as a streetcar-oriented commercial district in the 1920s and continues to serve this function, with the K-line streetcar on Ocean Avenue. Numerous other bus lines serve the area, especially the eastern end, where the Phelan Loop serves as a major bus terminus. The eastern end of the district is anchored by the main City College campus at Phelan and direct linkages to the Balboa Park BART/MUNI rail station two blocks to the east, which serves as the southernmost San Francisco station for BART and the terminus of the J, K, and M streetcar lines. Because of the immediate proximity of the BART/MUNI station the district has quick and easy transit access to downtown.

The Ocean Avenue NC-T District is mixed use, transitioning from a predominantly one- and two-story retail district to include neighborhood-serving commercial uses on lower floors and housing above. Housing density is limited not by lot area, but by the regulations on the built envelope of buildings, including height, bulk, setbacks, and lot coverage, and standards for residential uses, including open space and exposure, and urban design guidelines. Access (i.e. driveways, garage entries) to off-street parking and loading is generally prohibited on Ocean Avenue to preserve and enhance the pedestrian-oriented character and transit function of the street. Residential and commercial parking are not required.

The Ocean Avenue NC-T District is intended to provide convenience goods and services to the surrounding neighborhoods as well as limited comparison shopping goods for a wider market. The range of comparison goods and services offered is varied and often includes specialty retail stores, restaurants, and neighborhood-serving offices. Buildings may range in height, with height limits generally allowing up to four or five stories. Lots are generally small to medium in size and lot consolidation is prohibited to preserve the

fine grain character of the district, unless the consolidation creates a corner parcel that enables off-street parking to be accessed from a side street.

Rear yard requirements above the ground story and at residential levels preserve open space corridors of interior blocks.

Commercial uses are required at the ground level and permitted at the second story. Large Fast Food uses are not permitted.

Housing development in new buildings is encouraged above the ground story. Existing residential units are protected by limitations on demolition and upper-story conversions.

8. **Planning Code Compliance:** The Commission finds that the Project is consistent with the relevant provisions of the Planning Code in the following manner:

**A. Rear Yard.**

Planning Code Section 134 requires a 25% rear yard. Planning Code Section 737.12 requires the yard to be located at the second story and above and at all residential levels.

*The Project would have a rear yard located at grade but because a portion of the building would encroach into this required open space an exception is required. See Finding 9A below.*

**B. Open Space.**

Planning Code Section 135 requires that usable open space be located on the same lot as the dwelling units it serves. Either 100 square feet of private usable open space per dwelling unit or 133 square feet of common usable open space per dwelling unit or any combination thereof must be provided for the project.

*The Project, with 71 dwelling units, is required to provide approximately 7,100 sf of private open space, or 9,443 sf of common open space, or an equivalent combination of private and common open space. The Project provides approximately 7,841 sf of combined common and private open space on-site, thereby partially meeting open space requirement on site. The remainder of the requirement is met off-site by the proposed adjacent public plaza. See Finding 9B below.*

**C. Density.**

Planning Code Section 737.91 places no limits on residential density in the District. Density is only restricted by physical building envelope.

*The project would provide 71 dwellings which is a ratio of one dwelling per 363 square-feet of lot area.*

**D. Street Trees.**

Planning Code Section 143 requires the owner or developer of a new building in a NC District to install one 24-inch box street tree for every 20-feet of lot frontage.

*The project meets the requirement by adding five new street trees at the Ocean Avenue frontage and five new street trees at the proposed Lee Avenue frontage.*

**E. Permitted Parking (Residential).**

Planning Code Section 737.94 requires no residential parking and permits up to one parking space for each dwelling unit. Parking above a ratio of 1:1 is not permitted.

*The project would provide five residential parking spaces which is .07 parking space for each dwelling unit.*

**F. Permitted Parking (Commercial).**

Planning Code Section 737.22 requires no commercial parking and permits up to one space per 1,500 square-feet of occupied floor area, not permitted above.

*The project would not provide any commercial parking.*

**G. Off-Street Loading.**

Planning Code Section 152 requires one off-street loading space for retail uses between 10,001 and 30,000 square feet and zero off-street loading space for residential uses between 0 and 100,000 sf.

*An off-street loading space is not required because the project has 7,300 gross square-feet of commercial space and 79,200 sf. of residential space. The project includes a non-Code complying freight space within the parking garage.*

**H. Height and Bulk.**

The subject property is located within the 40-X, 55-X, and 65-A Height and Bulk Districts.

*The Project reaches a finished roof height of 55 feet. The Project therefore complies with the basic height limitation for the property. Pursuant to Section 270, projects within "-X" Bulk Districts are not subject to specific bulk controls.*

**I. Floor Area Ratio.**

In the Ocean Avenue NCT District, Section 124 allows a Floor Area Ratio (FAR) of up to 2.5. In NC Districts the FAR requirement does not apply to residential uses.

*The Project Site has an area of 25,772 square feet; therefore the allowable FAR would permit up to 64,430 square feet of gross floor area of nonresidential space. The Project would provide approximately 7,300 gross square feet of nonresidential space, and therefore complies with the maximum allowable FAR.*

**J. Car Sharing.**

Section 166 of the Planning Code does not require any car share parking spaces if a project has 0 – 49 off-street parking spaces.

*The Code does not require any car share space because the Project proposes no off-street parking, however, the project would provide one car share space for use by residents of the building.*

**K. Shower and Locker Facilities.**

Section 155 of the Code does not require a shower or locker facility for retail uses that are less than 25,000 sf.

*The Project would not provide any shower or locker facilities.*

**L. Bicycle Parking.**

Section 155 of the Code requires no bicycle parking for commercial uses less than 10,000 sf. and requires 25 Class 1 spaces plus 1 Class 1 space for every 4 dwelling units over 50.

*No bicycle parking is required for the commercial uses because it is only 7,300 sf. However, the project would provide four Class 1 bicycle spaces for the commercial uses. The Code requires 30 Class 1 bicycle parking spaces for the residential uses. The Project would provide 32 Class 1 spaces.*

**M. Dwelling Unit Mix.**

Section 207.6 of the Planning Code requires that a minimum of 40 percent of all dwelling units in NC-T-Districts have at least two-bedrooms or more to ensure an adequate supply of family-sized units.

*The project proposes 34- dwellings with two or more bedrooms, or 48 percent of the total number of units.*

**N. Lot Size per Development.**

Planning Code Section 737.11 permits development of lots larger than 9,999 square-feet within the Ocean Avenue NC-T with conditional use authorization.

*The subject lot would be subdivided from lot 001 in assessor's block 3180 and measure 25,772 square-feet thus requiring conditional use authorization to develop.*

**O. Inclusionary Housing.**

Planning Code Section 315 requires that a minimum of 15 percent of the total dwelling units constructed be affordable to and occupied by qualifying persons and families as defined in the Code.

*The Project proposes 100 percent of the total units to be affordable. Twenty-one of the dwellings would be for young adults transitioning from foster care. According to the sponsor, the remaining 50 dwellings would be for qualifying households earning less than 50% of area median income which is subject to change based upon financing. The Sponsor has submitted the "Declaration of Intent" to memorialize his intent.*

**P. Balboa Park Community Improvements Fund.**

Pursuant to Section 331 of the Code, the project requires payment of \$8.00 per net occupied square foot of residential development and \$1.50 per square-foot of net additional commercial square-footage for the Balboa Park Community Improvement Fund, prior to issuance of site permit.

*The project includes 79,166 gross square-feet of residential uses and 7,300 gross square-feet of commercial uses. Per the Balboa Park Community Improvements Fund the project requires a payment of approximately \$633,328 for residential uses and \$10,950 for commercial uses.*

9. **Planning Code Exceptions:** Planning Code Section 304 allows exceptions from the Code for larger development sites. The Commission finds that the following exceptions are hereby approved for the project.

**A. Rear Yard.**

Section 134 of the Planning Code requires a 25 percent rear yard at the second story and at all residential levels.

*The proposed project would provide open space at the rear of the site, but the space is not large enough to meet the Code's rear yard requirements. The project proposes an interior open space courtyard that when combined with the open space at the rear of the property will provide more useable and accessible open space for residents of the project than would a single rear yard.*

**B. Open Space.**

Section 135 of the Planning Code requires at least 100 sf of private open space, 133 sf of common open space, or some equivalent combination of both, per dwelling unit. Furthermore, the Code section requires that open space meet certain minimum dimensions.

*The Project, with 71 dwelling units, is required to provide approximately 7,100 sf of private open space, or 9,443 sf of common open space, or an equivalent combination of private and common open space. The Project provides approximately 7,841 sf of combined common and private open space on-site, thereby partially meeting the open space requirement on site. The remainder of the requirement is met off-site by the proposed adjacent public plaza. The Project provides 3,615 sf of common open space at the podium within the courtyard, 1,230 sf*

*of open space within the covered children's play area, 2,112 sf of open space within the rear yard, 724 sq of open space at the courtyard entry, and 160 sf of open space for four top floor dwellings with balconies. The Project is not deficient in total required amount of open space but the private open space provided does not meet minimum dimensions or area required by Code and the children's playground does not meet the Code's open space exposure requirement.*

**C. Permitted Obstructions.**

Sections 136 and 136.1 of the Planning Code requires maximum dimensions for each bay window or balcony and each awning or canopy that extends over streets and alleys.

*Due to the scale of the building and the amount of street frontage, the project would include several bay windows and a continuous ground floor awning that are larger than permitted by Code. The larger bay windows are appropriate because they articulate the building's façade and add more visual interest to a large street wall. The larger continuous awning is appropriate to reduce glare on the ground floor windows and provide a pedestrian scale at the base of the building.*

10. **Planning Code Section 303** establishes criteria for the Planning Commission to consider when reviewing applications for Conditional Use authorization. On balance, the Project complies with the criteria of Section 303, in that:

- A. The proposed use or feature, at the size and intensity contemplated and at the proposed location, will provide a development that is necessary or desirable for, and compatible with, the neighborhood or the community.

*The proposed project is necessary and desirable for the community because it fills multiple needs in the City of San Francisco. The currently proposed project will augment the City's supply of affordable housing by 71 units, 48% of which would be designed for families. According to the sponsor, 21 of the dwellings will be provided for young adults transitioning out of foster care, a unique and underserved population.*

*The proposed project will also provide approximately 7,300 gross square-feet of commercial space. The commercial space will be accessible by walking, MUNI and car. In combination, the proposed residential and retail uses, at the densities and scale contemplated, will enhance the existing mixed-use character of the neighborhood and create needed amenities in this area.*

*As found in the Area Plan, this project is compatible with the neighborhood at the proposed size and intensity at this location. The project is located adjacent to City College's main campus along a major transit and vehicular corridor, providing direct access to Highway 280 from this part of the City. The project's transit rich location will make it easier for the households living in the dwellings to forego vehicle ownership, thus saving money on the expenses of vehicle ownership. Furthermore, the close proximity of City College makes it*

*easier for the young adult and adult population to obtain higher education and other needed skills if desired.*

- B. The use or feature as proposed will not be detrimental to the health, safety, convenience, or general welfare of persons residing or working in the vicinity, or injurious to property, improvements, or potential development in the vicinity, with respect to aspects including, but not limited to the following:
- i. The nature of the proposed site, including its size and shape, and the proposed size, shape, and arrangement of structures.

*The project site is much larger than the average lot within the Ocean Avenue NC-T. However, the site is located at the edge of the District near an institutional use that is comprised of large buildings. The project is a transitional property from the larger buildings of CCSF to the finer grained buildings of the Ocean Avenue NC-T. The Project Site is an irregularly-shaped lot that is adequately sized to accommodate the development. The building is generally arranged as a unified form occupying the majority of the lot, similar to other large structures in the area. In addition, the base of the Project is differentiated by being inset from the upper floors and transparent along the Ocean Avenue frontage. This differentiation activates the streetscape and reinforces a human scale for the pedestrian. The shape and size of development on the subject property will not be detrimental to persons or adjacent properties in the vicinity.*

*The project will have no significant or detrimental shadow or wind impacts. There is no existing Recreation and Park Department open spaces near the project site. The proposed Phelan Loop Plaza open space is new and will not be acquired by the Recreation and Park Department. The project will not create any new shade on any protected Recreation and Park Commission properties, nor would it produce shading not commonly expected or experienced in urban areas such as the project site.*

*The project will include the demolition of the existing one-story bus shelter structure. This structure is not mentioned in the Area Plan Draft EIR as an historic resource. Thus, its demolition will not constitute a significant impact, and it will not be detrimental to those residing and working in the area.*

- ii. The accessibility and traffic patterns for persons and vehicles, the type and volume of such traffic, and the adequacy of proposed off-street parking and loading and of proposed alternatives to off-street parking, including provisions of car-share parking spaces, as defined in Section 166.

*The program-level EIR that was done for the project as part of the Balboa Park Station Area Plan did not identify any transportation or circulation impacts beyond those generally anticipated by an infill urban project. The Project includes minimal off-street parking, however, the area is served by ample public transit, so that many of the*



*employees, residents, and patrons can be expected to arrive by transit or other means beyond private automobiles. While no off-street loading is required by the Planning Code, the Project includes a small loading area within the parking garage to accommodate deliveries associated with the building.*

*As proposed, the traffic patterns, off-street loading, and the lack of off-street parking will not be detrimental to persons or adjacent properties in the vicinity.*

- iii. The safeguards afforded to prevent noxious or offensive emissions such as noise, glare, dust, and odor.

*Since this will be a predominantly residential project with small scale, neighborhood-serving retail uses and a medium-sized commercial use, the project will not generate unusual noise, odor, dust and glare as a result of its operations. The buildings will comply with Title 24 standards for noise insulation. The materials for the facades of the buildings will not result in glare. The project would generate additional night lighting, but not in amounts unusual for an urbanized area. Design of exterior lighting could ensure that off-site glare and lighting spillover would be minimized.*

*In terms of dust, the City's standard Building Code requirement regarding construction dust is sufficient to prevent negative impacts to the surrounding community from dust blowing during construction.*

- iv. Treatment given, as appropriate, to such aspects as landscaping, screening, open spaces, parking and loading areas, service areas, lighting, and signs.

*The project will provide an interior, landscaped open space on top of a one-story podium, and street trees consistent with code requirements will be installed along Ocean and Lee Avenues. The Project Sponsor will continue to work with Department staff to refine details of lighting, signage, materials, street trees, and other aspects of the design.*

- C. Such use or feature as proposed will comply with the applicable provisions of this Code and will not adversely affect the General Plan.

*The Project complies with all relevant requirements and standards of the Planning Code and is consistent with objectives and policies of the General Plan as detailed below.*

- D. Such use or feature as proposed will provide development that is in conformity with the state purpose of the Ocean Avenue NCT.

*The Project is consistent with the stated purposes of Ocean Avenue NC-T District in that the intended commercial uses are located at the ground, and the Project as a whole will provide a compatible convenience service for the immediately surrounding neighborhoods during daytime hours as well as providing 71 new residential units to San Francisco's housing stock.*

11. **Planning Code Section 121.1 Findings.** In addition to the criteria of Section 303(c) of this Code, the City Planning Commission has considered the extent to which the following criteria are met for a project site exceeding 9,999 square feet in the Ocean Avenue NC-T zoning district:

- E. The mass and facade of the proposed structure are compatible with the existing scale of the district.

*The project will be compatible with the existing scale of the district. The project site is located on Ocean Avenue, a major transit and commercial corridor in the City. The Area Plan reduced the height limit from 65 to 55 feet. The project will not exceed this height limit. The large bay windows and defined storefronts help to further break down the scale of the building.*

- F. The facade of the proposed structure is compatible with the design features of adjacent facades that contribute to the positive visual qualities of the district.

*Existing buildings in the area exhibit an eclectic architectural character, with no prevailing style establishing a dominant visual pattern for the neighborhood. The style of the proposed building is contemporary, however, the relatively uniform massing is comparable to the uniform massing of many of the early twentieth century structures. The bay windows add depth and shadow across the Ocean Avenue elevation. The southeast corner of the building rises up to frame the future plaza entrance.*

12. **Planned Unit Development.** Planning Code Section 304(d) establishes criteria and limitations for the authorization of PUD's over and above those applicable to Conditional Uses in general and contained in Section 303(c) and elsewhere in the Code. PUD's must:

- A. Affirmatively promote applicable objectives and policies of the General Plan.

*This Project is consistent with the objectives and policies of the General Plan as outlined in Section 12 below.*

- B. Provide off street parking adequate for the occupancy proposed.

*The project includes 71 dwelling units and ground floor commercial space. Consistent with City policy for projects along transit corridors, the project includes minimal amounts of off-street parking. The location is transit rich making it more feasible for households to live without personal vehicles.*

- C. Provide open space usable by the occupants and, where appropriate, by the general public, at least equal to the open spaces required by the Code.

*The Project, with 71 dwelling units, is required to provide approximately 7,100 sf of private, or 9,443 sf of common open space, or an equivalent combination of private and common open space. The Project proposes a total of approximately 7,841 square feet of open space on the subject lot which includes the rear yard, the courtyard, the kids' play area, and private decks. The remainder of the open space requirement would be met off-site by the proposed adjacent plaza.*

- D. Be limited in dwelling unit density to less than the density that would be allowed by Article 2 of this Code for a District permitting a greater density, so that the PUD will not be substantially equivalent to a reclassification of property.

*There is no density limit for projects within the Ocean Avenue NC-T.*

- E. In R Districts, include commercial uses only to the extent that such uses are necessary to serve residents of the immediate vicinity, subject to the limitations for NC-1 (Neighborhood Commercial Cluster) Districts under the Code.

*The Project Site is not located within an R-District.*

- F. Under no circumstances be excepted from any height limit established by Article 2.5 of this Code, unless such exception is explicitly authorized by the terms of this Code. In the absence of such an explicit authorization, exceptions from the provisions of this Code with respect to height shall be confined to minor deviations from the provisions for measurement of height in Sections 260 and 261 of this Code, and no such deviation shall depart from the purposes or intent of those sections.

*The project site is within a 55-X Height and Bulk District. The project does not exceed a height of 55 feet.*

- G. In NC Districts, be limited in gross floor area to that allowed under the Floor Area Ratio limit permitted for the district in Section 124 and Article 7 of this Code.

*The Project Site has an area of 25,772 square feet; therefore the allowable FAR would permit up to 64,430 square feet of gross floor area of nonresidential space. The Project would provide approximately 7,300 gross square feet of nonresidential space, and therefore complies with the maximum allowable FAR.*

- H. In NC Districts, not violate the use limitations by story set forth in Article 7 of this Code.

*Consistent with the District controls, the project provides general commercial space at the ground floor and residential units at the floors above.*

13. **Planning Code Section 101.1(b)** establishes eight priority-planning policies and requires review of permits for consistency with said policies. On balance, the project does comply with said policies in that:

- A. That existing neighborhood-serving retail uses be preserved and enhanced and future opportunities for resident employment in and ownership of such businesses enhanced.

*The Project Site is located within Ocean Avenue Neighborhood Commercial Transit District and is thought to enhance the commercial vitality of the area. With approximately 7,300 gross sf. of ground floor retail development, the project will complement the district's small-scale retail environment.*

- B. That existing housing and neighborhood character be conserved and protected in order to preserve the cultural and economic diversity of our neighborhood.

*The Project would increase the City's housing supply by 71 units. The existing buildings that will be demolished do not contribute to the character of the Ocean Avenue NC-T. Furthermore, the Project will not result in the loss of existing housing. The project would promote the economic diversity of the neighborhood by providing residents a rental housing option.*

- C. That the City's supply of affordable housing be preserved and enhanced.

*The Project will provide 71 affordable housing units thereby enhancing the City's supply of affordable housing.*

- D. That commuter traffic not impede MUNI transit service or overburden our streets or neighborhood parking.

*The Site is well served by multiple transit lines, including MUNI's K-Ingleside metro line. It is anticipated that smaller households in the surrounding neighborhood will visit the Project by alternative modes, including transit. The increase in transit demand anticipated by the Project would not have a significant or noticeable impact upon transit services in the neighborhood or affect transit operations.*

- E. That a diverse economic base be maintained by protecting our industrial and service sectors from displacement due to commercial office development, and that future opportunities for resident employment and ownership in these sectors be enhanced.

*The Project will not displace any service or industry establishment due to commercial office development. The project will not affect industrial or service sector uses or related employment opportunities. Ownership of industrial or service sector businesses will not be affected by this project.*

- F. That the City achieves the greatest possible preparedness to protect against injury and loss of life in an earthquake.

*The Project is designed and will be constructed to conform to the structural and seismic safety requirements of the City Building Code. This proposal will not impact the property's ability to withstand an earthquake.*

- G. That landmark and historic buildings be preserved.

*The existing buildings on the Site are not landmarks or historic buildings.*

- H. That our parks and open space and their access to sunlight and vistas be protected from development.

*The Project will have no negative impact on parks or open space.*

13. **General Plan Compliance.** The Project is, on balance, consistent with the following Objectives and Policies of the General Plan:

**COMMERCE AND INDUSTRY ELEMENT:**

**Objectives and Policies**

**OBJECTIVE 6**

**MAINTAIN AND STRENGTHEN VIABLE NEIGHBORHOOD COMMERCIAL AREAS EASILY ACCESSIBLE TO CITY RESIDENTS.**

**Policy 6.10:**

Promote neighborhood commercial revitalization, including community-based and other economic development efforts where feasible.

*The Project would replace an underutilized parcel with a building that will provide affordable housing opportunities to the area. In addition, the ground-floor commercial space will activate the streetscape and enhance the pedestrian realm compared with the existing uses on the site.*

**HOUSING ELEMENT**

**Objectives and Policies**

**OBJECTIVE 1:**

**IDENTIFY AND MAXIMIZE OPPORTUNITIES TO INCREASE THE POTENTIAL SUPPLY OF HOUSING IN APPROPRIATE LOCATIONS CITYWIDE.**

**Policy 1.4:**

Locate in-fill housing on appropriate sites in established residential neighborhoods.

*The Project will create up to 71 units of new housing, all of which would be Below Market Rate units, in a location well-served by transit with access via BART and MUNI to several employment centers around the region. .*

*The residential neighborhoods surrounding the Ocean Avenue NC-T District are established family-oriented residential neighborhoods. The subject site is suitable for residential development because it is underutilized and well served by transit.*

## **BALBOA PARK STATION AREA PLAN: Objectives and Policies**

### **OBJECTIVE 1.2**

#### **STRENGTHEN THE OCEAN AVENUE NEIGHBORHOOD COMMERCIAL DISTRICT.**

##### **Policy 1.2.2:**

Encourage mixed-use residential and commercial infill within the commercial district.

*The Project would provide an infill mixed-use building that would strengthen the commercial district by extending and connecting it to the City College campus.*

### **OBJECTIVE 3.1**

#### **ESTABLISH PARKING STANDARDS AND CONTROLS THAT PROMOTE QUALITY OF PLACE, AFFORDABLE HOUSING, AND TRANSIT-ORIENTED DEVELOPMENT.**

##### **Policy 3.1.1**

Provide flexibility for new residential development by eliminating minimum off-street parking requirements and establishing reasonable parking caps.

##### **Policy 3.1.2**

Provide flexibility for non-residential development by eliminating minimum off-street parking requirements and establishing parking caps generally equal to the previous minimum requirements.

*The project's transit rich location and lack of off-street parking will encourage residents, employees, and patrons to use alternative means of transportation.*

### **OBJECTIVE 4.2**

**STRENGTHEN THE OCEAN AVENUE NEIGHBORHOOD COMMERCIAL DISTRICT BY PROVIDING AN APPROPRIATE MIX OF HOUSING.**

**Policy 4.2.1**

Encourage mixed-use commercial and residential infill within the commercial district while maintaining the district's existing fine-grained character.

**Policy 4.2.2**

Redevelop the parcels in the Phelan Loop Area with new mixed-use development.

*The project would provide a well designed mixed-use building on the Phelan Loop site.*

**OBJECTIVE 4.5**

**PROVIDE INCREASED HOUSING OPPORTUNITIES AFFORDABLE TO A MIX OF HOUSEHOLDS AT VARYING INCOME LEVELS.**

**Policy 4.5.1**

Give first consideration to the development of affordable housing on publicly-owned sites.

*The project is a public/private partnership between the City and the Bernal Heights Neighborhood Center (BHNC) to provide 71 dwelling units that are 100% affordable on a City owned parcel commonly known as the Phelan Loop.*

**OBJECTIVE 5.2**

**DEVELOP AND IMPLEMENT PARKING POLICIES FOR AREAS WELL SERVED BY PUBLIC TRANSIT THAT ENCOURAGE TRAVEL BY PUBLIC TRANSIT AND ALTERNATIVE TRANSPORTATION MODES AND REDUCE TRAFFIC CONGESTION.**

**Policy 5.2.1:**

Eliminate minimum off-street parking requirements and establish parking caps for residential and commercial parking.

**Policy 5.2.3:**

Minimize the negative impacts of parking on neighborhood quality.

*The Project provides minimal off-street parking, creating an incentive for employees, patrons, and students of the facility to travel by means other than the private automobile. The area is well-served by public transit, and is within walking distance of many retail goods and services. The lack of parking will not negatively impact the quality of the surrounding neighborhood.*

15. The Project is consistent with and would promote the general and specific purposes of the Code provided under Section 101.1(b) in that, as designed, the Project would contribute to the character and stability of the neighborhood and would constitute a beneficial development.
16. The Project has completed the requirements of the First Source Hiring Construction and Employment Program approved by the First Source Hiring Administrator as they apply to permits for residential development (Section 83.4(m) of the Administrative Code). The Project Sponsor shall comply with the requirements of this Program regarding construction work and on-going employment required for the Project.
17. The Commission hereby finds that approval of the Conditional Use authorization would promote the health, safety and welfare of the City.



## DECISION

That based upon the Record, the submissions by the Project Sponsor, the staff of the Department and other interested parties, the oral testimony presented to this Commission at the public hearings, and all other written materials submitted by all parties, the Commission hereby **APPROVES Conditional Use Application No. 2009.1117C** subject to the following conditions attached hereto as EXHIBIT A which is incorporated herein by reference as though fully set forth, and in general conformance with the plans stamped EXHIBIT B, dated July 7, 2010 and on file in Case Docket No. 2009.1117C.

The Planning Commission has reviewed and considered the program-level EIR for the *Balboa Park Station Area Plan* and the record as a whole and finds that there is no substantial evidence that the Project will have a significant effect on the environment with the adoption of the mitigation measures contained in the MMRP to avoid potentially significant environmental effects associated with the Project, and hereby adopts the MMRP.

The Planning Commission hereby adopts the MMRP attached hereto as Exhibit C and incorporated herein as part of this Resolution/Motion by this reference thereto. All required mitigation measures identified in the program-level EIR for the *Balboa Park Station Area Plan* and contained in the MMRP are included as conditions of approval.

The Planning Commission further finds that since the program-level EIR for the *Balboa Park Station Area Plan* was finalized, there have been no substantial project changes and no substantial changes in project circumstances that would require major revisions to the EIR due to the involvement of new significant environmental effects or an increase in the severity of previously identified significant impacts, and there is no new information of substantial importance that would change the conclusions set forth in the EIR.

**APPEAL AND EFFECTIVE DATE OF MOTION: Any aggrieved person may appeal this Conditional Use Authorization to the Board of Supervisors within thirty (30) days after the date of this Motion No. XXXXX. The effective date of this Motion shall be the date of this Motion if not appealed (After the 30-day period has expired) OR the date of the decision of the Board of Supervisors if appealed to the Board of Supervisors. For further information, please contact the Board of Supervisors at (415) 554-5184, City Hall, Room 244, 1 Dr. Carlton B. Goodlett Place, San Francisco, CA 94012.**

I hereby certify that the Planning Commission ADOPTED the foregoing Motion on July 22, 2010.

Linda Avery  
Commission Secretary

**Motion XXXXX**  
**Hearing Date: July 22, 2010**

**CASE NO 2009.1117C**  
**1100 Ocean Avenue**

AYES:

NAYS:

ABSENT:

ADOPTED: July 22, 2010

## Exhibit A

# Conditions of Approval

Wherever "Project Sponsor" is used in the following conditions, the conditions shall also bind any successor to the Project or other persons having an interest in the Project or underlying property.

This Conditional Use Authorization is to demolish the existing bus shelter and surface parking lot and to construct a mixed-use, five-story, 55-foot-tall buildings totaling approximately 79,166 gross square feet (gsf) with five- off-street parking spaces all as part of a Planned Unit Development (PUD). The project would include 71 affordable dwelling units and approximately 7,300 gsf of ground-floor commercial space (tenants not yet determined). The project requires subdividing the 30-acre lot creating a 25,772 square-foot lot with approximately 137-feet of frontage on Ocean Avenue. The project site is located at 1100 Ocean Avenue (a.k.a. 11 Phelan Avenue), Lot 001 in Assessor's Block 3180, within the Ocean Avenue Neighborhood Commercial Transit District and a 55-X Height and Bulk District, in general conformance with the revised plans dated July 7, 2010, and marked "Exhibit B", except as modified herein.

### 1. MITIGATION MEASURES

Mitigation measures described in the MMRP attached as Exhibit C are necessary to avoid potential significant effects of the proposed project and have been agreed to by the project sponsor. Their implementation is a condition of project approval.

### 2. COMPLIANCE WITH OTHER REQUIREMENTS

This decision conveys no right to construct. The conditions set forth below are additional conditions required in connection with the Project. If these conditions overlap with any other requirement imposed on the Project, the more restrictive or protective condition or requirement, as determined by the Zoning Administrator, shall apply. The conditions set forth below shall remain in effect for the life of the Project, unless specifically noted otherwise

### 3. GENERAL CONDITIONS

A. Recordation. Prior to the issuance of any building permit for the construction of the Project, the Zoning Administrator shall approve and order the recordation of a notice in the Official Records of the Recorder of the City and County of San Francisco, which notice shall state that construction of the Project has been authorized by and is subject to the conditions of this Motion. From time to time after the recordation of such notice, at the request of the Project Sponsor, the Zoning Administrator shall affirm in writing the extent to which the conditions of this Motion have been satisfied, and record said writing if requested.

B. Construction.

- (1). The Project Sponsor shall ensure the construction contractor will coordinate with the City and other construction contractor(s) for any concurrent nearby Projects that are planned for construction so as to minimize, to the extent possible, negative impacts on traffic and nearby properties caused by construction activities.
- (2). The contractor(s) shall arrange for off-street parking for construction workers.

C. Performance. The Planning Commission may, in a public hearing, consider the revocation of this conditional use authorization if a site or building permit has not been issued within three (3) years of the date of the Motion approving the Project. Once a site or building permit has been issued, construction must commence within the timeframe required by the Department of Building Inspection and be continued thenceforth diligently to completion. The Commission may also consider revoking this conditional use authorization if a permit for the Project has been issued but is allowed to expire and more than three (3) years have passed since the Motion was approved. This authorization may be extended at the discretion of the Zoning Administrator only if the failure to issue a permit by the Department of Building Inspection is delayed by a City, state or federal agency or by appeal of the issuance of such permit.

D. The commercial tenant(s) shall obtain all necessary approvals from the appropriate City agencies prior to establishing a commercial use.

E. Severability. If any clause, sentence, section or any part of these conditions of approval is for any reason held to be invalid, such invalidity shall not affect or impair other of the remaining provisions, clauses, sentences, or sections of these conditions. It is hereby declared to be the intent of the Commission that these conditions of approval would have been adopted had such invalid sentence, clause, or section or part thereof not been included herein.

F. First Source. The Project is subject to the requirements of the First Source Hiring Program (Chapter 83 of the Administrative Code) and the Project Sponsor shall comply with the requirements of this Program.

G. Violation of the conditions contained in this Motion or of any other provisions of the Planning Code may be subject to abatement procedures and fines up to \$500 a day in accordance with Sections 176 and 176.1 of the Planning Code and actions to abate violations of this conditional use authorization in accordance with Section 303(f).

H. Should monitoring of these Conditions of Approval be required, the Project Sponsor or successors shall pay fees as established in Section 351(e)(1) of the Planning Code.

- I. The Property Owner shall maintain the main entrance to the building and all sidewalks abutting the subject property in a clean condition. Such maintenance shall include, at a minimum, daily litter pickup and disposal, and washing or steam cleaning of the main entrance and abutting sidewalks at least once each week.
  - J. Noise and odors shall be regulated so as not to be a nuisance to nearby businesses or residents.
  - K. Ground level storefronts and glazing in general conformity with Exhibit B shall be maintained in an attractive manner, providing transparency into the tenancy behind. Visibility of the interiors and activity through all windows shall be maintained in order to ensure that the ground level of the building remains visually active, provides visual interest to pedestrians, and enhances sidewalk security. Interior layouts should be designed with these requirements in mind. Generally, windows should not be visually obscured with the following: blinds, shades or curtains; shelving; equipment; darkly tinted, translucent or opaque film; painted, stenciled or adhesive signage applied to individual window surfaces that has an overall transparency of less than 50%, or any signage that covers more than 1/3 of the area of any individual window; full or partial height interior partition walls placed directly against or within 10 feet from the window glazing; or any other items that significantly block the vision of pedestrians through the storefront windows into the occupiable commercial space. Solid roll-down security gates shall not be installed in storefront openings. The Property Owner shall ensure that this condition of approval is incorporated into all commercial leases.
  - L. An enclosed waste storage area shall be provided within the establishment. All trash and recycling containers shall be kept within the building until pick-up by the disposal company.
4. CONDITIONS TO BE MET PRIOR TO THE ISSUANCE OF A FIRST SITE OR BUILDING PERMIT
- A. Design. The Project Sponsor and the Project architects shall continue to work on design development with the Department, with particular attention given to details regarding reveal dimensions at all windows, moldings, and other details, as well as building materials and colors.
  - B. Balboa Park Community Improvements Fund. The Project Sponsor shall satisfy the requirements of Planning Code Section 331 either through a payment to the Fund or through the provision of in-lieu improvement, as specified within this Section.
5. CONDITIONS TO BE MET PRIOR TO THE ISSUANCE OF AN ARCHITECTURAL ADDENDUM TO A BUILDING (OR SITE) PERMIT
- A. Except as otherwise provided in this Motion, the Project shall be completed in

compliance with the Planning Code and in general conformity with plans dated July 7, 2010, labeled "Exhibit B".

- B. Final detailed building plans shall be reviewed and approved by the Planning Department. Detailed building plans shall include a final site plan, elevations, sections, and a landscape plan, and shall specify final architectural and decorative detailing, materials, glazing, color and texture of exterior finishes, and details of construction.
  - C. Highly reflective spandrel glass, mirror glass, or deeply tinted glass shall not be permitted. Only clear glass shall be used at pedestrian levels.
  - D. Pursuant to Planning Code Section 141, rooftop mechanical equipment is required to be screened so as not to be visible from any point at or below the roof level of the subject building.
  - E. Signage. The Project Sponsor shall develop a signage program for the Project which shall be subject to review and approval by Planning Department staff. All subsequent sign permits shall conform to the approved signage program. Once approved by Department staff, the signage program information shall be submitted and approved as part of the first building or site permit for the Project.
  - F. Lighting. The Project Sponsor shall develop a lighting program for the Project which shall be subject to review and approval by Planning Department staff. The lighting program shall include any lighting required or proposed within the public right-of-way as well as lighting attached to the building. Once approved by Department staff, the lighting program information shall be submitted and approved as part of the first building or site permit for the Project.
  - G. A final pedestrian streetscape improvement plan, including landscaping and paving materials and patterns, shall be submitted for review by, and shall be satisfactory to the Planning Director, in consultation with staff from the Department of Public Works, the Department of Parking and Traffic, and the Bureau of Urban Forestry. Other agencies shall be contacted as appropriate. The Project shall include street trees in conformance with Section 143. Relocation of some existing underground utilities may be necessary to accommodate the required street trees. The street trees planted pursuant to this condition shall be maintained in perpetuity by the Project Sponsor.
6. CONDITIONS TO BE MET PRIOR TO ISSUANCE OF ANY CERTIFICATES OF OCCUPANCY FOR THE PROJECT.
- A. All usable open spaces shall be completed and available for use.

- B. An evacuation and emergency response plan shall be developed by the Project Sponsor or building management staff, in consultation with the Mayor's Office of Emergency Services, to ensure coordination between the City's emergency planning activities and the Project's plan and to provide for building occupants in the event of an emergency. The Project's plan shall be reviewed by the Office of Emergency Services and implemented by the building management insofar as feasible before issuance of the final certificate of occupancy by the Department of Public Works. A copy of the transmittal and the plan submitted to the Office of Emergency Services shall be submitted to the Department. To expedite the implementation of the City's Emergency Response Plan, the Project Sponsor shall post information (with locations noted on the final plans) for building occupants concerning actions to take in the event of a disaster.

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# Exhibit C

## MITIGATION MONITORING AND REPORTING PROGRAM

### Attachment A

Measures Adopted as Conditions of Approval of the Balboa Park Station Area Plan Environmental Impact Report that are Applicable to the Project	Responsibility for Implementation	Mitigation Schedule	Monitoring/Report Responsibility	Status/Date Completed
<b>MITIGATION MEASURES FOR THE BALBOA PARK STATION AREA PLAN</b>				
<i>Noise Mitigation Measures</i>				
<b>N-1:</b> In accordance with the San Francisco Land Use Compatibility Guidelines for Community Noise, conduct a detailed evaluation of noise reduction requirements and incorporate needed noise reduction measures into the project design wherever new residential development is proposed in areas subject to existing or future noise levels over 60 dBA (CNEL).	Project sponsor of each future residential development project in the Balboa Park Station Area Plan	Design measures to be incorporated into project design and evaluated in environmental/building permit review prior to issuance of a final building permit and certificate of occupancy	Planning Department and DBI	Considered complete upon approval of final construction drawing set
<b>N-2:</b> Complete a vibration analysis for any residential or vibration-sensitive land uses proposed within critical distances of existing or planned BART or MUNI facilities (see Table 18, p. 231 of the Final EIR). Incorporate measures into the design as necessary to reduce the potential for vibration disturbance.	Project sponsor of each future residential or noise-sensitive development project in the Balboa Park Station Area Plan	During construction	Each project sponsor to provide Planning Department with monthly reports during construction period	Considered complete upon receipt of final monitoring report at completion of construction
<i>Hazardous Materials Mitigation Measure</i>				
<b>HM-2:</b> For projects that include demolition, ensure that any equipment containing PCBs or DEHP, such as fluorescent light ballasts, are removed and properly disposed of according to applicable federal, state, and local laws prior to the start of renovation or demolition, and that any fluorescent light tubes, which could contain mercury, are similarly removed and properly disposed of. Any other hazardous materials identified, such as asbestos-containing building materials, either before or during work, shall be abated according to applicable federal, state, and local laws.	Project sponsor of each future development project in the Balboa Park Station Area Plan	Prior to approval of each subsequent project, through Mitigation Plan	Planning Department, in consultation with DPH. Where a site mitigation plan is required, Project Sponsor or contractor shall submit a monitoring report to DPH, with a copy to Planning Department and DBI, at end of construction	Considered complete upon approval of each subsequent project
<i>Archeological Mitigation Measures</i>				
<b>AM-1:</b> AM-1 applies to projects involving activities including excavation, construction of foundations, soils improvement/densification, installation of utilities or soils remediation resulting in soils disturbance/modification to a depth of four (4) feet or greater below ground surface. The following mitigation measure is required to avoid any potential adverse effect from the proposed project on accidentally discovered buried historical resources	Project sponsor of each future development project in the Balboa Park Station Area Plan	Prior to and during construction	The ERO to review and approve the Final Archeological Resources Report	The project archeologist to consult with the ERO as indicated. Considered



# Exhibit C

## MITIGATION MONITORING AND REPORTING PROGRAM

Attachment A				
Measures Adopted as Conditions of Approval of the Balboa Park Station Area Plan Environmental Impact Report that are Applicable to the Project	Responsibility for Implementation	Mitigation Schedule	Monitoring/Report Responsibility	Status/Date Completed
<p>as defined in CEQA Guidelines Section 15064.5(a)(c). The project sponsor shall distribute the Planning Department archeological resource "ALERT" sheet to the project prime contractor; to any project subcontractor (including demolition, excavation, grading, foundation, pile driving, etc. firms); or utilities contractor involved in soils disturbing activities within the project site. Prior to any soils disturbing activities being undertaken each contractor is responsible for ensuring that the "ALERT" sheet is circulated to all field personnel, including machine operators, field crew, pile drivers, supervisory personnel, etc. The project sponsor shall provide the Environmental Review Officer (ERO) with a signed affidavit from the responsible parties (prime contractor, subcontractor(s), and utilities firm) to the ERO confirming that all field personnel have received copies of the Alert Sheet.</p> <p>Should any indication of an archeological resource be encountered during any soils disturbing activity of the project, the project Head Foreman and/or project sponsor shall immediately notify the ERO and shall immediately suspend any soils disturbing activities in the vicinity of the discovery until the ERO has determined what additional measures should be undertaken.</p> <p>If the ERO determines that an archeological resource may be present within the project site, the project sponsor shall retain the services of a qualified archeological consultant. The archeological consultant shall advise the ERO as to whether the discovery is an archeological resource, retains sufficient integrity, and is of potential scientific/historical/cultural significance. If an archeological resource is present, the archeological consultant shall identify and evaluate the archeological resource. The archeological consultant shall make a recommendation as to what action, if any, is warranted. Based on this information, the ERO may require, if warranted, specific additional measures to be implemented by the project sponsor.</p> <p>Measures might include: preservation in situ of the archeological resource; an archaeological monitoring program; or an archeological testing program. If an archeological monitoring program or archeological testing program is required, it shall be consistent with the Major Environmental Analysis (MEA) division guidelines for such programs. The ERO may also require that the project sponsor immediately implement a site security program if the archeological resource is at risk from vandalism, looting, or other damaging actions.</p> <p>The project archeological consultant shall submit a Final Archeological Resources Report (FARR) to the ERO that evaluates the historical significance of any discovered archeological resource and describing the archeological and historical research methods employed in the archeological monitoring/data</p>				<p>complete after review and approval of the Final Archeological Resources Report by the ERO.</p>

# Exhibit C

## MITIGATION MONITORING AND REPORTING PROGRAM

### Attachment A

Measures Adopted as Conditions of Approval of the Balboa Park Station Area Plan Environmental Impact Report that are Applicable to the Project	Responsibility for Implementation	Mitigation Schedule	Monitoring/Report Responsibility	Status/Date Completed
<p>recovery program(s) undertaken. Information that may put at risk any archeological resource shall be provided in a separate removable insert within the final report.</p> <p>Copies of the Draft FARR shall be sent to the ERO for review and approval. Once approved by the ERO, copies of the FARR shall be distributed as follows: California Archaeological Site Survey Northwest Information Center (NWIC) shall receive one (1) copy and the ERO shall receive a copy of the transmittal of the FARR to the NWIC. The Major Environmental Analysis division of the Planning Department shall receive three copies of the FARR along with copies of any formal site recordation forms (CA DPR 523 series) and/or documentation for nomination to the National Register of Historic Places/California Register of Historical Resources. In instances of high public interest or interpretive value, the ERO may require a different final report content, format, and distribution than that presented above.</p>				
<p><b>AM-2:</b> AM-2 applies to any project involving any soils-disturbing activities greater than 10 feet in depth, including excavation, installation of foundations or utilities or soils remediation, and to any soils-disturbing project of any depth within the Phelan Loop and Kragen Auto Parts Sites, the east side of San Jose between Ocean and Geneva Avenues, and the Upper Yard Parcel.</p> <p>Based on the reasonable potential that archeological resources may be present within the Project Area, the following measures shall be undertaken to avoid any potentially significant adverse effect from the proposed project on buried historical resources. The project sponsor of a development project under the Balboa Park Station Area Plan shall retain the services of a qualified archeological consultant having expertise in California prehistoric and urban historical archeology. The archeological consultant shall undertake an archeological monitoring program. All plans and reports prepared by the consultant as specified herein shall be submitted first and directly to the ERO for review and comment, and shall be considered draft reports subject to revision until final approval by the ERO. Archeological monitoring and/or data recovery programs required by this measure could suspend construction of the project for up to a maximum of four weeks. At the direction of the ERO, the suspension of construction can be extended beyond four weeks only if such a suspension is the only feasible means to reduce the potential effects on a significant archeological resource as defined in CEQA Guidelines Sect. 15064.5 (a)(c), to a less-than-significant level.</p> <p>Archeological monitoring program (AMP). The archeological monitoring program shall minimally include the following provisions:</p> <ul style="list-style-type: none"> <li>The archeological consultant, project sponsor of a development project under</li> </ul>	<p>Project sponsor of each future development project within the Phelan Loop and Kragen Auto Parts Sites, the east side of San Jose between Ocean and Geneva Avenues, and the Upper Yard Parcel in the Balboa Park Station Area Plan</p>	<p>Prior to and during construction</p>	<p>The ERO to review and approve the Final Archeological Resources Report</p>	<p>The project archeologist to consult with the ERO as indicated. Considered complete after review and approval of the Final Archeological Resources Report by the ERO.</p>

# Exhibit C

## MITIGATION MONITORING AND REPORTING PROGRAM

### Attachment A

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<p>the Balboa Park Station Area Plan, and ERO shall meet and consult on the scope of the AMP reasonably prior to any project-related soils disturbing activities commencing. The ERO in consultation with the project archeologist shall determine what project activities shall be archeologically monitored. In most cases, any soils disturbing activities, such as demolition, foundation removal, excavation, grading, utilities installation, foundation work, driving of piles (foundation, shoring, etc.), site remediation, etc., shall require archeological monitoring because of the potential risk these activities pose to archaeological resources and to their depositional context;</p> <ul style="list-style-type: none"> <li>• The archeological consultant shall advise all project contractors to be on the alert for evidence of the presence of the expected resource(s), of how to identify the evidence of the expected resource(s), and of the appropriate protocol in the event of apparent discovery of an archeological resource;</li> <li>• The archaeological monitor(s) shall be present on the project site according to a schedule agreed upon by the archeological consultant and the ERO until the ERO has, in consultation with the archeological consultant, determined that project construction activities could have no effects on significant archeological deposits;</li> <li>• The archeological monitor shall record and be authorized to collect soil samples and artifactual/ecofactual material as warranted for analysis;</li> <li>• If an intact archeological deposit is encountered, all soils disturbing activities in the vicinity of the deposit shall cease. The archeological monitor shall be empowered to temporarily redirect demolition/excavation/pile driving/construction crews and heavy equipment until the deposit is evaluated. If in the case of pile driving activity (foundation, shoring, etc.), the archeological monitor has cause to believe that the pile driving activity may affect an archeological resource, the pile driving activity shall be terminated until an appropriate evaluation of the resource has been made in consultation with the ERO. The archeological consultant shall immediately notify the ERO of the encountered archeological deposit. The archeological consultant shall, after making a reasonable effort to assess the identity, integrity, and significance of the encountered archeological deposit, present the findings of this assessment to the ERO.</li> </ul> <p>If the ERO in consultation with the archeological consultant determines that a significant archeological resource is present and that the resource could be adversely affected by the proposed project, at the discretion of the project sponsor either:</p>				

# Exhibit C

## MITIGATION MONITORING AND REPORTING PROGRAM

Attachment A				
Measures Adopted as Conditions of Approval of the Balboa Park Station Area Plan Environmental Impact Report that are Applicable to the Project	Responsibility for Implementation	Mitigation Schedule	Monitoring/Report Responsibility	Status/Date Completed
<p>A) The proposed project shall be re-designed so as to avoid any adverse effect on the significant archeological resource; or</p> <p>B) An archeological data recovery program shall be implemented, unless the ERO determines that the archeological resource is of greater interpretive than research significance and that interpretive use of the resource is feasible.</p> <p>If an archeological data recovery program is required by the ERO, the archeological data recovery program shall be conducted in accord with an archeological data recovery plan (ADRP). The project archeological consultant, project sponsor, and ERO shall meet and consult on the scope of the ADRP. The archeological consultant shall prepare a draft ADRP that shall be submitted to the ERO for review and approval. The ADRP shall identify how the proposed data recovery program will preserve the significant information the archeological resource is expected to contain. That is, the ADRP will identify what scientific/historical research questions are applicable to the expected resource, what data classes the resource is expected to possess, and how the expected data classes would address the applicable research questions. Data recovery, in general, should be limited to the portions of the historical property that could be adversely affected by the proposed project. Destructive data recovery methods shall not be applied to portions of the archeological resources if nondestructive methods are practical.</p> <p>The scope of the ADRP shall include the following elements:</p> <ul style="list-style-type: none"> <li>• Field Methods and Procedures. Descriptions of proposed field strategies, procedures, and operations.</li> <li>• Cataloguing and Laboratory Analysis. Description of selected cataloguing system and artifact analysis procedures.</li> <li>• Discard and Deaccession Policy. Description of and rationale for field and post-field discard and deaccession policies.</li> <li>• Interpretive Program. Consideration of an on-site/off-site public interpretive program during the course of the archeological data recovery program.</li> <li>• Security Measures. Recommended security measures to protect the archeological resource from vandalism, looting, and non-intentionally damaging activities.</li> <li>• Final Report. Description of proposed report format and distribution of results.</li> </ul> <p>Curation. Description of the procedures and recommendations for the curation of</p>	<p>Project archeologist</p>	<p>Follow requirements of an ADRP</p>	<p>The ERO to review and approve the ADRP</p>	<p>Considered complete after review and approval of the ADRP by the ERO</p>

# Exhibit C

## MITIGATION MONITORING AND REPORTING PROGRAM

**Attachment A**

Measures Adopted as Conditions of Approval of the Balboa Park Station Area Plan Environmental Impact Report that are Applicable to the Project	Responsibility for Implementation	Mitigation Schedule	Monitoring/Report Responsibility	Status/Date Completed
<p>any recovered data having potential research value, identification of appropriate curation facilities, and a summary of the accession policies of the curation facilities.</p> <p>Human Remains, Associated or Unassociated Funerary Objects. The treatment of human remains and of associated or unassociated funerary objects discovered during any soils disturbing activity shall comply with applicable State and Federal Laws, including immediate notification of the Coroner of the City and County of San Francisco and in the event of the Coroner's determination that the human remains are Native American remains, notification of the California State Native American Heritage Commission (NAHC) who shall appoint a Most Likely Descendant (MLD) (Pub. Res. Code Sec. 5097.98). The archeological consultant, project sponsor, and MLD shall make all reasonable efforts to develop an agreement for the treatment of, with appropriate dignity, human remains and associated or unassociated funerary objects (CEQA Guidelines. Sec. 15064.5(d)). The agreement should take into consideration the appropriate excavation, removal, recordation, analysis, curation, possession, and final disposition of the human remains and associated or unassociated funerary objects.</p> <p>Final Archeological Resources Report. The archeological consultant shall submit a Draft Final Archeological Resources Report (FARR) to the ERO that evaluates the historical significance of any discovered archeological resource and describes the archeological and historical research methods employed in the archeological testing/monitoring/data recovery program(s) undertaken. Information that may put at risk any archeological resource shall be provided in a separate removable insert within the draft final report.</p> <p>Copies of the Draft FARR shall be sent to the ERO for review and approval. Once approved by the ERO copies of the FARR shall be distributed as follows: California Archaeological Site Survey Northwest Information Center (NWIC) shall receive one (1) copy and the ERO shall receive a copy of the transmittal of the FARR to the NWIC. The Major Environmental Analysis division of the Planning Department shall receive three copies of the FARR along with copies of any formal site recordation forms (CA DPR 523 series) and/or documentation for nomination to the National Register of Historic Places/California Register of Historical Resources. In instances of high public interest or interpretive value, the ERO may require a different final report content, format, and distribution than that presented above.</p>	<p>Project archeologist</p>          <p>Project archeologist</p>	<p>Following discovery of human remains</p>          <p>Completion of draft FARR</p>	<p>County Coroner and ERO</p>          <p>The ERO to review and approve the FARR</p>	<p>Completion of notification and consultation requirements of Pub. Res. Code Sec. 6097.98</p>          <p>Considered complete after review and approval of the FARR by the ERO</p>
<b>IMPROVEMENT MEASURES FOR THE BALBOA PARK STATION AREA PLAN</b>				

# Exhibit C

## MITIGATION MONITORING AND REPORTING PROGRAM

### Attachment A

Measures Adopted as Conditions of Approval of the Balboa Park Station Area Plan Environmental Impact Report that are Applicable to the Project	Responsibility for Implementation	Mitigation Schedule	Monitoring/Report Responsibility	Status/Date Completed
<b>Transportation Improvement Measures</b>				
The project sponsor shall coordinate with one of the carshare providers to provide carshare spaces within new off-street parking facilities to encourage carshare use. Make efforts to enhance transit, pedestrian, and bicycle circulation and access in the Project Area, which would reduce the reliance upon private vehicles.	Project sponsor of each future development project in the Balboa Park Station Area Plan	Ongoing, when new residents and commercial tenants move into a building	MTA, Planning Department	Ongoing
To minimize disruption of the general traffic flow on adjacent streets during the a.m. and p.m. peak periods, limit truck movements to the hours between 9:00 a.m. and 3:30 p.m. (or other times, if approved by MTA). In addition, have all construction contractors meet with representatives of MTA and the Planning Department to determine feasible measures to reduce traffic congestion, including transit disruption and pedestrian and bicycle circulation impacts during construction of individual projects within the Project Area.	Project sponsor of each future development project in the Balboa Park Station Area Plan	Prior to issuance of individual building permits	DBI	Ongoing
<b>Shadow Improvement Measure</b>				
<b>SM-1:</b> New buildings and additions to existing buildings in the Project Area where the building height exceeds 40 feet shall be shaped, consistent with the dictates of good design and without unduly restricting the development potential of the site in question, to reduce substantial shadow impacts on public plazas and other publicly accessible spaces other than those protected under Section 295 of the Planning Code.  In determining the impact of shadows, the following factors shall be taken into account: the amount of area shaded, the duration of the shadow, and the importance of sunlight to the use or utility of the open space being shaded.	Project sponsor of each future development project in the Balboa Park Station Area Plan	Prior to issuance of individual building permits	Planning Department	Ongoing
<b>Water Quality Improvement Measure</b>				
<b>WQ-1:</b> Incorporate green stormwater management technologies into proposed new open spaces in the Project Area. Examples of green stormwater technologies include swales and other infiltration methods, rainwater gardens, stormwater planters, green roofs, pervious concrete, green streets, new open space, and reducing the use of pipes, curbs and gutters. Incorporation of these green stormwater management technologies could further delay peak stormwater runoff flows and provide reduction of pollutants in the stormwater runoff discharged to the combined sewer system.	Project sponsor of each future development project in the Balboa Park Station Area Plan	Prior to issuance of individual building permits	Planning Department, DBI	Ongoing
<b>IMPROVEMENT MEASURES FOR PHELAN LOOP SITE</b>				


# Exhibit C

## MITIGATION MONITORING AND REPORTING PROGRAM

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<b>Transportation Improvement Measures</b>				
<b>Truck Loading:</b> <ul style="list-style-type: none"> <li>• Restrict truck access to the loading dock to 30 foot trucks or shorter.</li> <li>• Schedule all deliveries to reduce the potential for trucks waiting to enter the loading dock (which may cause a back-up onto Ocean Avenue). Traffic volumes along Ocean Avenue are constantly high throughout the day; therefore, deliveries between 7:00 a.m. and 7:00 p.m. should be avoided.</li> <li>• Maintain accurate truck logs to document the time and duration of truck activities.</li> <li>• Station loading dock personnel at the corner of the Ocean/Lee intersection and at the loading dock to assist truck maneuvers and to manage traffic flows.</li> <li>• Work with MTA to prohibit on-street parking along Lee Avenue during the peak loading periods to provide sufficient right-of-way for truck maneuvers.</li> </ul>				
Coordinate with one of the carshare providers to provide carshare spaces within the parking garage to encourage carshare use.	Phelan Loop Site project sponsor	Prior to issuance of building permit	MTA, Planning Department	Ongoing
Provide the Planning Code required shower and locker facilities for the retail space (four showers and eight lockers), and provide additional bicycle parking spaces in a safe and secure location for employees.	Phelan Loop Site project sponsor	Monitor biannually	MTA, Planning Department	Ongoing
During project construction, limit truck movements to the hours between 9:00 a.m. and 3:30 p.m. (or other times, if approved by MTA) to minimize disruption of the general traffic flow on adjacent streets during the a.m. and p.m. peak periods. In addition, construction contractors should meet with MTA, the Fire Department, and the Planning Department to determine feasible measures to reduce traffic congestion, including transit disruption and pedestrian circulation impacts during construction.	Phelan Loop Site project sponsor	Prior to construction	MTA, Planning Department	Completion of construction


# Parcel Map

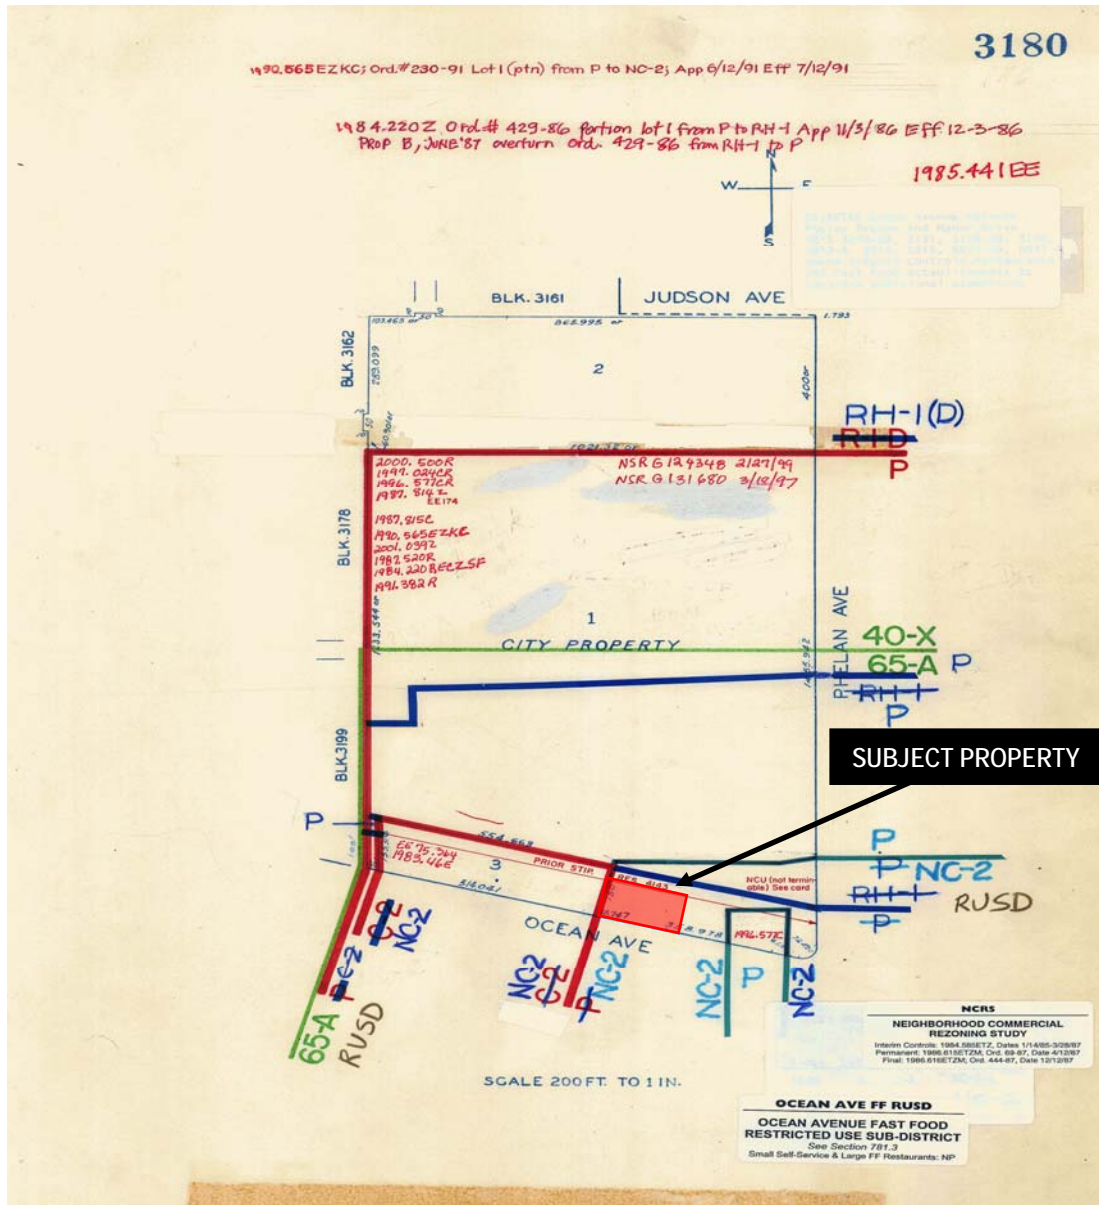

Conditional Use Hearing  
Case Number 2009.117C  
1100 Ocean Avenue



# Sanborn Map\*

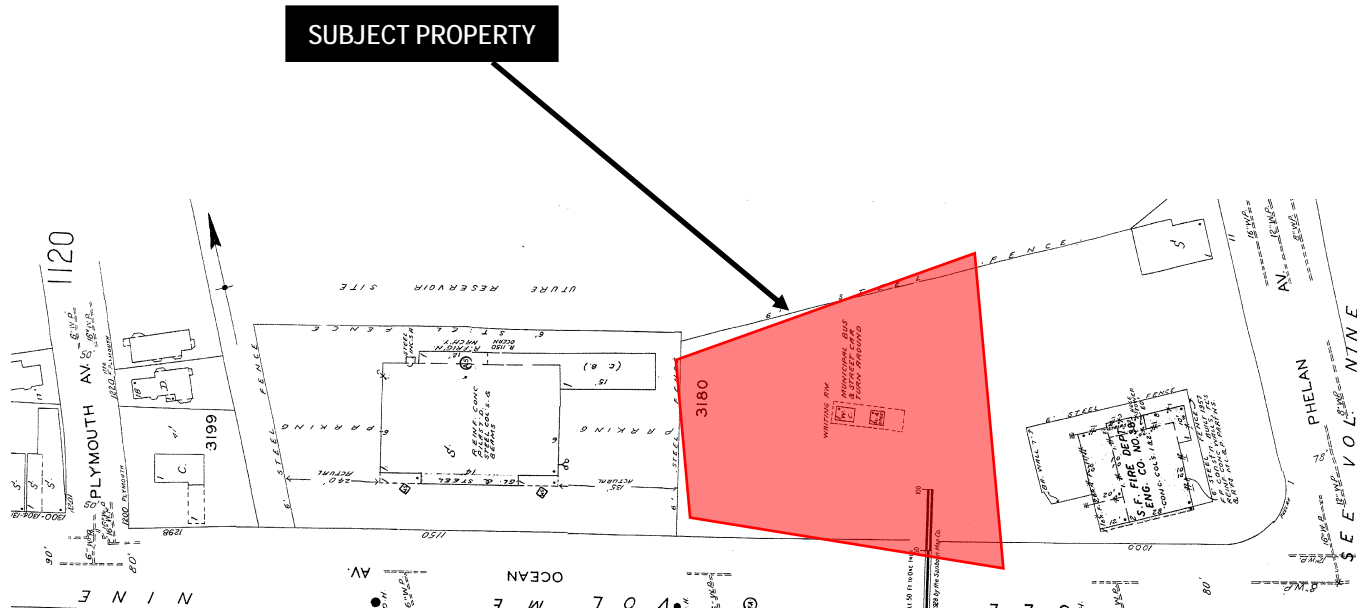

\*The Sanborn Maps in San Francisco have not been updated since 1998, and this map may not accurately reflect existing conditions.



Conditional Use Hearing  
Case Number 2009.117C  
1100 Ocean Avenue

# Zoning Map




Conditional Use Hearing  
Case Number 2009.1117C  
1100 Ocean Avenue

# Height Map



Conditional Use Hearing  
Case Number 2009.1117C  
1100 Ocean Avenue

# Aerial Photo

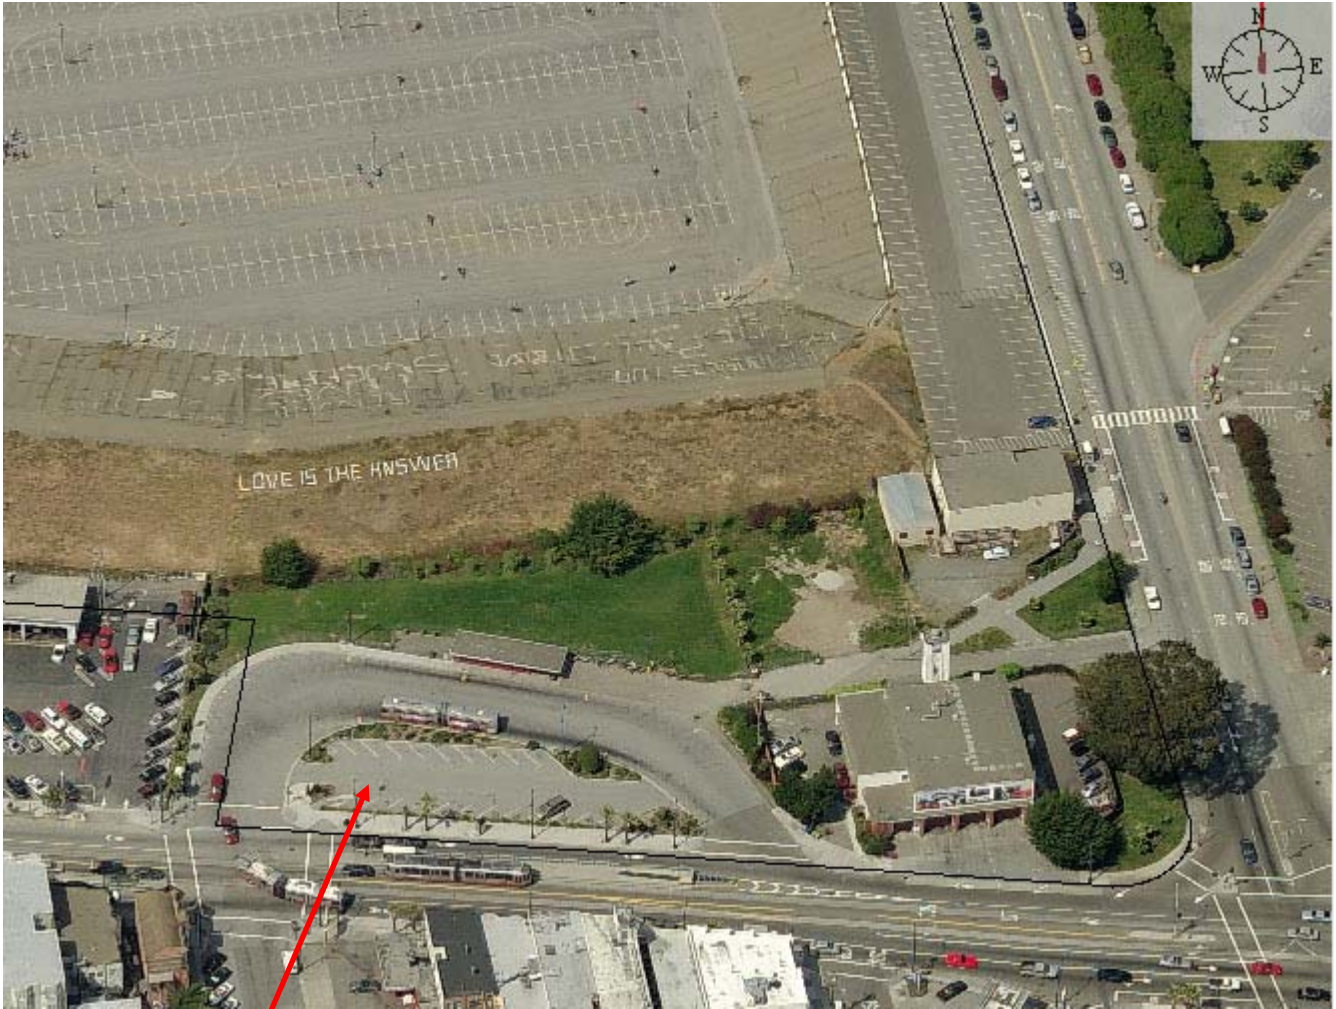

SUBJECT PROPERTY



Conditional Use Hearing  
Case Number 2009.1117C  
1100 Ocean Avenue

# Aerial Photo



**SUBJECT PROPERTY**



Conditional Use Hearing  
**Case Number 2009.1117C**  
1100 Ocean Avenue

***OUTER MISSION MERCHANTS and RESIDENTS ASSOCIATION  
POST OFFICE BOX 34099  
SAN FRANCISCO, CALIFORNIA 94134-0099***

*Steven R. Currier, President  
Alan Mills, 1<sup>st</sup> Vice President  
Joelle Kenealey, 2<sup>nd</sup> Vice President  
Monika Yungert, Secretary  
Kenneth Kalani, Treasurer  
Alex Murillo, Sergeant-at-Arms  
Vacant, Member-at-Large  
Marleen Norman, Member-at-Large  
Vacant, Newsletter Editor*

*Members of Organizations:  
Coalition for San Francisco Neighborhoods  
District 11 Council  
Friends of the Geneva Office Building  
San Francisco Police Officers Association*

July 12, 2010

Mr. Kevin Kitchingham  
Housing Director  
**Bernal Heights Neighborhood Center**  
515 Cortland Avenue  
San Francisco, CA 94110

**RE: Phelan Loop Affordable Housing Project**

Dear Mr. Kitchingham:

On behalf of the Outer Mission Merchants and Residents Association (OMMRA) and its Executive Board, I write to enthusiastically support your project on Ocean Avenue as affordable supportive housing for families and transitional aged youth along with commercial spaces.

Since 1998, OMMRA then OMRA, has worked to make the Balboa Park Station Area Plan the transit hub that it is. For years, in many meetings, to many to number, it has never been disputed that this area rich in public transit consider transit villages. This project has the earmarks of a transit village with approximately 70 units. Due to the number of various public transportation options, the idea to limit parking and consider the number of intermodal opportunities, this is a perfect area for this housing.

I am particularly excited about bringing in transitional aged youth (TAY) who are at risk and will be able to access services as needed. Youth and young adults who are transitioning are particularly at risk and for them to access the services from the Department of Health and other agencies are welcomed.

**Mr. Kevin Kitchingham**  
**Housing Director**  
**Bernal Heights Neighborhood Center**  
**July 12, 2010**  
**Page Two**

All in all, OMMRA has been actively working on these area projects and welcome this development and look forward to its groundbreaking and eventual ribbon cutting.

Congratulations on all your work on this project.

Sincerely,

Steven R. Currier  
President, OMMRA  
415.587.9150  
[Steven.currier@sfdistricts.org](mailto:Steven.currier@sfdistricts.org)

CC: OMMRA Executive Board  
Mary C. Harris, President District 11 Council  
Supervisor John Avalos, District 11  
Supervisor Sean Elsbernd, District 7



July 14, 2010

San Francisco Planning Commission  
President Ron Miguel  
1650 Mission Street, Suite 400  
San Francisco, CA 94103

Subject: Support for Phelan Loop Affordable Housing

Dear President Miguel,

I am writing this letter on behalf of the Corporation for Supportive Housing Northern California Office in support of the proposal by the Bernal Heights Neighborhood Center and Mercy Housing to develop 71 units of transit-oriented, affordable family housing at the corner of Ocean and Phelan commonly known as the Phelan Loop.

The proposed development represents all that is good when a community-based developer such as the Bernal/Mercy team engages with neighborhood stakeholders to bring forth a truly inspirational housing project. I have been continually impressed by the openness and inclusiveness of the development team's engagement process with community members from the early stages of this project's genesis to today.

The project serves the needs of the local community and brings vital support services to an area which suffers from a dearth of options for both transition age youth and families seeking to stay in San Francisco. Over the years, the Corporation for Supportive Housing has been an enthusiastic supporter of affordable and supportive housing developments with homes for transition age youth who are homeless or at risk of homelessness. When provided with decent, safe, and affordable housing – along with access to flexible supportive services – transition age youth can begin to heal from past traumas, create community connections, and learn the skills that they will need to live stable, independent lives.

I am also delighted that this transit-oriented project will revitalize the Ocean Avenue corridor by including retail, anchoring and enhancing the commercial strength of this emerging business district and providing employment opportunities for the area's youth. Since our inception, CSH has been an advocate for the creation of mixed-use affordable housing and retail opportunities close to transportation, employment and community services.

Please accept this letter as my support for the Bernal/Mercy project at the Phelan Loop. Do not hesitate to contact me at (510) 251-1910 ext. 208 if you have any questions.

Sincerely,

Anne Cory  
Director, CSH Northern California

Corporation for Supportive Housing  
1330 Broadway, Suite 601  
Oakland, CA 94612  
T 510.251.1910  
F 510.251.5954  
[www.csh.org](http://www.csh.org)

CSH HELPS COMMUNITIES

CREATE PERMANENT


HOUSING WITH SERVICES

TO PREVENT AND END


HOMELESSNESS.



VICINITY MAP

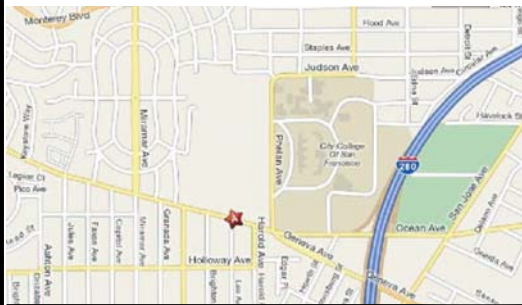

PLOT PLAN

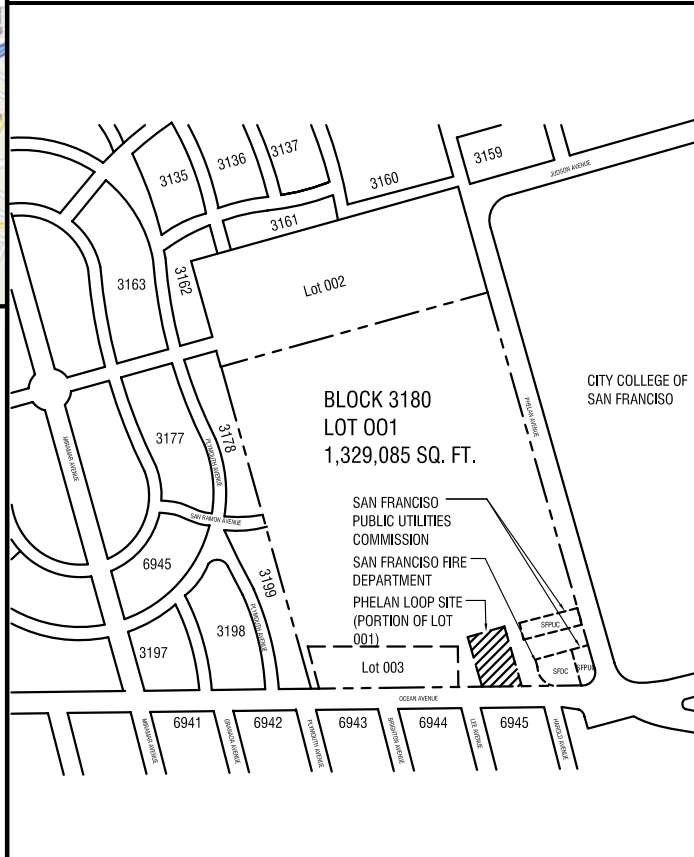


GENERAL NOTES

- DO NOT SCALE DRAWINGS. CONTRACTOR SHALL VERIFY ALL DIMENSIONS. IF DISCREPANCIES ARE FOUND, THE ARCHITECT SHALL BE NOTIFIED IMMEDIATELY.
- THE DIMENSIONS SHOWN ON PLANS, SECTIONS AND DETAILS ARE TO FACE OF STUD, GRID LINE, OR FACE OF CONCRETE, UNLESS OTHERWISE NOTED.
- THE STRUCTURAL, ELECTRICAL, AND MECHANICAL DRAWINGS ARE SUPPLEMENTARY TO THE ARCHITECTURAL DRAWINGS. IT SHALL BE THE RESPONSIBILITY OF THE CONTRACTOR TO CHECK THE ARCHITECTURAL DRAWINGS BEFORE THE INSTALLATION OF STRUCTURAL, ELECTRICAL, OR MECHANICAL WORK. SHOULD THERE BE ANY DISCREPANCIES IN THE DRAWINGS THAT CONFLICT WITH THE ARCHITECTURAL DESIGN, THEY SHALL BE BROUGHT TO THE ARCHITECT'S ATTENTION FOR CLARIFICATION. WORK INSTALLED IN CONFLICT WITH THE ARCHITECTURAL DRAWINGS SHALL BE CORRECTED BY THE GENERAL CONTRACTOR AT HIS/HER COST.
- INSTALLATION OF SPECIFIED ITEMS SHALL FOLLOW THE MANUFACTURER'S PUBLISHED SPECIFICATIONS AND/OR TRADE STANDARDS IN ADDITION TO MEETING OR EXCEEDING THE DESIGN STANDARDS.
- PROVIDE MINIMUM CLASS A FIRE-RETARDANT ROOFING ASSEMBLY PER MANUFACTURER'S INSTALLATION INSTRUCTIONS AND CONDITIONS OF LISTING.
- FIRESTOPPING SHALL BE PROVIDED IN THE FOLLOWING LOCATIONS PER CBC SECTION 708.
  - IN CONCEALED SPACES OF STUD WALLS AND PARTITIONS, INCLUDING FURRED SPACES AT THE CEILING AND FLOOR LEVELS AND AT 10-FOOT INTERVALS BOTH HORIZONTAL AND VERTICAL.
  - AT ALL INTERCONNECTIONS BETWEEN VERTICAL AND HORIZONTAL SPACES SUCH AS OCCUR AT SOFFITS, DROPPED AND COVERED CEILINGS.
  - IN CONCEALED SPACES BETWEEN STAIR STRINGERS AT THE TOP AND BOTTOM OF THE RUN, AND BETWEEN STUDS ALONG AND IN LINE WITH THE RUN OF STAIRS IF THE WALLS UNDER THE STAIRS ARE UNFINISHED.
  - IN OPENINGS AROUND VENTS, PIPES, DUCTS AND SIMILAR OPENINGS WHICH AFFORD A PASSAGE FOR FIRE AT THE CEILING AND FLOOR LEVELS WITH NON COMBUSTIBLE MATERIALS.
- DRAFT STOPS SHALL BE INSTALLED PER CBC SECTION 708 IN FLOOR-CEILING ASSEMBLIES IN LINE WITH WALLS SEPARATING INDIVIDUAL DWELLING UNITS FROM EACH OTHER AND FROM OTHER AREAS.
- WALLS NOT NOTED WITH A WALL TYPE SYMBOL SHALL BE CONSTRUCTED IN ACCORDANCE WITH WALL TYPE 1A, WHERE A WALL CHANGES TYPES IN A SINGLE LENGTH, THE PLANE OF THE WALL SHALL NOT CHANGE IN ANY LOCATION OTHER THAN WHERE THERE IS A NEUTRAL BREAKING POINT (I.E. AT AN INTERSECTING WALL).
- EVERY DWELLING UNIT AND SLEEPING ROOM SHALL BE PROVIDED WITH AN EMERGENCY EGRESS WINDOW PER SECTION 310.4 OF THE CBC. CONTRACTOR TO VERIFY THAT THE WINDOWS SHOWN IN THE DRAWINGS MEET THE FOLLOWING CLEARANCE CRITERIA.
  - MINIMUM NET CLEAR OPENING OF 5.7 SQUARE FEET.
  - MINIMUM NET CLEAR OPENING HEIGHT OF 24 INCHES.
  - MINIMUM NET CLEAR OPENING WIDTH OF 20 INCHES.
  - MAXIMUM FINISH SILL HEIGHT OF 44 INCHES.

LIST OF ABBREVIATIONS

@	AT	INSUL.	INSULATION
ABV.	ABOVE	JT	JOINT
A.F.F.	ABOVE FINISH FLOOR	L.P.	LOW POINT
ALV.	ALUMINUM	MAX.	MAXIMUM
B.F.F.	BELOW FINISH FLOOR	MIN.	MINIMUM
BD.	BOARD	MTL.	METAL
BLDG.	BUILDING	N.A.	NOT APPLICABLE
BLKG.	BLOCKING	N.I.C.	NOT IN CONTRACT
BLW.	BELOW	N.T.S.	NOT TO SCALE
BOT.	BOTTOM	NO.	NUMBER
BM.	BEAM	O.H.	OPPOSITE HAND
B.U.R.	BUILT UP ROOFING	OP.	OPPOSITE
CA.	SECURITY CAMERA	P.L.	PROPERTY LINE
CL.	CENTERLINE	P.LAM.	PLASTIC LAMINATE
C.J.	CONTROL JOINT	P.T.	PRESSURE TREATED
CAB.	CABINET	PERF.	PERFORATED
CLG.	CEILING	PLYWD.	PLYWOOD
CLK.	CAULK	PT.	POINT
CLR.	CLEAR	R.	RISER(S)
COL.	COLUMN	R.W.L.	RAIN WATER LEADER
CONC.	CONCRETE	RAD.	RADIUS
CONT.	CONTINUOUS	RES.	RESILIENT
CPT.	CARPET	RM.	ROOM
DEMO.	DEMOLISH	S.D.	STORM DRAIN
DET.	DETAIL	S.A.D.	SEE ARCHITECTURAL DRAWINGS
DIA.	DIAMETER	S.C.D.	SEE CIVIL DRAWINGS
DN.	DOWN	S.E.D.	SEE ELECTRICAL DRAWINGS
DWG.	DRAWING	S.L.D.	SEE LANDSCAPE DRAWINGS
EL.	ELEVATION	S.M.D.	SEE MECHANICAL DRAWINGS
ELEC.	ELECTRIC(AL)	S.P.D.	SEE PLUMBING DRAWINGS
EMERG.	EMERGENCY	S.S.D.	SEE STRUCTURAL DRAWINGS
ENCL.	ENCLOSURE	SHT.	SHEET
EQ.	EQUAL	SIM.	SIMILAR
EQUIP.	EQUIPMENT	STD.	STANDARD
EXIST.	EXISTING	ST.	STREET
F.C.	FIBER CEMENT	STL.	STEEL
F.D.	FLOOR DRAIN	STRUCT.	STRUCTURE
F.E.C.	FIRE EXTINGUISHER CABINET	T.C.	TOP OF CURB
F.F.	FINISH FLOOR	T.O.	TOP OF
FLR.	FLOOR	T.O.C.	TOP OF CONCRETE
F.O.C.	FACE OF CONCRETE	T.O.S.	TOP OF SLAB
F.O.F.	FACE OF FINISH	T.O.STL.	TOP OF STEEL
F.O.S.	FACE OF STUD	T.P.	TOILET PAPER
FIN.	FINISH	TEL.	TELEPHONE
FIXT.	FIXTURE	TYP.	TYPICAL
FNDN.	FOUNDATION	U.O.N.	UNLESS OTHERWISE NOTED
FT.	FOOT/FEET	W/	WITH
G.I.	GROUND FAULT INTERRUPTER	W/O	WITHOUT
G.S.M.	GALVANIZED SHEET METAL	W.O.	WHERE OCCURS
GA.	GALVE	WD.	WOOD
GALV.	GALVANIZED	W.A.	WATERPROOF
GL.	GLASS		
GYP. BD.	GYPSPUM BOARD		
HT.	HEIGHT		
H.P.	HIGH POINT		

LEGEND OF SYMBOLS

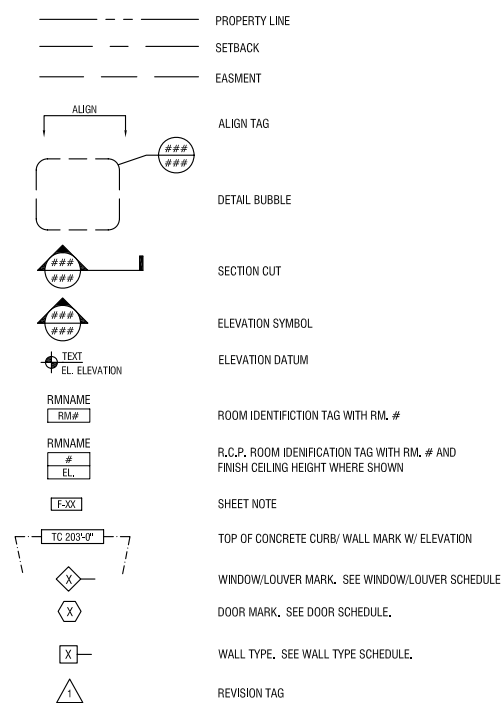

OCEAN AVENUE ELEVATION



PROJECT DATA

Address:	PHELAN LOOP	Building Coverage:	
Block:	3180	-Front and side setbacks are not required	
Lots:	PORTION OF LOT 001	-Rearyard requirement per sec. 134(e)(1 & 2)	
Parcel Area:	25,772 SQ. FT.	-Rearyard provided = 1,302 sf	
Buildable Area:	18,950 SQ. FT.	MODIFICATION REQUIRED	
Zoning:	OCEAN AVENUE NCT	Conditional use permits:	
Height Limit:	5'	Planned Unit Development	
Bulk Limit:	"A"		

Open Space Requirements per Section 135 & Table 135A  
 100 SQ. FT. of private open space per unit or  
 1.33 SQ. FT. of common space per every 1 sq. ft. of required private space

100 S.F. X 71 units = 7,100 S.F. private space required  
 7,100 S.F. X 1.33 = 9,443 S.F. common area required

**PHELAN LOOP HOUSING SITE PROVIDES :**

- 2,112 S.F. GARDEN AREA @ REAR YARD
- 724 S.F. ENTRY COURTYARD & COURTYARD STAIR
- 3,615 S.F. OPEN COURTYARD @ SECOND FLOOR
- 1,230 S.F. PLAY AREA @ SECOND FLOOR
- 160 S.F. PRIVATE DECK @ FIFTH FLOOR
- 3,490 S.F. OPEN SPACE/EGRESS EASEMENT
- 11,331 SQ. FT. TOTAL USABLE OPEN SPACE

**RETAIL SQUARE FOOTAGE:**

Gross	Occupied
7,300 SQ. FT.	5,404 SQ. FT.

GROSS AREA INCLUDES: RETAIL CORRIDOR: 735 S.F., BATHROOMS: 270 S.F., BICYCLE: 67 S.F., FRASH: 545 S.F. AND LOCKERS: 271 S.F.  
 (ALL MEASUREMENTS TO CENTER LINE OF WALL)

# PHELAN LOOP AFFORDABLE MULTI-FAMILY HOUSING DEVELOPMENT

## OCEAN AVENUE & LEE AVENUE

### SAN FRANCISCO, CA 94112

PROJECT TEAM

<b>CLIENT</b>	Bernal Heights Neighborhood Center Contact: William Ho 515 Cortland Ave., San Francisco, CA 94110 T: 415.206.2140 F: 415.648.0793 E: who@bhnc.org
<b>DEVELOPMENT CONSULTANT</b>	Mercy Housing of San Francisco Contact: Jennifer Dolin 1360 Mission Street San Francisco, CA 94103 T: 415.335.7114 F: 415.503.1320 E: JDolin@mercyhousing.org
<b>CONSTRUCTION MANAGEMENT</b>	Armando Vasquez Architecture & Construction Management Contact: Armando Vasquez 1247 Florida Street San Francisco, CA 94110 T: 415.425.1771 E: avarchcm@aestound.net
<b>ARCHITECT</b>	Herman Colver Locus Architecture Contact: Shelley Davis 363 Clementina Street San Francisco, CA 94103 T: 415.458.1776 F: 415.552.9811 E: sdavis@hclrchitecture.com

SCOPE OF WORK

Project Description/Proposed Use:

- 5 story building of studios, 1, 2 and 3 bedroom rental dwelling units for families and young adults transitioning out of foster care with parking/retail/social service space at the street/ground level.

SHEET INDEX

GENERAL	
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A0.2	PHOTO REFERENCE SHEET
A0.3	SITE PHOTOGRAPHS
A0.4	SITE PHOTOGRAPHS
A0.5	SITE PHOTOGRAPHS
A0.6	PERSPECTIVES
A0.7	PERSPECTIVES
A0.8	ENLARGED SOUTH ELEVATION AND MATERIALS
A1.0	EXISTING SITE/PLOT PLAN
A1.1	NEW SITE PLAN
A2.0	GROUND FLOOR PLAN
A2.1	SECOND FLOOR PLAN
A2.2	THIRD FLOOR PLAN
A2.3	FOURTH FLOOR PLAN
A2.4	FIFTH FLOOR PLAN
A2.5	MEZZANINE PLAN
A2.6	ROOF PLAN
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A2.8	UNIT PLANS
A2.9	UNIT PLANS
A3.0	SOUTH & EAST BUILDING ELEVATIONS
A3.0a	OCEAN AVENUE ELEVATION & ADJACENT BUILDINGS
A3.1	NORTH AND WEST BUILDING ELEVATIONS
A3.2	BUILDING SECTIONS

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Key Plan:

General Notes/Legend:

Consultant:

Stamp:


Rev. No.	Revision	Date
	Environmental Evaluation App.	12.04.09
	Conditional Use Application	12.14.09
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	CUP/Prelim. Pricing Rev. 1	06.15.10
	CUP/Prelim. Pricing Rev. 2	07.07.10
	Planning Commission Hearing	07.12.10

Project Title:  
**PHELAN LOOP AFFORDABLE HOUSING**

Ocean Avenue & Lee Avenue  
 San Francisco, CA 94112

Sheet Title:  
**COVER SHEET**


Scale:  
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Drawn By:	SD, JW	Sheet Number:	<b>A0.1</b>
Checked:		Associate:	
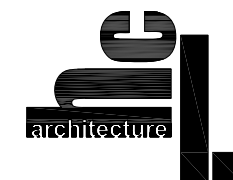
# PHELAN LOOP SITE (PORTION OF LOT 001)



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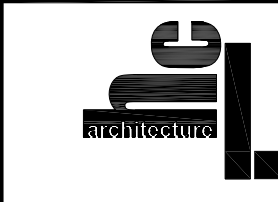
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Sheet Title:  
PHOTO REFERENCE MAP

Scale:  
NTS

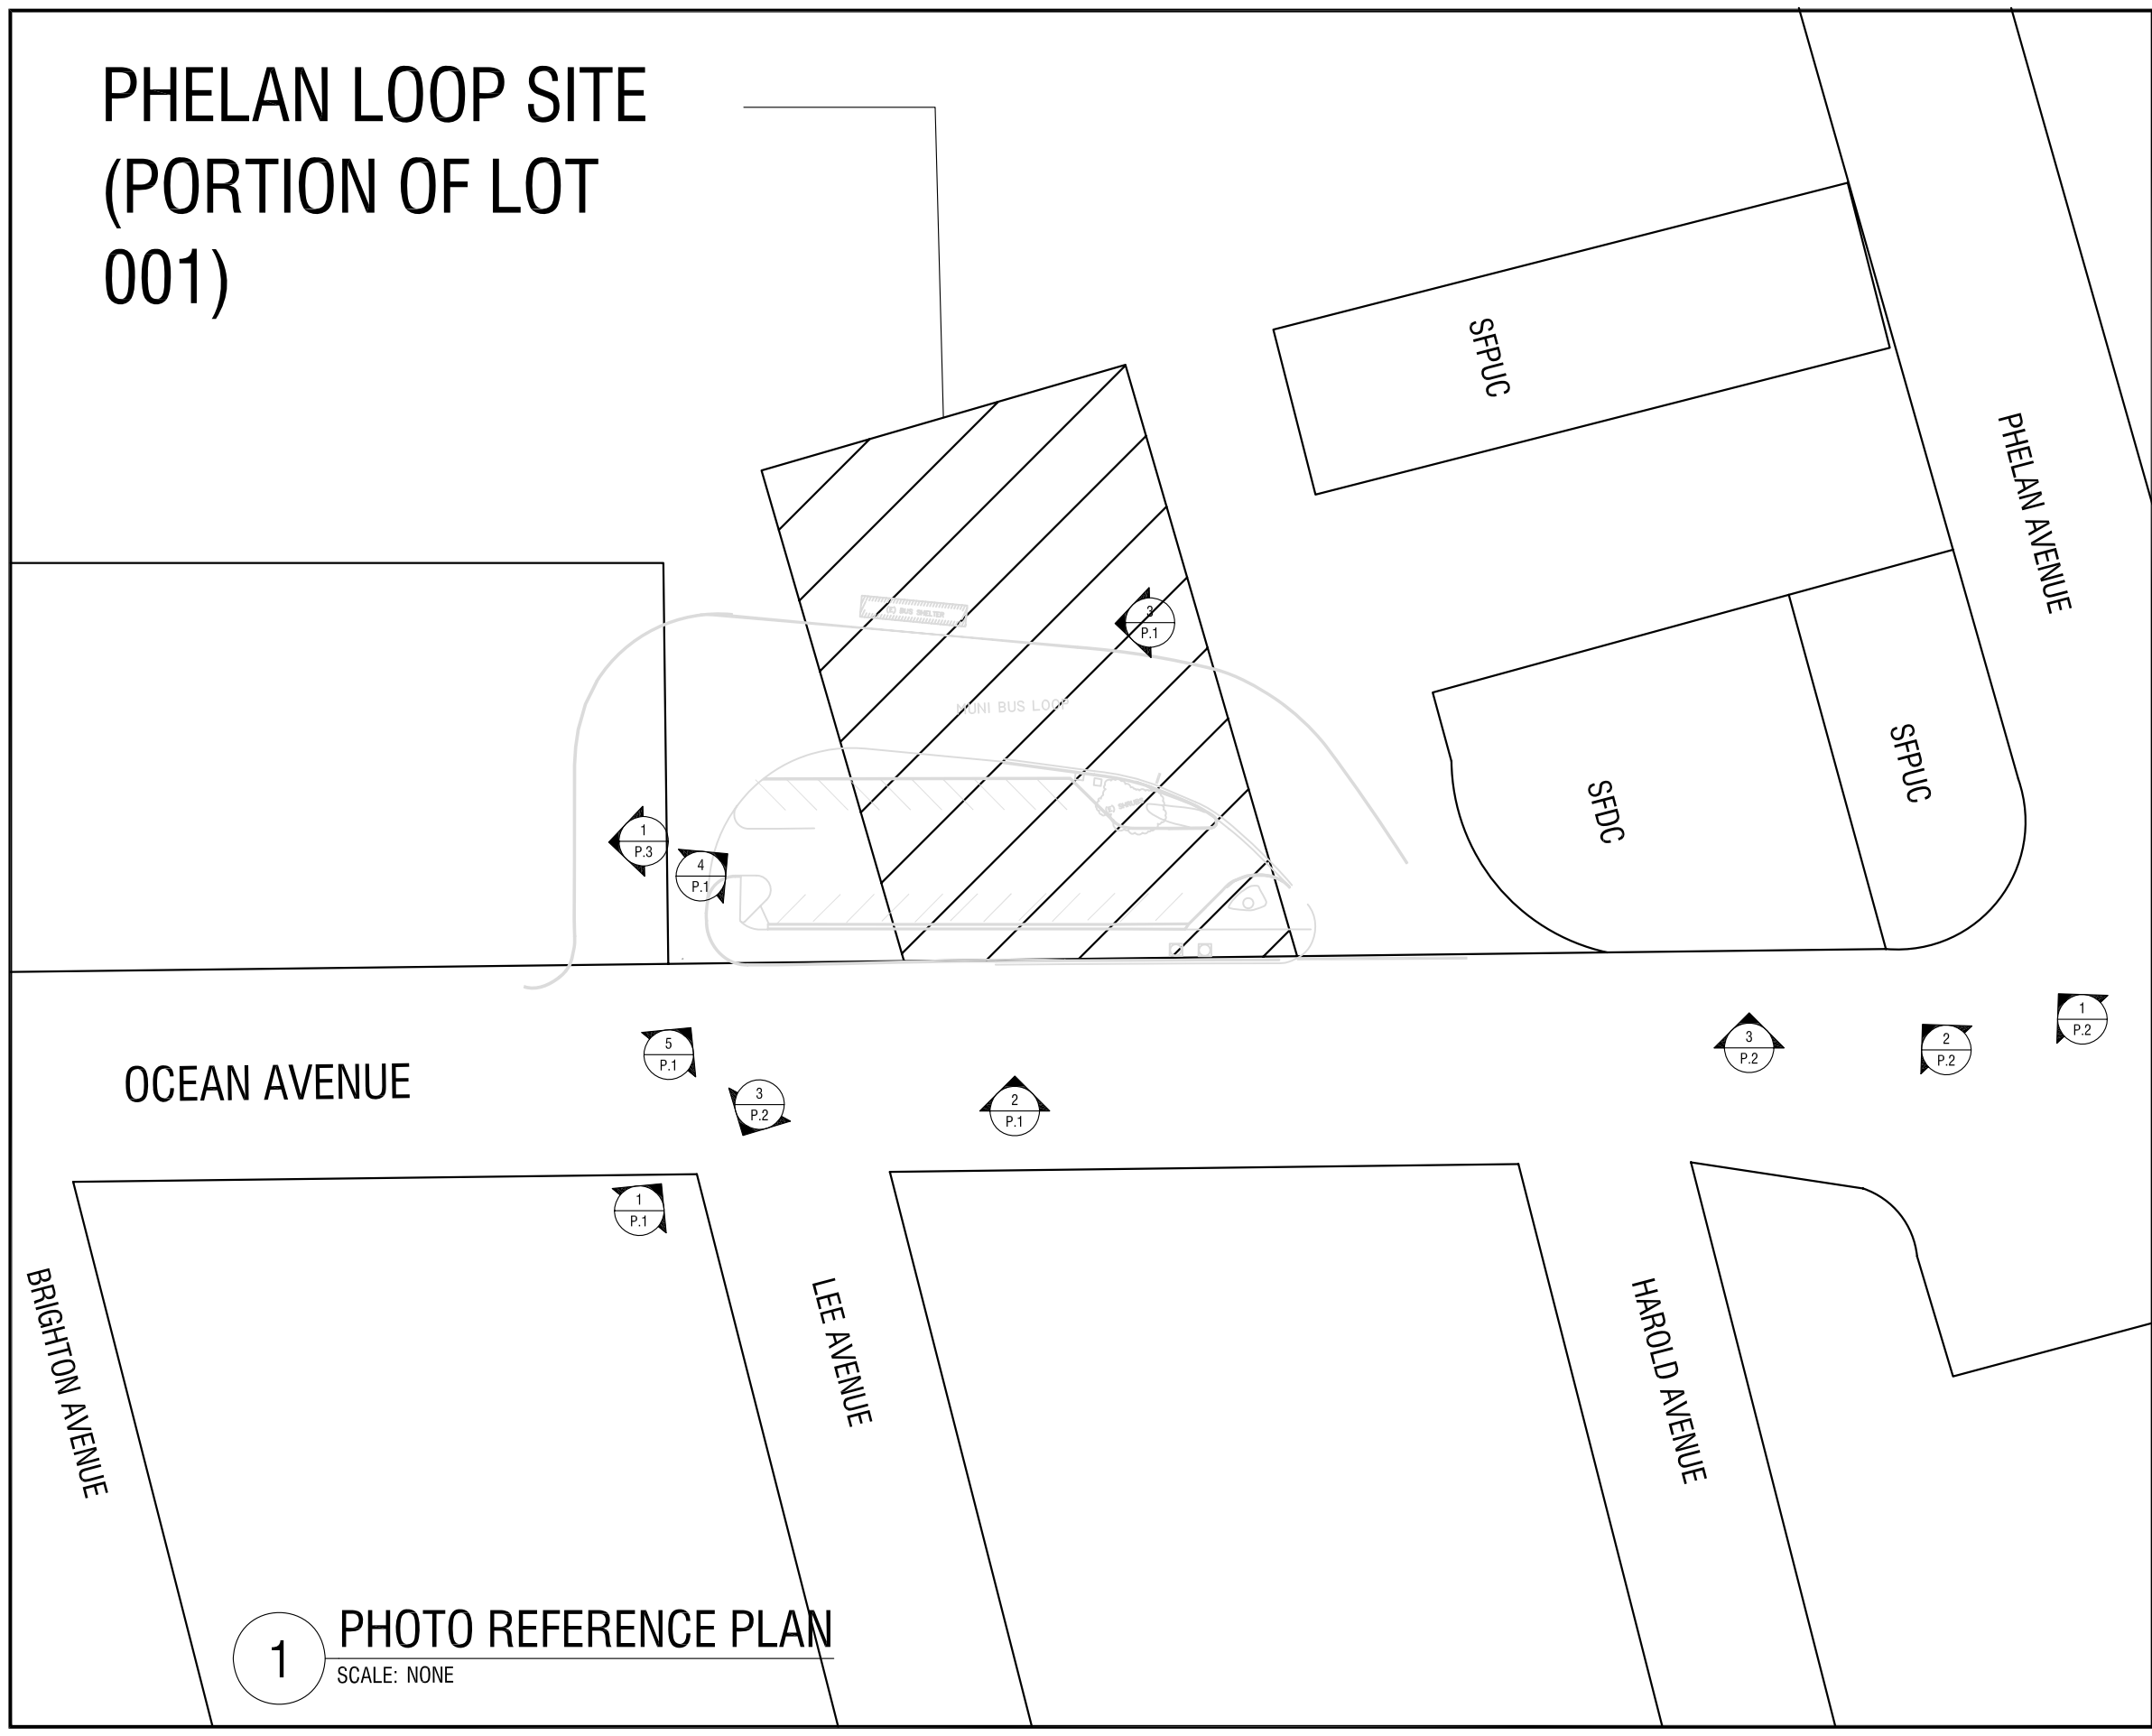

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Checked: \_\_\_\_\_  
Associate: \_\_\_\_\_  
Sheet Number:  
**A0.2**

**1** PHOTO REFERENCE PLAN  
SCALE: NONE



1 PHELAN LOOP SITE (EXISTING MUNI BUS LOOP) LOOKING NORTH EAST  
SCALE:



2 PHELAN LOOP SITE LOOKING NORTH FROM MUNI STOP  
SCALE:



4 PHELAN LOOP SITE LOOKING NORTH  
SCALE:



3 PHELAN LOOP SITE LOOKING NORTH  
SCALE:



5 PHELAN LOOP SITE  
SCALE:

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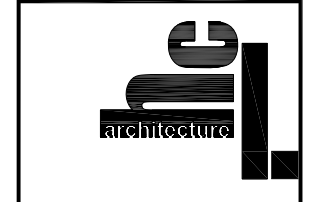
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Project Title:  
**PHELAN LOOP AFFORDABLE HOUSING**  
  
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Sheet Title:  
**SITE PHOTOGRAPHS**

Scale:  
NTS



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Associate: \_\_\_\_\_  
Sheet Number:  
**A0.3**



1 OCEAN AVENUE- ACROSS FROM PHELAN LOOP SITE  
SCALE:



2 OCEAN AVENUE- LOOKING WEST TOWARD PHELAN LOOP SITE  
SCALE:



3 OCEAN AVENUE- EXISTING FIRE STATION EAST OF PHELAN LOOP SITE  
SCALE:

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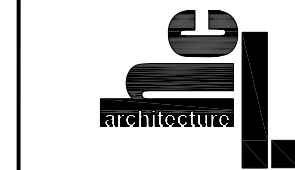
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San Francisco, CA 94112

Sheet Title:  
**SITE PHOTOGRAPHS**

Scale:  
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Checked: \_\_\_\_\_  
Associate: \_\_\_\_\_  
Sheet Number:  
**A0.4**



1 KRAGEN SITE ALONG FUTURE LEE STREET EXTENSION  
SCALE:

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General Notes/Legend:



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AFFORDABLE HOUSING**

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Sheet Title:

SITE PHOTOGRAPHS

Scale:

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Drawn By: \_\_\_\_\_  
Checked: \_\_\_\_\_  
Associate: \_\_\_\_\_

Sheet Number:  
**A0.5**



1 VIEW OF SOUTHEAST CORNER FROM OCEAN  
SCALE: N.T.S.



2 VIEW OF SOUTH ELEVATION FROM OCEAN  
SCALE: N.T.S.

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Project Title:  
**PHELAN LOOP  
AFFORDABLE HOUSING**

Ocean Avenue & Lee Avenue  
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Sheet Title:  
**PERSPECTIVES**

Scale:  
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Checked: Associate: **A0.6**



1 VIEW OF SOUTHWEST CORNER FROM OCEAN  
SCALE: N.T.S.



1 VIEW OF ENTRY AND CHILDREN'S PLAY SPACE FROM PLAZA  
SCALE: N.T.S.



2 VIEW OF NORTHEAST CORNER FROM PLAZA  
SCALE: N.T.S.

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Ocean Avenue & Lee Avenue  
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Sheet Title:  
**PERSPECTIVES**

Scale:  
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1 SOUTH ELEVATION

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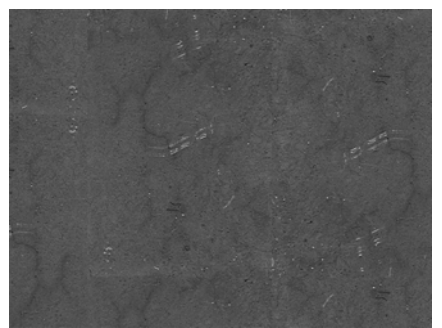
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General Notes/Legend:

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2 STAINED CONCRETE MATERIAL A



3 CEMENT BOARD: LIGHT BLUE MATERIAL B



4 CEMENT BORAD: ASH MATERIAL C




5 CEMENT BORAD: CORAL MATERIAL C, COLOR C1



6 COLORS




7 POWDER COATED METAL PANEL MATERIAL D

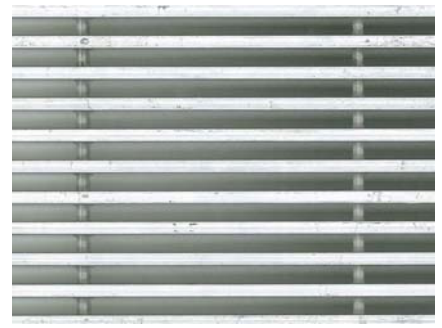

8 ANODIZED ALUMINUM MATERIAL E



9 METAIL GUARDRAIL, PAINTED

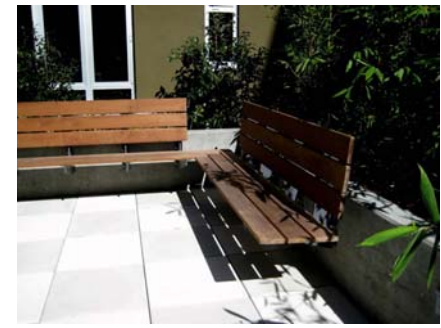

10 IPE BENCH




11 SIGNAGE



12 ALUMINUM STOREFRONT



13 STEEL CANOPY

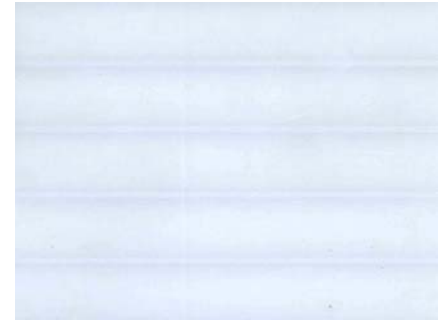

14 GLAZING AT OCEAN AVE. AWNING



15 ALUMINUM WINDOW




16 METAL COPING, PAINTED

Project Title:  
**PHELAN LOOP AFFORDABLE HOUSING**

Ocean Avenue & Lee Avenue  
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Sheet Title:  
**ENLARGED SOUTH ELEVATION & MATERIALS**

Scale:  
NTS

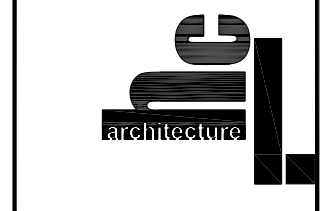


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Drawn By: JW Sheet Number:  
Checked: Associate: A0.8



**BLOCK 3180  
PORTION OF LOT 001**

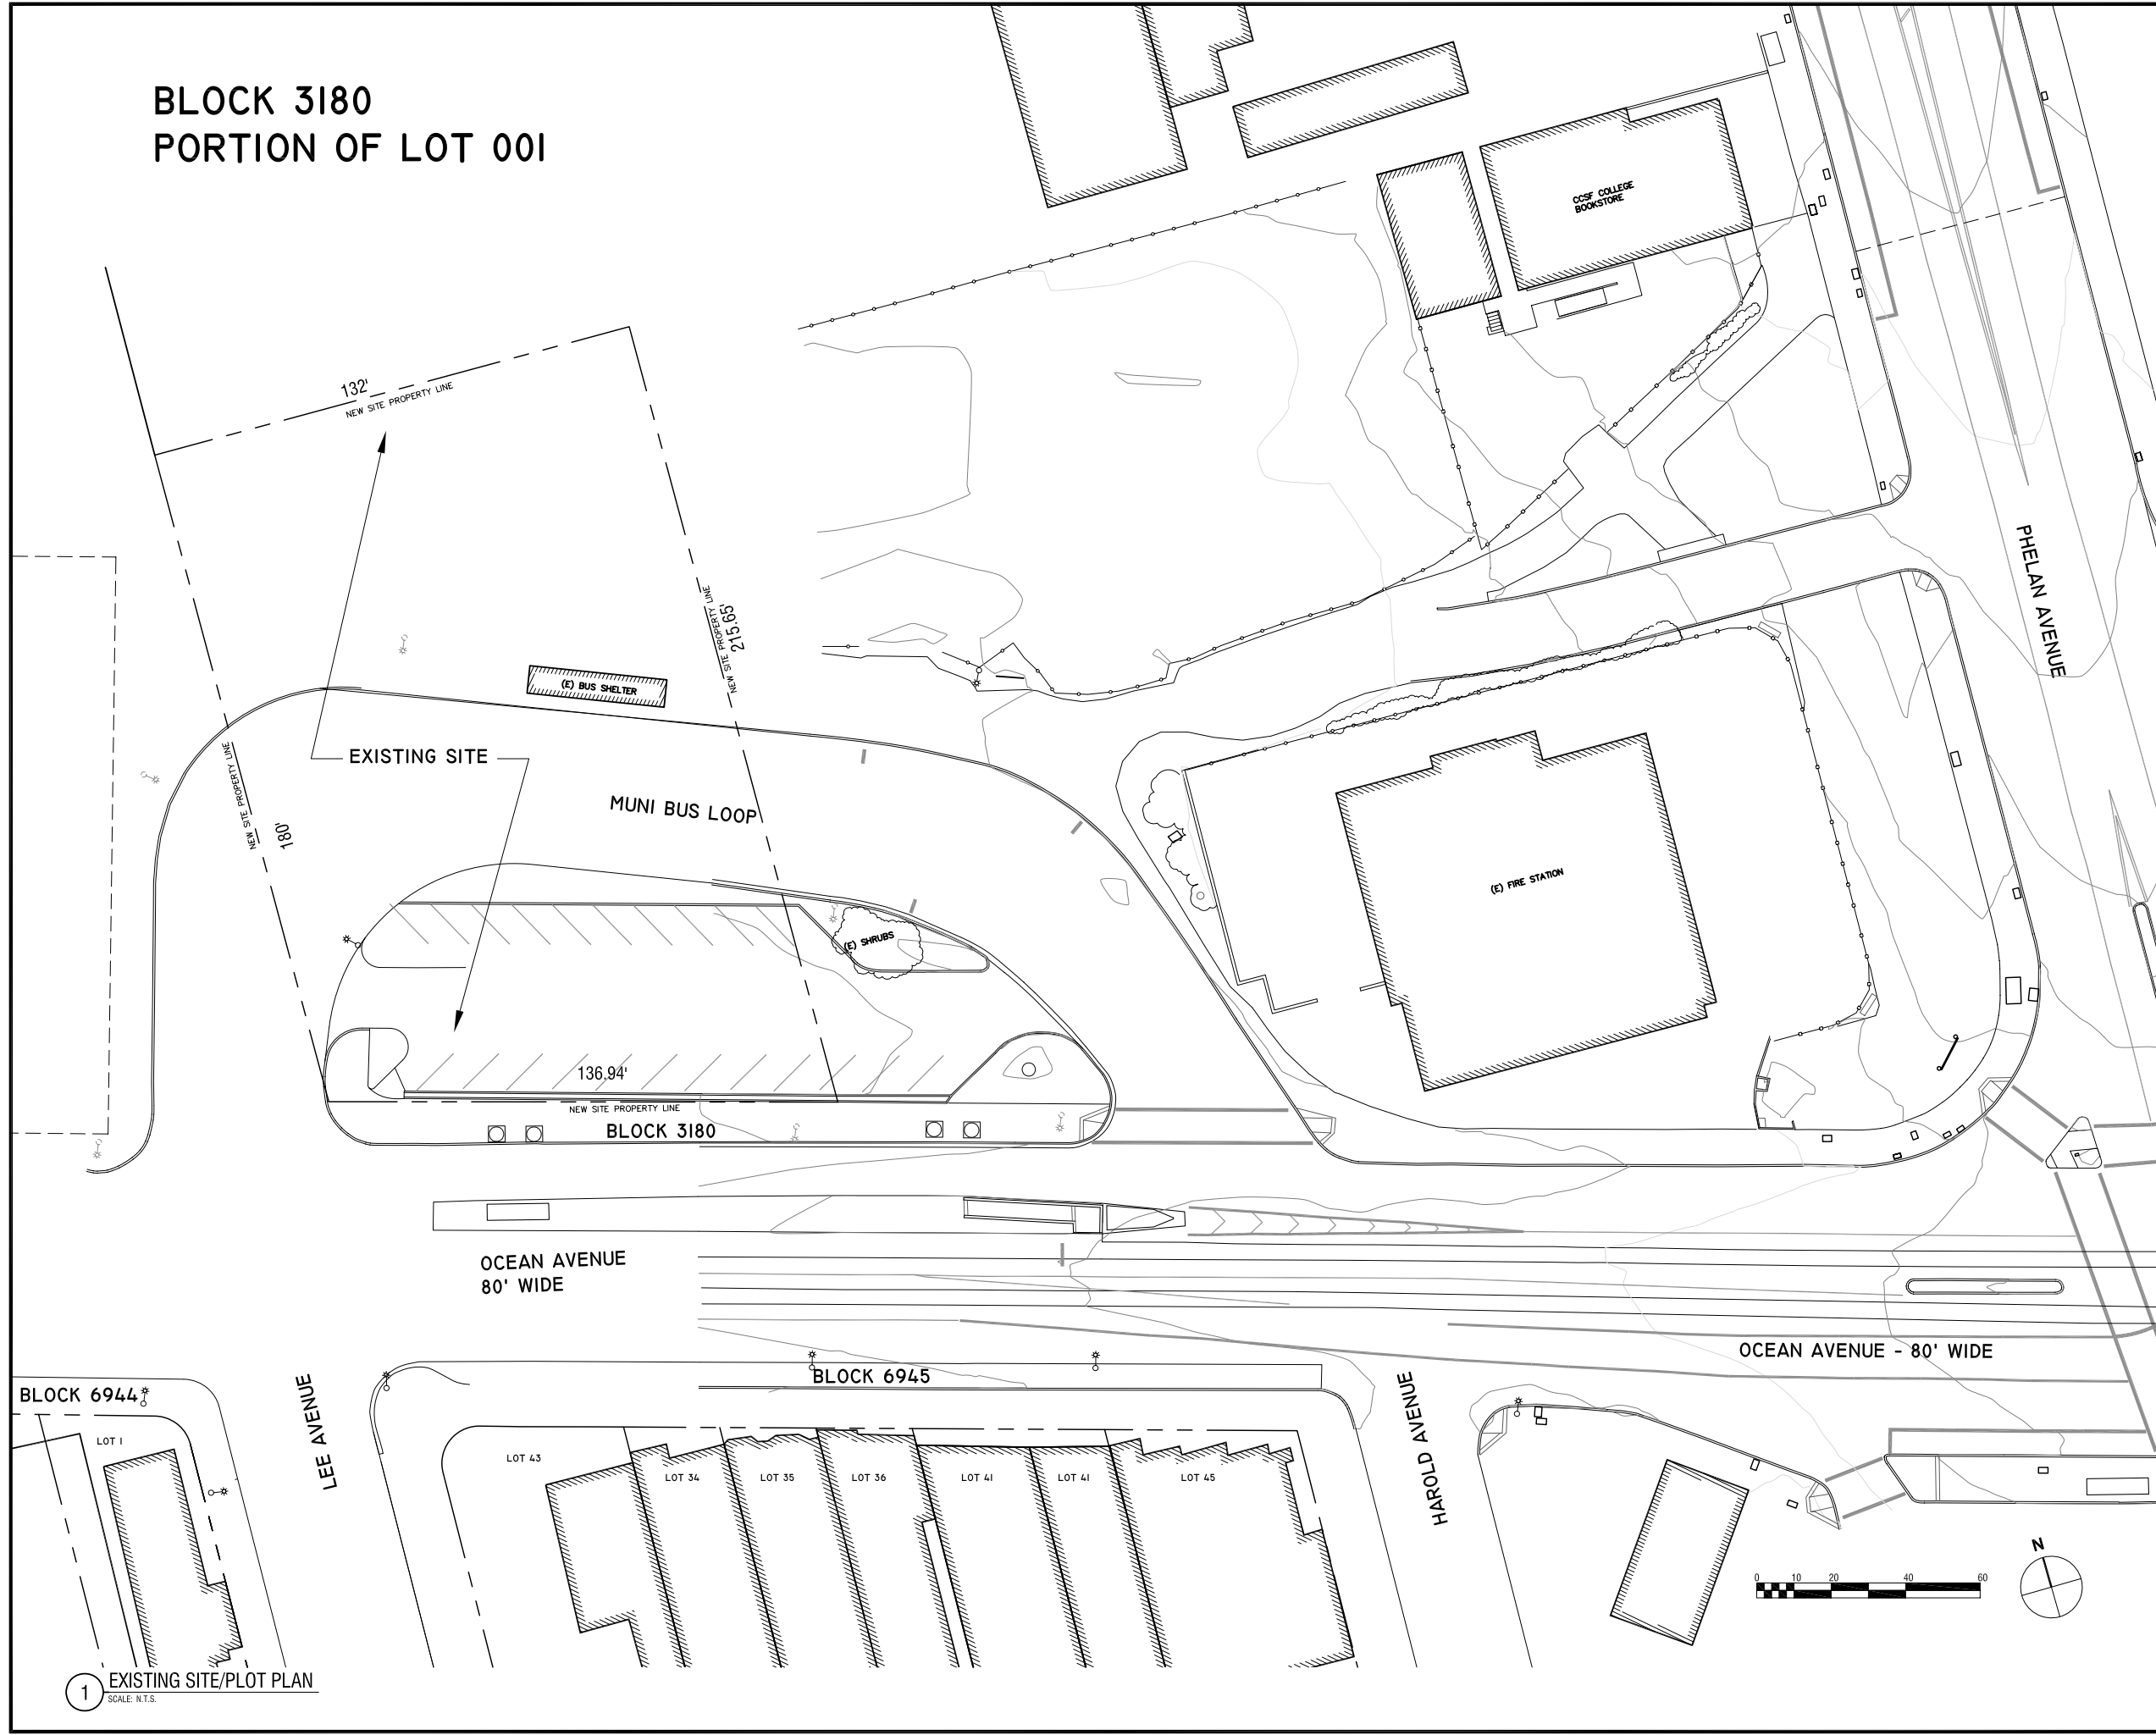

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**Key Plan:**

**General Notes/Legend:**

- EXISTING LIGHTPOST TO BE REMOVED/RELOCATED PER BSM
- EXISTING LIGHTPOST
- PROPERTY LINE
- (E) PALM TREE & PLANTER

**Consultant:**

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**PHELAN LOOP AFFORDABLE HOUSING**

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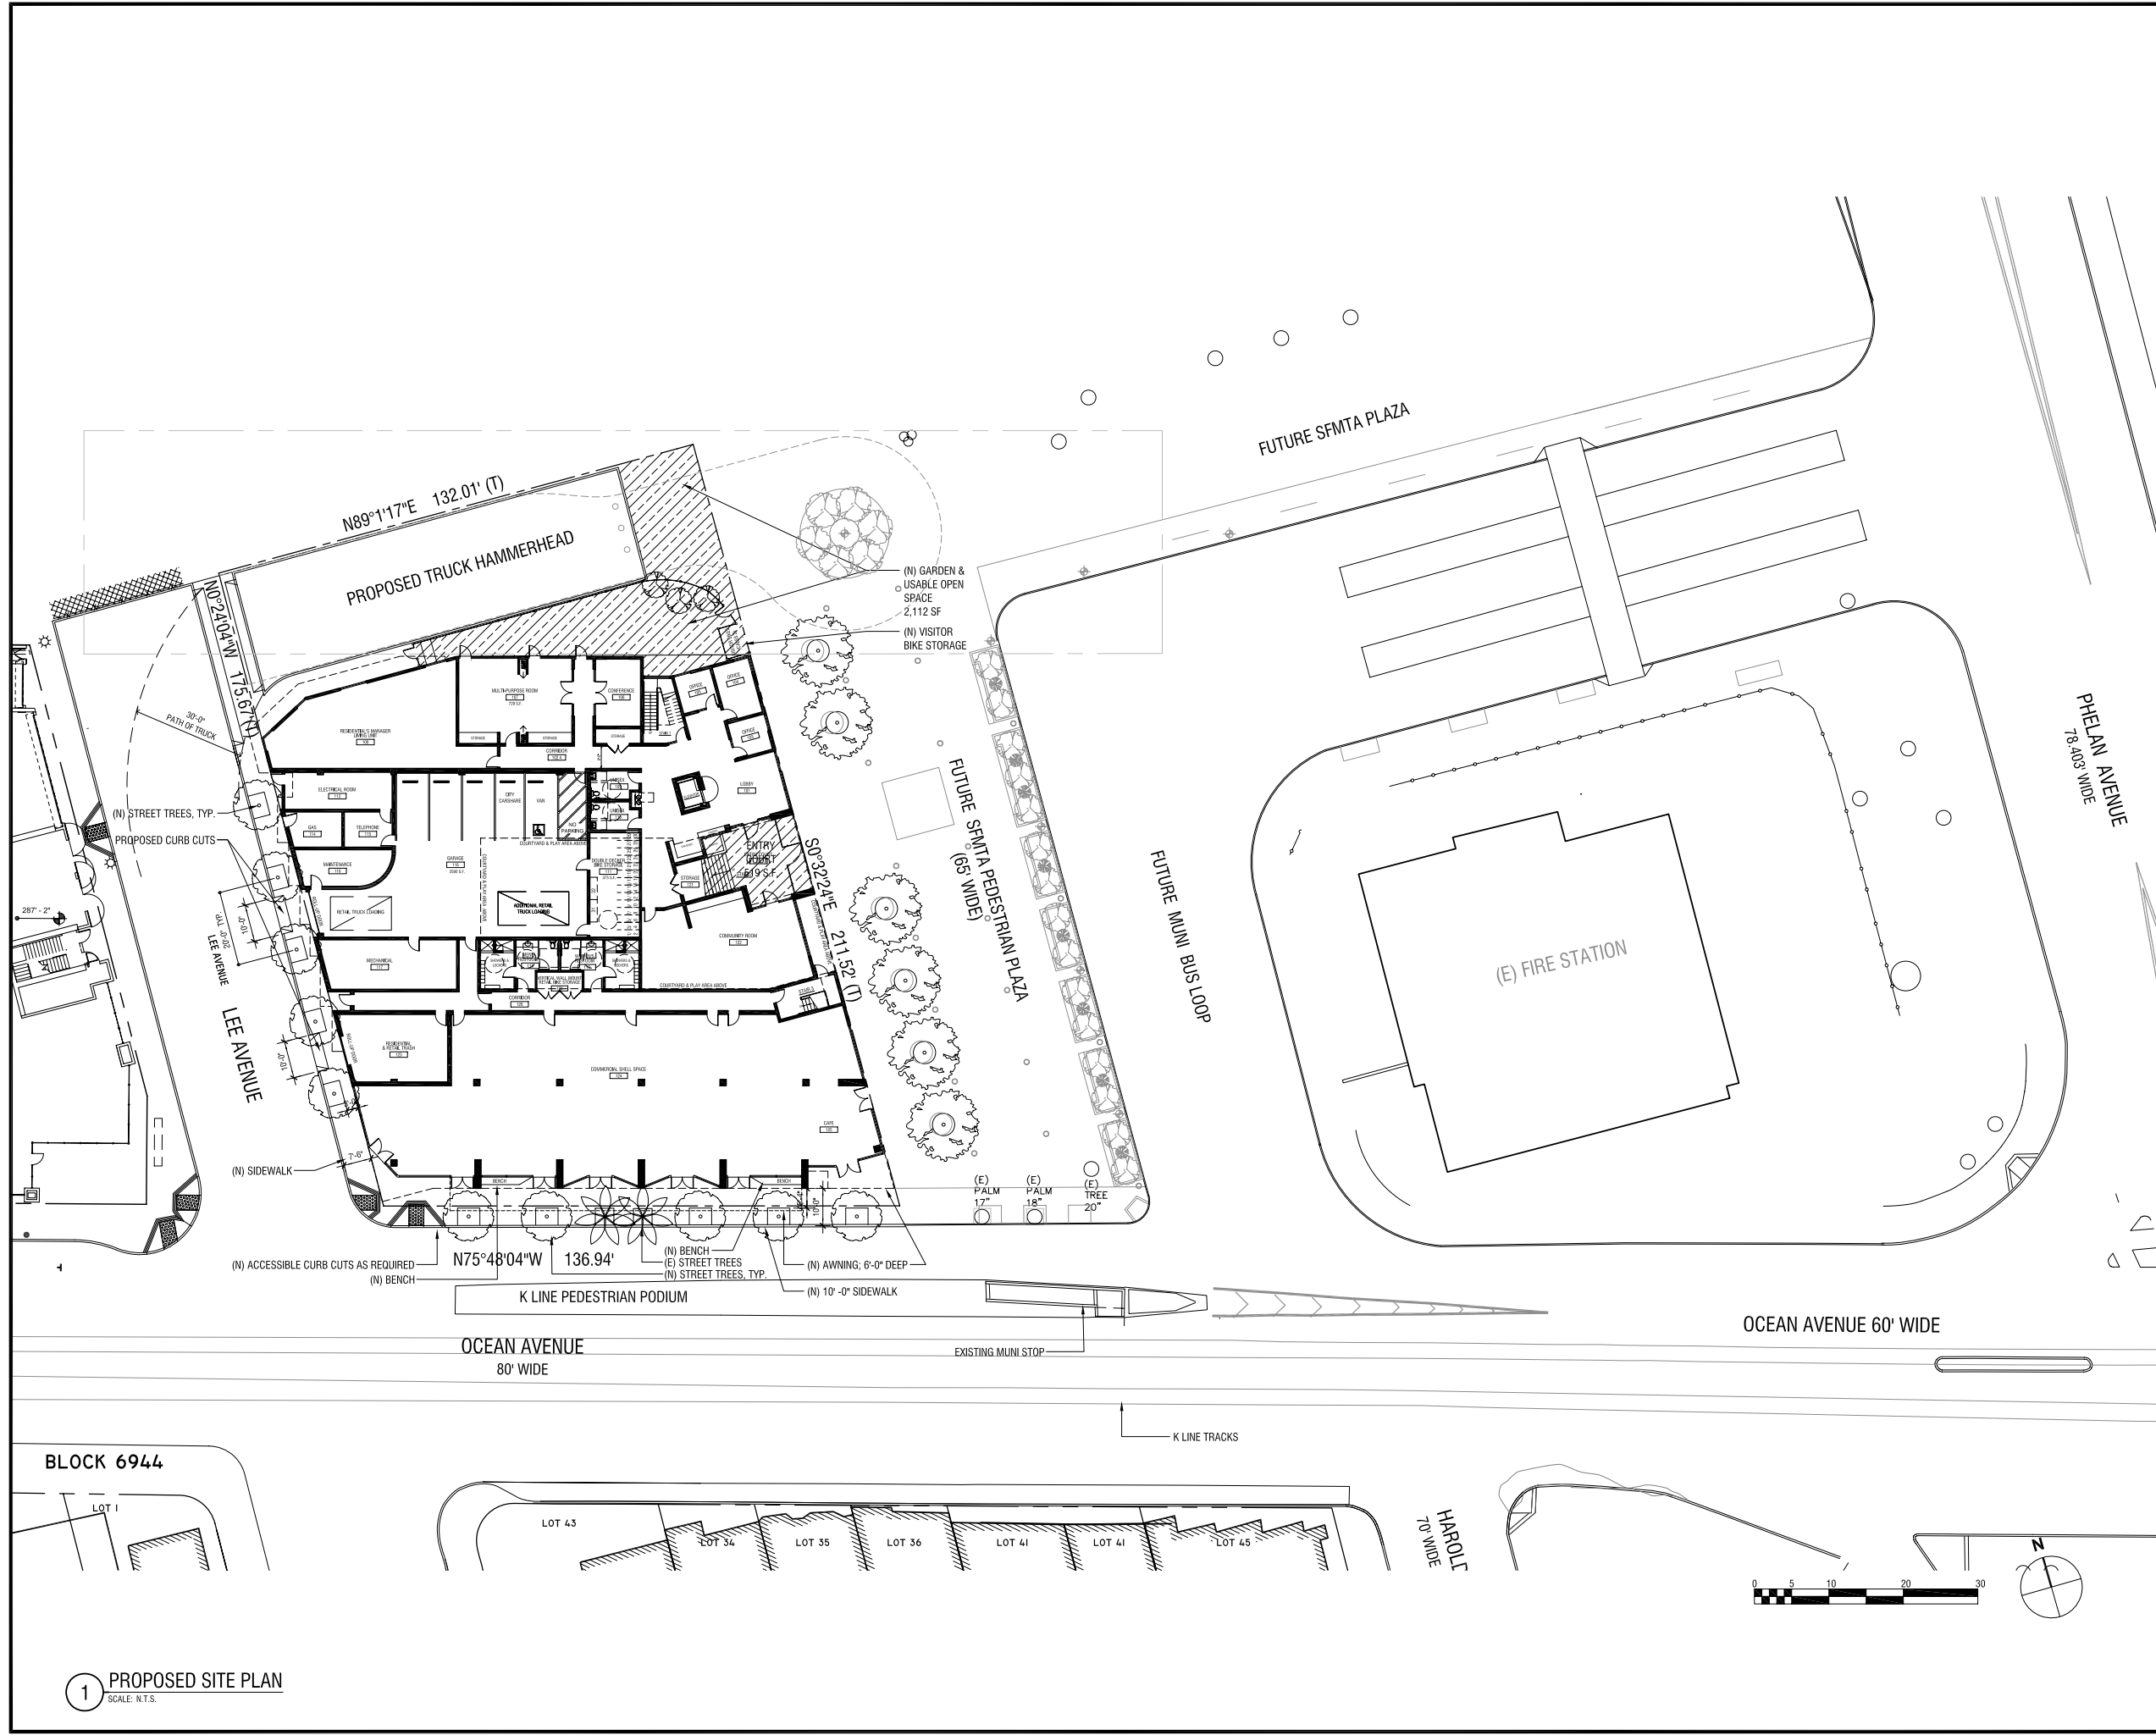
**Sheet Title:**  
**EXISTING SITE PLAN**

**Scale:**  
NOT TO SCALE

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**Drawn By:** SD **Sheet Number:**  
**Checked:** **Associate:** **A1.0**

**1** EXISTING SITE/PLOT PLAN  
SCALE: N.T.S.



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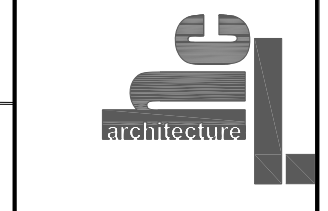
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**PHELAN LOOP AFFORDABLE HOUSING**  
 Ocean Avenue & Lee Avenue  
 San Francisco, CA 94112

Sheet Title:  
**PROPOSED SITE PLAN**


Scale:  
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Drawn By: SD Sheet Number:  
 Checked:  
 Associate: **A1.1**

**1 PROPOSED SITE PLAN**  
 SCALE: N.T.S.



**1** FIRST FLOOR PLAN  
SCALE: N.T.S.

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**Key Plan:**

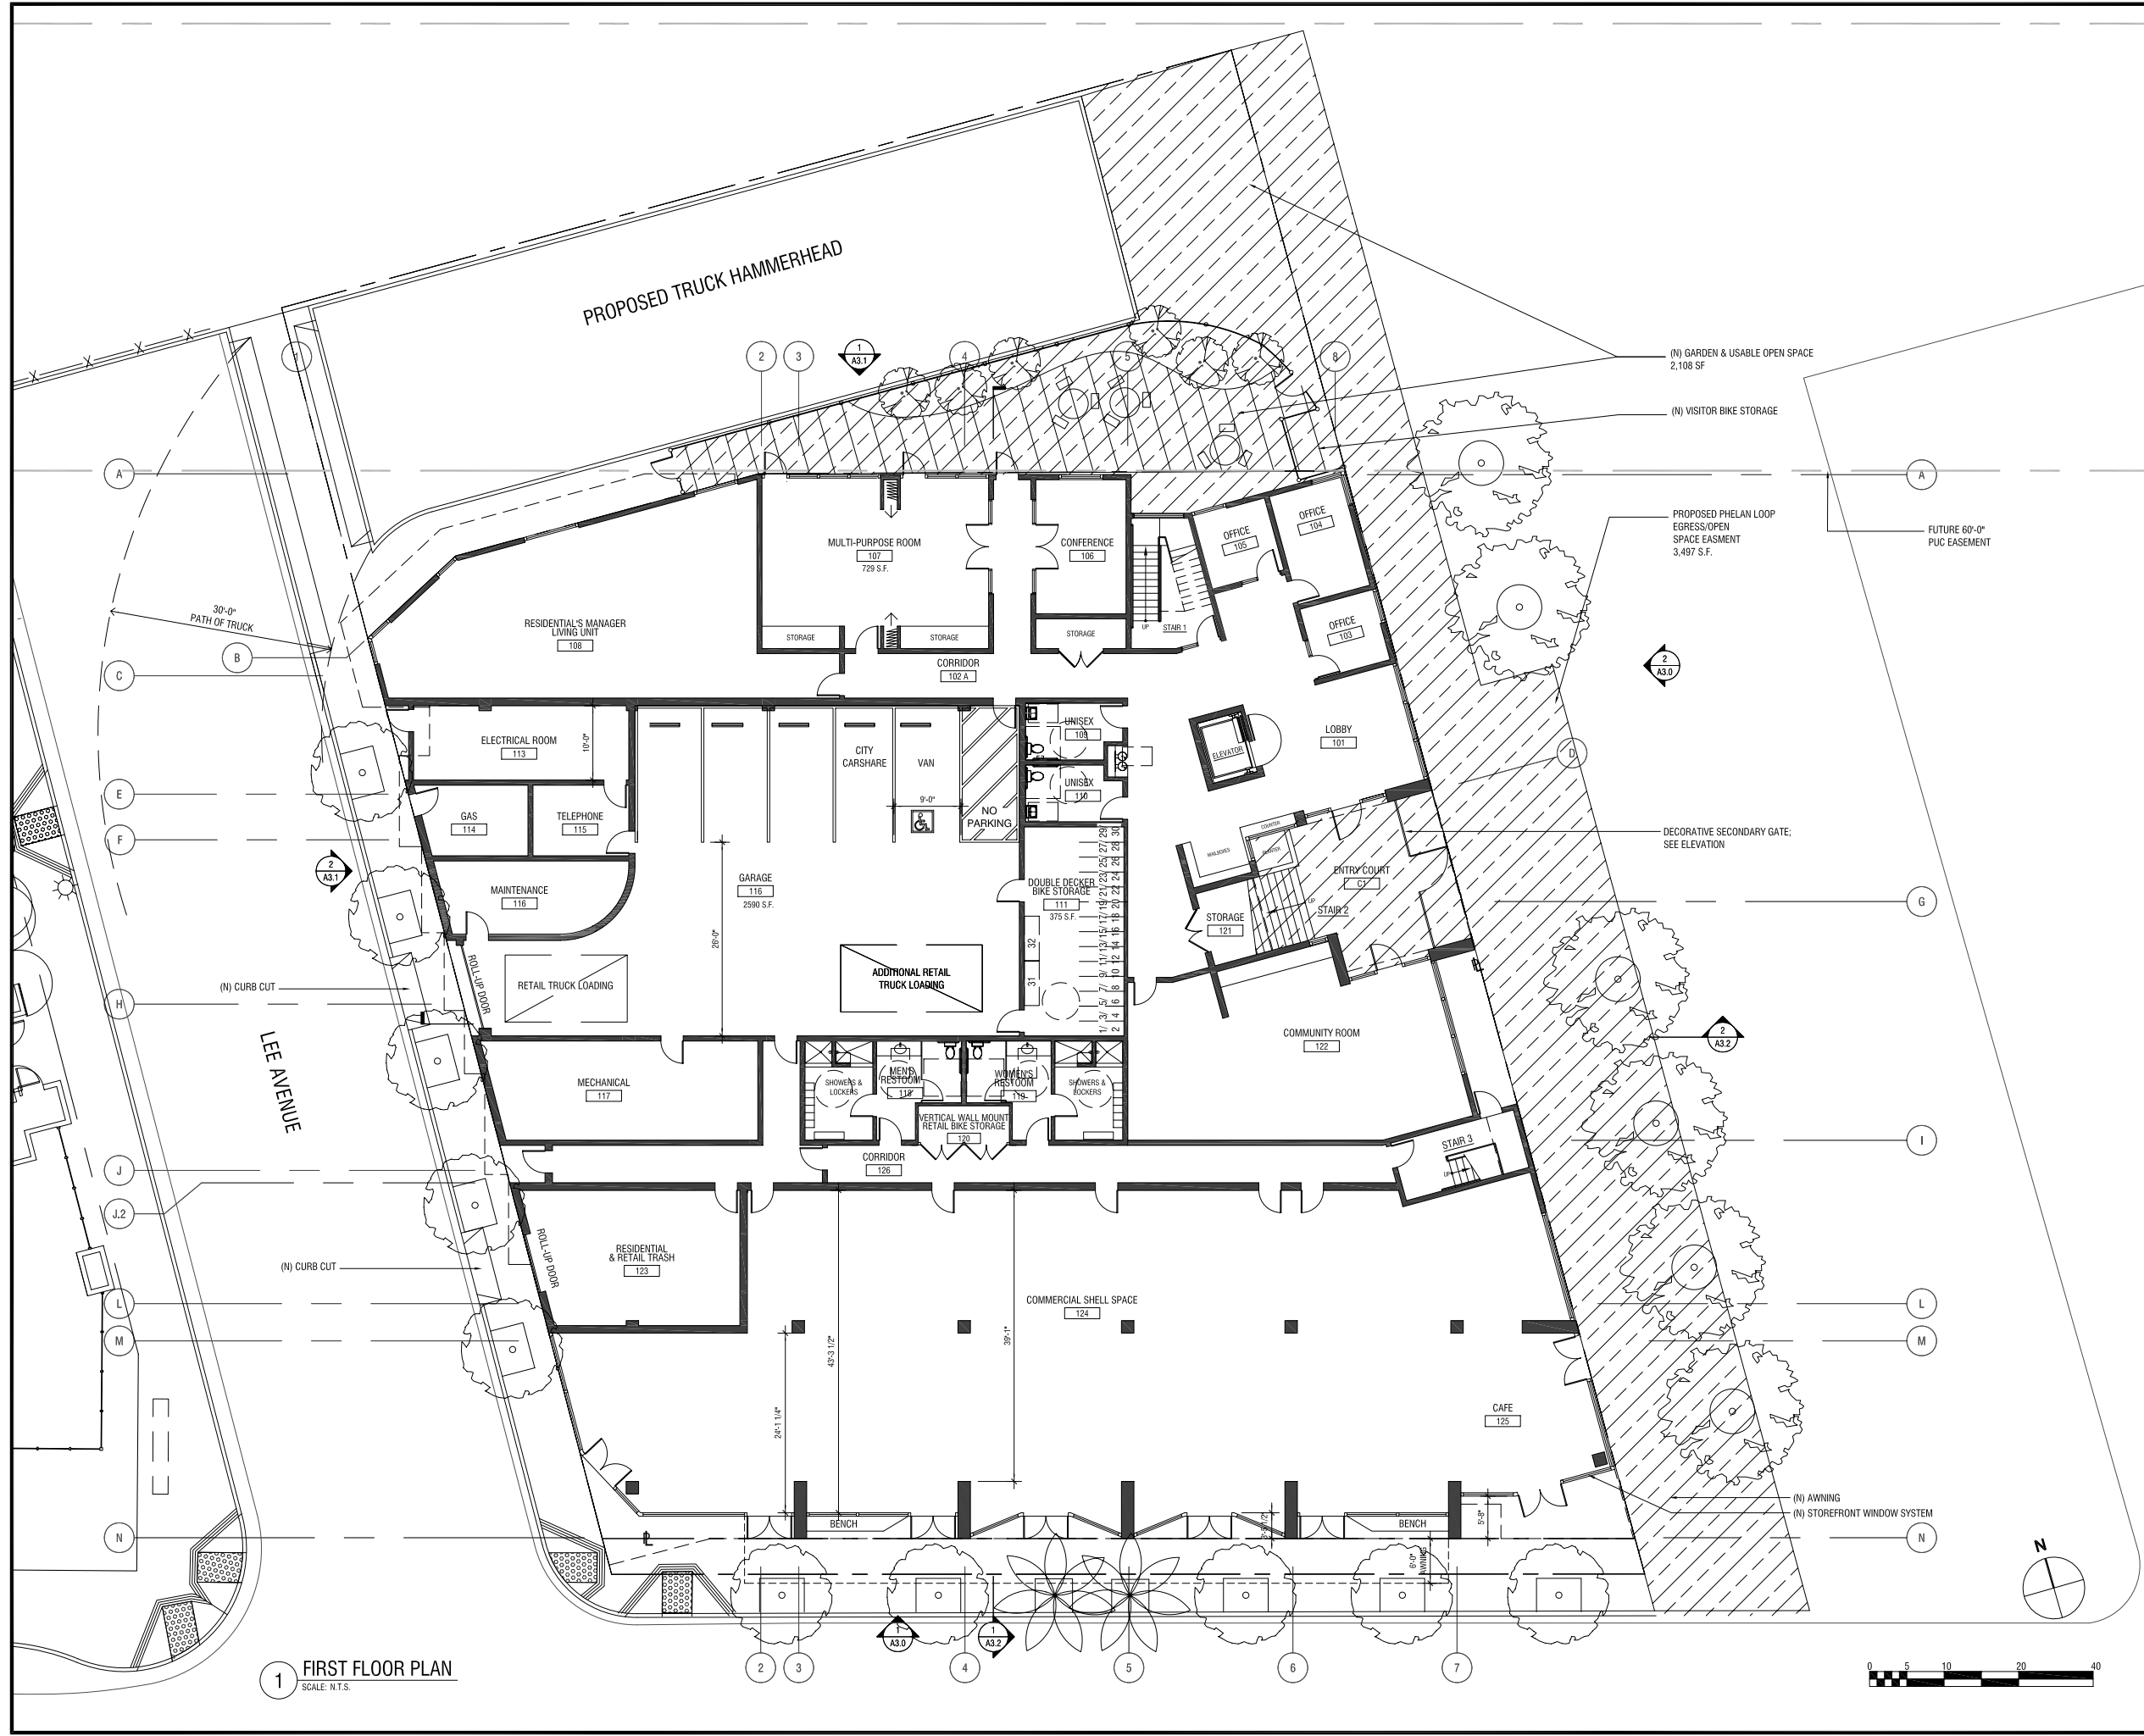**General Notes/Legend:**

- DOUBLE STRIPING OF STALLS SHALL BE PER FIG. 7 OF THE CITY OF LOS ANGELES BUILDING DEPARTMENT STANDARDS.
- BASEMENT FLOOR SLOPED TO DRAIN - SHALL NOT EXCEED A 2-PERCENT SLOPE IN ANY DIRECTION

**Consultant:**

**Stamp:**

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**Project Title:**  
**PHELAN LOOP AFFORDABLE HOUSING**

Ocean Avenue & Lee Avenue  
San Francisco, CA 94112

**Sheet Title:**  
FIRST FLOOR PLAN

**Scale:**  
NOT TO SCALE

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**Drawn By:** \_\_\_\_\_ **Sheet Number:** **A2.0**  
**Checked:** \_\_\_\_\_  
**Associate:** \_\_\_\_\_

Disclaimer:  
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Key Plan:

General Notes/Legend:

- DOUBLE STRIPING OF STALLS SHALL BE PER FIG. 7 OF THE CITY OF LOS ANGELES BUILDING DEPARTMENT STANDARDS.
- BASEMENT FLOOR SLOPED TO DRAIN - SHALL NOT EXCEED A 2-PERCENT SLOPE IN ANY DIRECTION

Consultant:

Stamp:


Rev. No.	Revision	Date
	Environmental Evaluation App.	12.04.09
	Conditional Use Application	12.14.09
	CUP/Preliminary Pricing Set	01.19.10
	CUP/Prelim. Pricing Rev. 1	06.15.10
	CUP/Prelim. Pricing Rev. 2	07.07.10
	Planning Commission Hearing	07.12.10

Project Title:  
**PHELAN LOOP AFFORDABLE HOUSING**

Ocean Avenue & Lee Avenue  
 San Francisco, CA 94112

Sheet Title:  
**SECOND FLOOR PLAN**

Scale:  
 NOT TO SCALE

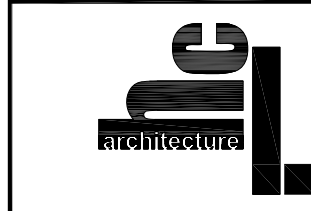


herman coliver locus  
 363 Clementia Street San Francisco California 94103  
 T 415.495.1776 F 415.952.9811 E info@hclarchitect.com

Drawn By: \_\_\_\_\_  
 Checked: \_\_\_\_\_  
 Associate: \_\_\_\_\_

Sheet Number:  
**A2.1**



**1 SECOND FLOOR PLAN**  
 SCALE: N.T.S.

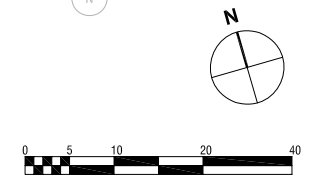

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Key Plan:

General Notes/Legend:

Consultant:

Stamp:


Rev. No.	Revision	Date
	Environmental Evaluation App.	12.04.09
	Conditional Use Application	12.14.09
	CUP/Preliminary Pricing Set	01.19.10
	CUP/Prelim. Pricing Rev. 1	06.15.10
	CUP/Prelim. Pricing Rev. 2	07.07.10
	Planning Commission Hearing	07.12.10

Project Title:  
**PHELAN LOOP AFFORDABLE HOUSING**

Ocean Avenue & Lee Avenue  
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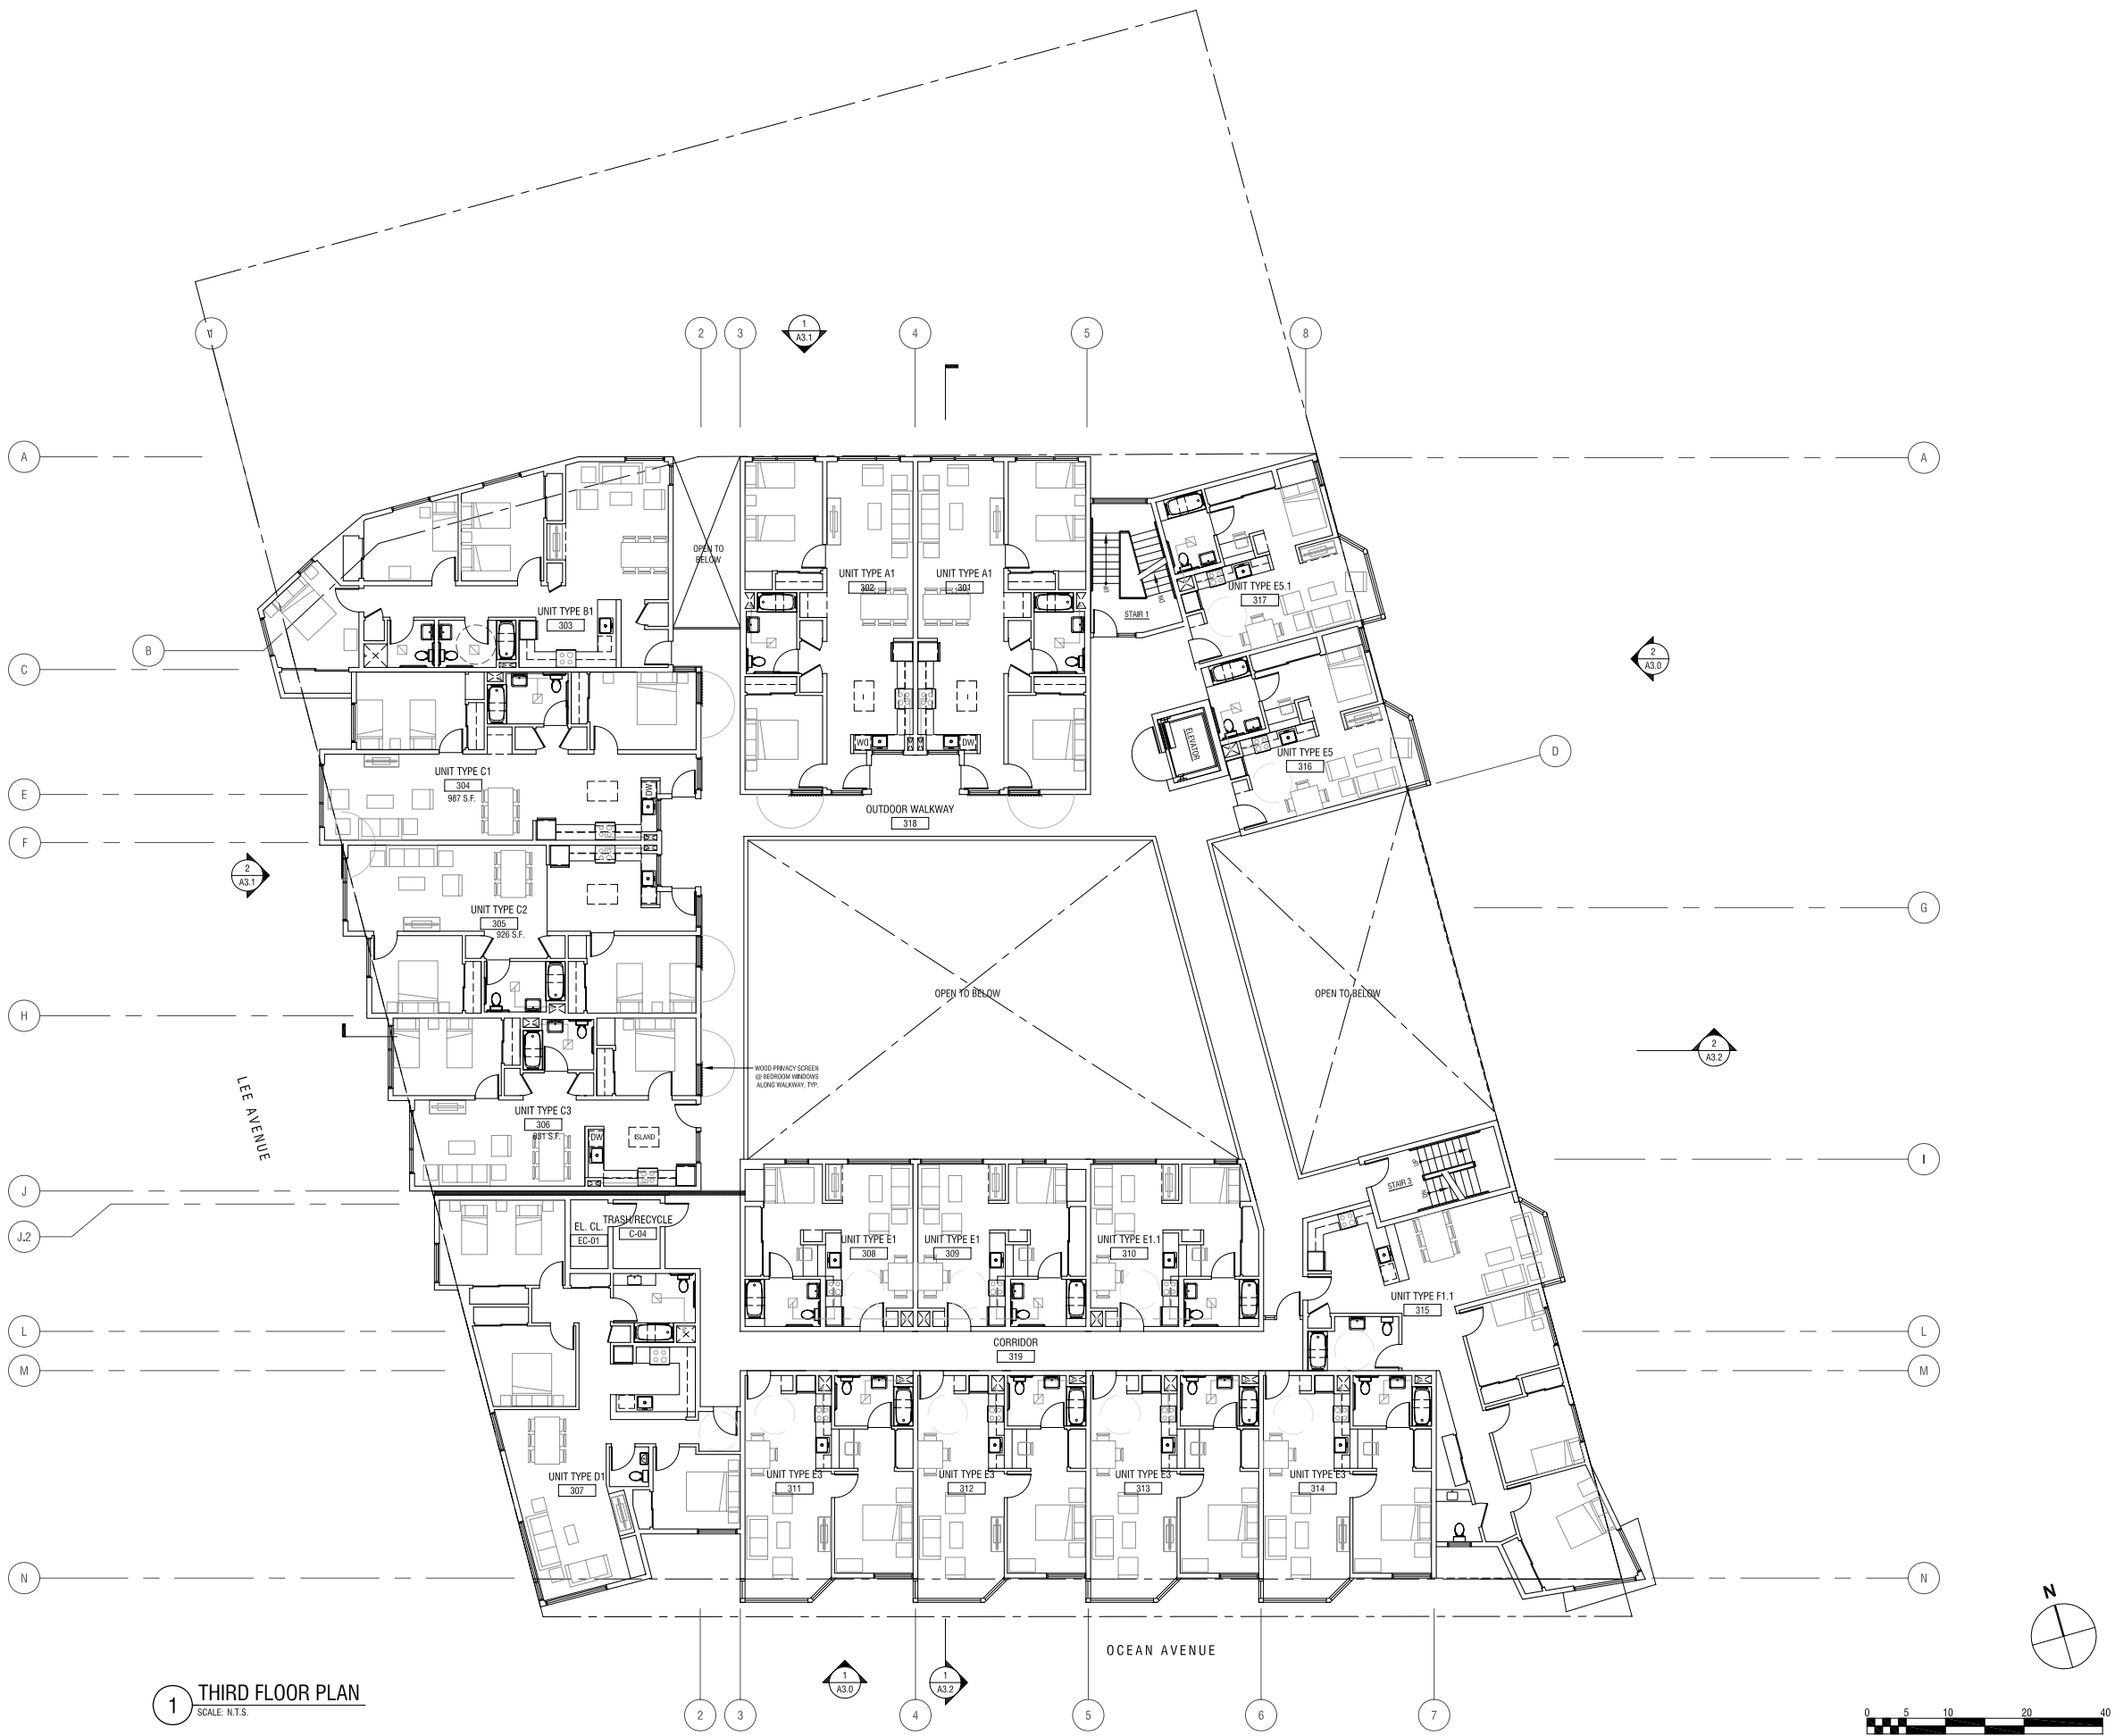
Sheet Title:  
**THIRD FLOOR PLAN**

Scale:  
 NOT TO SCALE

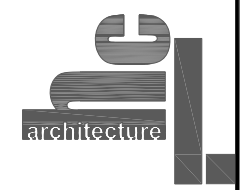

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Drawn By: JW Sheet Number:  
 Checked: Associate: **A2.2**



**1** THIRD FLOOR PLAN  
 SCALE: N.T.S.

Disclaimer:  
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Key Plan:  
 General Notes/Legend:


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Stamp:

Rev. No.	Revision	Date
Environmental Evaluation App.	12.04.09	
Conditional Use Application	12.14.09	
CUP/Preliminary Pricing Set	01.19.10	
CUP/Prelim. Pricing Rev. 1	06.15.10	
CUP/Prelim. Pricing Rev. 2	07.07.10	
Planning Commission Hearing	07.12.10	


Project Title:  
**PHELAN LOOP AFFORDABLE HOUSING**  
 Ocean Avenue & Lee Avenue  
 San Francisco, CA 94112

Sheet Title:  
**FOURTH FLOOR PLAN**  
 Scale:  
 NOT TO SCALE

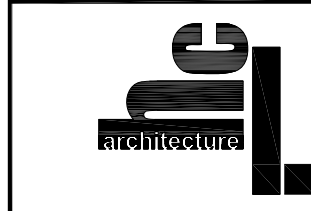


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Drawn By: JW Sheet Number:  
 Checked: Associate:  
**A2.3**

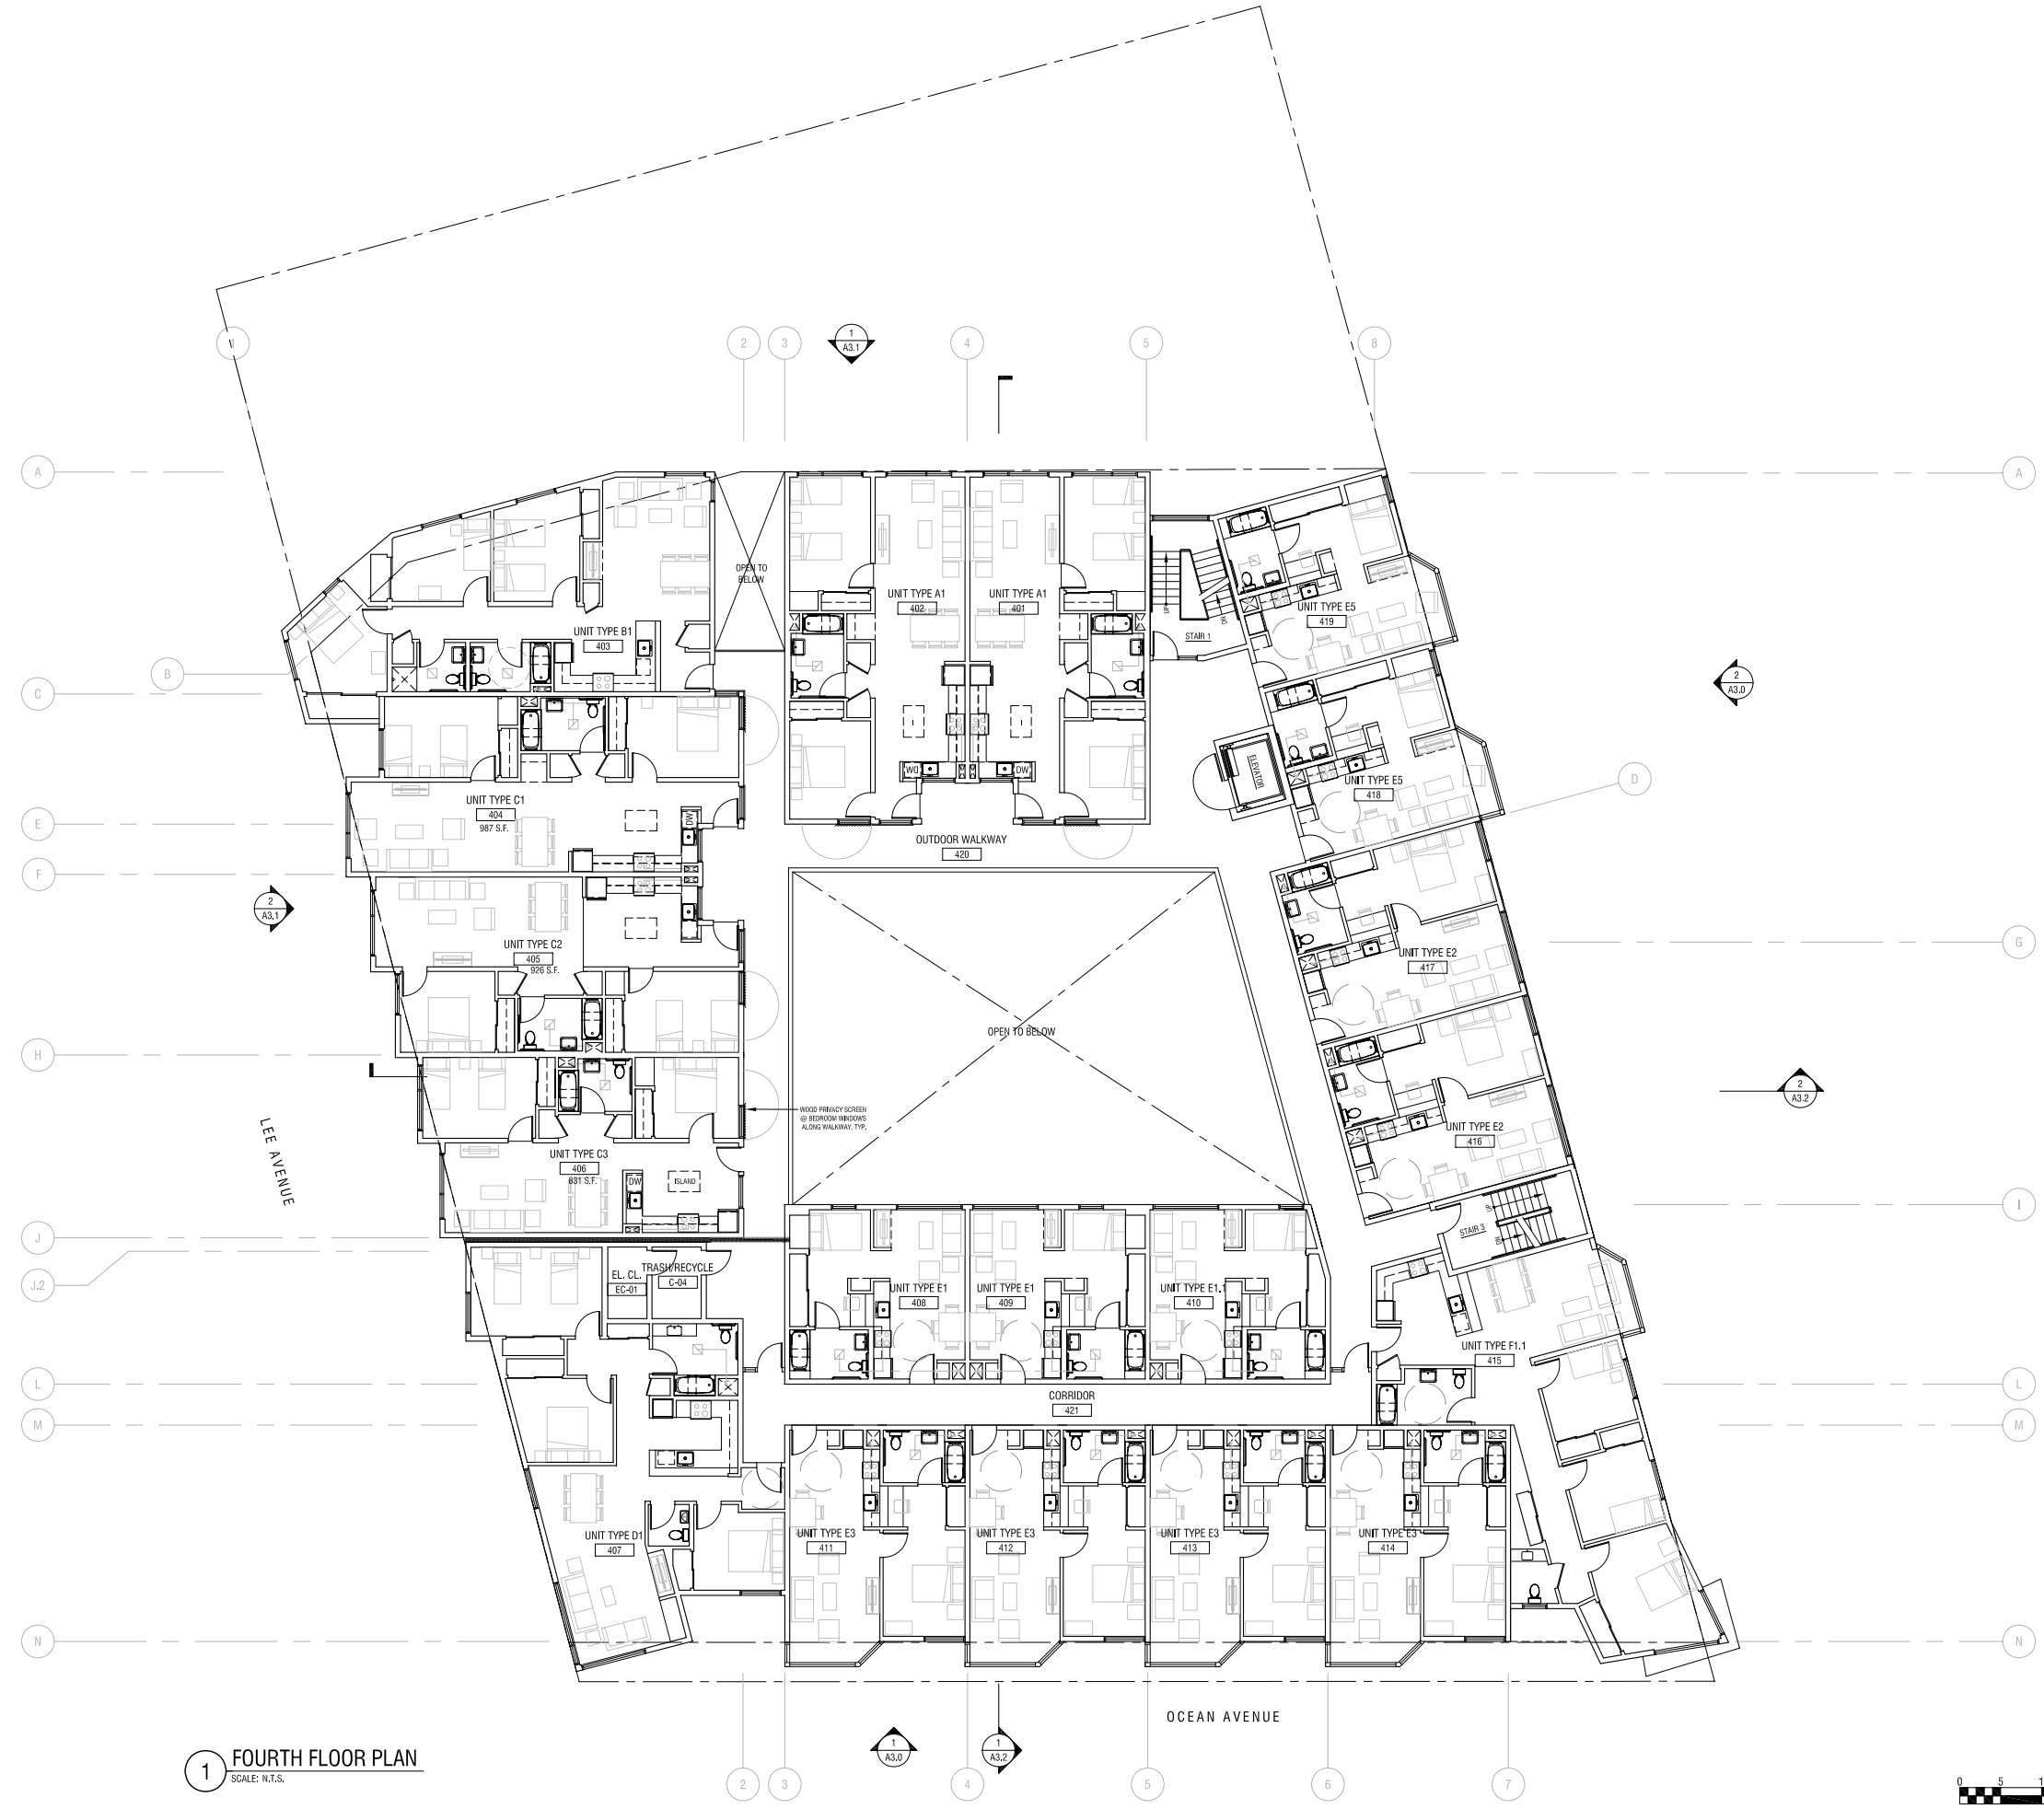

**1** FOURTH FLOOR PLAN  
 SCALE: N.T.S.

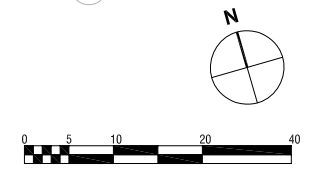

Disclaimer:  
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Key Plan:  
 General Notes/Legend:


Consultant:

Stamp:

Rev. No.	Revision	Date
1	Environmental Evaluation App.	12.04.09
2	Conditional Use Application	12.14.09
3	CUP/Preliminary Pricing Set	01.19.10
4	CUP/Prelim. Pricing Rev. 1	06.15.10
5	CUP/Prelim. Pricing Rev. 2	07.07.10
6	Planning Commission Hearing	07.12.10


Project Title:  
**PHELAN LOOP AFFORDABLE HOUSING**  
 Ocean Avenue & Lee Avenue  
 San Francisco, CA 94112

Sheet Title:  
**FIFTH FLOOR PLAN**  
 Scale:  
 NOT TO SCALE

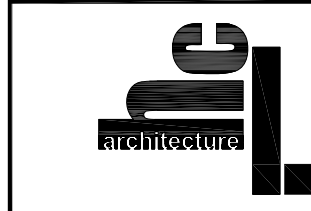

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Drawn By: JW Sheet Number:  
 Checked: Associate: **A2.4**

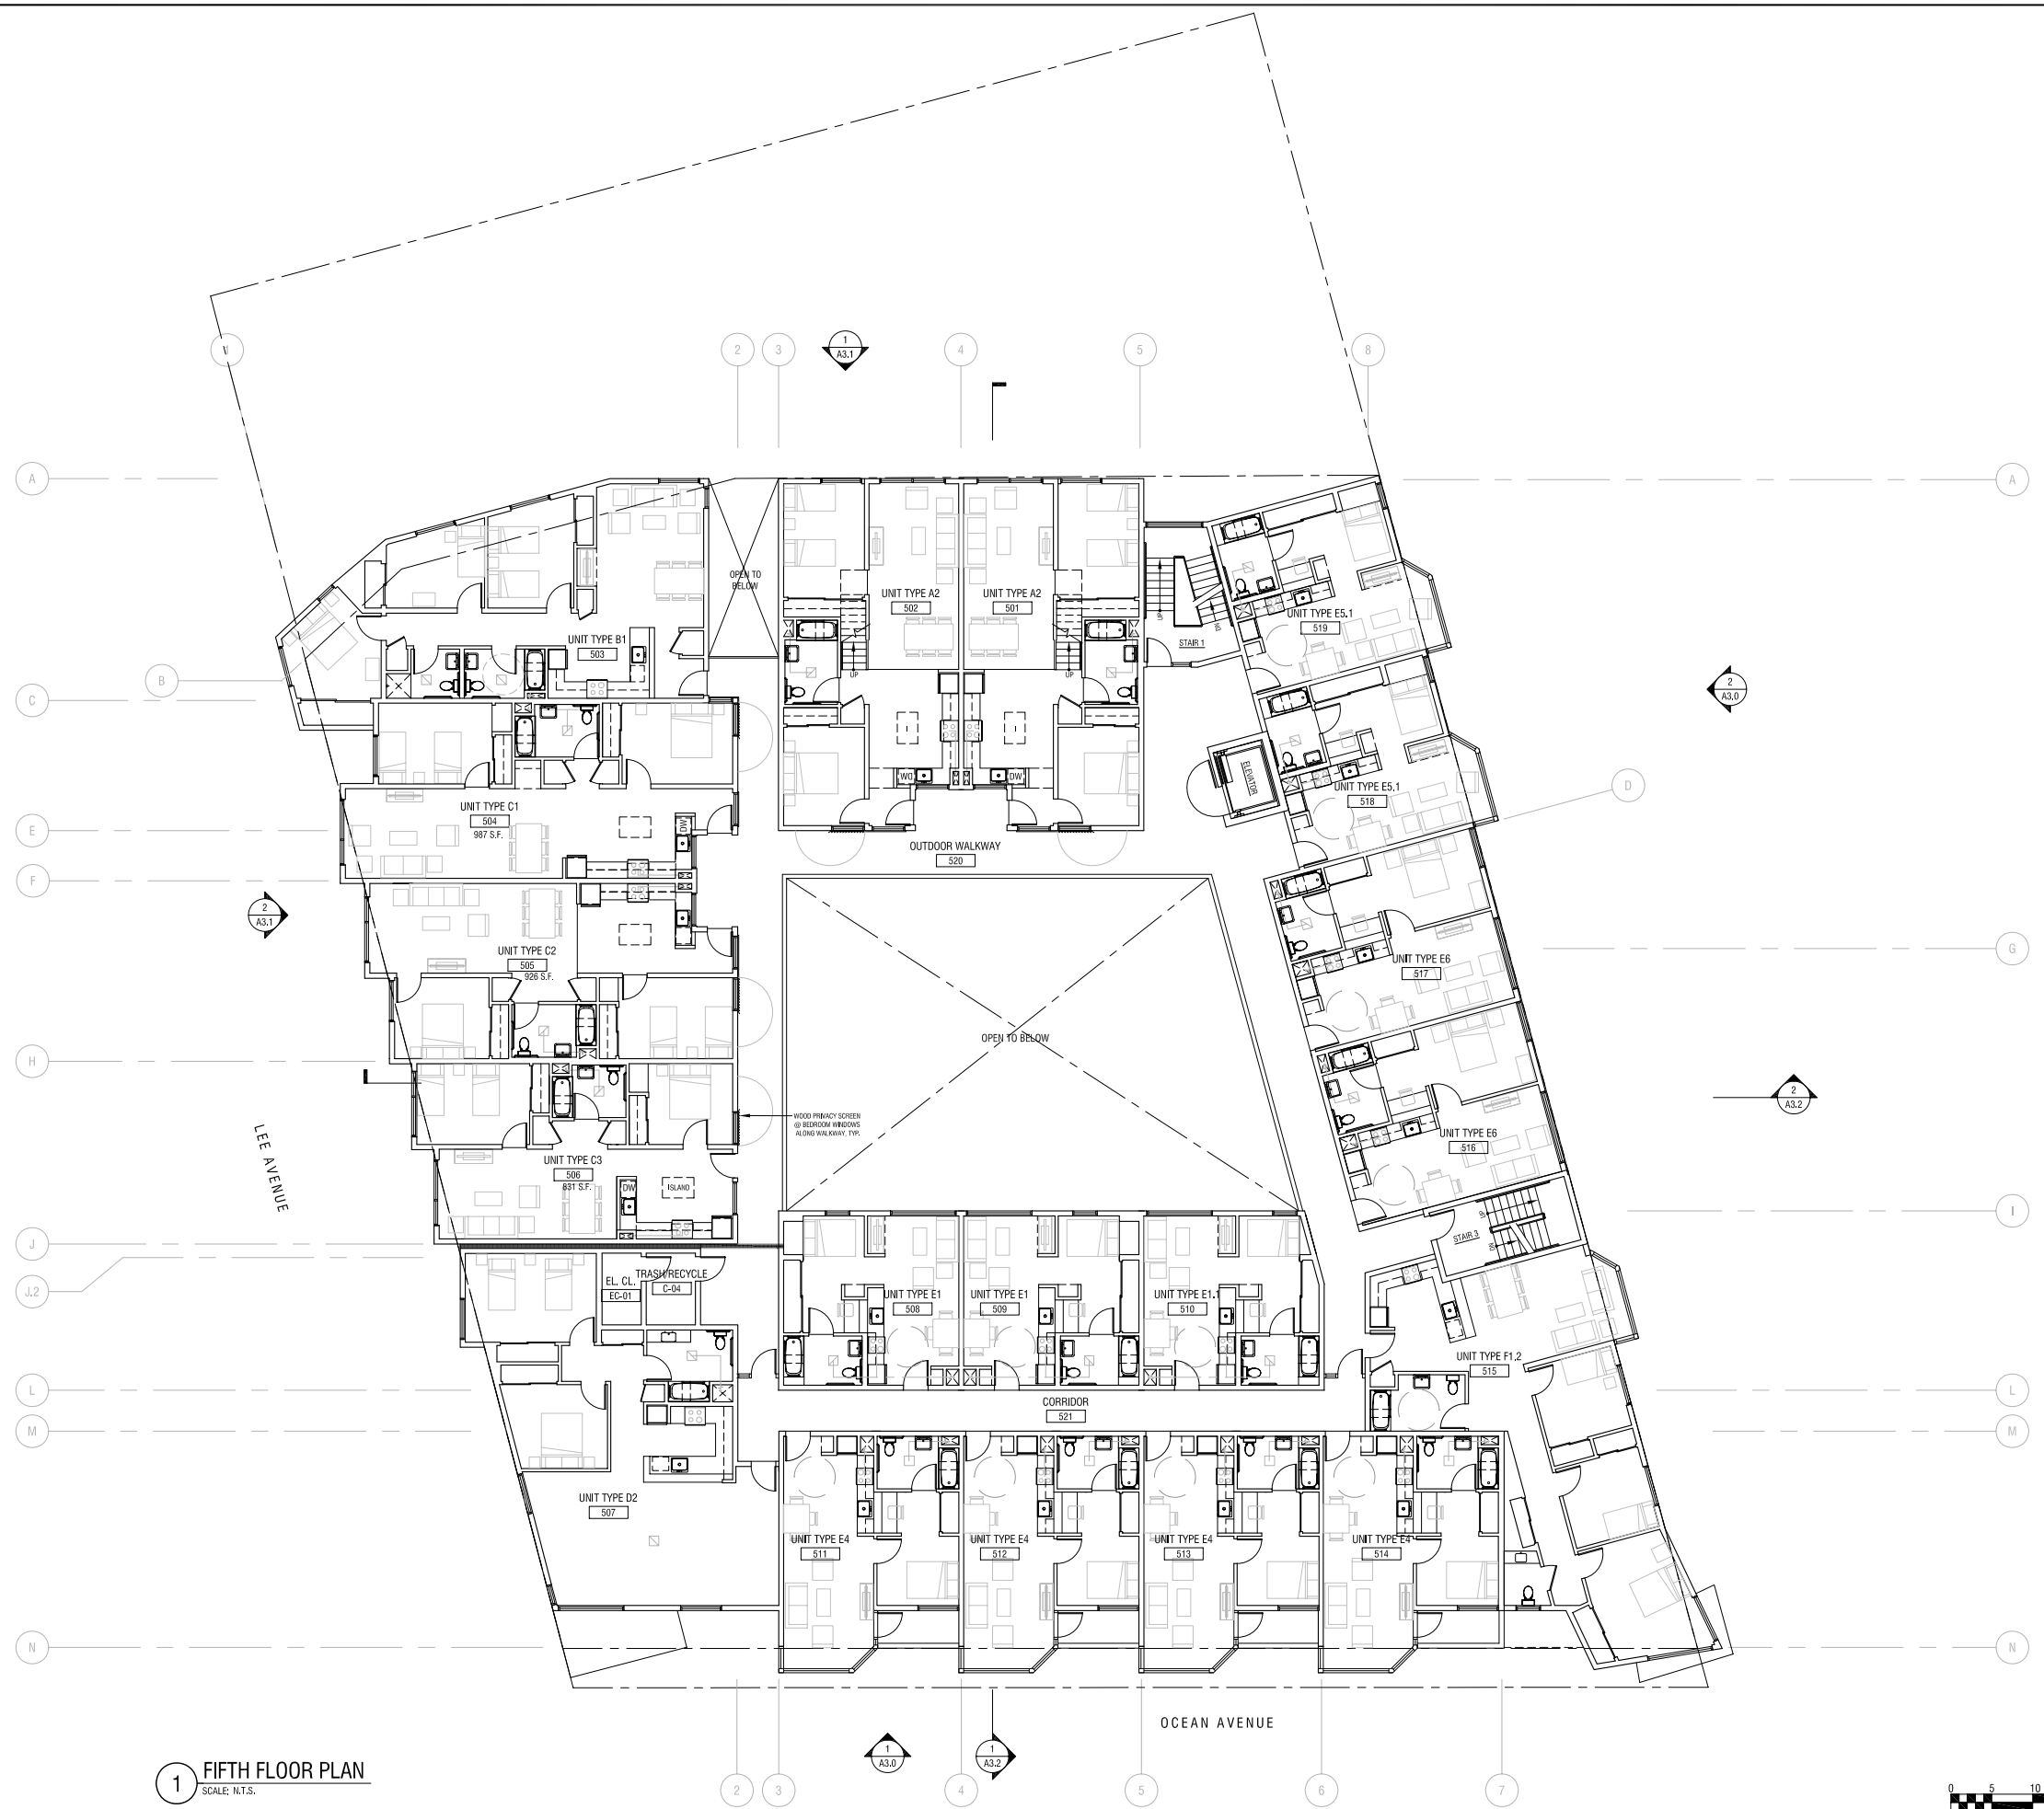

**1 FIFTH FLOOR PLAN**  
 SCALE: N.T.S.

Disclaimer:  
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Key Plan:  
 General Notes/Legend:

Consultant:


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Rev. No.	Revision	Date
	Environmental Evaluation App.	12.04.09
	Conditional Use Application	12.14.09
	CUP/Preliminary Pricing Set	01.19.10
	CUP/Prelim. Pricing Rev. 1	06.15.10
	CUP/Prelim. Pricing Rev. 2	07.07.10
	Planning Commission Hearing	07.12.10

Project Title:  
**PHELAN LOOP AFFORDABLE HOUSING**  
 Ocean Avenue & Lee Avenue  
 San Francisco, CA 94112


Sheet Title:  
**FIFTH FLOOR MEZZANINE PLAN**

Scale:  
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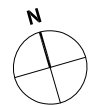


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Drawn By: JW Sheet Number:  
 Checked: Associate:  
**A2.5**

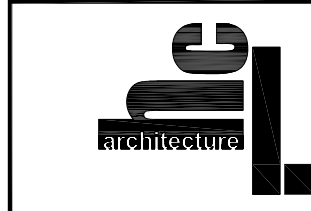

**1 FIFTH FLOOR MEZZANINE PLAN**  
 SCALE: N.T.S.

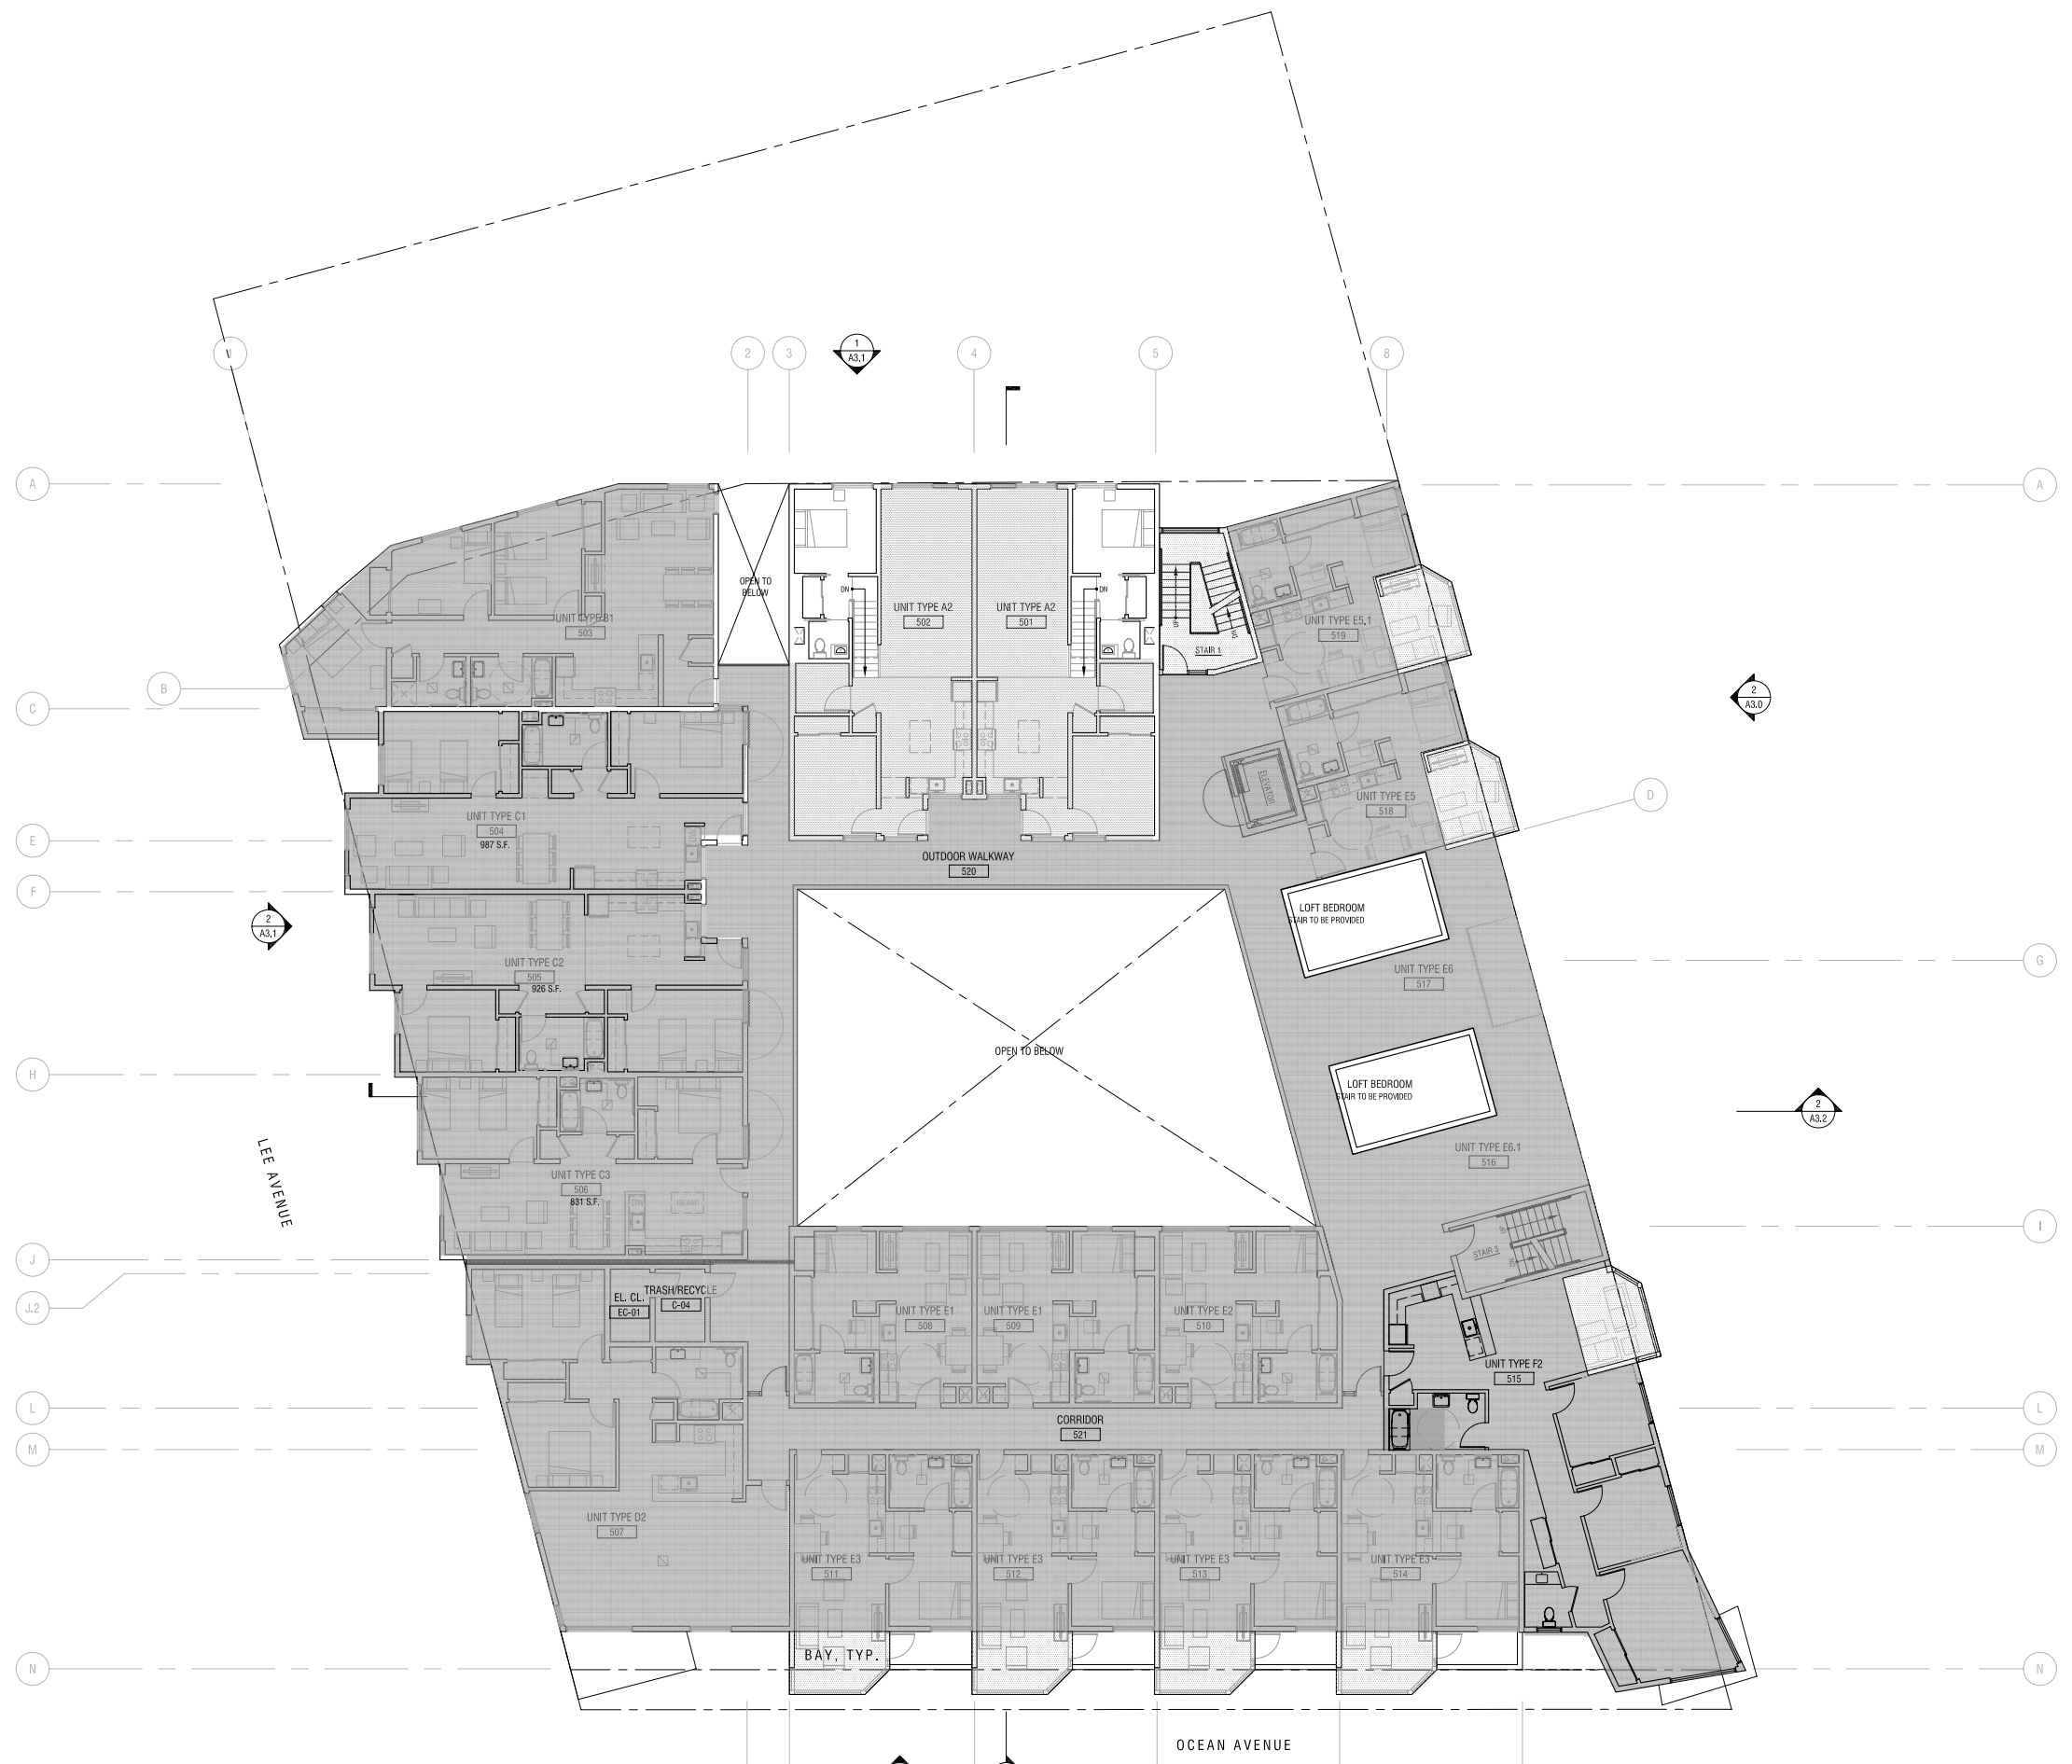



Disclaimer:  
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Key Plan:

General Notes/Legend:

Consultant:

Stamp:


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1	Environmental Evaluation App.	12.04.09
2	Conditional Use Application	12.14.09
3	CUP/Preliminary Pricing Set	01.19.10
4	CUP/Prelim. Pricing Rev. 1	06.15.10
5	CUP/Prelim. Pricing Rev. 2	07.07.10
6	Planning Commission Hearing	07.12.10

Project Title:  
**PHELAN LOOP AFFORDABLE HOUSING**

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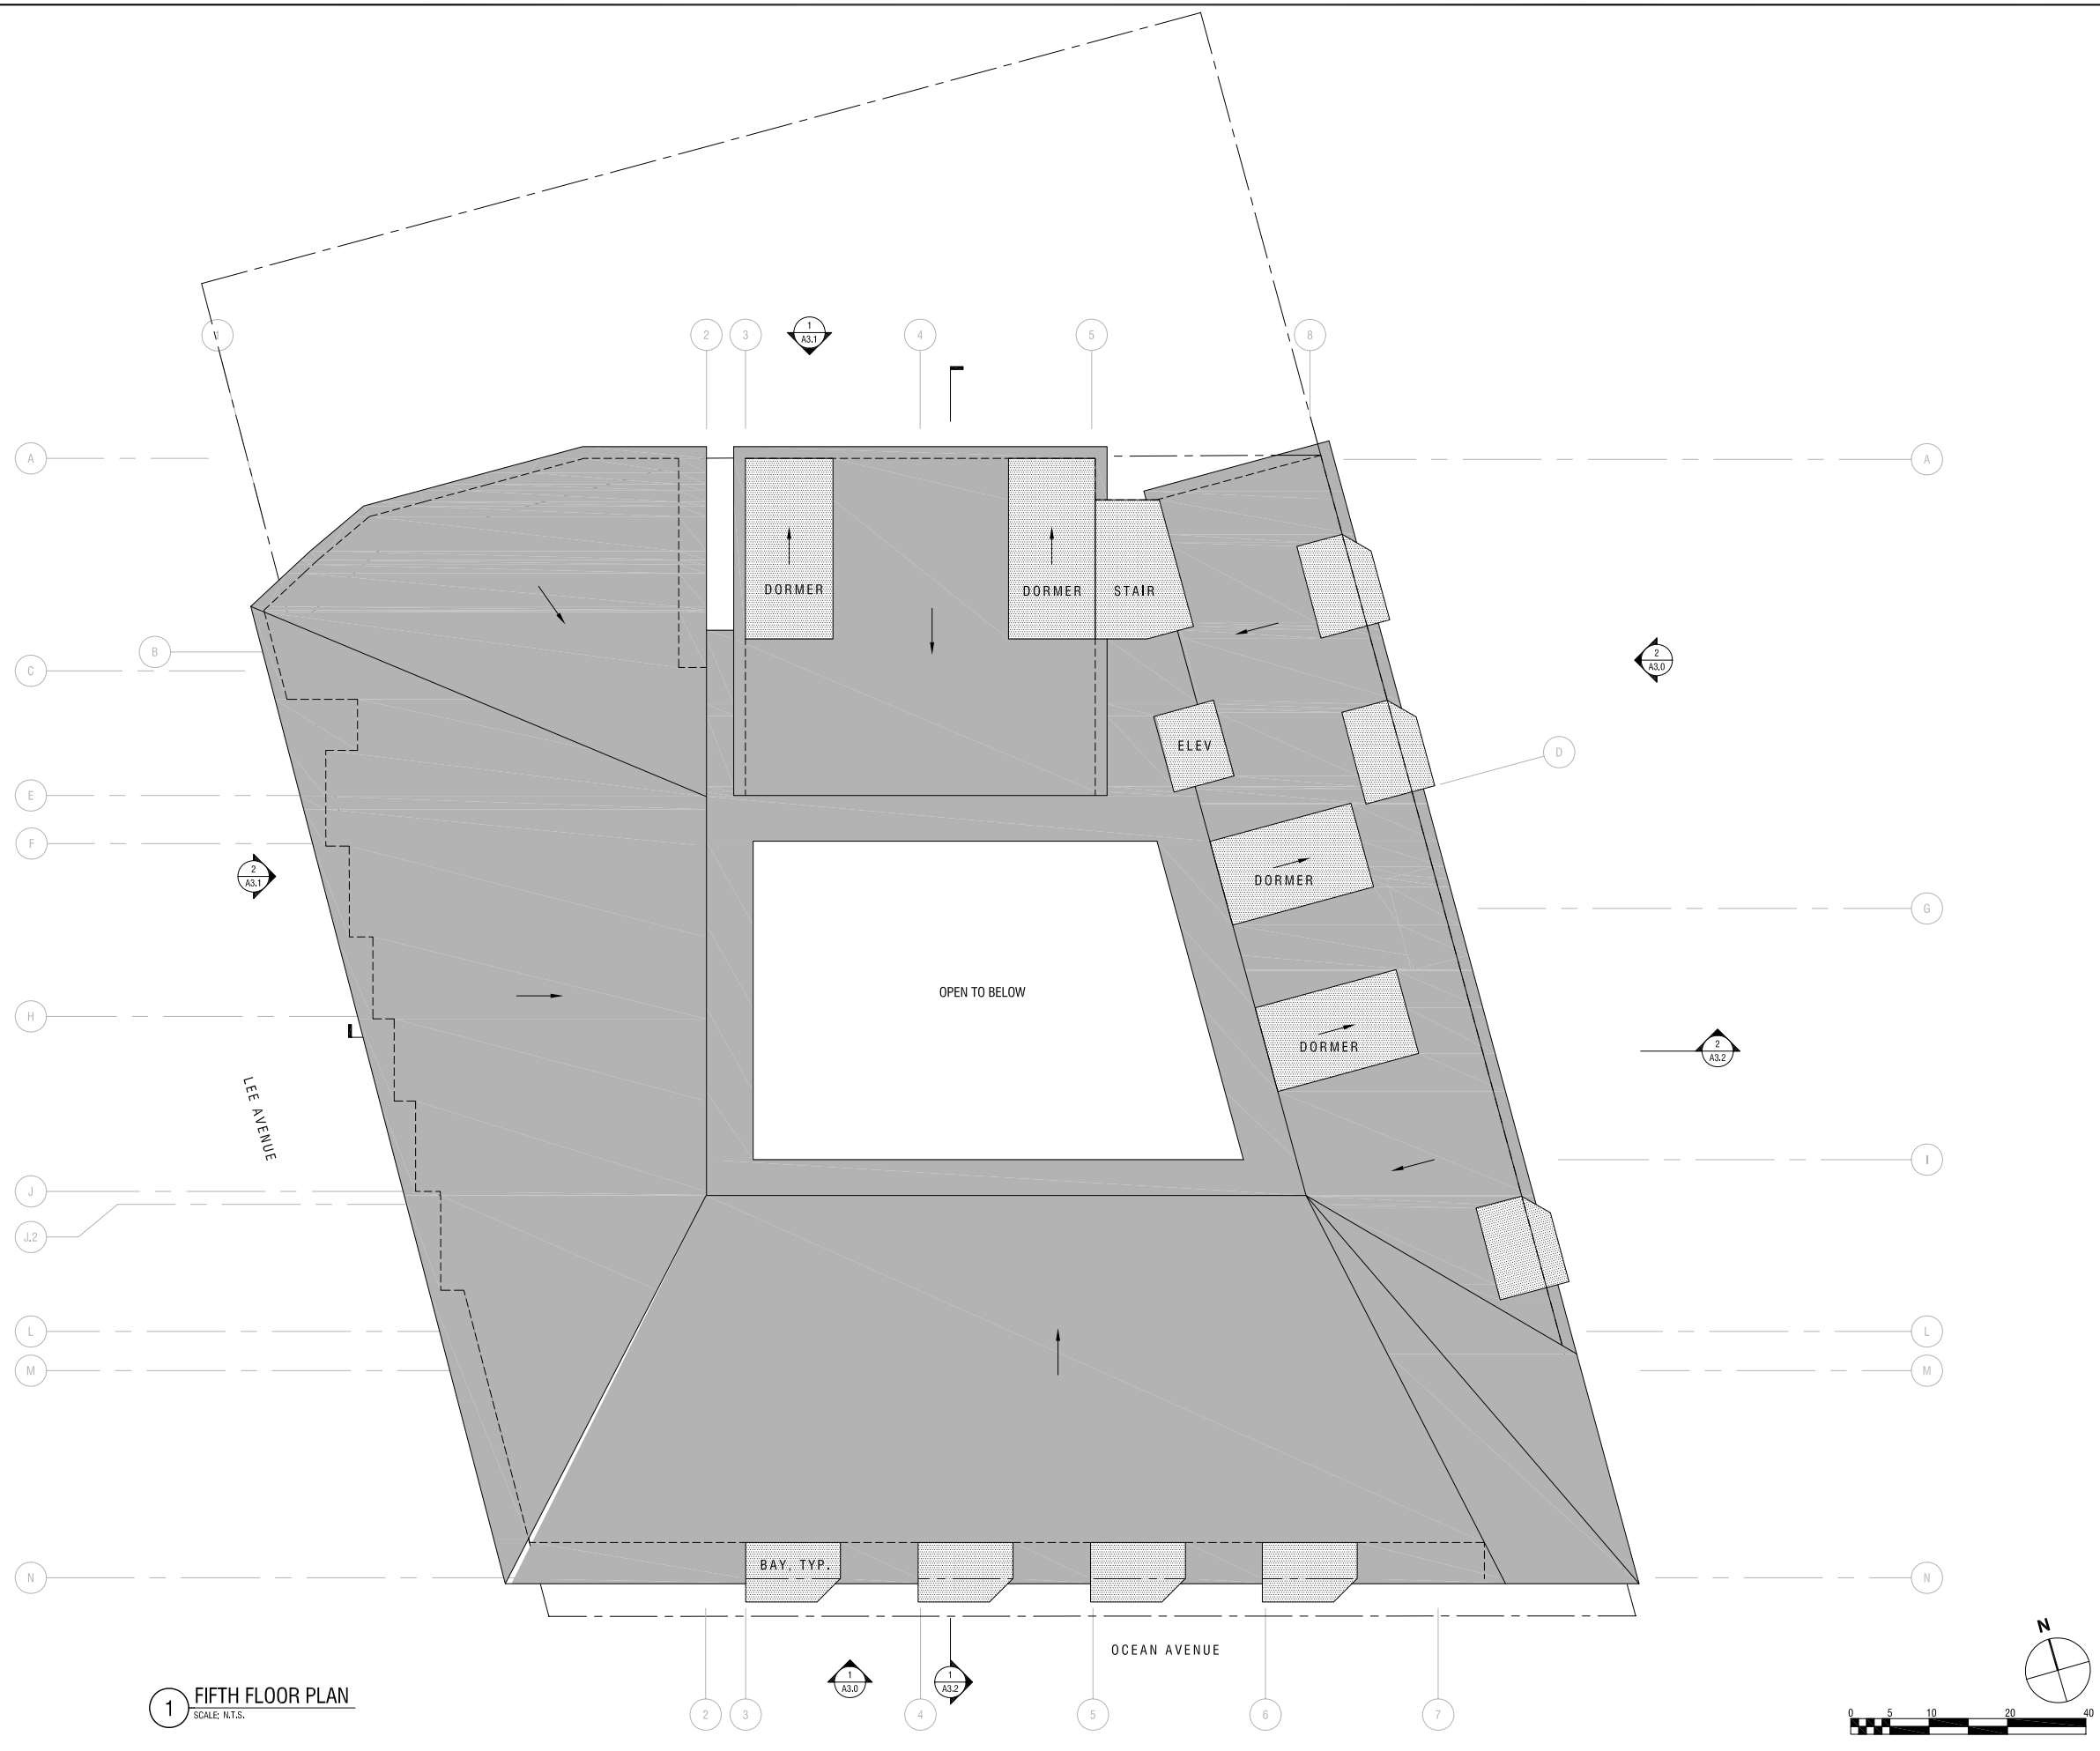
Sheet Title:  
**ROOF PLAN**

Scale:  
 NOT TO SCALE

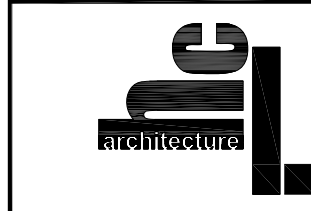

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Drawn By: JW Sheet Number:  
 Checked: Associate: **A2.6**



**1 FIFTH FLOOR PLAN**  
 SCALE: N.T.S.

Disclaimer:  
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Key Plan:

General Notes/Legend:

Consultant:


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Rev. No.	Revision	Date
	Environmental Evaluation App.	12.04.09
	Conditional Use Application	12.14.09
	CUP/Preliminary Pricing Set	01.19.10
	CUP/Prelim. Pricing Rev. 1	06.15.10
	CUP/Prelim. Pricing Rev. 2	07.07.10
	Planning Commission Hearing	07.12.10

Project Title:  
**PHELAN LOOP  
 AFFORDABLE HOUSING**  
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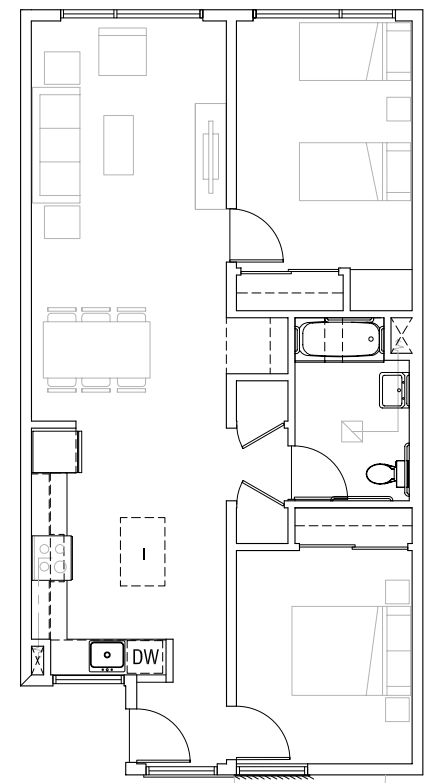
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 1/4" = 1'-0"




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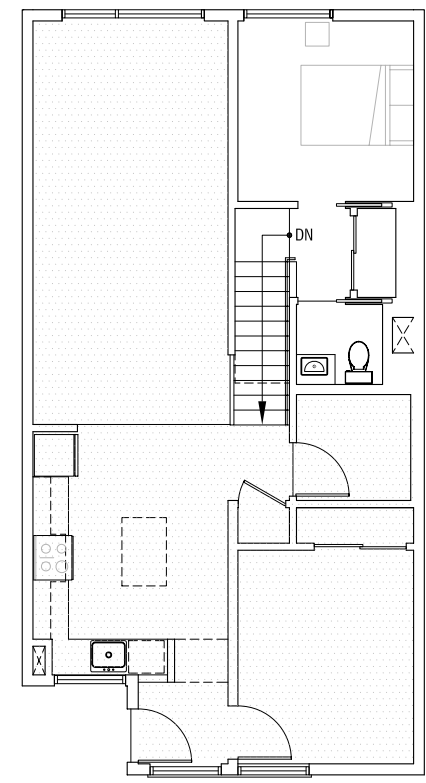
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 Checked: A2.7  
 Associate:

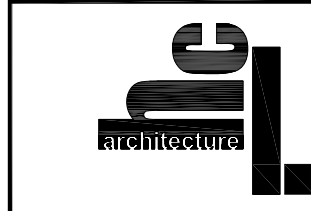


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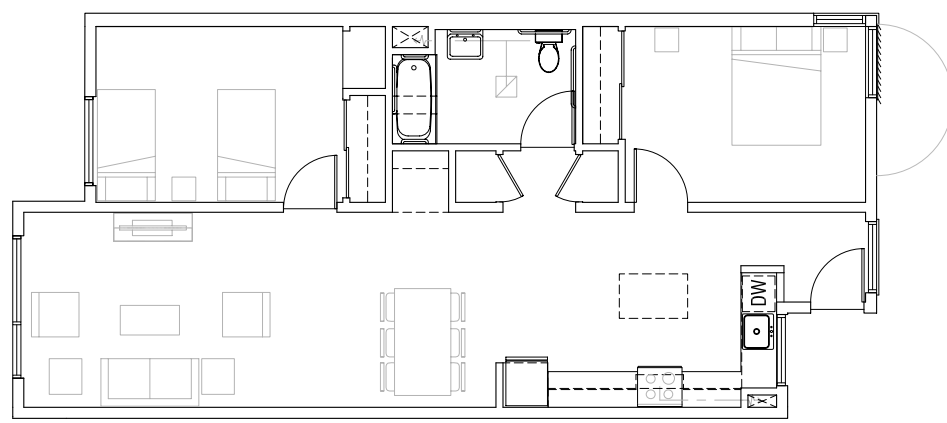
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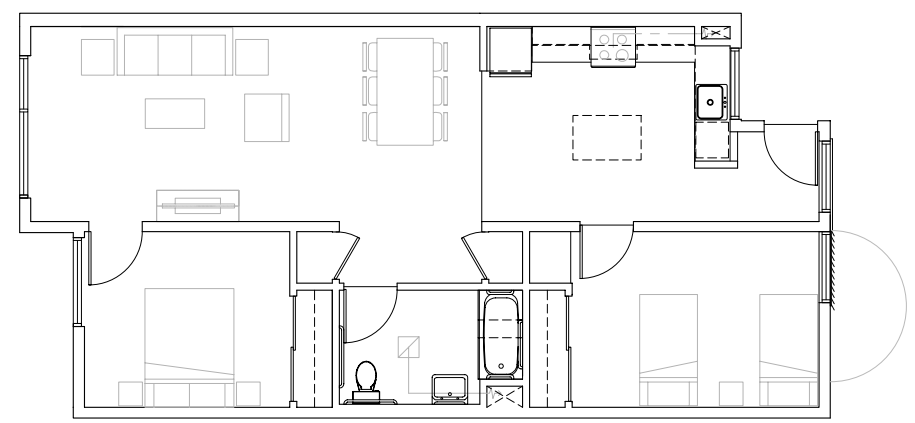
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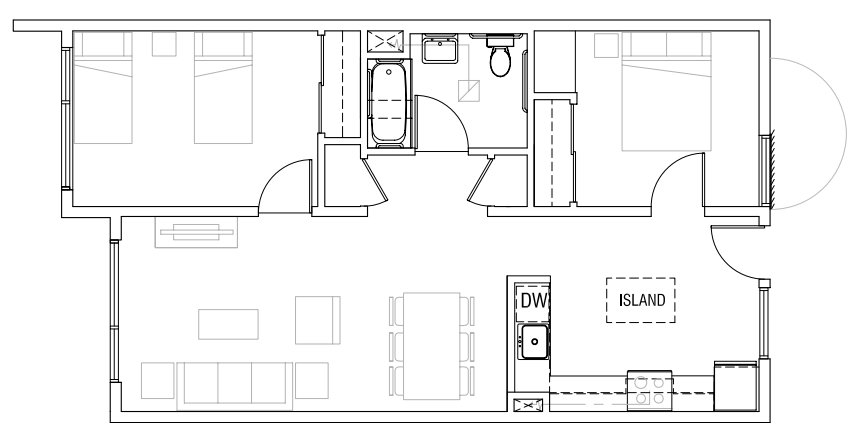
4 UNIT TYPE B1  
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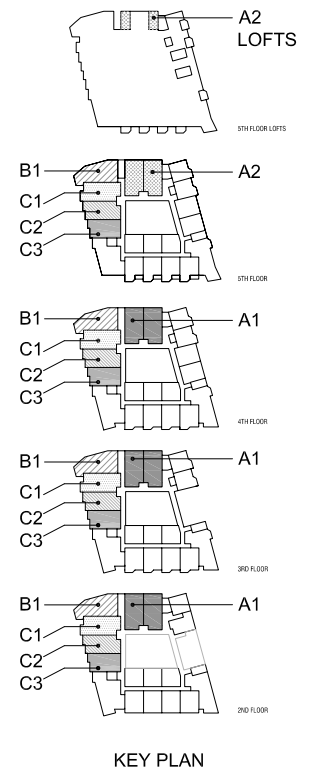
5 UNIT TYPE C1  
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6 UNIT TYPE C2  
 SCALE: 1/4" = 1'-0" NET SQ FT: 929

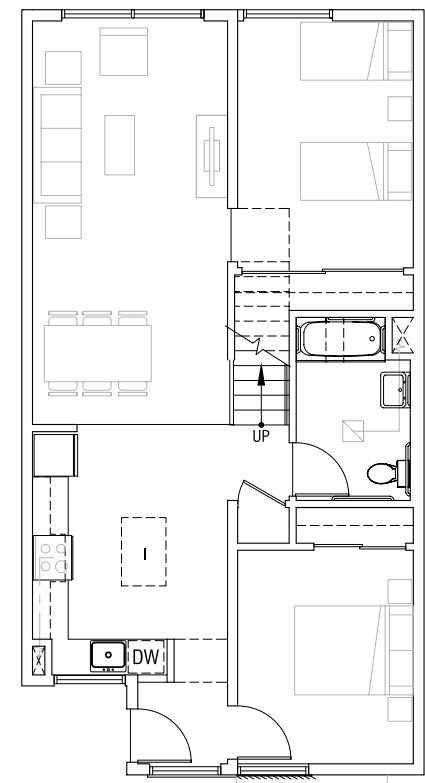

7 UNIT TYPE C3  
 SCALE: 1/4" = 1'-0" NET SQ FT: 831



KEY PLAN
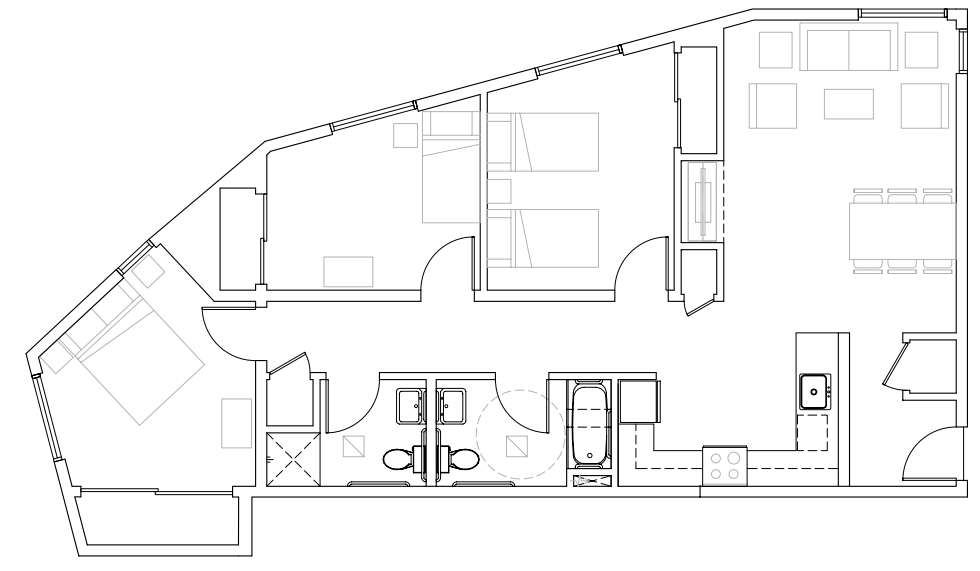
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Key Plan:  
 General Notes/Legend:  
 Consultant:  
 Stamp:


Rev. No.      Revision      Date

Rev. No.	Revision	Date
Environmental Evaluation App.	12.04.09	
Conditional Use Application	12.14.09	
CUP/Preliminary Pricing Set	01.19.10	
CUP/Prelim. Pricing Rev. 1	06.15.10	
CUP/Prelim. Pricing Rev. 2	07.07.10	
Planning Commission Hearing	07.12.10	

Project Title:  
**PHELAN LOOP  
 AFFORDABLE HOUSING**  
 Ocean Avenue & Lee Avenue  
 San Francisco, CA 94112


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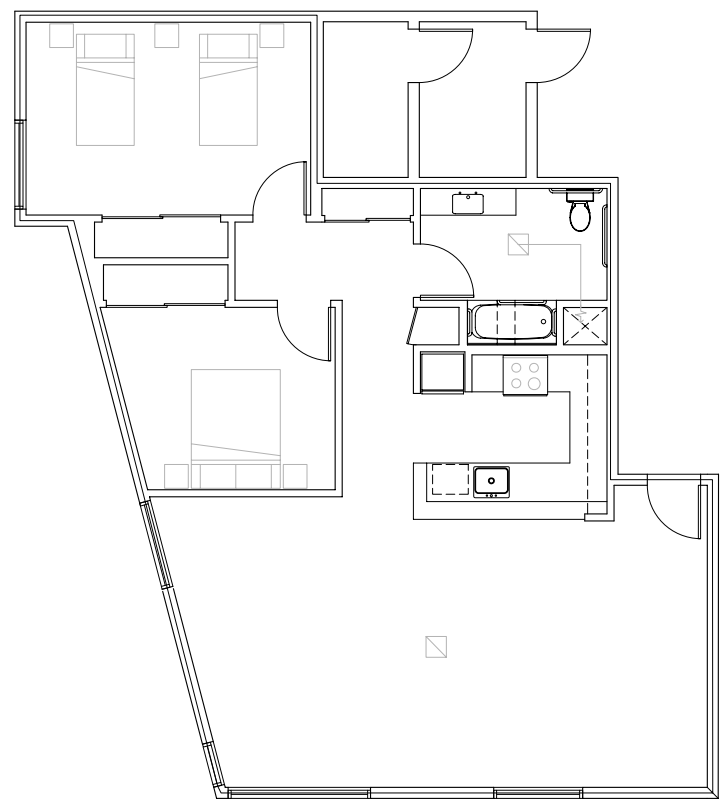


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Drawn By: JW      Sheet Number:  
 Checked:  
 Associate: **A2.8**

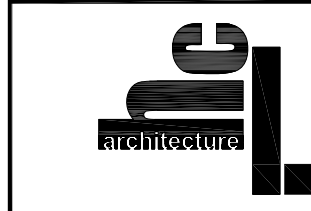

1 UNIT TYPE D1  
 SCALE: 1/4" = 1'-0" NET SQ FT: 1,237

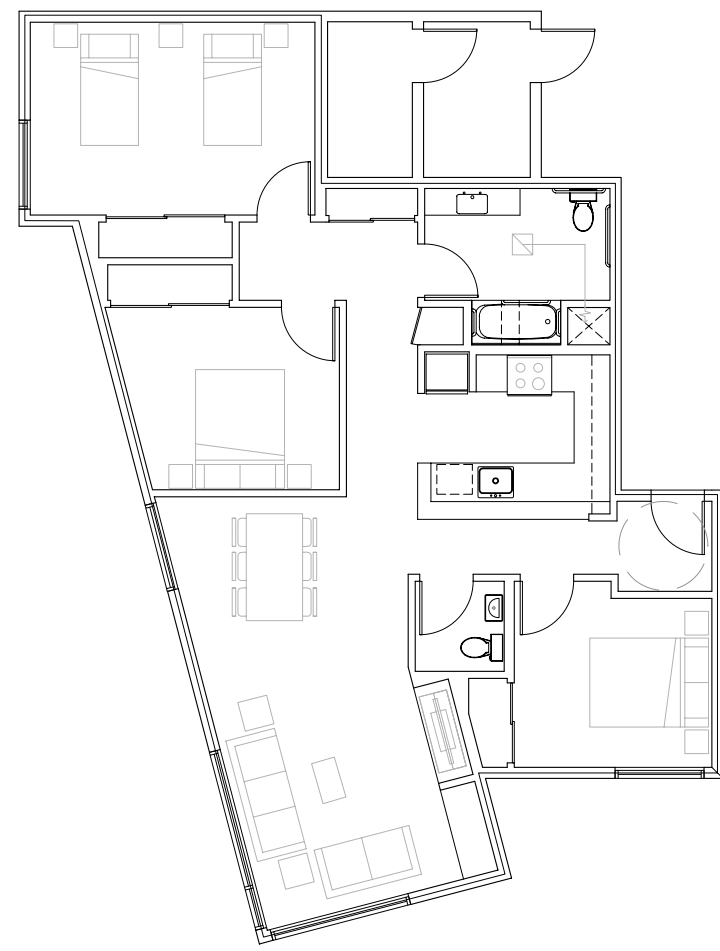


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3 UNIT TYPE F1  
 SCALE: 1/4" = 1'-0" NET SQ FT: 1,148

4 UNIT TYPE F1.1  
 SCALE: 1/4" = 1'-0" NET SQ FT: 1,179

5 UNIT TYPE F1.2  
 SCALE: 1/4" = 1'-0" NET SQ FT: 1,179



KEY PLAN
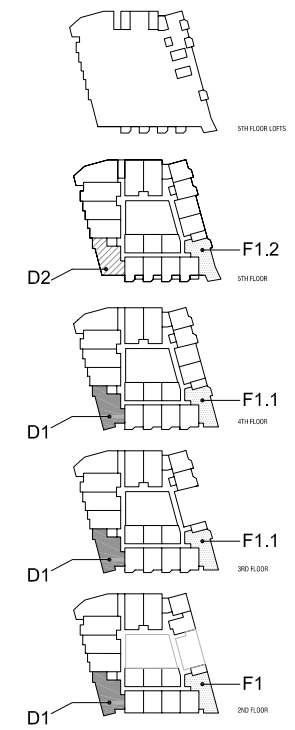
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Key Plan:

General Notes/Legend:

Consultant:

Stamp:

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	Environmental Evaluation App.	12.04.09
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	Planning Commission Hearing	07.12.10

Project Title:  
**PHELAN LOOP  
 AFFORDABLE HOUSING**  
 Ocean Avenue & Lee Avenue  
 San Francisco, CA 94112


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**ENLARGED UNIT PLANS**

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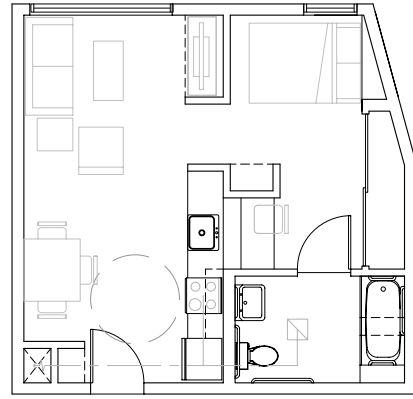


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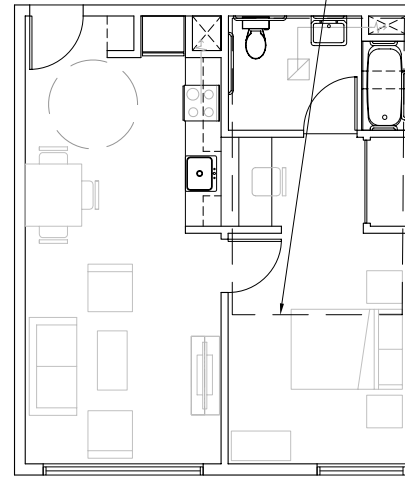
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 Checked: A2.9  
 Associate:




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2 UNIT TYPE E1.1  
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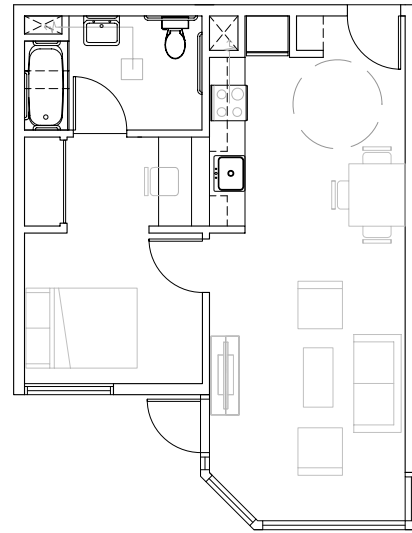
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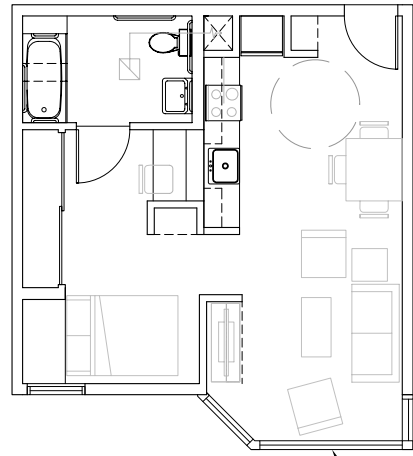
5 UNIT TYPE E3  
 SCALE: 1/4" = 1'-0" NET SQ FT: 600

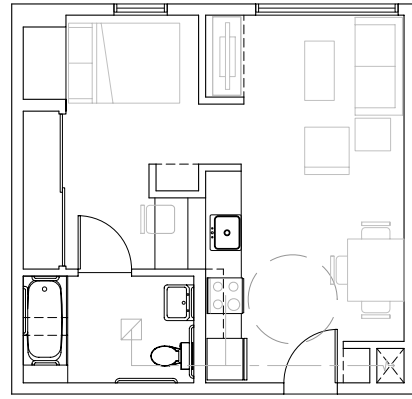4 UNIT TYPE E6  
 SCALE: 1/4" = 1'-0" NET SQ FT: 566 + 160

4 LOFT BEDROOM (DASHED);  
 STAIR TO BE PROVIDED




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7 UNIT TYPE E5  
 SCALE: 1/4" = 1'-0" NET SQ FT: 500

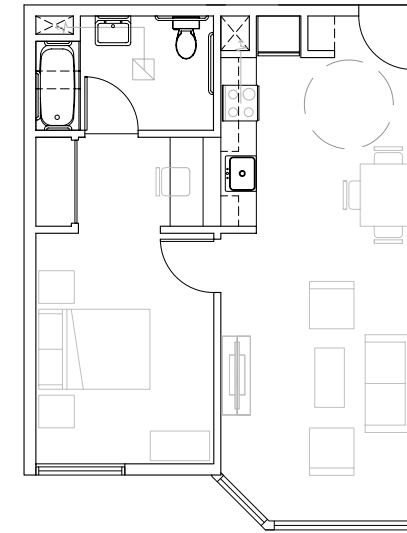8 DOUBLE HEIGHT BAY AT  
 UNIT TYPE E5.1

8 UNIT TYPE E5  
 SCALE: 1/4" = 1'-0" NET SQ FT: 500



KEY PLAN
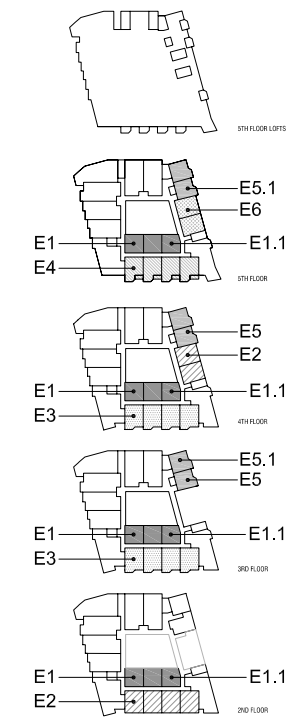
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Key Plan:  
 \_\_\_\_\_

General Notes/Legend:  
 \_\_\_\_\_

Consultant:  
 \_\_\_\_\_

Stamp:  
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Rev. No.	Revision	Date
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	CUP/Preliminary Pricing Set	01.19.10
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	CUP/Prelim. Pricing Rev. 2	07.07.10

Project Title:  
**PHELAN LOOP AFFORDABLE HOUSING**

Ocean Avenue & Lee Avenue  
 San Francisco, CA 94112

Sheet Title:  
**SOUTH & EAST BUILDING ELEVATIONS**

Scale:  
 1/8" = 1'-0"



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Drawn By: JW Sheet Number:  
 Checked: \_\_\_\_\_ A3.0  
 Associate: \_\_\_\_\_



**1 SOUTH ELEVATION**  
 SCALE: 1/8" = 1'-0"



**2 EAST ELEVATION**  
 SCALE: 1/8" = 1'-0"



Disclaimer:  
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Key Plan:

General Notes/Legend:

Consultant:


Stamp:

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	CUP/Preliminary Pricing Set	01.19.10
	CUP/Prelim. Pricing Rev. 1	06.15.10
	CUP/Prelim. Pricing Rev. 2	07.07.10
	Planning Commission Hearing	07.12.10

Project Title:  
**PHELAN LOOP AFFORDABLE HOUSING**  
 Ocean Avenue & Lee Avenue  
 San Francisco, CA 94112

Sheet Title:  
**OCEAN AVENUE ELEVATION & ADJACENT BUILDINGS**

Scale:  
 1" = 20'-0"

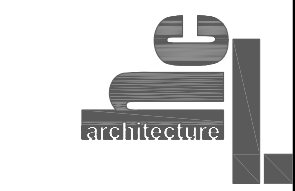

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Drawn By: JWSD  
 Checked:  
 Associate:

Sheet Number:  
**A3.0a**



**2** OCEAN AVENUE ELEVATION cont.  
 SCALE: 1" = 20'-0"



**1** OCEAN AVENUE ELEVATION  
 SCALE: 1" = 20'-0"

Disclaimer:  
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Key Plan:

General Notes/Legend:

Consultant:

Stamp:

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	CUP/Prelim. Pricing Rev. 1	06.15.10
	CUP/Prelim. Pricing Rev. 2	07.07.10

Project Title:  
**PHELAN LOOP AFFORDABLE HOUSING**  
 Ocean Avenue & Lee Avenue  
 San Francisco, CA 94112

Sheet Title:  
**NORTH & WEST BUILDING ELEVATIONS**

Scale:  
 1/8" = 1'-0"



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Drawn By: JW Sheet Number:  
 Checked: Associate: **A3.1**



**1 NORTH ELEVATION**  
 SCALE: 1/8" = 1'-0"



**2 WEST ELEVATION**  
 SCALE: 1/8" = 1'-0"

Disclaimer:  
 Written dimensions on these drawings shall have precedence over scaled dimensions. Contractors shall verify, and be responsible for, all dimensions and conditions on the job and this office must be notified of any variations from the dimensions and conditions shown by these drawings. Shop details must be submitted to this office for approval before proceeding with fabrication.

Key Plan:

General Notes/Legend:

Consultant:

Stamp:

Rev. No.	Revision	Date
	Environmental Evaluation App.	12.04.09
	Conditional Use Application	12.14.09
	CUP/Preliminary Pricing Set	01.19.10
	CUP/Prelim. Pricing Rev. 1	06.15.10
	CUP/Prelim. Pricing Rev. 2	07.07.10
	Planning Commission Hearing	07.12.10

Project Title:  
**PHELAN LOOP AFFORDABLE HOUSING**

Ocean Avenue & Lee Avenue  
 San Francisco, CA 94112


Sheet Title:  
**BUILDING SECTIONS**

Scale:  
**NOT TO SCALE**




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 Checked: Associate: **A3.2**

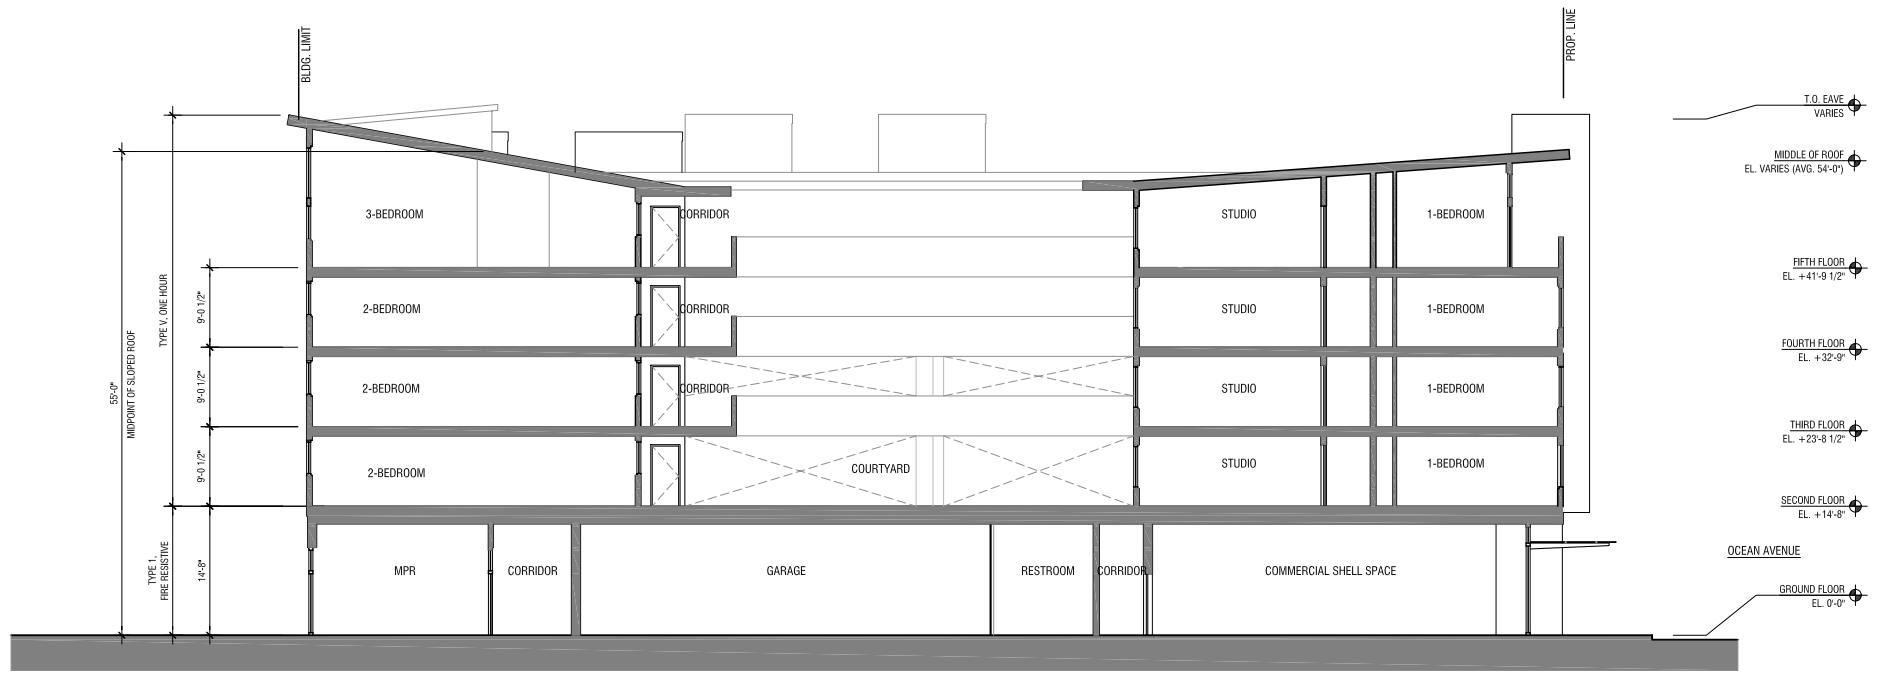

**1 BUILDING SECTION - LOOKING EAST**  
 SCALE: N.T.S.

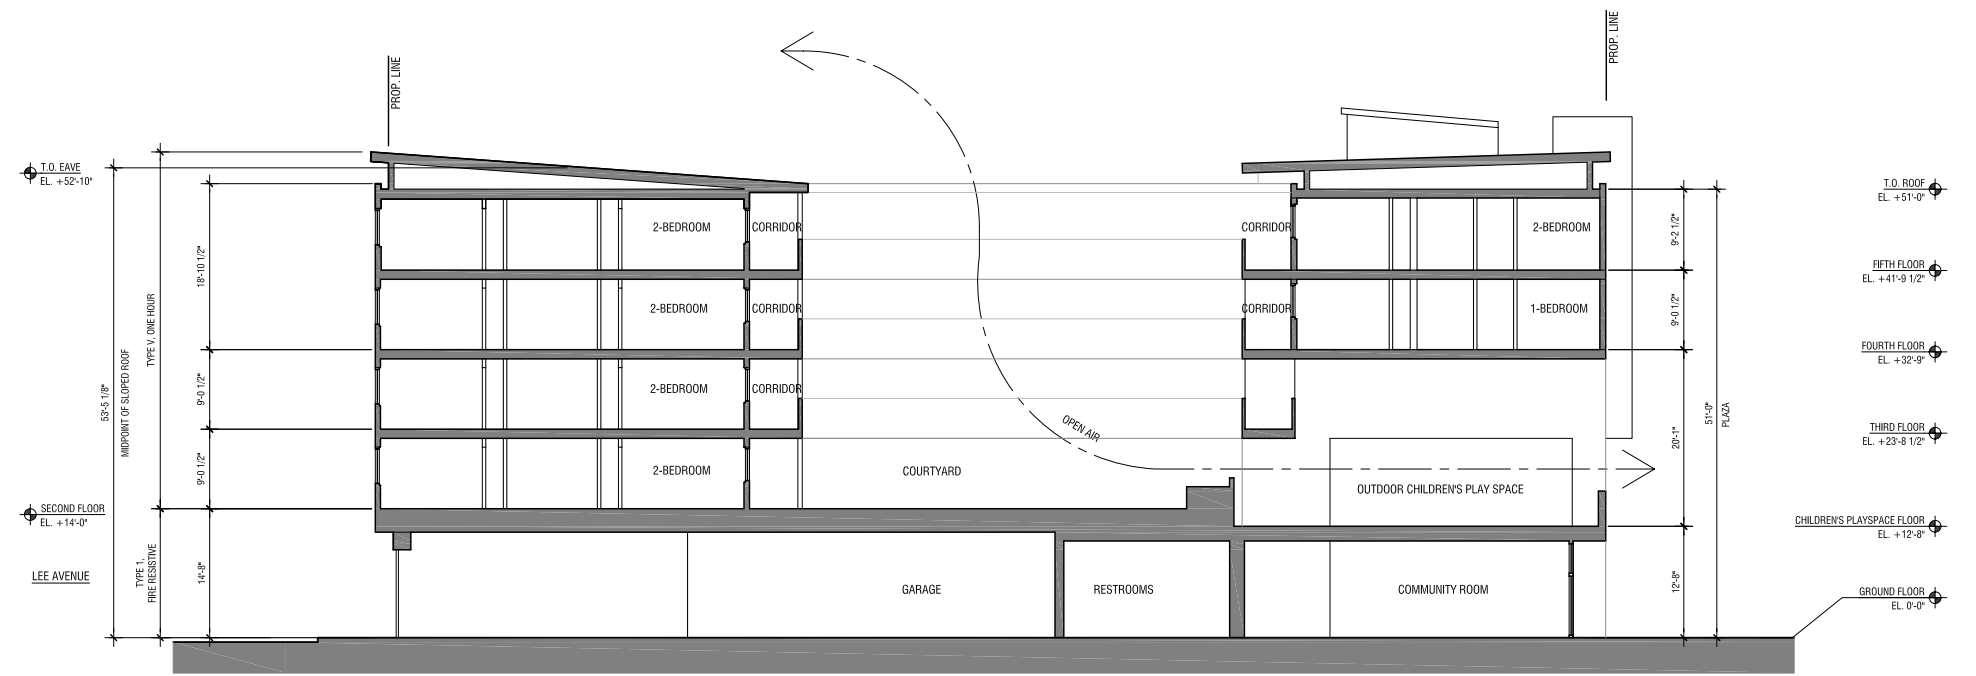

**2 BUILDING SECTION - LOOKING NORTH**  
 SCALE: N.T.S.