## Memo to the Planning Commission

**HEARING DATE: JUNE 6, 2013** 

1650 Mission St. Suite 400 San Francisco, CA 94103-2479

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Planning Information: 415.558.6377

Date: May 30, 2013

*Case No.:* **2004.0976**E<u>C</u>V

Project Address: 376 CASTRO STREET

Zoning: Upper-Market Street Neighborhood Commercial District

65-B Height and Bulk District

*Block/Lot:* 2623/006

Project Sponsor: David Silverman

Reuben & Junius

One Bush Street Suite 600 San Francisco, CA 94104

Staff Contact: Rick Crawford – (415) 558-6358

rick.crawford@sfgov.org

Recommendation: Informational Item, No Action Necessary

### **BACKGROUND**

On August 2, 2012 the Planning Commission granted Conditional Use Authorization under Planning Code Sections 228, and 721.21 to the project to allow the demolition of an existing gasoline service station on the property and construction of a six-story, 65 foot tall mixed use building with 24 dwelling units and 3,000 square feet of ground floor commercial space within the Upper Market Street Neighborhood Commercial District and a 65-B Height and Bulk District. As a condition of approval of the project, the Commission directed the Project Sponsor to continue to work with Planning Department on the building design including final materials, glazing, color, texture, landscaping, and detailing. The Commission also required that the Department should present the final approved plans for the project to the Planning Commission at a future meeting as an informational item.

### **CURRENT PROPOSAL**

The mixed-use project will contain ground floor retail space fronting both Market and Castro Streets. There will also be a street level room dedicated solely for neighborhood community use. Behind the retail area is a garage for both auto and bicycle parking. On the five floors above there will be twenty-four residential units, comprising of five one-bedroom units and nineteen two-bedroom units including on-site below market residential units.

The building is a fusion of a bold transparent element at the intersection of Market and Castro Streets flanked by solid walls with rhythmically patterned window openings, balconies, and bay projections. The corner element is a spandrel glass system with non-tinted glazing and an aluminum frame in a warm, pewter color paint finish. The solid walls are clad with terra cotta tiles, grounding the building with a dark grey at the base of the building and a random palette of terra cotta red and buff colors for the body of the building. The precise palette may include less color variety than presented.

The building is flanked by a shallow bay window system on both Market and Castro Streets, and will be clad with the same aluminum color as the corner element. The roof terrace has a windscreen of glass and mesh that is a continuation of the corner transparent element, and it will be capped with a pewter colored aluminum cornice. Balcony rails are either comprised of clear glass elements or painted metal rails.

### REQUIRED COMMISSION ACTION

This is an informational item to present the design of the building to the Planning Commission. No action is necessary.

RECOMMENDATION: Receive the Plans as Submitted





# **GENERAL CONDITIONS**

WORK TO BE PERFORMED UNDER SEPARATE PERMIT

CONTRACTORS RESPONSIBILITIES: I.CONTRACTOR TO PROVIDE ALL WORK AND MATERIALS IN ACCORDANCE WITH THE 2007 CBC AS AMENDED BY ALL STATE AND LOCAL CODES, AND CALIFORNIA ADMINISTRATIVE CODE, TITLE 24, DISABLED ACCESS COMPLIANCE REGULATIONS.

2.CONTRACTOR SHALL MAKE SITE INSPECTIONS AND BE RESPONSIBLE FOR ALL NEW AND DEMOLITION WORK, WHETHER DETAILED BY THE SPECIFICATIONS AND DRAWINGS, OR IMPLIED BY EXISTING CONDITIONS.

3.ANY DISCREPANCIES IN THE CONSTRUCTION DOCUMENTS, AS CONFLICTS WITH ACTUAL SITE CONDITIONS SHALL BE BROUGHT TO THE ATTENTION OF THE ARCHITECT BEFORE PROCEEDING WITH THE WORK.

1.CONTRACTOR SHALL PROVIDE ALL TEMPORARY SHORING & UNDERPINNING AS NECESSARY;

5.CONTRACTOR SHALL BE RESPONSIBLE TO COORDINATE AND PROVIDE ALL NECESSARY TEMPORARY UTILITY HOOK-UPS FOR ALL EQUIPMENT DURING CONSTRUCTION

3.CONTRACTOR SHALL BE RESPONSIBLE FOR DISCONNECTION / CAPPING OFF OF ALL EXISTING UTILITIES AND RE-CONNECTION WHERE RE-USE IS POSSIBLE.

CONFIRM ALL WINDOW SIZES WITH ACTUAL / EXISTING ROUGH OPENING DIMENSIONS PRIOR TO ORDERING WINDOWS.

8.SLOPE ALL FLOORS / ROOFS TO DRAIN A MINIMUM OF 1/4" PER 1'-0", UNLESS SPECIFICALLY NOTED OTHERWISE.

. CONTRACTOR IS RESPONSIBLE TO PROCURE STATE INDUSTRIAL SAFEY PERMIT FOR ANY

WORK OVER 36' IN HEIGHT, INVOLVING EXCAVATION OVER 5' & AS OTHERWISE REQUIRED.

### **DRAWINGS:**

1.DO NOT SCALE DRAWINGS! ALL WRITTEN DIMENSIONS SUPERSEDE SCALED DIMENSIONS.

2.ALL DIMENSIONS ARE TO "FACE OF STUD" UNLESS SPECIFICALLY NOTED OTHERWISE. EXISTING DIMENSIONS DENOTED BY "(E)" ARE TO "FACE OF EXISTING FINISH" UNLESS SPECIFICALLY NOTED OTHERWISE. ALL EXISTING DIMENSIONS SHALL BE FIELD VERIFIED PRIOR TO PROCEEDING WITH THE WORK.

3.LARGE SCALE DRAWINGS TAKE PRECEDENCE OVER SMALL SCALE DRAWINGS. WRITTEN SPECIFICATIONS TAKE PRECEDENCE OVER ALL DRAWINGS.

4.REFER TO EXTERIOR ELEVATIONS FOR INDICATIONS OF WINDOW OPERATION AND HANDING.

(SEE COVER SHEET LEGEND FOR RATED WALL DESIGNATIONS AND OTHER WALL TYPES)

.PROVIDE MINIMUM 1-HOUR WALL AND FLOOR / CEILING ASSEMBLY BETWEEN ALL RESIDENTIAL UNITS. SEE PLANS AND BUILDING SECTIONS FOR DESIGNATIONS; AND STANDARD DETAILS FOR COMPLETE ASSEMBLY DESCRIPTIONS

2.PROVIDE MINIMUM 50 STC AND IIC REQUIREMENT AT ALL UNITS AT FLOORS,CEILINGS, AND WALLS. SEE PLANS AND BUILDING SECTIONS FOR DESIGNATIONS; AND STANDARD DETAILS FOR ASSEMBLY DESCRIPTIONS.

3.INSULATE ALL ASSEMBLIES BETWEEN HEATED AND UNHEATED AREAS: R-30 AT ROOFS, R-13 AT WALLS, R-19 AT FLOORS; MINIMUM, UNLESS SPECIFICALLY NOTED OTHERWISE. SEE TITLE 24, ENERGY COMPLIANCE STATEMENT MANDATORY MEASURES CHECKLIST FOR SPECIFIC REQUIREMENTS.

4.PROVIDE VENTILATION OF ALL JOIST, STUD AND RAFTER SPACES ENCLOSED BY BUILDING ASSEMBLIES BETWEEN HEATED AND UNHEATED AREAS INCLUDING:ATTICS, BASEMENTS, ROOFS, SOFFITS, PARAPET AND RAILING WALLS, ETC.

5.ALL DOORS BETWEEN HEATED AND UNHEATED AREAS SHALL BE PROVIDED WITH WEATHER-STRIPPING AND THRESHOLDS.

6.ALL PROPERTY LINE WINDOWS (INDICATED ON DRAWINGS BY " ") SHALL BE STEEL SASH WITH FIXED WIRE GLASS, WITH SPRINKLER HEAD PROTECTION PER S.F. BUILDING CODE

7.PROVIDE MOISTURE RESISTANT GYPSUM WALL BOARD (MR GWB) ON ALL BATHROOM WALLS. DO NOT USE A CONTINUOUS VAPOR BARRIER BEHIND MR GWB. PROVIDE 30 POUND ROOFING FELT BEHIND FINISH SURFACE OF ALL TUB / SHOWER SURROUNDS, LAPPING ALL SEAMS. DO NOT USE MR GWB ON BATHROOM CEILINGS; USE 5/8" TYPE "X" GWB.

### MECHANICAL AND ELECTRICAL:

MECHANICAL AND ELECTRICAL WORK SHOWN ON DRAWINGS IS SCHEMATIC IN NATURE: CONTRACTOR TO CONFIRM FINAL LAYOUT WITH ARCHITECT, PRIOR TO PROCEEDING WITH THE

2. ALL WORK TO BE PERFORMED UNDER SEPARATE PERMIT.

3. PARKING GARAGE(S), CORRIDORS AND STAIRS SHALL BE VENTILATED AS REQUIRED PER

. PROVIDE EMERGENCY / EXIT LIGHTING AT ALL EXIT PATHS OF TRAVEL AS REQUIRED PER

5. ALL INTERIOR COMMON AREA LIGHT FIXTURES, ETC. SHALL BE PROVIDED WITH SWITCHING VIA CENTRAL PHOTO-ELECTRIC SENSOR WITH TIMER CLOCK SWITCH OVERRIDE, UNLESS OTHERWISE SPECIFIED.

5. PARKING GARAGE(S) AND ALL OTHER COMMON AREAS, NOT SERVED BY DAY LIGHTING WINDOWS, SHALL BE PROVIDED WITH ELECTRIC LIGHTING 24 HOURS PER DAY, UNLESS SPECIFICALLY NOTED OTHERWISE.

. STAGGER ALL ELECTRICAL AND MECHANICAL ITEMS IN ALL DEMISING WALLS AND FLOORS BETWEEN UNITS TO MAINTAIN ASSEMBLY'S ACOUSTICAL RATINGS. SEE SPECIFICATIONS AND DETAILS FOR SPECIFIC REQUIREMENTS.

8. ALL ELECTRICAL RECEPTACLES IN DAMP LOCATIONS TO BE GROUND FAUL INTERRUPTER (GFI) AS REQUIRED PER CODE.

## WATERPROOFING:

I.ALL SHEET METAL WORK TO BE IN ACCORDANCE WITH CURRENT EDITION OF S.M.A.C.N.A.

PROVIDE GALVANIZED SHEET METAL FLASHING AT ALL WINDOW AND DOOR HEADS: INSTALL UNDER EXTERIOR SIDING OR CEMENT PLASTER AND BUILDING PAPER, AND OVER HEAD FRAME OF ALL NEW DOORS AND WINDOWS PROVIDE ADDITIONAL FLASHING MEMBRANE PER STANDARD WINDOW FLASHING DETAIL (SEE

3.PROVIDE GALVANIZED SHEET METAL FLASHING AT ALL ROOF CONDITIONS INCLUDING BUT NOT LIMITED TO: PERIMETER EDGES, VALLEYS, PARAPET CAPS, WALL / ROOF INTERSECTIONS,

4.ALL NEW EXTERIOR FINISHES TO BE INSTALLED OVER A MINIMUM MOISTURE BARRIER OF OF

## **DPW STREET IMPROVEMENT NOTES**

ROOF PENETRATIONS, ETC. SEE DETAIL SHEETS FOR SPECIFIC REQUIREMENTS.

DPW / BSM SITE MEETING REQUIRED; CALL 415-554-7149 TO ARRANGE APPOINTMENT WITH

DFFICIAL SIDEWALK SLOPE IS 1/5" PER FOOT RISE FROM CURB GRADE TO PROPERTY LINE. ALL ENTRANCES, BOTH PEDESTRIAN AND VEHICULAR, SHALL MEET SIDEWALK GRADE. ALL RAMPING SHALL BE INSIDE OF PROPERTY LINE. DRIVEWAYS AND SIDEWALKS MUST CONFORM TO CITY REQUIREMENTS. FOR FURTHER INFORMATION CALL BUREAU OF STREET USE & MAPPING @

ALL ENCROACHMENTS INTO OFFICIAL STREET OR SIDEWALK AREAS MUST BE GRANTED IN WRITING BY THE DIRECTOR OF PUBLIC WORKS OR BY RESOLUTION OF THE BOARD OF SUPERVISORS. ALL RAMPING TO BE INSIDE PROPERTY LINE.

STREET TREES IN SIDEWALK AREAS. FOR FURTHER INFORMATION CALL 415-554-6700.

DPW / BSM SIGN-OFF REQUIRED ON JOB CARD PRIOR TO DBI FINAL

DETAIL SHEETS) AROUND ALL WINDOW AND DOOR OPENINGS.

TWO LAYERS OF 15 POUND (GRADE D) BUILDING PAPER.

# **BUILDING DEPARTMENT NOTES**



# **DRAWING INDEX** TS.00 COVER SHEET/ DRAWING INDEX **GREEN BUILDING CHECKLIST** BASEMENT / RETAIL A 2.02 GROUND FLOOR / RESIDENTIAL PARKING / COMMUNITY ROOM A 2.03 FIRST FLOOR RESIDENTIAL PLAN SECOND & THIRD RESIDENTIAL FLOOR PLAN FOURTH RESIDENTIAL FLOOR PLAN FIFTH RESIDENTIAL FLOOR PLAN A2.07 ROOF PLAN & SITE PLAN CASTRO AND MARKET STREET ELEVATIONS A 3.02 NORTH & WEST REAR ELVEATIONS A 3.03 PROPERTY LINE ELEVATIONS A 4.01 BUILDING CROSS SECTION

### PLANNING DEPARTMENT NOTES

PROJECT LOCATION: 376 CASTRO STREET, BLOCK 2623, LOT 006, SAN FRANCISCO, CA.

ZONING DISTRICT: UPPER MARKET NCD - NEIGHBORHOOD COMMERCIAL DISTRICT SEC - 721. RETAIL USE OF 3,000 s.f. OR MORE REQUIRE A CONDITIONAL USE. DEVELOPMENTS ON LOT SIZES OF 10,000 S.F. AND MORE SHALL ALSO REQUIRE A CONDITIONAL USE.

DWELLING UNIT DENSITY: 1 UNIT PER 400 SF OF LOT = 9,748 / 400 = 24.37 UNITS (NC DISTRICTS ARE PERMITTED TO

PROPOSED BUILDING USE: 24 UNIT RESIDENTIAL BUILDING OVER GARAGE, COMMERCIAL, RESIDENTIAL ENTRY AND UTILITY ROOMS.

BUILDING HEIGHT LIMIT: 65-B - BULK LIMIT - ABOVE 50' MAX LENGTH 110' / MAX DIAGONAL 125'. THE PROPOSED BUILDING HEIGHT SHALL BE 65'-O" MEASURED AT CASTRO STREET FRONTAGE FROM CURB AT CENTERLINE OF BUILDING TO ROOF OF BUILDING.

USABLE OPEN SPACE: MINIMUM 60 S.F. OF PRIVATE USABLE OUTDOOR OPEN SPACE, OR 80 S.F. OF COMMON USABLE OUTDOOR OPEN SPACE REQUIRED PER UNIT, WITH A MINIMUM DIMENSION OF 6' REQUIRED FOR PRIVATE AND 15' FOR COMMON. 24 X 80 = 1920 SQ.FT. REQUIRED. 1925 SQ.FT. COMMON TERRACE PROVIDED. IT IS LOCATED AT THE FIRST

REAR YARD SET-BACK: REQUIRED AT GRADE AND ABOVE AT ALL RESIDENTIAL LEVELS. 25% OF LOT AREA = 2,437 S.F. REQUIRED. 2,510 S.F. PROVIDED AT FIRST RESIDENTIAL FLOOR. VARIANCE IS REQUESTED DUE TO TOPGORPAHY OF ADJOINING PROPERTIES.

FRONT SET-BACK: NONE REQUIRED.

SIDE SET-BACK: NOT REQUIRED IN UPPER MARKET NCD ZONE.

FLOOR AREA RATIO (F.A.R.): FAR IS NOT REQUIRED FOR RESIDENTIAL IN UPPER MARKET NCD ZONE.

AUTO PARKING: UP TO .5 PARKING SPACE PER RESIDENTIAL UNIT PERMITTED.12 PARKING SPACES PROVIDED. 1 PARKING SPACE PER 1,500 SQ.FT. OF RETAIL PERMITTED. 2 PROVIDED. 14 TOTAL PARKING SPACES PROVIDED. 1 ADA VAN ACCESSIBLE

BICYCLE PARKING REQUIRED: ONE CLASS 1 PARKING SPACE REQUIRED PER 2 RESIDENTIAL UNITS. = 12 BICYCLE SPACES REQUIRED. 12 CLASS 1 BICYCLE PARKING SPACES PROVIDED.

# **LEGEND**

ONE-WAY SWITCH

240: 220/240 VOLT **WP: WATERPROOF** 

W/ REMOVABLE **FLUSH COVER** 

FOURPLEX RECEPT.

RECEPTACLE

— - 

RECEPTACLE STRIP

**RECESS MOUNTED** 

LIGHT FIXTURE AT WALL. PC=PULL CHAIN, LV=LOW VOLTAGE

SURFACE-MOUNTED INCANDESCENT LIGHT FIXTURE AT CEILING.

FLUORESCENT LIGHT FIXTURE AT WALL. LV=LOW VOLTAGE

FLUORESCENT LIGHT FIXTURE AT CEILING. LV=LOW VOLTAGE

(H: HEAT LAMP LV: LOW VOLT.)

UNDER CABINET FLUOR.

TWO-WAY SWITCH

DIMMER SWITCH

24 HOUR TIMERSWITCH DUPLEX RECEPTACLE

**CA: ABOVE COUNTER** FLOOR DUPLEX RECPT.

DIRECT CONNECTION

(OUTLETS @ 6" O.C.)

**ELEC. PANEL BOX** 

TELEPHONE RECEPT.

(W: WALL MTD.) **CEILING HEATER** 

SURFACE-MOUNTED INCANDESCENT

PC=PULL CHAIN, LV=LOW VOLTAGE SURFACE-MOUNTED COMPACT

SURFACE-MOUNTED COMPACT

RECESSED INCANDESCENT LIGHT FIXTURE AT CEILING.

RECESSED COMPACT FLUORESCENT LIGHT FIXTURE AT CEILING.

LIGHT STRIF

# **──** FLUORESCENT LIGHT FIXTURE

□□□□ INCANDESCENT TRACK LIGHT **FIXTURE** 

-⊕—⊕- HALOGEN TRACK LIGHT FIXTURE

T.V. OUTLET; VIACOM **COMPATIBLE CABLE** 

INTERCOM

**SMOKE / CARBON MONOXIDE** DETECTOR (AC POWERED W/ BATTERY BACK-UP U.O.N.)

**THERMOSTAT** 

DOOR BELL LIGHTED EXIT SIGN W/

**BATTERY BACK-UP** SECURITY ALARM

SECURITY ALARM PANEL BOX

**IN-SINK TRASH** DISPOSAL **EXHAUST FAN** 

**GAS METER** 

**ELECTRIC METER** 

WATER CONNECTION

**AS REQUIRED** HOSE BIB

GAS HOOK-UP

FLOOR SUPPLY  $>\!\!<$ 

FLOOR RETURN

**CEILING SUPPLY** 

**CEILING RETURN** WALL/TOE SPACE

SUPPLY WALL/TOE SPACE

RETURN **ELECTRIC WALL** 

FLOOR DRAIN

**HEATER** 

SEPARATE PERMIT REQUIRED FROM BUREAU OF STREET USE & MAPPING FOR POTTED PLANTS &

ALL WORK IS SUBJECT TO THE CONDITIONS NOTED ON PENDING DPW STREET IMPROVEMENT <u>PERMIT</u> (WHERE APPLICABLE).

# **FIRE DEPARTMENT NOTES:**

Low level exit signs required with general exit signs.

are required.

<u>Sprinkler system</u> required to meet NFPA 13 2007 Edition: Light hazard- This is a Residential Building Note: Sewer connections to Fire Sprinkler Drains are not permitted in an enclosed stairway. Fire Alarm to meet section 310.10 CBC and be monitored to Central Station

over 100 heads. System to be UL certified. A Standpipe System is required through out per NFPA 13, provide outlet in each stairwell at each

Fire Extinguishers, of 2A10BC rating, to be provided on each level with a maximum of 75 feet travel distance form the extinguisher. Plans and Installations to meet NFPA 13 as above and San Francisco Fire Department Administrate Bulletins. Separate electrical and plumbing permits

This building is R-2 Residential building over a S-2 Parking Garage. Provide a lock box per Fire Department District Inspector. Firestop / Fireblocking in TJI requirement - NFPA 13, 2007, 8.14.1.2

# **SCOPE OF WORK**

CONSTRUCTION OF NEW SIX STORY OVER BASEMENT,TWENTY FOUR (24) UNIT, RESIDENTIAL OVER COMMERCIAL AND AUTO PARKING BUILDING. TYPE I-A BUILDING. THE BUILDING SHALL CONTAIN A PARKING GARAGE, COMMERCIAL, RESIDENTIAL ENTRY AND UTILITY ROOMS, AND RESIDENTIAL UNITS ON FLOORS ABOVE THE GROUND FLOOR.

# **DIRECTORY:**

# <u>OWNER</u>

**ARCHITECT** 

376 CASTRO STREET LLC 376 CASTRO STREET SAN FRANCISCO, CA

STERNBERG BENJAMIN ARCHITECTS INC. 1331 HARRISON STREET SAN FRANCISCO, CA 94103 415.882.9783

STRUCTURAL ENGINEER

# **CIVIL ENGINEER**

TRANSAMERICAN ENGINEERS 1390 MARKET STREET, #201 SAN FRANCISCO, CA 94102 415.553.4092

LOCATION PLAN Inn On Castro Catch | Time Out For Myself PROJECT SITE Twin Peaks Marcello's Pizza US Post Hansen's Office Laundry Escape From New York Pizza

Streetlight Records

REV./ISSUE. DATE 02.01.12 N.T.S. DRAWN: HEET:

BLDG PMT 05.08.13 MP

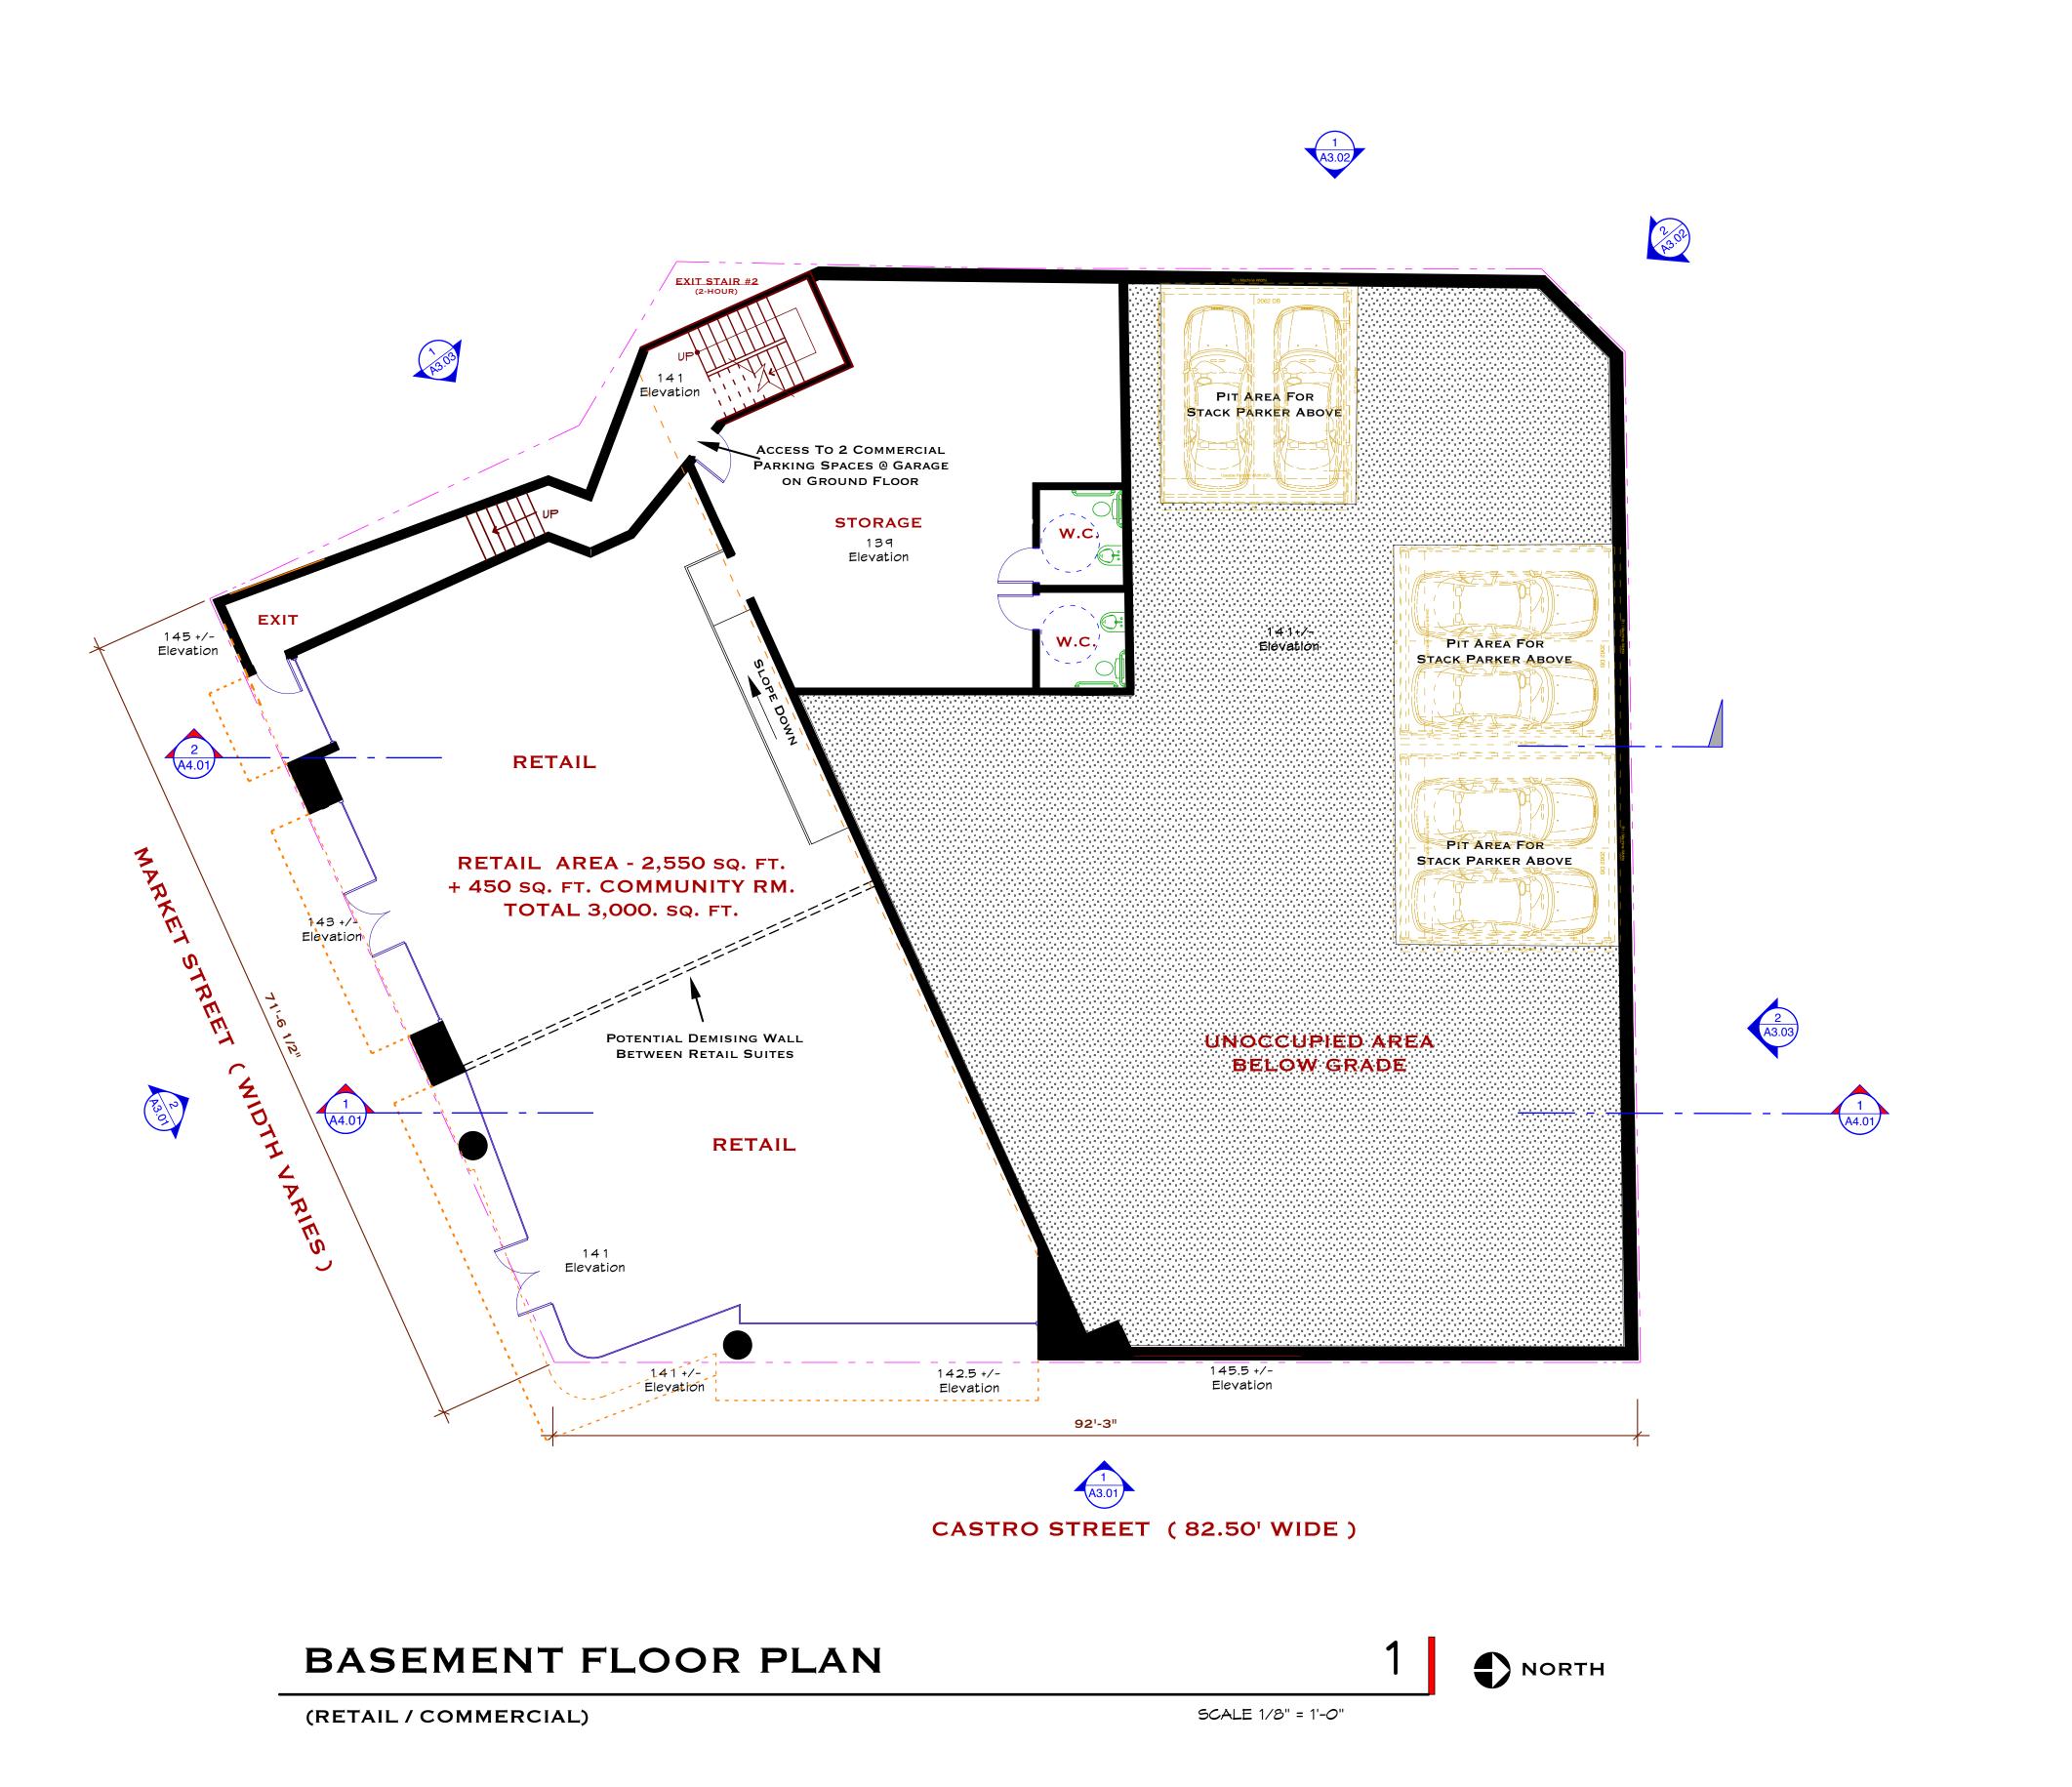
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Rev./Issue. Date

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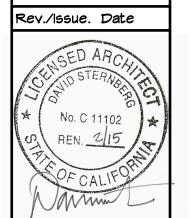
1331 HARRISON ST
SAN FRANCISCO CA 94
TEL 415.882.9783 FAX 415.882.
AMIN
TECTS
CHOP

STERNBERG
BENJAMIN

3/6 CASIRO SI 24 RESIDENTIAL UNITS BLOCK 2623 LOT 6 SAN FRANCISCO.. CA

3ASEMENT RETAIL

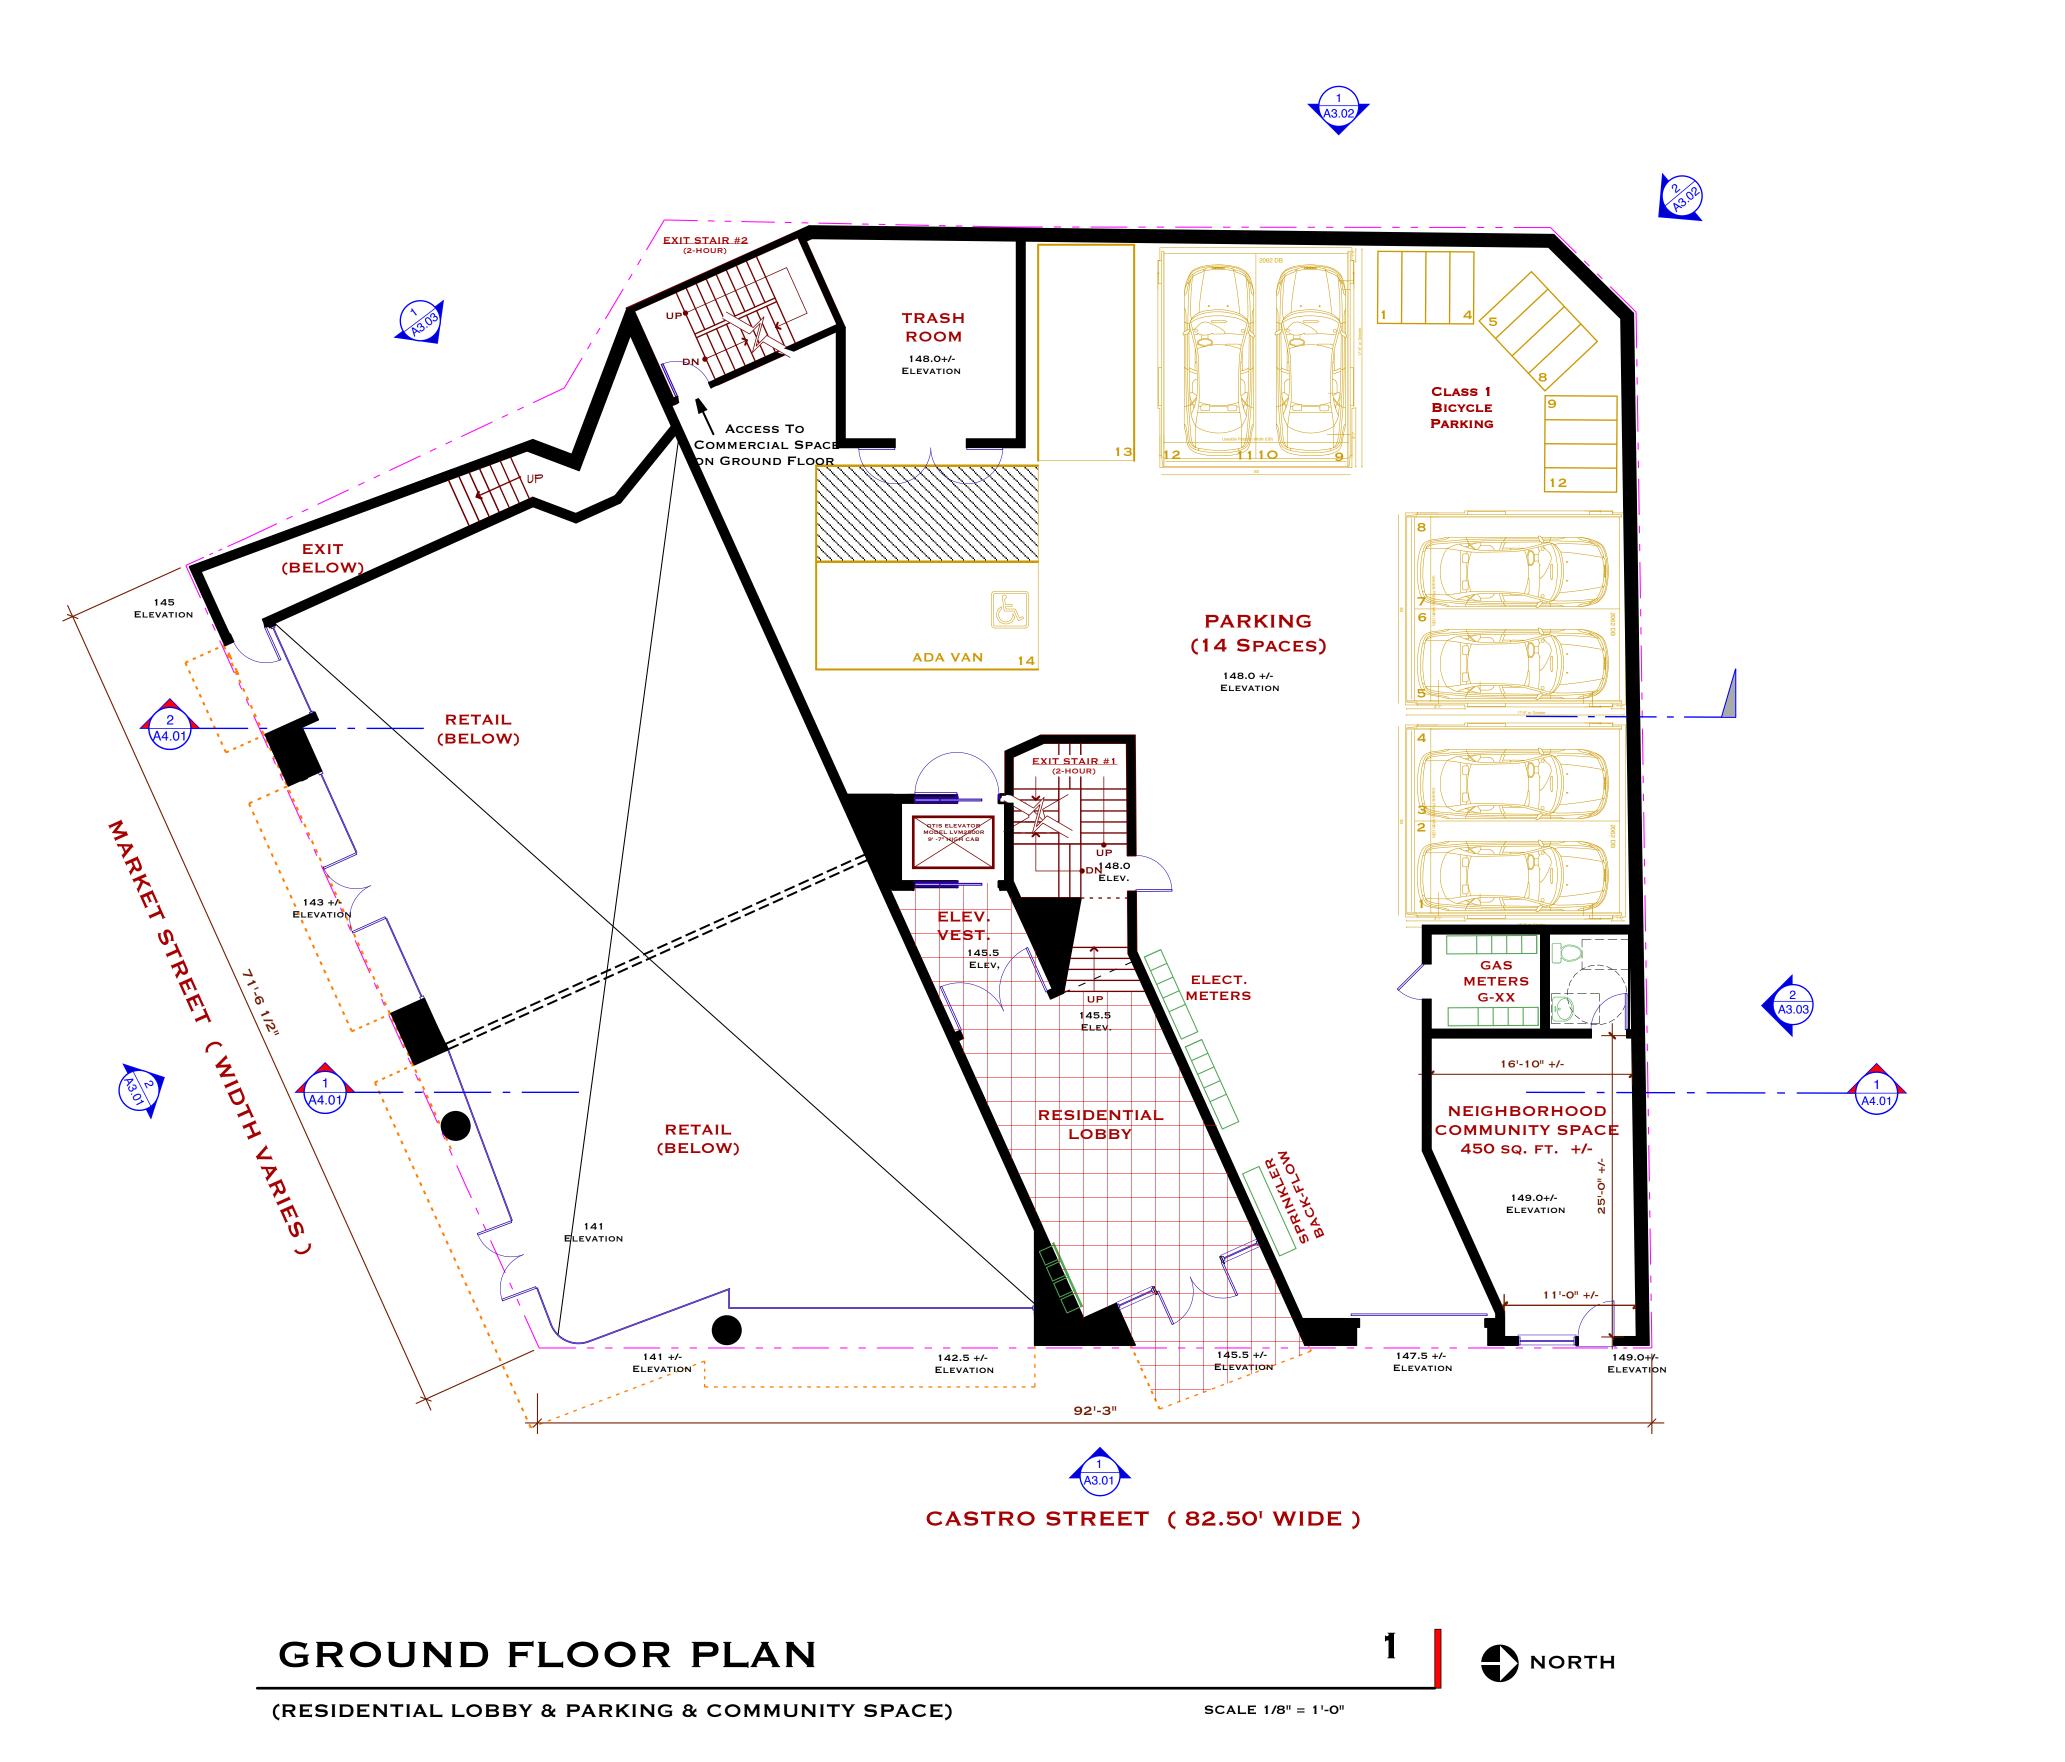
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Date: 10.05.10

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Drawn: MPB



1331 HARRISON STRE

SAN FRANCISCO CA 9410

TEL 415.882.9783 FAX 415.882.977

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STERNBERG
BENJAMIN

5/6 CASIRO SI 24 RESIDENTIAL UNITS BLOCK 2623 LOT 6 SAN FRANCISCO...CA

GROUND FLOOR RES. PARKING

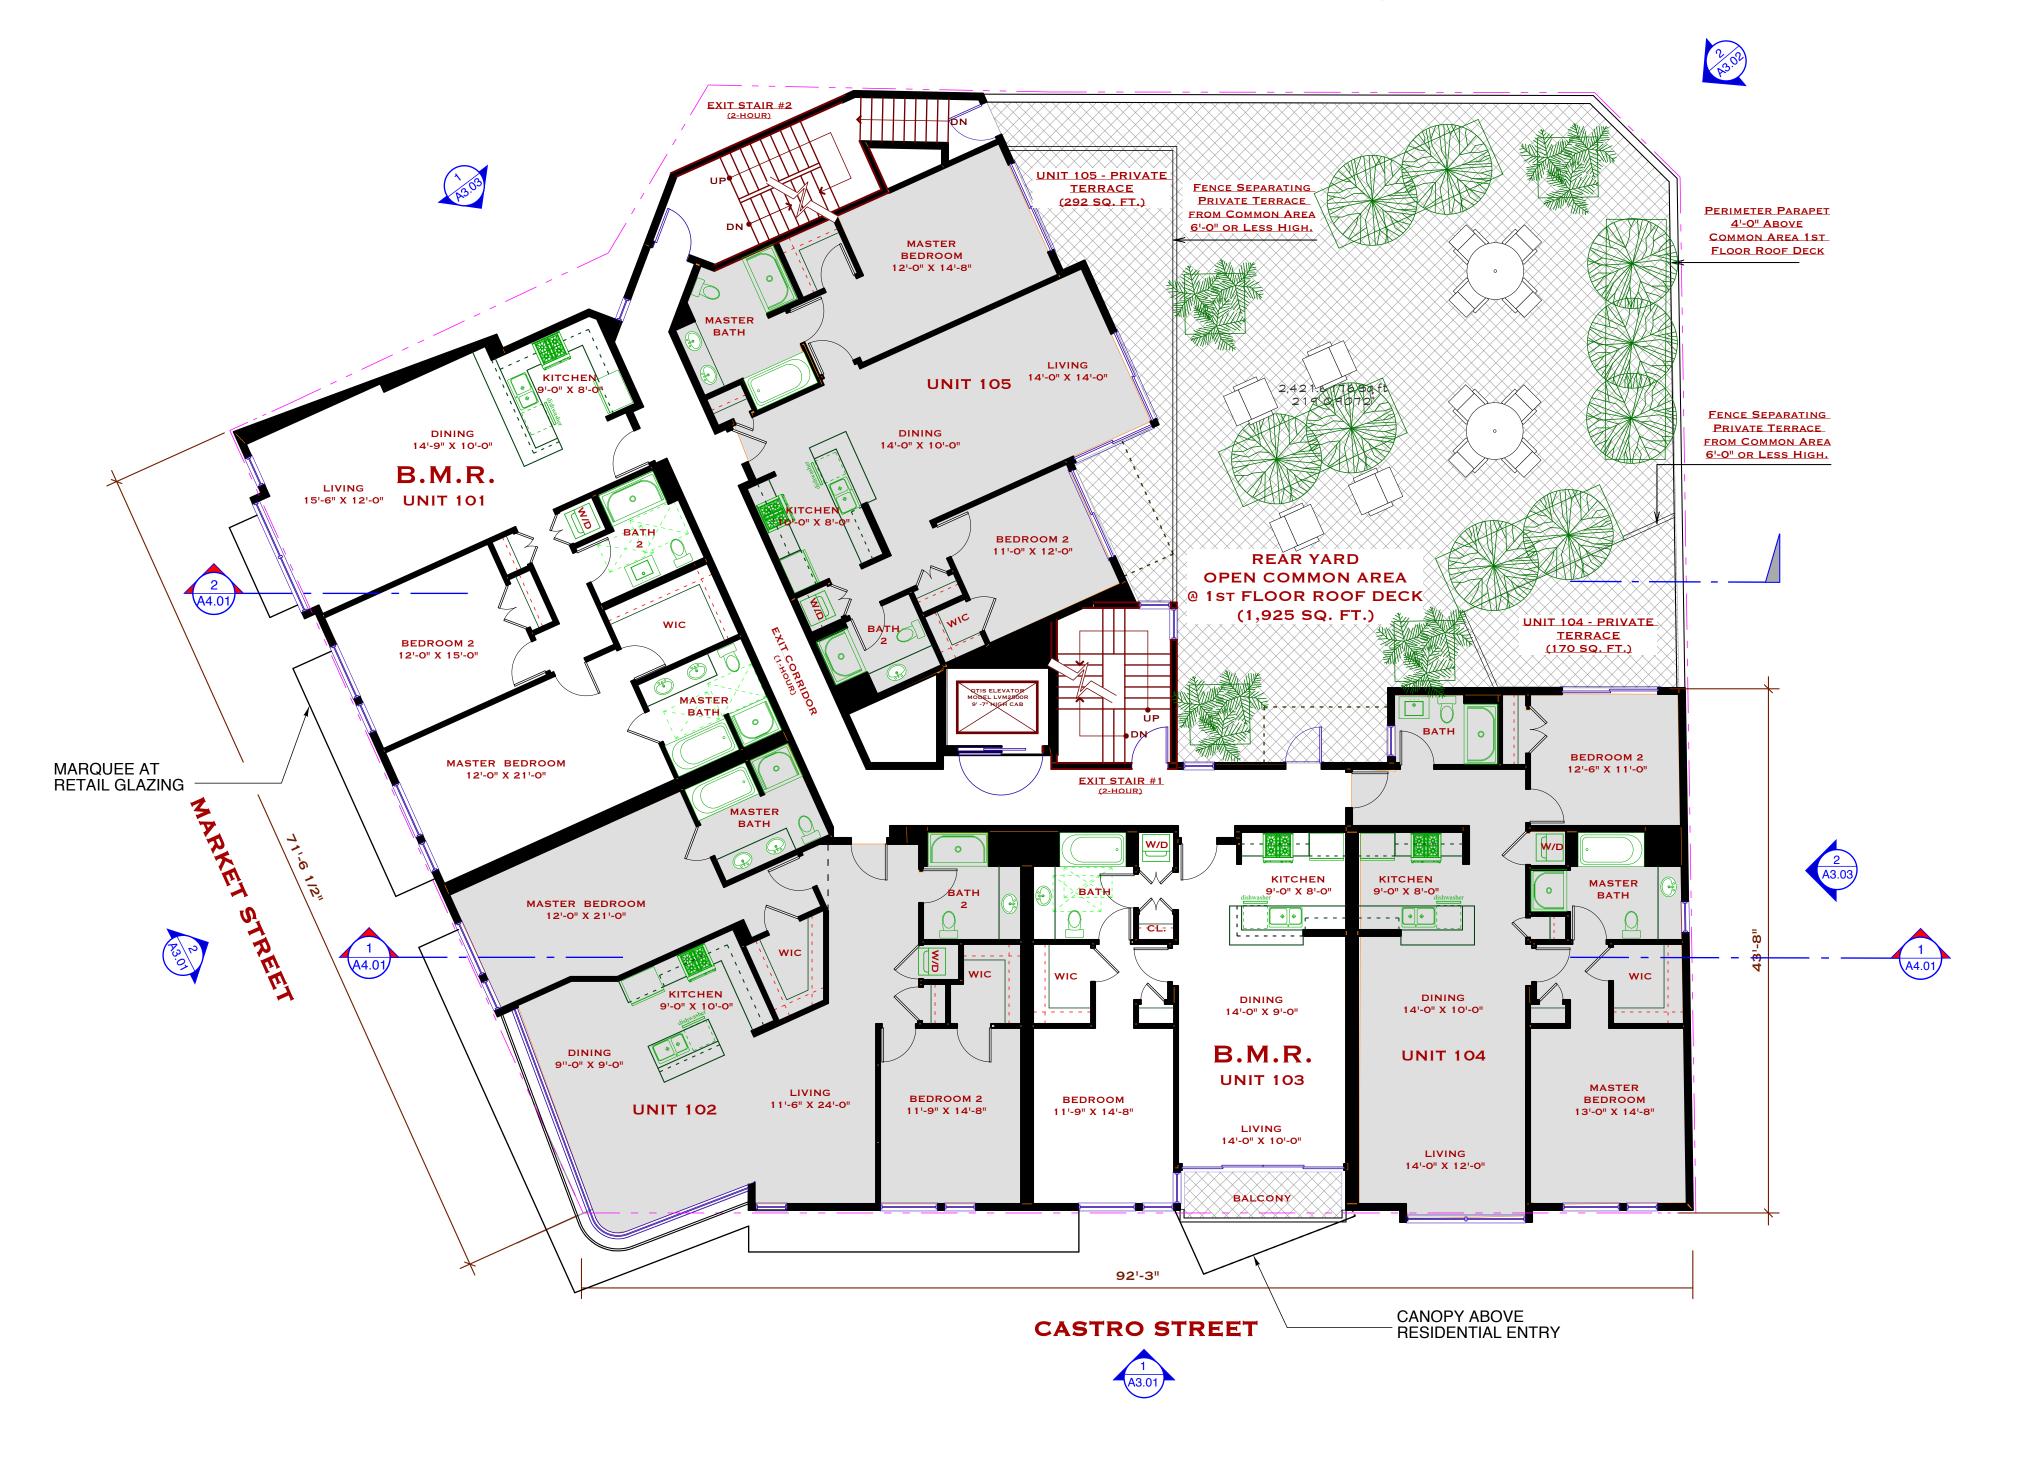
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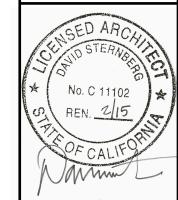
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A2.03



1ST RESIDENTIAL FLOOR PLAN

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1/8"=1'-0"

JNITS
STERNBERG
BENJAMIN
STORY

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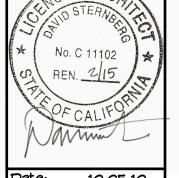
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RESIDENTI FLOOR PL/

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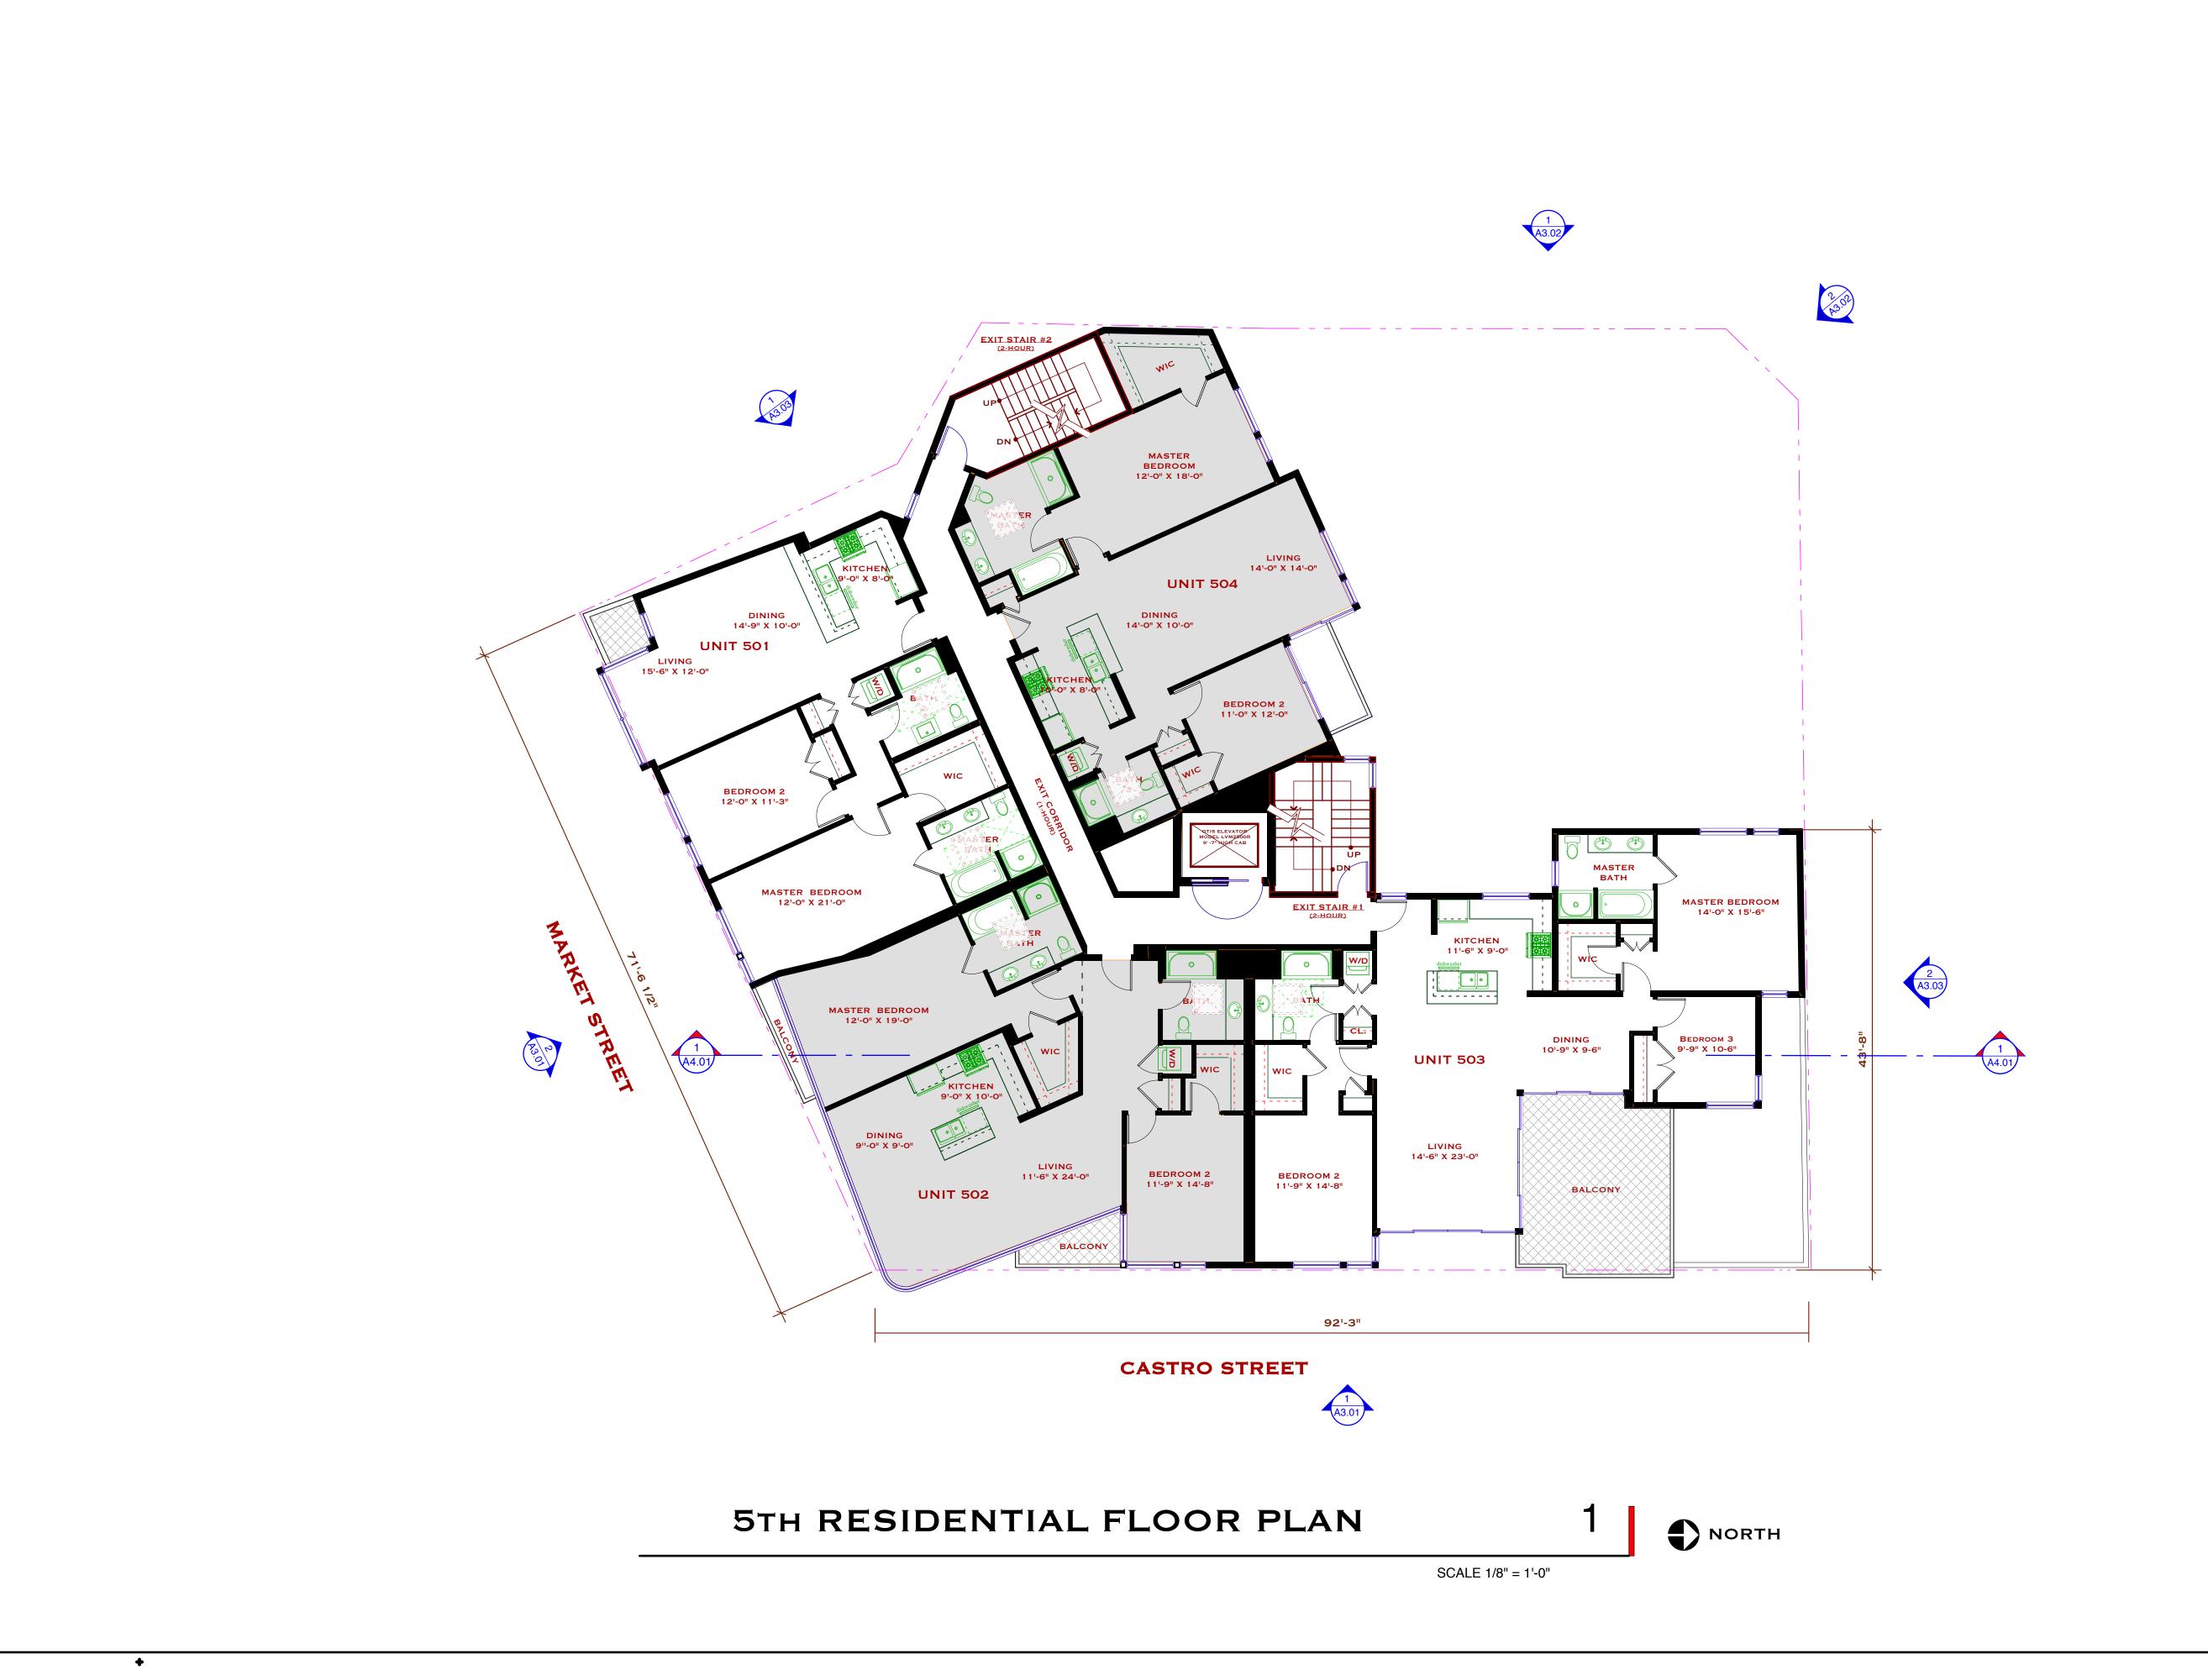


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SAN FRANCISCO CA 941
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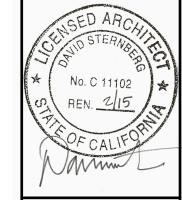
STERNBERG
BENJAMIN

24 RESIDENTIAL UNITS
BLOCK 2623 LOT 6
SAN FRANCISCO.. CA

STH RESIDENTIAI FLOOR PLAN

BLDG PMT 05.08.13 MPB
PLANNING 03.25.12 MPB
PLANNING 01.18.12 MPB
UDAT 01.18.11 MPB

Rev./Issue. Date



Date: 10.05.10

Scale: 1/8"=1'-0"

Drawn: MPB

